RENOVATIONS

TO THE

CLAY COUNTY CAREER ACADEMY FOR THE CLAY COUNTY BOARD of EDUCATION

ASHLAND, ALABAMA

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CONTACTS

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PLUMBING and MECHANICAL

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ELECTRICAL

Gunn and Associates 3102 Highway 14 Millbrook, AL 36054 Phone: (334) 285.1273 SHEET TITLE : COVER SHEET

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MCKEE JOB # : 21.239


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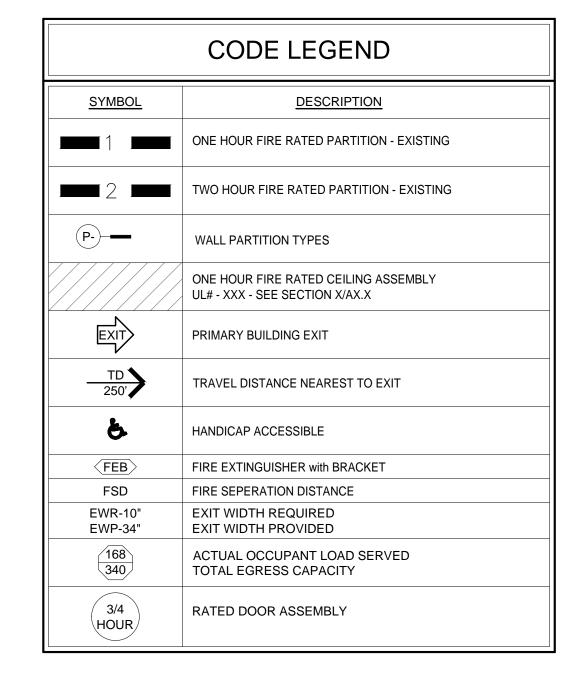
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DATE: 5.19.2022
REVISED DATE:

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SHEET NO.: GO.1





CODE REVIEW								
xxx								
CODE: 2015 INTERNATIONAL BUILDING CODE								
OCCUPANCY TYPE: GROUP 'E' SHOPS & OTHER VOCATIONAL AREAS								
SPRINKLERED: NO								
NUMBER OF STORIES: 1 CONSTRUCTION TYPE: TYPE 2B								
TYPE 2B , REQUIRES THE FOLLOWING FIRE RESISTANCE (TABLE 601):								
STRUCTURAL FRAME: EXTERIOR BEARING WALLS: INTERIOR BEARING WALLS: EXTERIOR NONBEARING WALLS: INTERIOR NONBEARING WALLS: INTERIOR NONBEARING WALLS: FLOOR CONSTRUCTION: ROOF CONSTRUCTION: 0 HOUR								
OTHER REQUIREMENTS:								
FIRE WALL RATING (TABLE 706.4): 2 HOUR								
OCCUPANCY SEPARATION (TABLE 508.4): XXX								
INCIDENTAL USE AREAS (TABLE 509): XXX								
CORRIDORS (TABLE 1020.1): CORRIDORS SERVING MORE THAN 30 OCCUPANTS IN UNSPRINKLERED 'E' OCCUPANCY SHALL HAVE A 1-HOUR WALL.								
STAIRS & SHAFT ENCLOSURES (707 & TABLE 707.3.10 NOT LEES THAN 508.4 IF APPLICABLE): XXX								
SINGLE OCCUPANCY FIRE BARRIERS (TABLE 707.3.10): 1 HOUR EXIT ACCESS TRAVEL DISTANCE IS 200 FEET FOR E (TABLE 1017.2)								

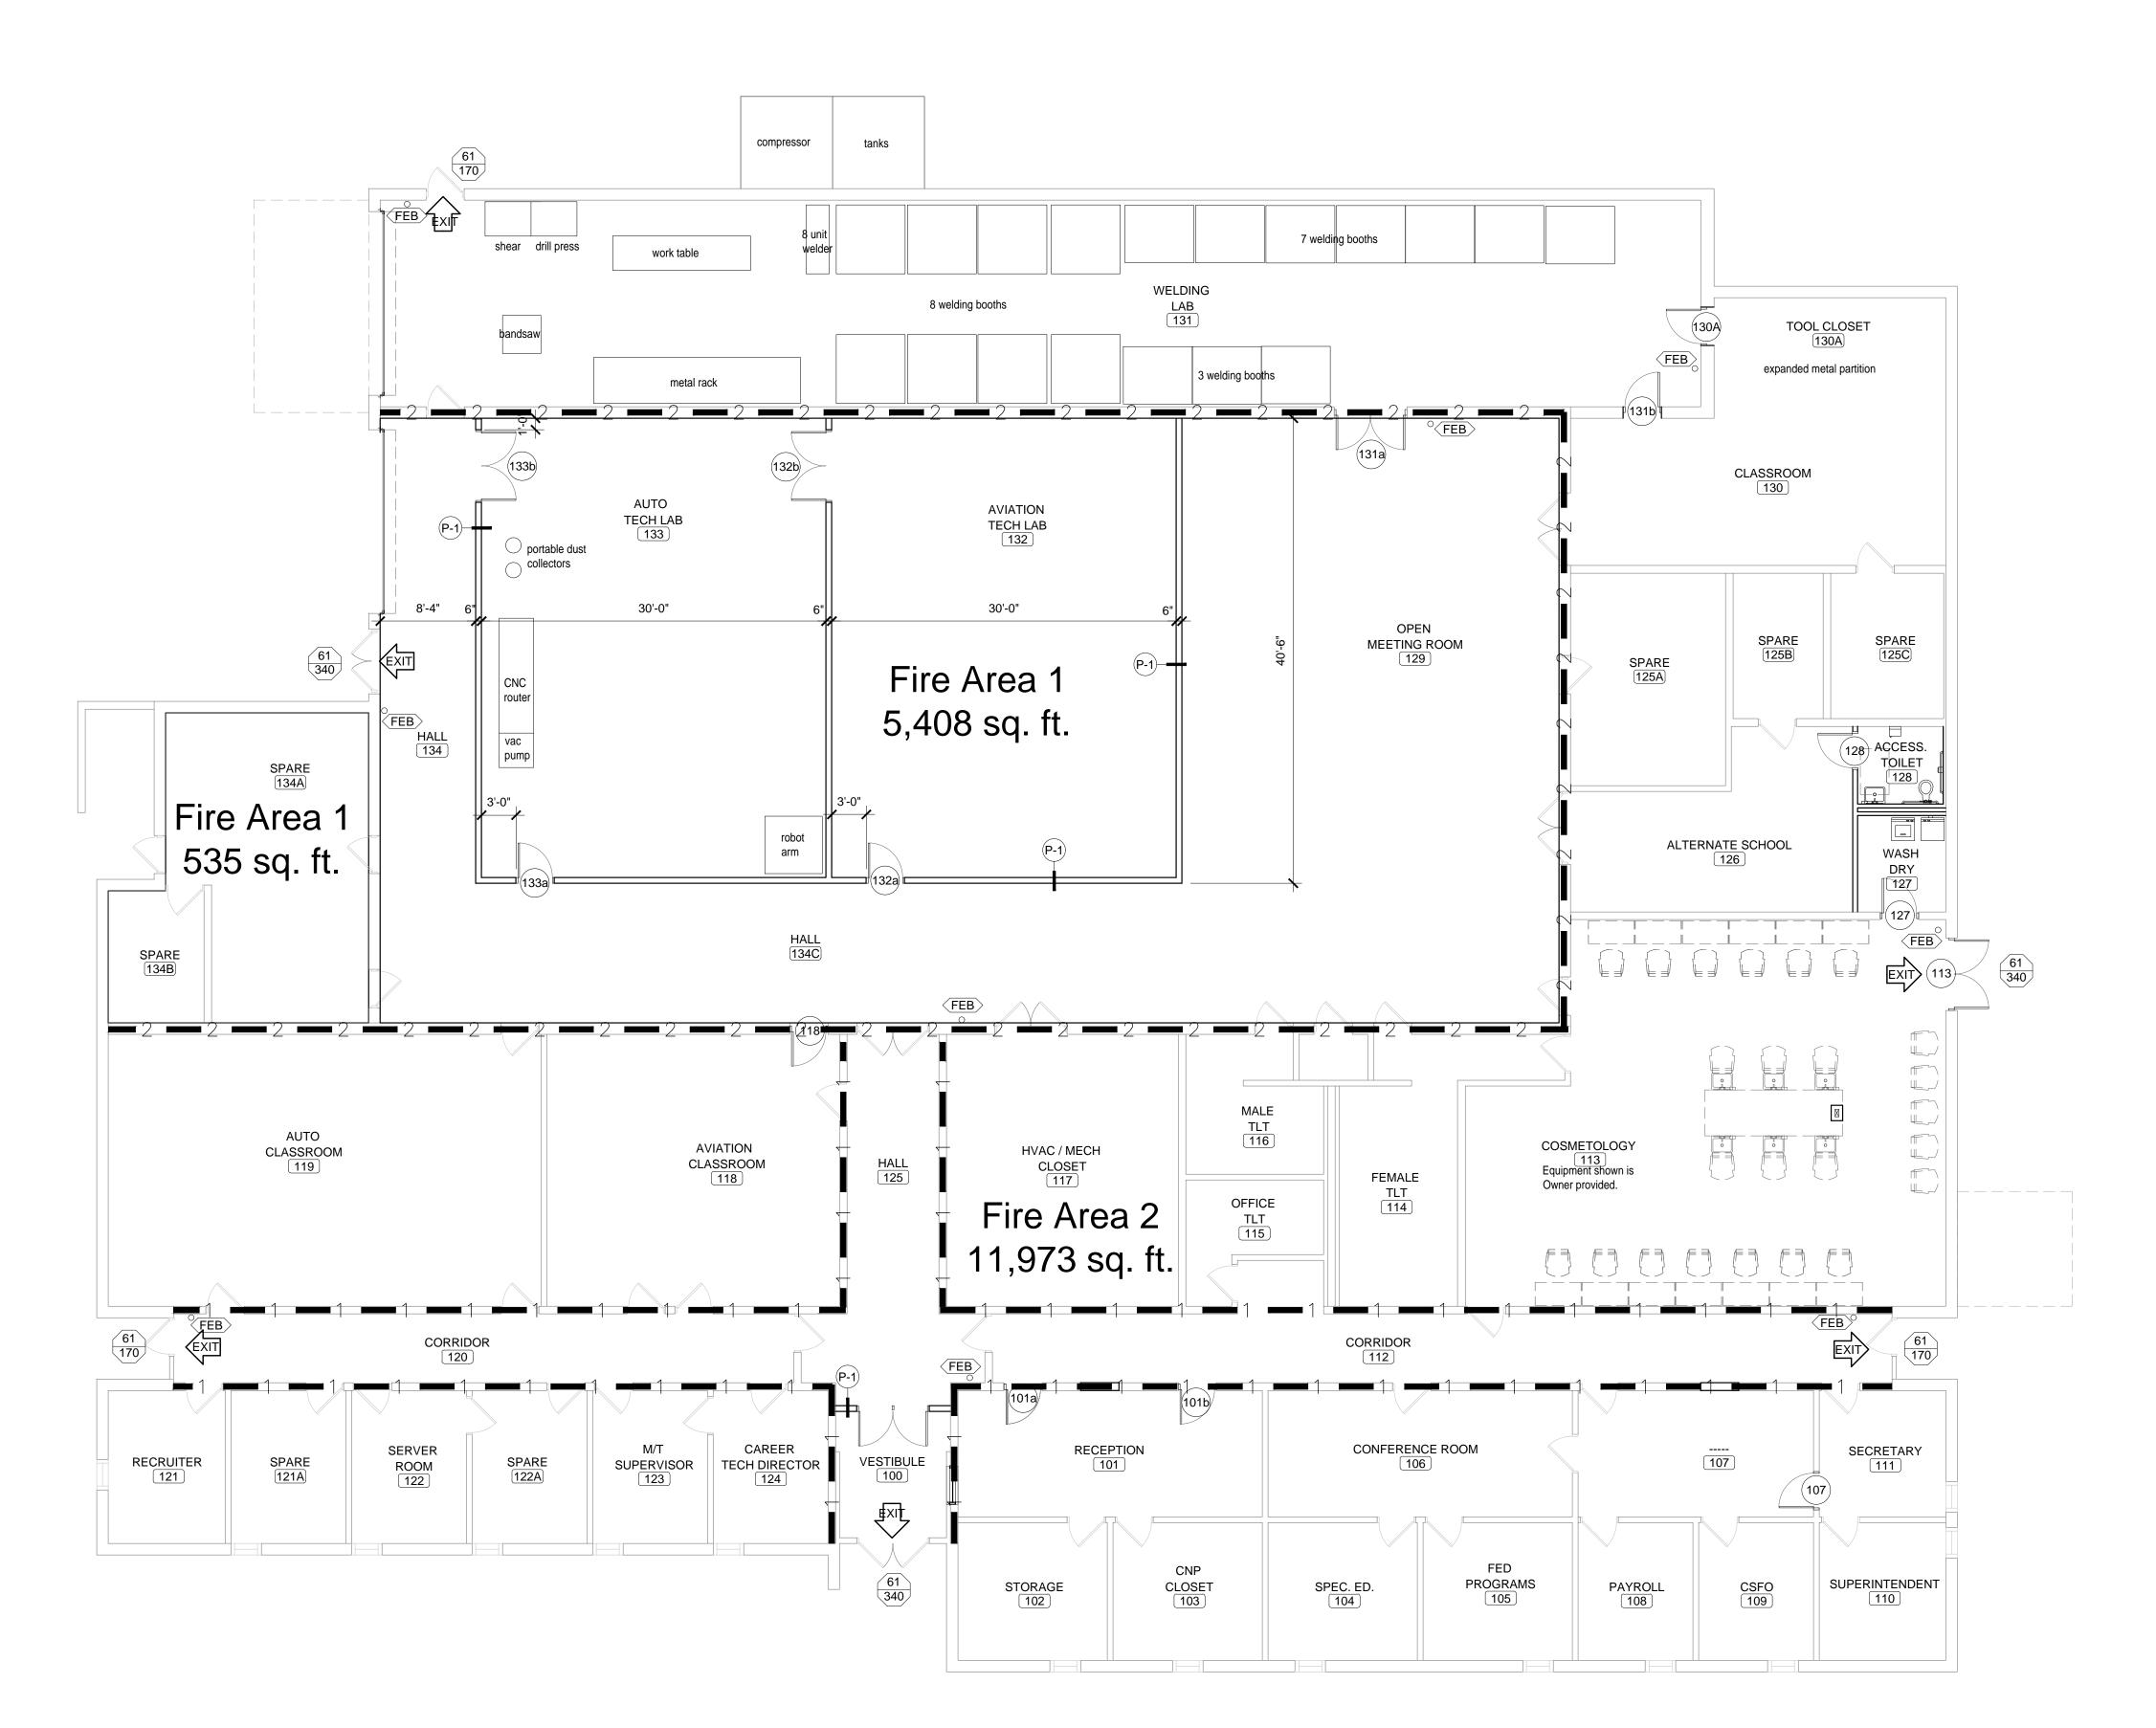EXIT CALCULATIONS

OCCUPANCY TYPE - GROUP 'E'
BUILDING TYPE: II-B
ALLOWABLE SF: 14,500 SQ FT (TABLE 506.2)
ACTUAL SF - 18,300 SQ FT

ALLOWABLE HEIGHT (TABLE 504.3) ALLOWABLE # OF STORIES (TABLE 504.4)
ALLOWABLE HEIGHT: 55 FT
ALLOWABLE NO. OF STORIES: 2
ACTUAL BUILDING HEIGHT: ±20 FT

ACTUAL NO. OF STORIES: 1

BUILDING AREA MODIFICATION (506.3)
FRONTAGE INCREASE (506.3.3)

CALCULATIONS: I = [F / P - .25] W / 30

I (AREA INCREASE DUE TO FRONTAGE)

W (WIDTH OF PUBLIC WAY OR OPEN SPACE) = 30

F (BUILDING PERIMETER THAT FRONTS PUBLIC WAY OR OPEN SPACE) = 574

P (PERIMETER OF ENTIRE BUILDING) = 574

.100 = [574 / 574 - .25] $\frac{30}{30}$.75 x 14,500 = 10,875 SF ALLOWABLE AREA W / FRONTAGE INCREASE: 25,375 SF OCCUPANT LOAD

OCCUPANT LOAD TOTAL (1004 & TABLE 1004.1.2) = 18,300 / 50 = **366** PERSONS

TOTAL BUILDING AREA

EXIT REQUIREMENTS

EXIT ACCESS (TABLE 1006.2.1 &

EXIT ACCESS (TABLE 1006.2.1 & TABLE 1006.3.1)

NO. OF EXITS REQUIRED: 2

NO. OF EXITS FURNISHED: 6

MEANS OF EGRESS WIDTH (1005.3)

SEE PLAN FOR EXIT WIDTHS

MINIMUM CORRIDOR WIDTH (TABLE 1020.2) 6'

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SHEET TITLE: CODE PLAN

MCKEE JOB #: 21.239

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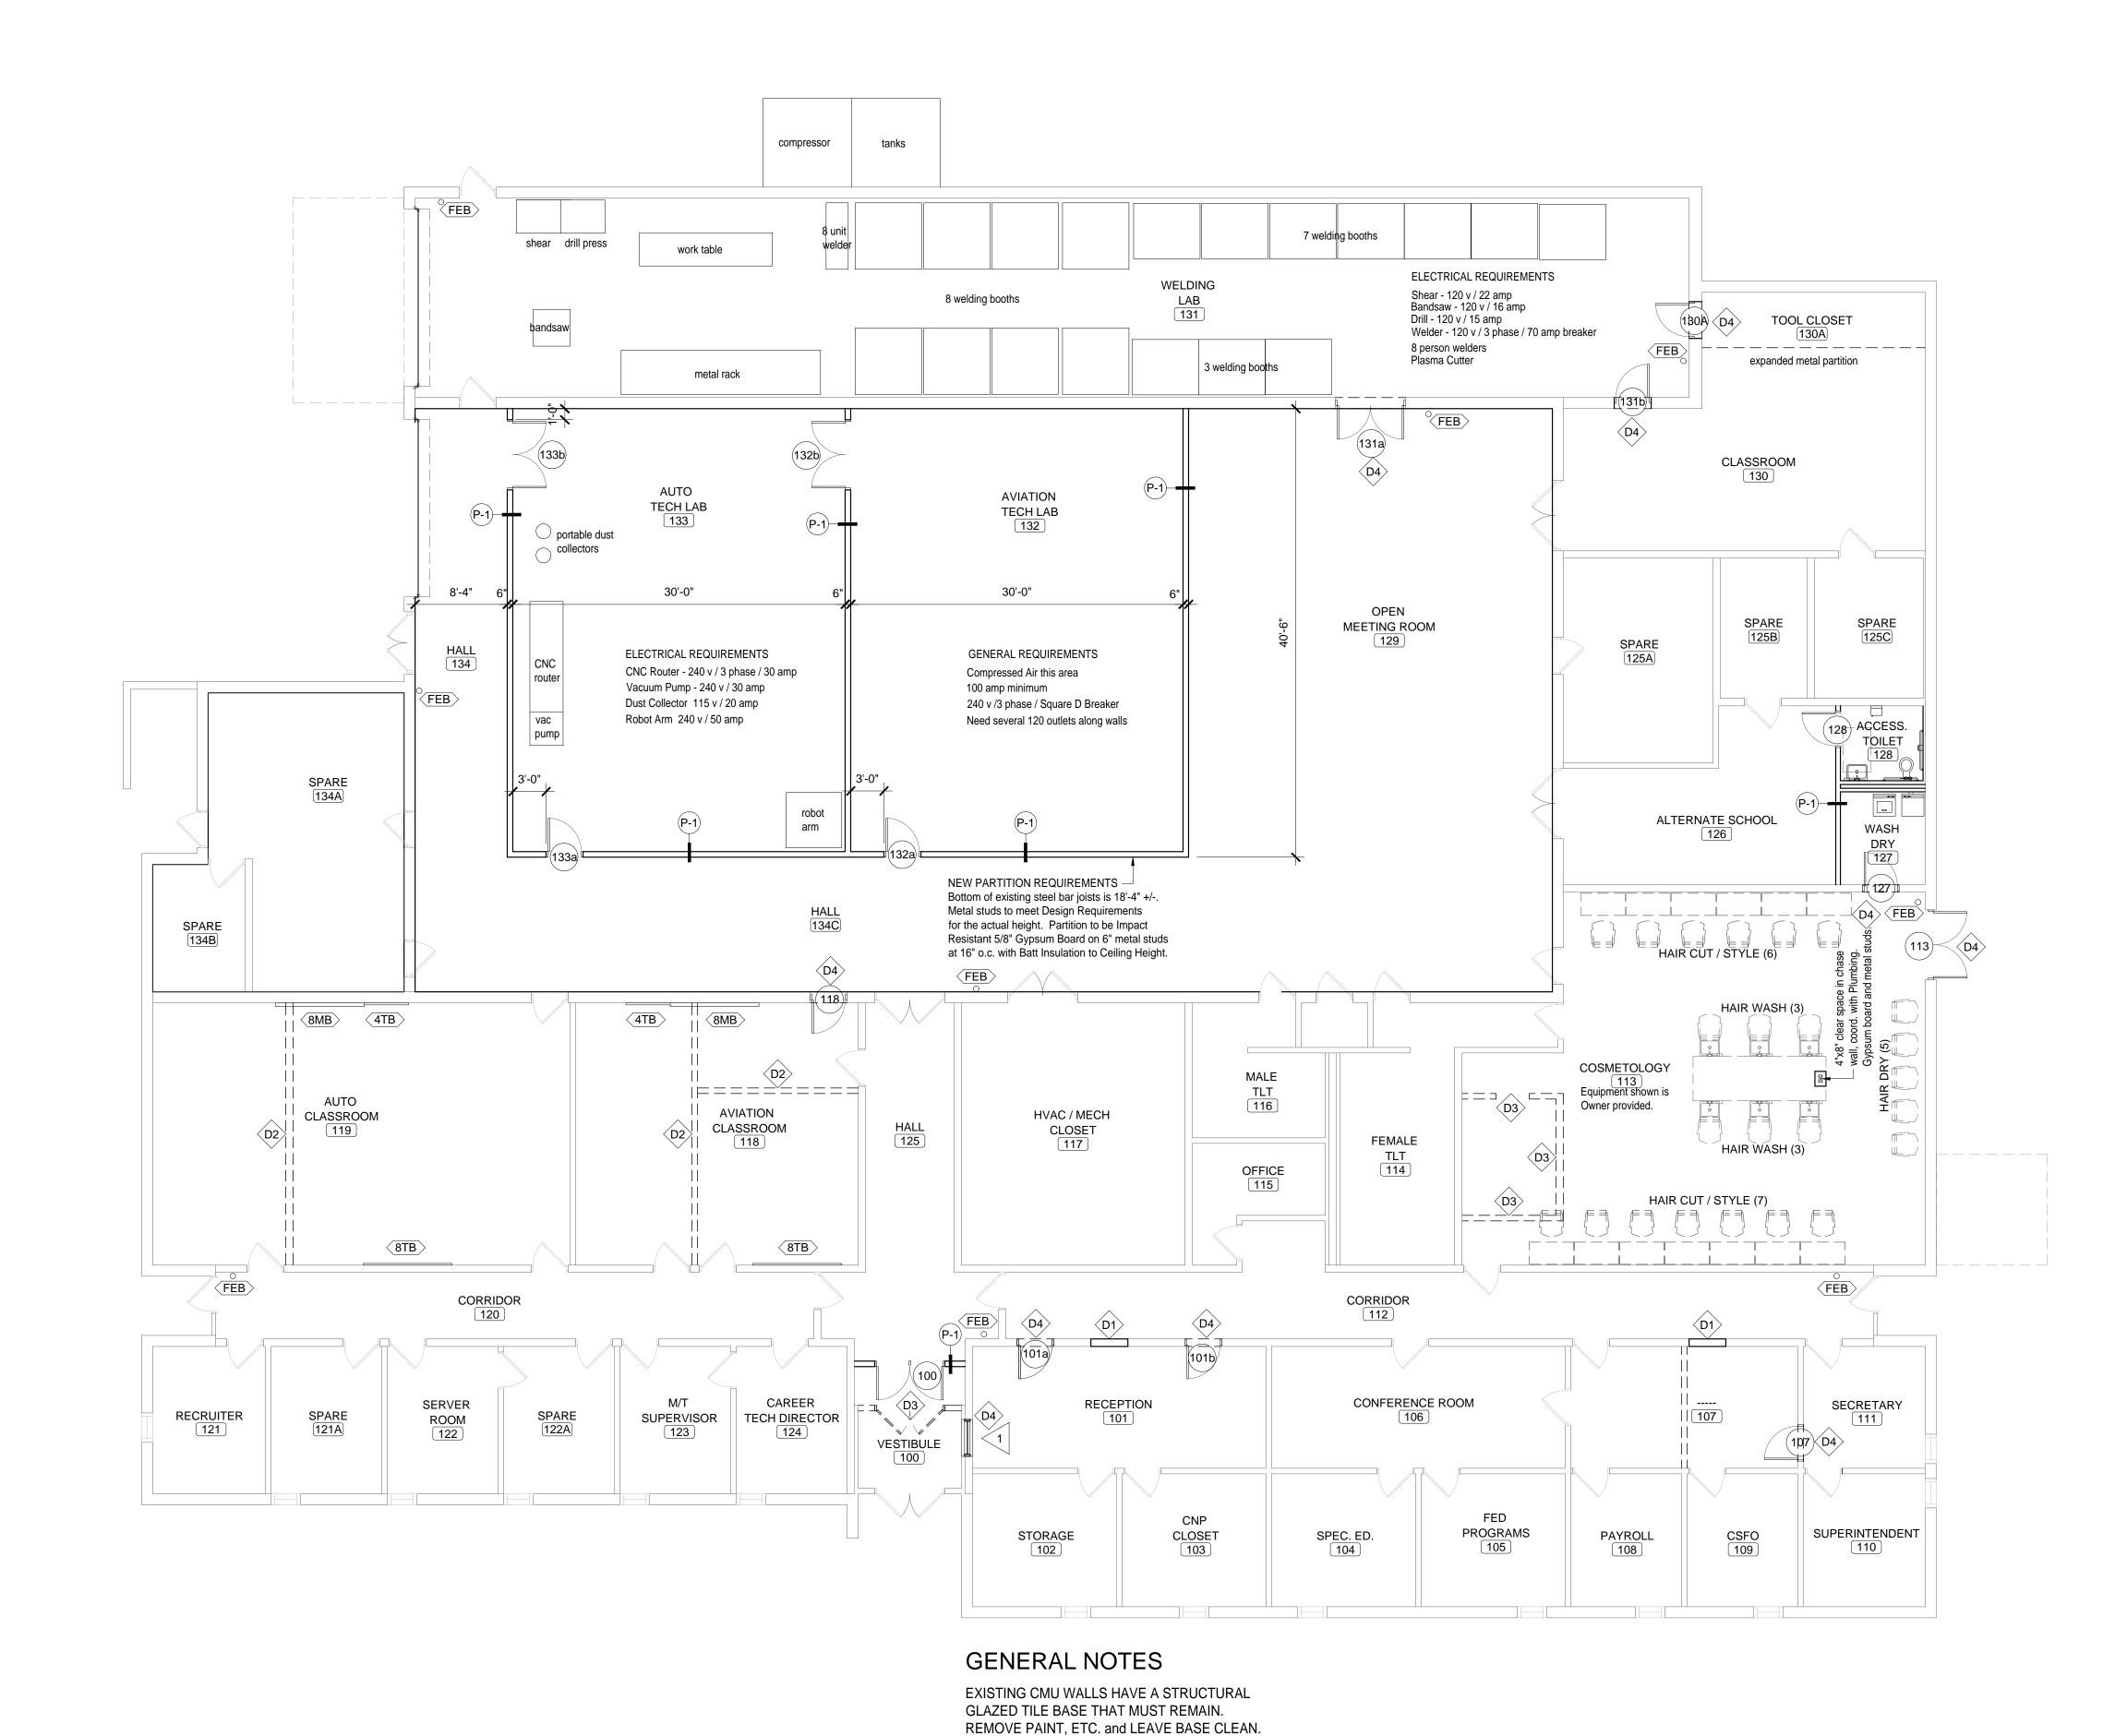
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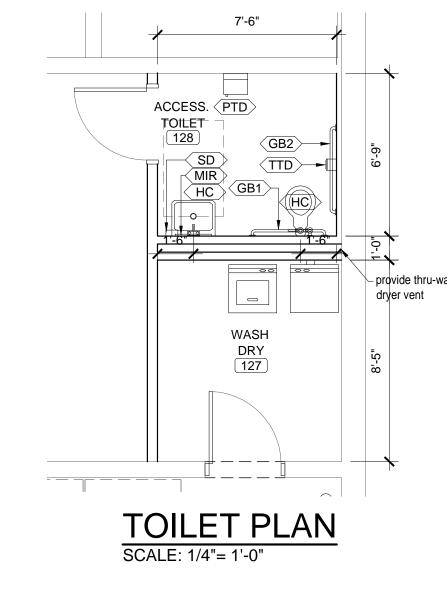
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CODE PLAN

SCALE: 1/8" = 1'-0"





FLOOR PLAN LEGEND												
SYMBOL	DESCRIPTION											
(A)	SCHEDULED DOOR AND FRAME											
	SCHEDULED WINDOW UNIT											
CORRIDOR 	SCHEDULED ROOM NAME AND NUMBER											
P-	WALL PARTITION TYPES											
FEB	FIRE EXTINGUISHER and BRACKET											
⟨8 MB⟩	8 FT. MARKERBOARD											
4 TB	4 FT. TACKBOARD											
<8 TB>	8 FT. TACKBOARD											

[
DEMOL	DEMOLITION PLAN LEGEND												
SYMBOL	DESCRIPTION												
	EXISTING TO REMAIN												
====	EXISTING TO BE REMOVED												
	NEW CONSTRUCTION												
D1	EXISTING DOOR AND FRAME TO BE REMOVED and WALL OPENING CLOSED.												
(D2)	EXISTING WALL TO BE REMOVED												
D3	EXISTING WALL, DOOR and FRAME TO BE REMOVED and WALL OPENING CLOSED.												
D4	PROVIDE WALL OPENING FOR NEW DOOR OR WINDOW AS SCHEDULED												
	EXISTING DOORS and FRAME TO BE REMOVED and REPLACED WITH NEW DOORS and FRAME.												

SITE OF WORK EXAMINATION

THESE DRAWINGS WERE COMPILED BY THE ARCHITECT FROM THE OWNER'S RECORD DRAWINGS AND FROM ON-SITE OBSERVATIONS TO INDICATE THE BUILDING ARRANGEMENT.

ALL CONTRACTORS SUBMITTING PROPOSALS FOR THIS WORK SHALL FIRST EXAMINE THE PREMISES AND ALL CONDITIONS THEREIN. ALL PROPOSALS SHALL TAKE INTO CONSIDERATION ALL SUCH CONDITIONS AS MAY AFFECT THE WORK UNDER THIS CONTRACT.

DRAWINGS ARE DIMENSIONED FOR BIDDING PURPOSES ONLY.
CONTRACTORS SHALL MEASURE ALL EXISTING WORK AT THE PREMISES
AND VERIFY ALL DIMENSIONS NEEDED TO PROPERLY INTERFACE
IMPROVEMENTS WITH ALL EXISTING ELEMENTS WHICH ARE TO REMAIN.

CLAY COUNTY CAREER /
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SHEET TITLE : FLOOR PLAN

MCKEE JOB # : 21.239

PSCA # : XXX

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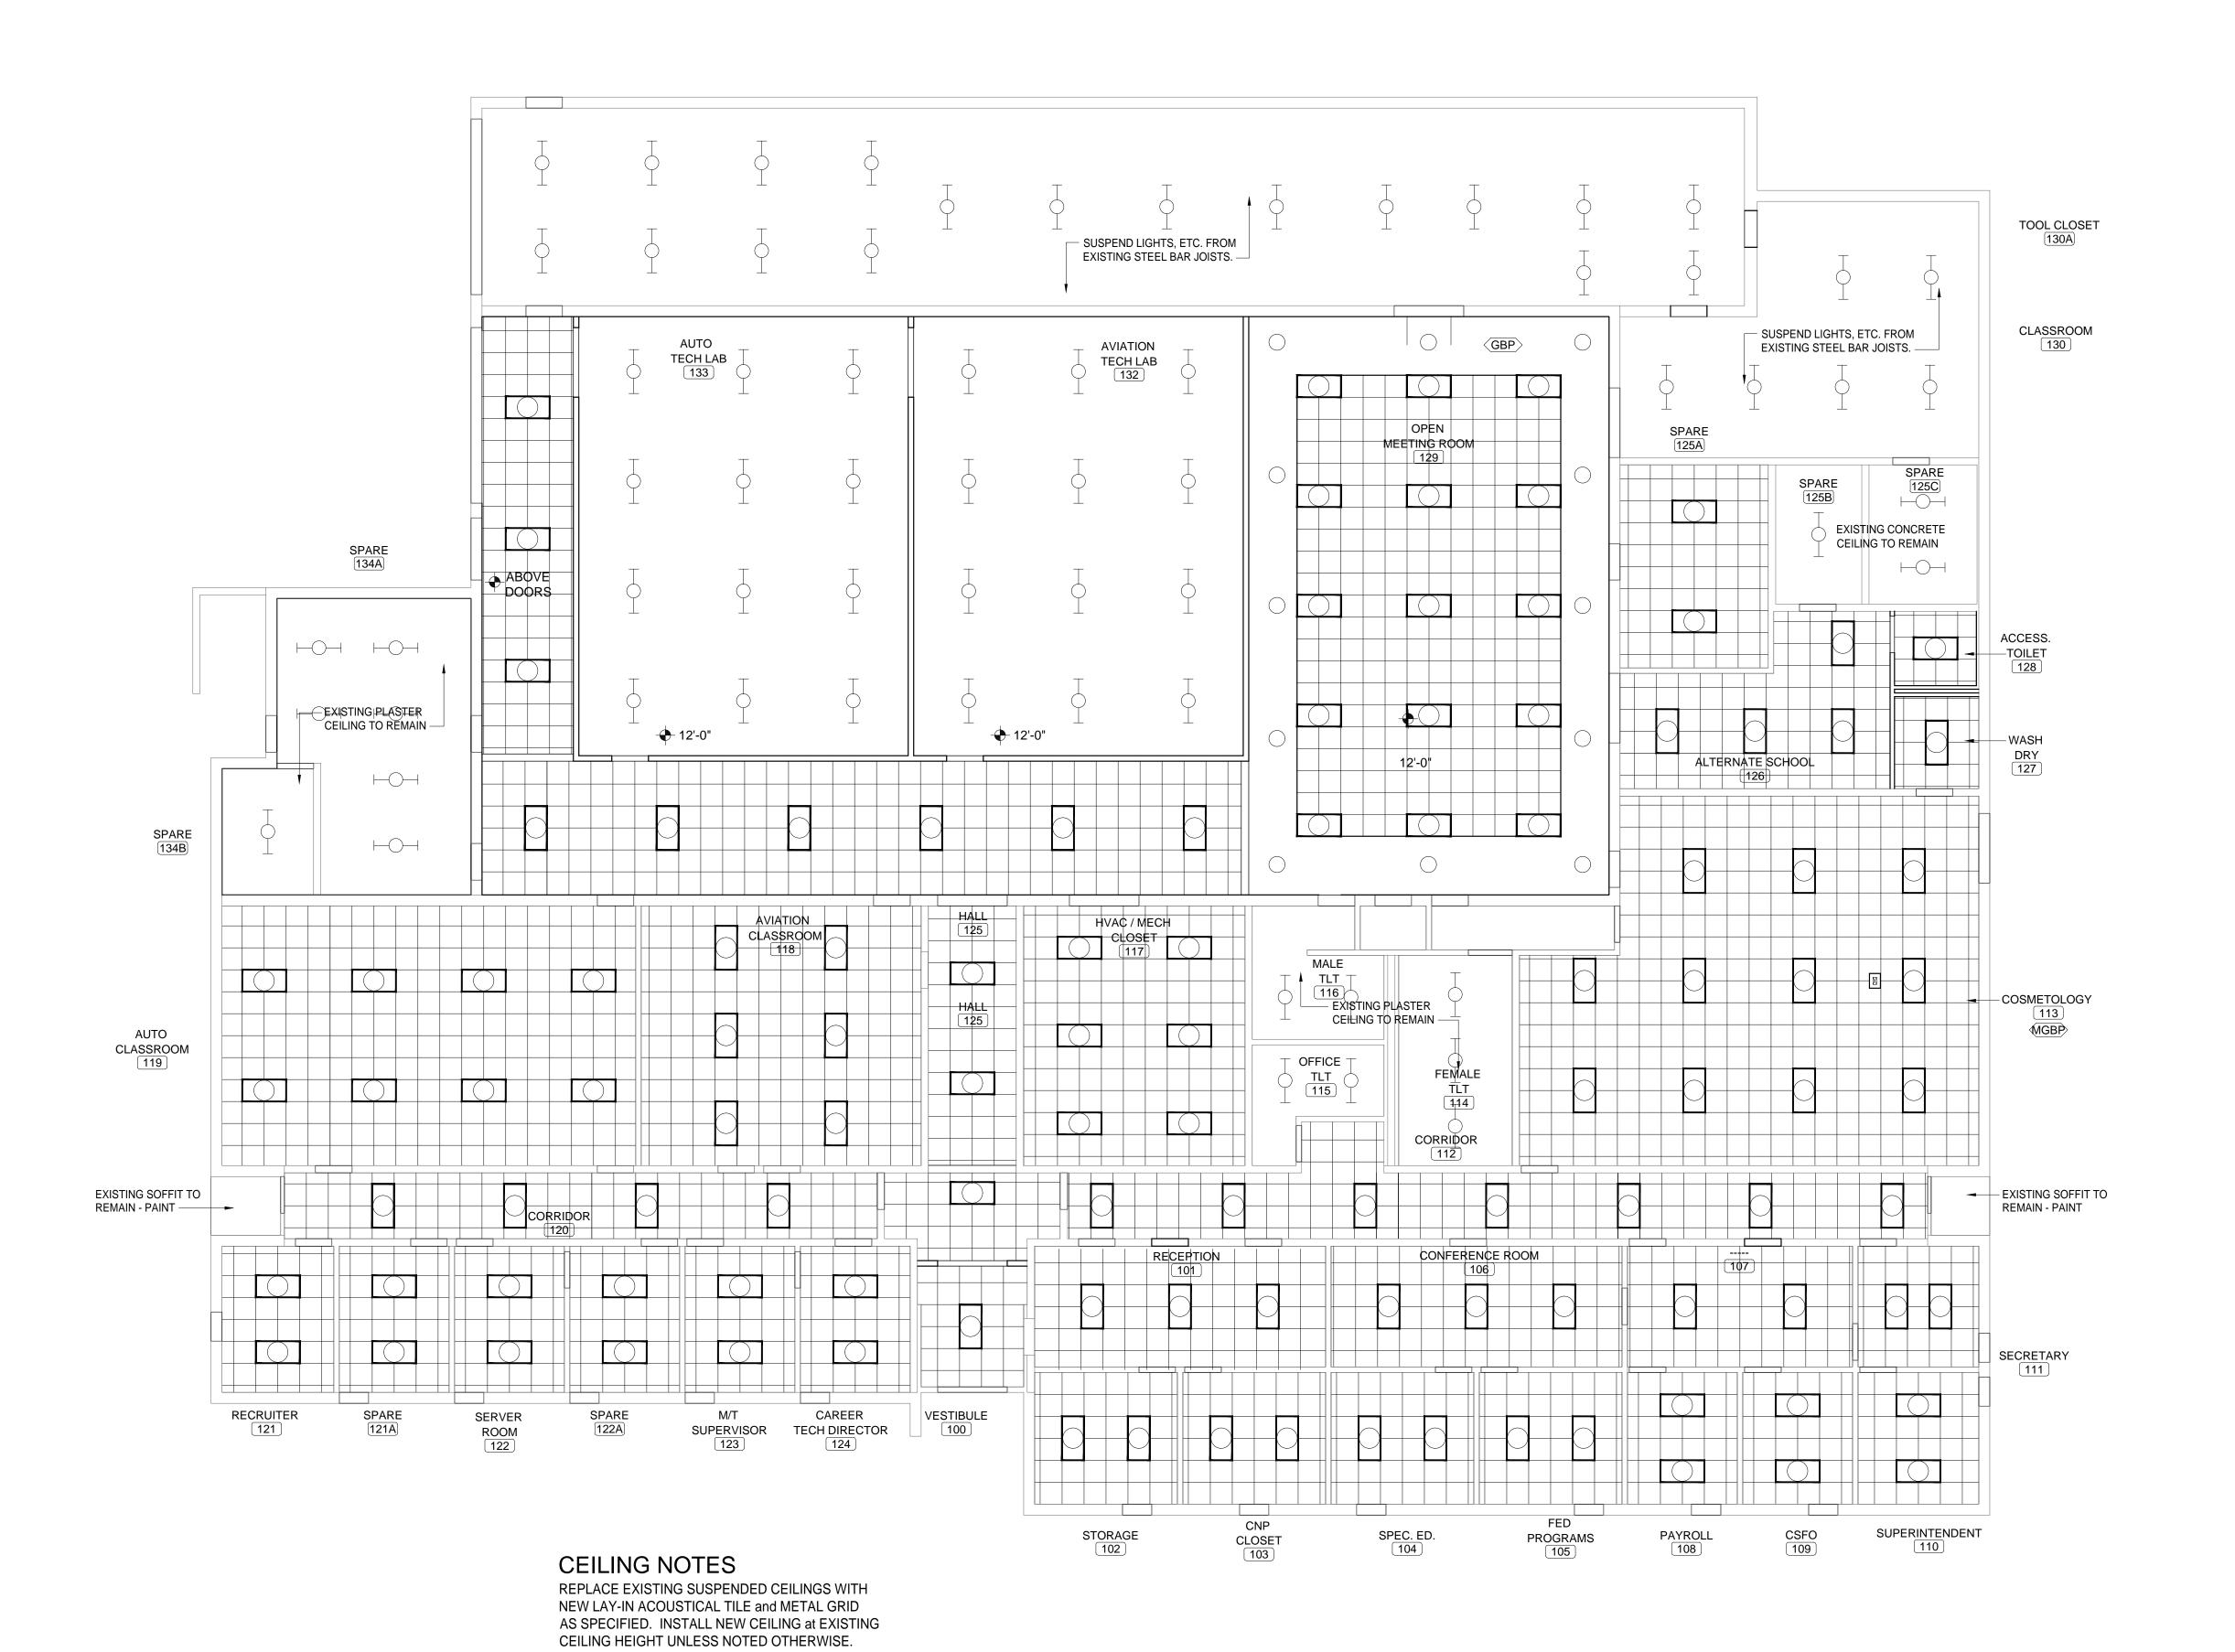
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LAY-IN CEILING
SEEE RCP
GYPSUM BOARD ON METAL
STUD FURRING

FURRING DETAIL
SCALE: 1 1/2"= 1'-0"
COORDINATE DETAL WITH CEILING PLAN
and LIGHTING PLAN

REFLECTED CEILING PLAN LEGEND												
REFLECTED	CEILING PLAN LEGEND											
SYMBOL	<u>DESCRIPTION</u>											
0'-0"	HEIGHT ABOVE FINISHED FLOOR ELEVATION											
	2'x2' LAY-IN ACOUSTICAL CEILING											
	2'x2' VINYL CLAD LAY-IN ACOUSTICAL CEILING											
	⁵ % ₅₀ HARD/SOFT ACOUSTICAL TILE TREATMENT IN SUSPENDED CEILING GRID											
	GYPSUM BOARD (SUSPENDED AS REQUIRED)											
	MOISTURE RESISTANT GYPSUM BOARD (SUSPENDED AS REQUIRED)											
	METAL SOFFIT PANELS (SUSPENDED AS REQUIRED)											
(EIFS)	EXTERIOR INSULATED FINISH SYSTEM (SUSPENDED AS REQUIRED)											
OTA	OPEN TO ABOVE											
	2'x4' RECESSED OR SURFACE MOUNTED LIGHT FIXTURE (SEE ELECTRICAL)											
	2'x2' RECESSED OR SURFACE MOUNTED LIGHT FIXTURE (SEE ELECTRICAL)											
	1'x4' RECESSED OR SURFACE MOUNTED LIGHT FIXTURE (SEE ELECTRICAL)											
ЮН	1'x4' SURFACE MOUNTED LIGHT FIXTURE (SEE ELECTRICAL)											
•	RECESSED ROUND LIGHT FIXTURE (SEE ELECTRICAL)											
	HVAC SUPPLY AIR GRILLE (SEE MECHANICAL)											
	HVAC RETURN AIR GRILLE (SEE MECHANICAL)											
	EXHAUST FAN GRILLE (SEE MECHANICAL)											
	CASSETTE HEAT PUMP (SEE MECHANICAL)											
ESP	EXPOSED STRUCTURE - PAINT											
ES	EXPOSED STRUCTURE - NO PAINT											
NWR	NO WORK REQUIRED											
SLP	STEEL LINTEL - PAINT											
GBF	GYPSUM BOARD FURRING											
DS	DISAPPERING STAIR											
EDP	EXPOSED DUCTWORK - PAINT											
ED	EXPOSED DUCTWORK - NO PAINT											
GBP	GYPSUM BOARD - PAINT											
GB	GYPSUM BOARD - NO PAINT											
(MGBP)	MOISTURE RESISTANT GYPSUM BOARD - PAINT											
MGB	MOISTURE RESISTANT GYPSUM BOARD - NO PAINT											
(MSPV)	METAL SOFFIT PANELS - VENTED											
(MSP)	METAL SOFFIT PANELS - NON VENTED SPECIATLY SUSPENDED GRID SYSTEM "CLOUD"											

Coordination Note

LIGHT FIXTURES, CEILING GRILLES, DIFFUSERS, ETC. ARE INDICATED ON THIS PLAN AS A GUIDE FOR LOCATING THESE ITEMS IN THE SUSPENDED CEILING GRID. THE CONTRACTOR SHALL INSURE THAT ALL ITEMS SHOWN AND / OR SPECIFIED BY THE ELECTRICAL AND MECHANICAL DISCIPLINES FOR INSTALLATION IN WALLS OR CEILINGS ARE PROVIDED, WHETHER SPECIFICALLY SHOWN ON THIS PLAN OR NOT. IF A PARTICULAR ITEM IS NOT SHOWN ON THE REFLECTED CEILING PLAN, PREPARE A DRAWING AND PRESENT IT TO THE ARCHITECT FOR REVIEW AND / OR APPROVAL.

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EDUCATION

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COUNT

;ADEMY

WALTER T. MCKEE, JR. 32 No. 1082
No. 1082
MONTGOMERY, ALA. 52
STERED ARGAIL ELE AND CHARLES AND CHARLE

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TITLE: REFLECTED CEILING PLAN

MCKEE JOB # : 21.239

PSCA # : XXX

DRAWN BY: CH

DATE: 5.19.2022

REVISED DATE:


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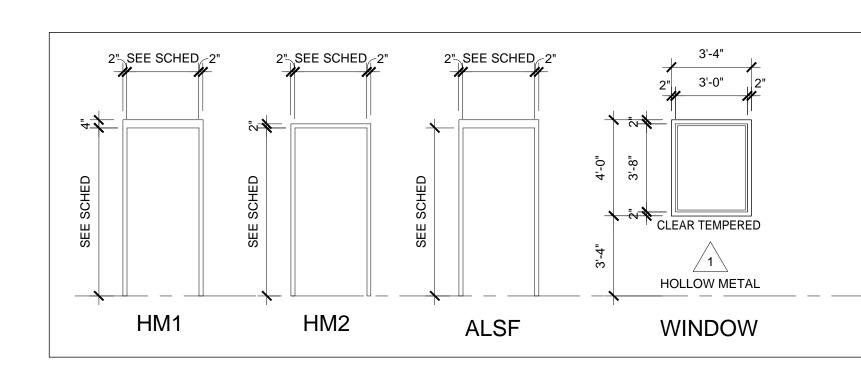
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REFLECTED CEILING PLAN

SCALE: 1/8" = 1'-0"





TYPICAL DOOR TYPES SCALE: 1/4" - 1'-0"

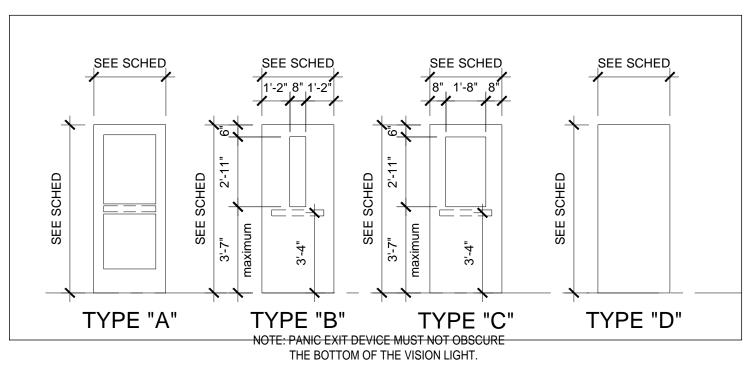TYPICAL FRAME TYPES SCALE: 1/4" - 1'-0"

GBP - GYPS GB - GYPSL MGBP - MOIS MGB - MOIS IGBP - IMPA	RK REQUIRED SUM BOARD - PAINT JM BOARD - NO PAINT ISTURE RESISTANT GYPSUM BOARD - PAINT STURE RESISTANT GYPSUM BOARD - NO PAINT ICT RESISTANT GYPSUM BOARD - PAINT CT RESISTANT GYPSUM BOARD - NO PAINT	CMUP - CONCRETE MASON CMU - CONCRETE MASON IMWP - INTERIOR METAL V PLP - PLASTIC LAMINATE V AWC - ACCOUSTICAL WAL CT - CERAMIC TILE PT - PORCELAIN TILE	RY UNIT - NO F VALL PANELS VALL PANELS			SC - S RFT - RSF - VCT -	VINYL COMPO	OR TILES R SPORTS FLO OSITION TILE				PF - POLYMER FLOORING RB - RUBBER BASE W - WOOD BASE VCB - VENTELATED COVE BASE EMP - EXPANDED METAL PARTITION
ROOM#	ROOM NAME	FLOOR	BASE	NORTH	WAL SOUTH	LS	WEST	CEIL TYPE	JING HEIGHT	WAINS.	HEIGHT	REMARKS
100	VESTIBULE	LVT	EXISTING	CMUP	CMUP	CMUP	CMUP	SEE RC				
101	RECEPTION	LVT	EXISTING	CMUP	CMUP	CMUP	CMUP	SEE RC				
102	STORAGE	LVT	EXISTING	CMUP	CMUP	CMUP	CMUP	SEE RC				
103	CNP CLOSET	LVT	EXISTING	CMUP	CMUP	CMUP	CMUP	SEE RC				
104	SPECIAL EDUCATION	LVT	EXISTING	CMUP	CMUP	CMUP	CMUP	SEE RC				
105	FEDERAL PROGRAMS	LVT	EXISTING	CMUP	CMUP	CMUP	CMUP	SEE RC				
103	CONFERENCE ROOM	LVT	EXISTING	CMUP	CMUP	CMUP	CMUP	SEE RC				
107	SPARE SPARE	LVT	EXISTING	CMUP	CMUP	CMUP	CMUP	SEE RC				
107	PAYROLL	LVT	EXISTING	CMUP	CMUP	CMUP	CMUP	SEE RC				
100	CSFO	LVT	EXISTING	CMUP	CMUP	CMUP	CMUP	SEE RC				
110	SUPERINTENDENT	LVT	EXISTING	CMUP	CMUP	CMUP	CMUP	SEE RC				
111	SECRETARY	LVT	EXISTING	CMUP	CMUP	CMUP	CMUP	SEE RC				
112	CORRIDOR	LVT	EXISTING	CMUP		CMUP	CMUP	SEE RC				
113	COSMETOLOGY	LVT	EXISTING	CMUP	CMUP	CMUP	CMUP	SEE RC				
114	FEMALE TOILET	EXISTING	EXISTING					SEE RC				PAINT PLASTER CEILING and CMU ABOVE WAINSCOT
115	OFFICE TOILET	EXISTING						SEE RC				PAINT PLASTER CEILING and CMU ABOVE WAINSCOT
116	MALE TOILET		EXISTING					SEE RC				PAINT PLASTER CEILING and CMU ABOVE WAINSCOT
117	HVAC / MECHANICAL CLOSET			CMUP	CMUP	CMUP	CMUP	SEE RC				CLEAN EXISTING CONCRETE FLOOR
118	AVIATION CLASSROOM	LVT	EXISTING	GBP	GBP	GBP	CMUP	SEE RC				OLEAN EXISTING CONCRETE TECCH
119	AUTO CLASSROOM	LVT	EXISTING	GBP	GBP	GBP	CMUP	SEE RC				
120	CORRIDOR	LVT	EXISTING		CMUP	CMUP	CMUP	SEE RC				
121	RECUITER	LVT	EXISTING	CMUP	CMUP	CMUP	CMUP	SEE RC				
121A	SPARE	LVT	EXISTING	CMUP	CMUP	CMUP	CMUP	SEE RC				
122	SERVER ROOM	LVT	EXISTING	CMUP	CMUP	CMUP	CMUP	SEE RC				
122A	SPARE	LVT	EXISTING	CMUP	CMUP	CMUP	CMUP	SEE RC				
123	M/T SUPERVISOR	LVT	EXISTING	CMUP	CMUP	CMUP	CMUP	SEE RC				
123	CAREER TECH DIRECTOR	LVT	EXISTING	CMUP	CMUP	CMUP	CMUP	SEE RC				
125	HALL	LVT	EXISTING	CMUP	CMUP		CMUP		P PLAN			
125 125A	SPARE	CONC	EXISTING	CMUP	CMUP	CMUP	CMUP	SEE RC				
125A 125B	SPARE	CONC	EXISTING	CMUP	CMUP	CMUP	CMUP		:P PLAN			
125C	SPARE	CONC	EXISTING	CMUP	CMUP	CMUP	CMUP	SEE RC				
126	ALTERNATE SCHOOL	LVT	EXIST/RB	CMUP	GBP	CMUP	CMUP	SEE RC				
127	WASH / DRY	LVT	EXIST / RB	GBP	CMUP	GBP	CMUP	SEE RC				
128	ACCESSIBLE TOILET	PT	EXIST / RB	GBP	CMUP	GBP	PT	SEE RC				PORCELAIN TILE ON WET WALL
129	OPEN MEETING ROOM	LVT	EXIST / RB	GBP	CMUP	CMUP	CMUP	SEE RC				. 55
130	CLASSROOM	EXISTING		CMUP	CMUP	CMUP	EMP	SEE RC				CLEAN EXISTING CONCRETE FLOOR
130A	TOOL CLOSET	EXISTING		CMUP	GBP	EMP	CMUP	SEE RC				CLEAN EXISTING CONCRETE FLOOR
131	WELDING LAB	EXISTING		CMUP	GBP	CMUP	CMUP		P PLAN			CLEAN EXISTING CONCRETE FLOOR
132	AVIATION TECH LAB	CONC	EXIST / RB	GBP	GBP	GBP	CMUP	SEE RC				
133	AUTO TECH LAB	CONC	EXIST / RB	GBP	GBP	GBP	CMUP		P PLAN			
134	HALL	LVT	EXIST / RB	CMUP	GBP	CMUP	CMUP	SEE RC				
134A	SPARE	LVT	EXISTING	CMUP	CMUP	CMUP	CMUP	SEE RC				
134B	SPARE	LVT	EXISTING	CMUP	CMUP	CMUP	CMUP		P PLAN			
UTU	OI AIL	LVI	LAIGHING	OIVIOI-	SIVIOI	OIVIOI-	OIVIOF	JEL NO	LETUN			

GENERAL NOTES

EXISTING CMU WALLS HAVE A STRUCTURAL GLAZED TILE BASE THAT MUST REMAIN. REMOVE PAINT, ETC. and LEAVE BASE CLEAN.

SIGN MOUNTING HEIGHT

703.4.1 HEIGHT ABOVE FINISH FLOOR OF GROUND

TACTILE CHARACTERS ON SIGNS SHALL BE LOCATED 48 INCHES (1220 mm) MINIMUM ABOVE THE FINISH FLOOR OR GROUND SURFACE, MEASURED FROM THE BASELINE OF THE LOWEST TACTILE CHARACTER AND 60 INCHES (1525 mm) MAXIMUM ABOVE FINISH FLOOR OR GROUND SURFACE, MEASURED FROM THE BASELINE OF THE HIGHEST TACTILE CHARACTER.

EXCEPTION: BRAILLE PROVIDED ON ELEVATOR CAR CONTROLS SHALL BE SEPARATED $\frac{3}{16}$ INCHES (4.8 mm) MINIMUM AND SHALL BE LOCATED EITHER DIRECTLY BELOW OR ADJACENT TO THE CORRESPONDING RAISED CHARACTERS OR SYMBOLS.

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WHERE A TACTILE SIGN IS PROVIDED AT A DOOR, THE SIGN SHALL BE LOCATED ALONGSIDE THE DOOR AT THE LATCH SIDE. WHERE A TACTILE SIGN IS PROVIDED AT DOUBLE DOORS WITH ONE ACTIVE LEAF, THE SIGN SHALL BE LOCATED ON THE INACTIVE LEAF. WHERE A TACTILE SIGN IS PROVIDED AT DOUBLE DOORS WITH TWO ACTIVE LEAFS, THE SIGN SHALL BE LOCATED TO THE RIGHT OF THE RIGHT HAND DOOR. WHERE THERE IS NO WALL SPACE AT THE LATCH SIDE OF A SINGLE DOOR OR AT THE RIGHT SIDE OF DOUBLE DOORS, SIGNS SHALL BE LOCATED ON THE NEAREST ADJACENT WALL. SIGNS CONTAINING TACTILE CHARACTERS SHALL BE LOCATED SO THAT THE CLEAR FLOOR SPACE OF 18 INCHES (455 mm) MINIMUM, CENTERED ON THE TACTILE CHARACTERS, IS PROVIDED BEYOND THE ARC OF ANY DOOR SWING BETWEEN THE CLOSEST POSITION AND 45 DEGREE OPEN POSITION

CHARACTERS, IS PROVIDED BEYOND THE ARC OF ANY DOOR SWING BETWEEN THE CLOSEST POSITION AND 45 DEGREE OPEN POSITION.

EXCEPTION: SIGNS WITH TACTILE CHARACTERS SHALL BE PERMITTED ON THE PUSH SIDE OF DOORS WITH CLOSERS AND WITHOUT HOLD-OPEN DEVICES.


SIGNAGE NOTES:

FURNISH INDIVIDUAL PLASTIC LAMINATE SIGNAGE SYSTEM WITH ROOM OR OCCUPANT'S NAME AND ROOM NUMBER. FINAL WORDING TO BE FURNISHED WHEN SHOP DRAWINGS FOR SIGNAGE SYSTEM ARE SUBMITTED. FURNISH INDIVIDUAL PLASTIC LAMINATE RESTROOM SIGNS FOR DOOR(S) AND HANDICAPED ACCESS SIGN TO BE PLACED ON WALL BESIDE RESTROOM DOOR(S) -SEE DIAGRAM.


LABELED DOOR AND FRAME NOTE:


NOTATION: "FIRE DOOR, TO BE EQUIPPED WITH FIRE EXIT HARDWARE"


HOURLY RATING DESIGNATIONS AND / OR ALPHABETICAL LETTER DESIGNATIONS ARE GIVEN WHERE PROTECTED OPENINGS ARE REQUIRED IN RATED PARTITIONS. THESE OPENING PROTECTIVE ASSEMBLIES SHALL INCLUDE THE FRAME, DOOR, HARDWARE, CLOSING DEVICE, SILL AND ANCHORAGE. CONTRACTOR SHALL SEE THAT NO COMPONENT IS OMITTED OR SUBSTANDARD QUALITY USED SUCH THAT THE EFFECTIVENESS OF THE ENTIRE OPENING AS A FIRE OR SMOKE BARRIER MIGHT BE JEOPARDIZED. DOORS AND FRAMES SHALL BE FURNISHED WITH UNDERWRITER'S LABORATORIES OR WARNOCKHERSEY LABELS WITH APPROPRIATE FIRE RESISTANCE RATINGS FOR THE CLASS OF OPENING SCHEDULED. SUBJECT TO DOOR MANUFACTURER'S PROCEDURAL LIMITATIONS, LABELS SHOULD BEAR THE FOLLOWING

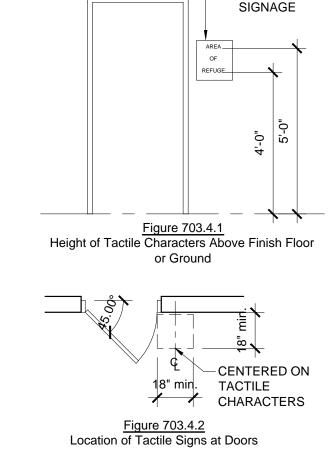



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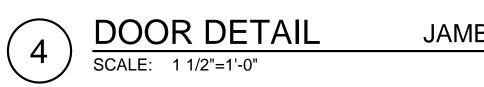


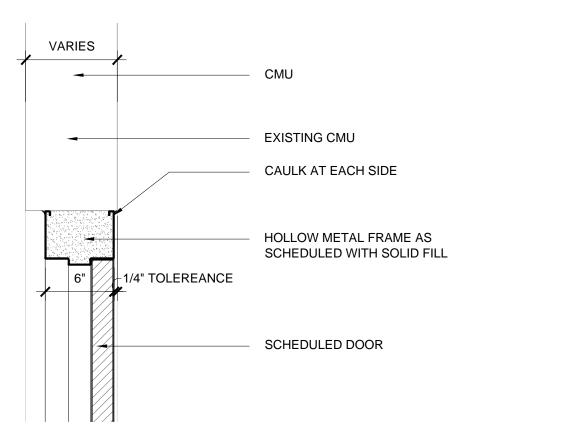


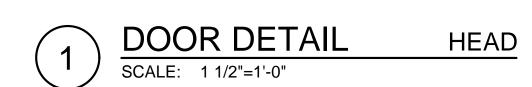DOOR DETAIL

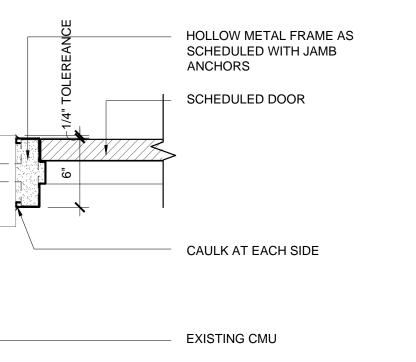
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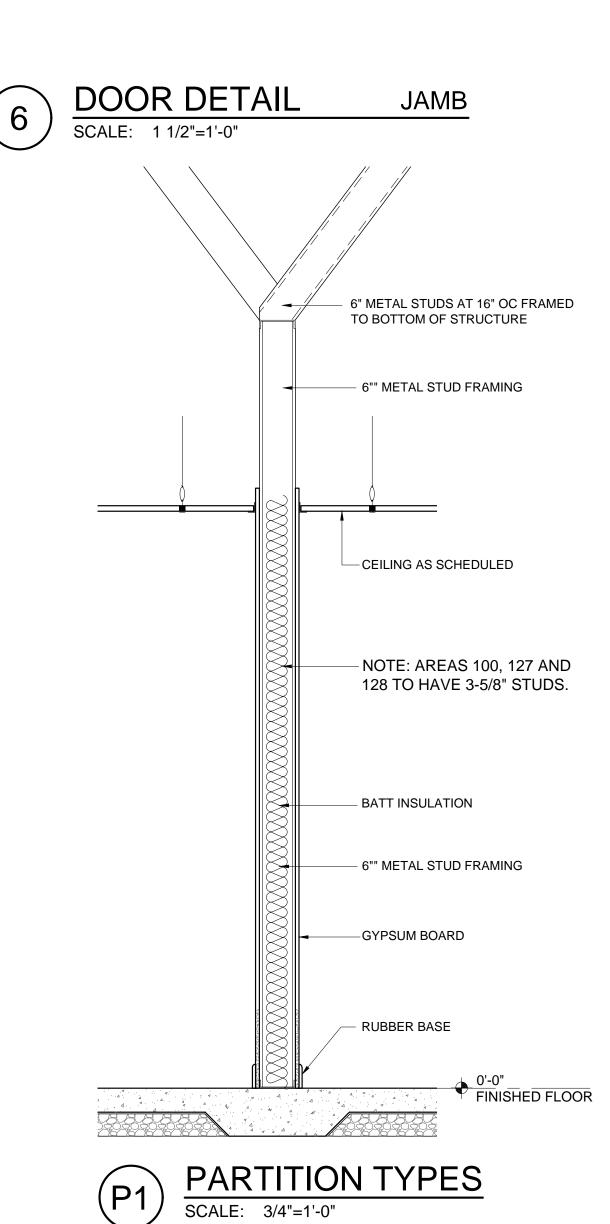
HEAD

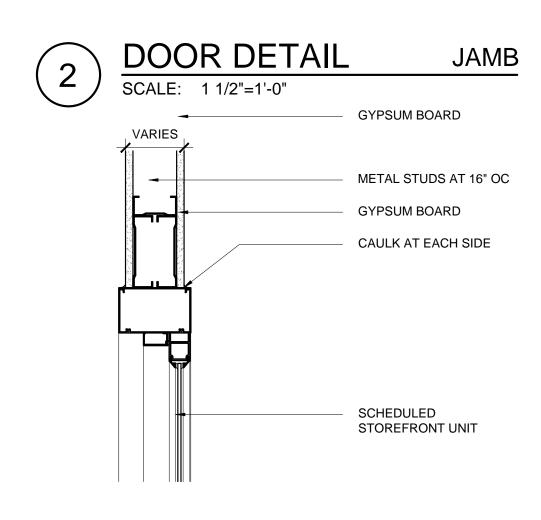


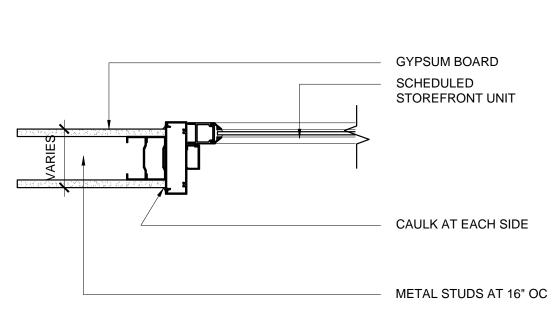

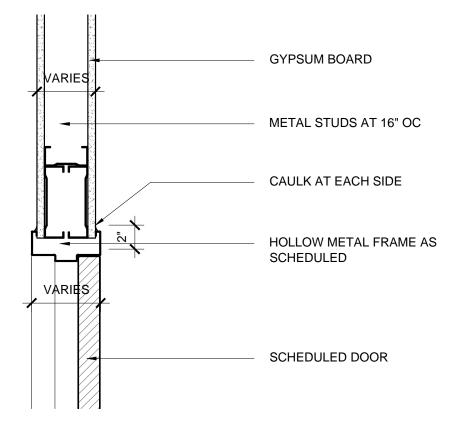



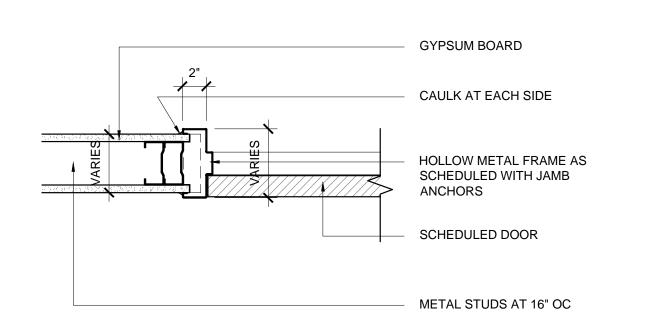

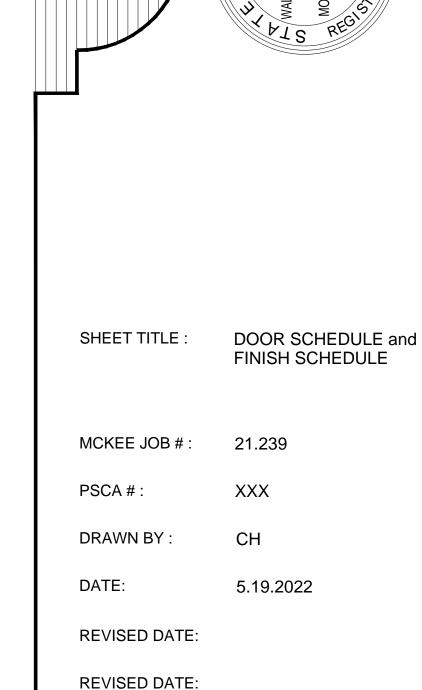

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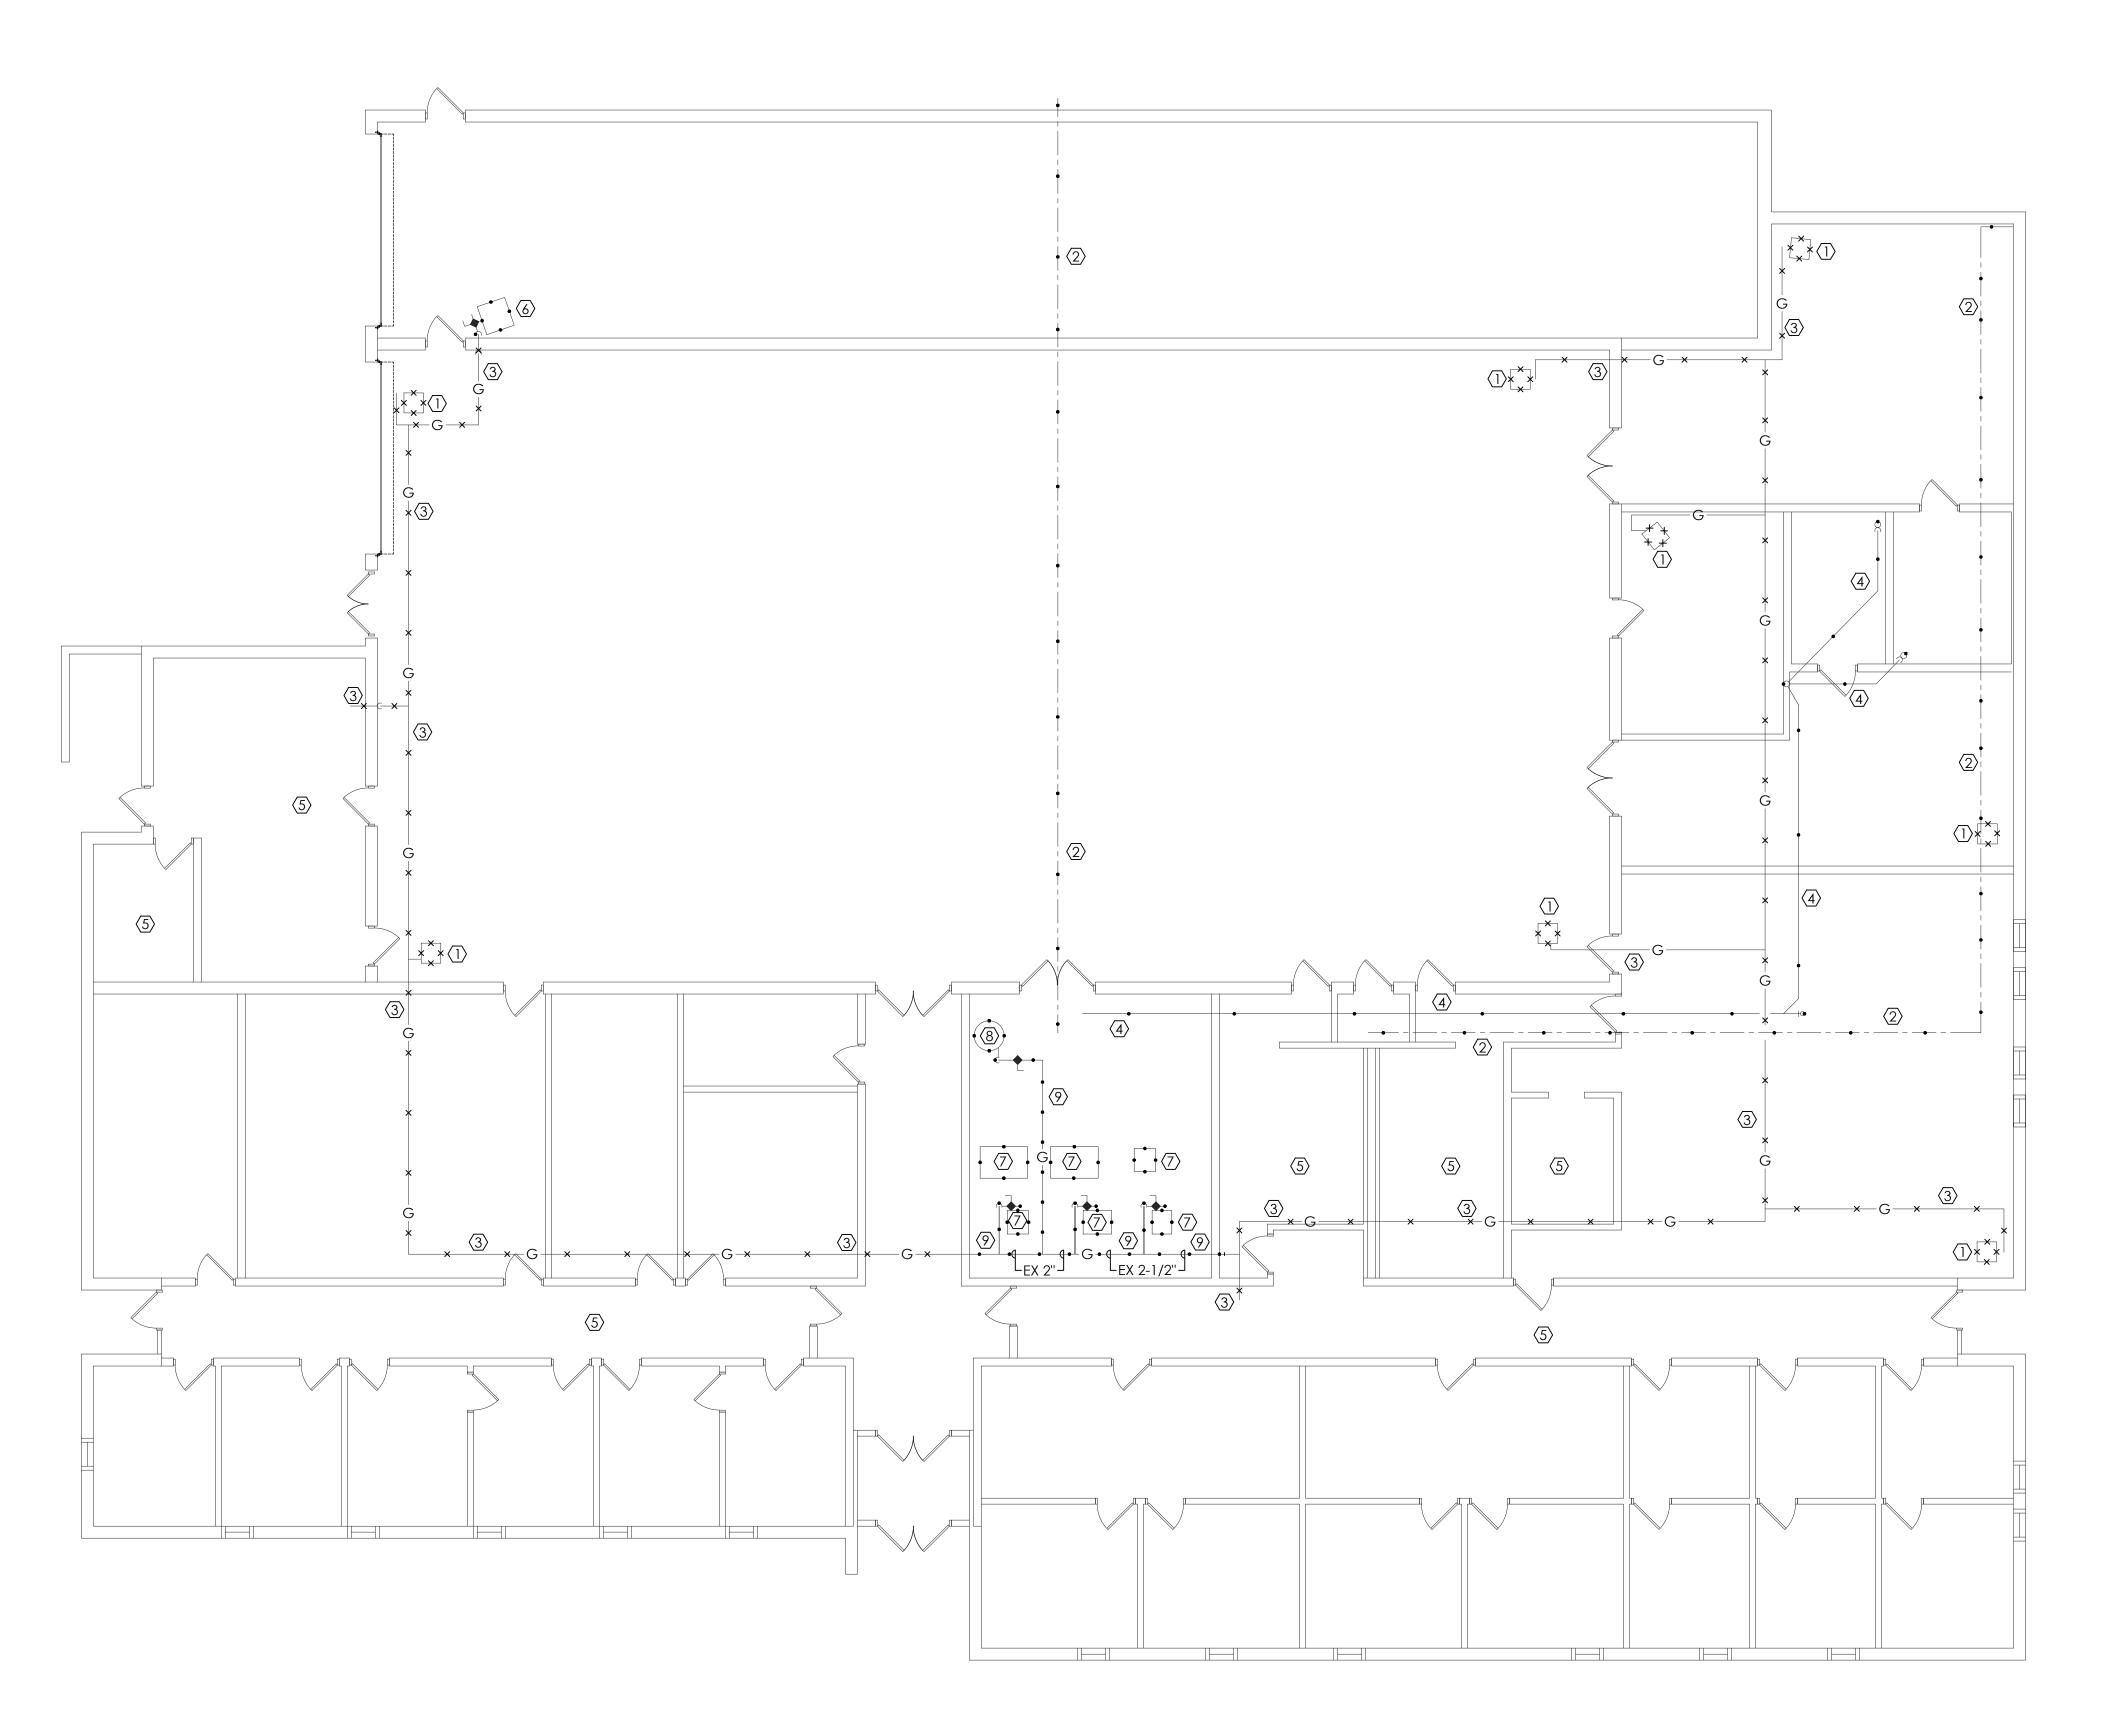
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SHEET NO.: A8.2





GENERAL DEMOLITION NOTES

- 1. CONTRACTOR SHALL REMOVE ALL EXISTING PLUMBING, AND EXISTING UTILITIES AS NOTED ON THIS DRAWING AND AS REQUIRED FOR INSTALLATION AND PROPER OPERATION OF NEW PLUMBING
- AND EQUIPMENT.

 2. CONTRACTOR SHALL VISIT THE SITE AND NOTIFY THE ARCHITECT IN WRITING OF ANY PROBLEMS OR DISCREPANCIES IN THE DRAWING
- BEFORE SUBMITTING A BID.

 3. PATCH AND PAINT ALL HOLES IN WALLS, FLOORS, CEILINGS AND ROOF DUE TO DEMOLITION OF CONSTRUCTION.

$\langle \# \rangle$ note legend: (This sheet only)

- I. EXISTING UNIT HEATER TO BE REMOVED BY OWNER. GAS PIPING
- TO BE CAPPED BY OWNER.

 2. EXISTING WATER TO REMAIN.
- ABANDON EXISTING GAS LINE.
 EXISTING WASTE LINE TO REMAIN.
- 5. NO WORK IN THESE AREA'S.
- 6. EXISTING UNIT HEATER AND GAS CONNECTION TO BE REMAIN.
 7. EXISTING MECHANICAL UNITS TO REMAIN SEE MECHANICAL
- 7. EXISTING MECHANICAL UNITS TO REMAIN. SEE MECHANICAL DRAWINGS.
- 8. EXISTING WATER HEATER AND ALL RELATED PIPING TO REMAIN.9. EXISTING GAS LINE TO REMAIN.

RENOVATIONS

TO THE
FOR THE
FOR THE
ASHLAND, ALABAMA
ARCHITECTS, INC.

SHEET TITLE : PLUMBING DEMOLITION FLOOR PLAN

MCKEE JOB #: 21.239

PSCA#:

DRAWN BY: SJW/ RLB

DATE: 5.19.2022

REVISED DATE:

REVISED DATE:


SCALE: 1/8" = 1'-0"


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NGINEERING

HVAC - PLUMBING - FIRE SPRINKLER DESIGN

SHEET NO.: PO.



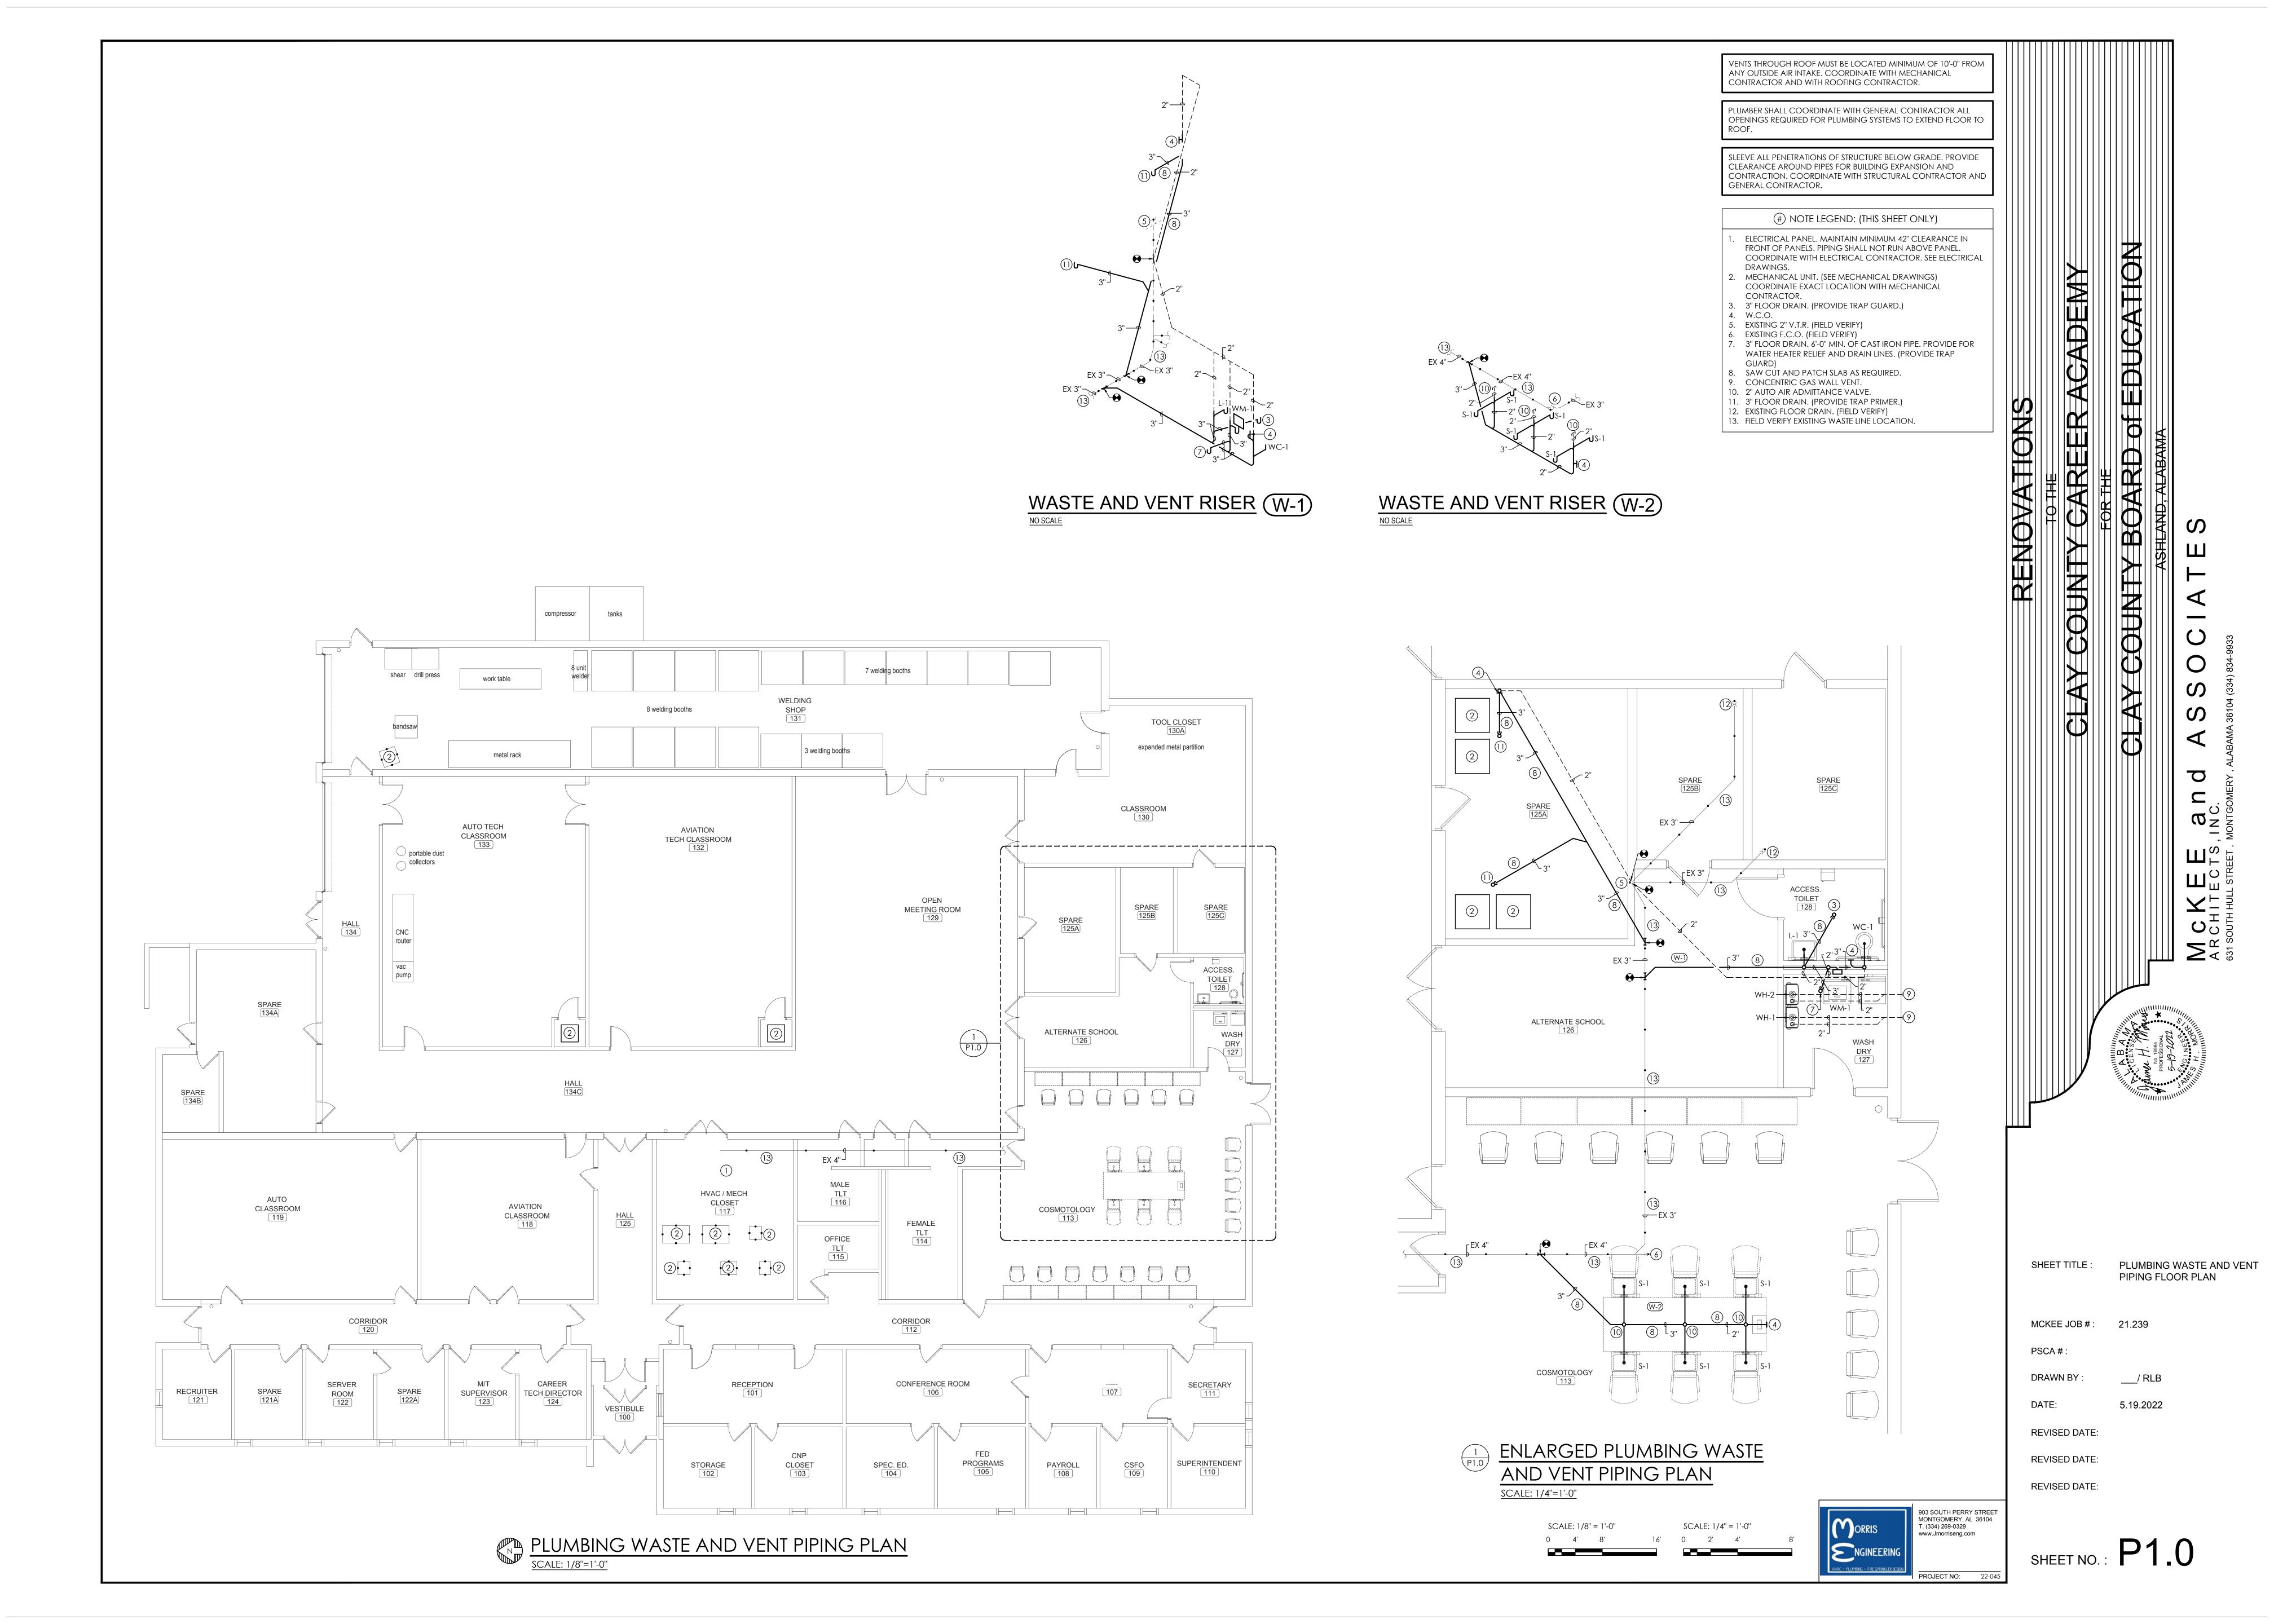


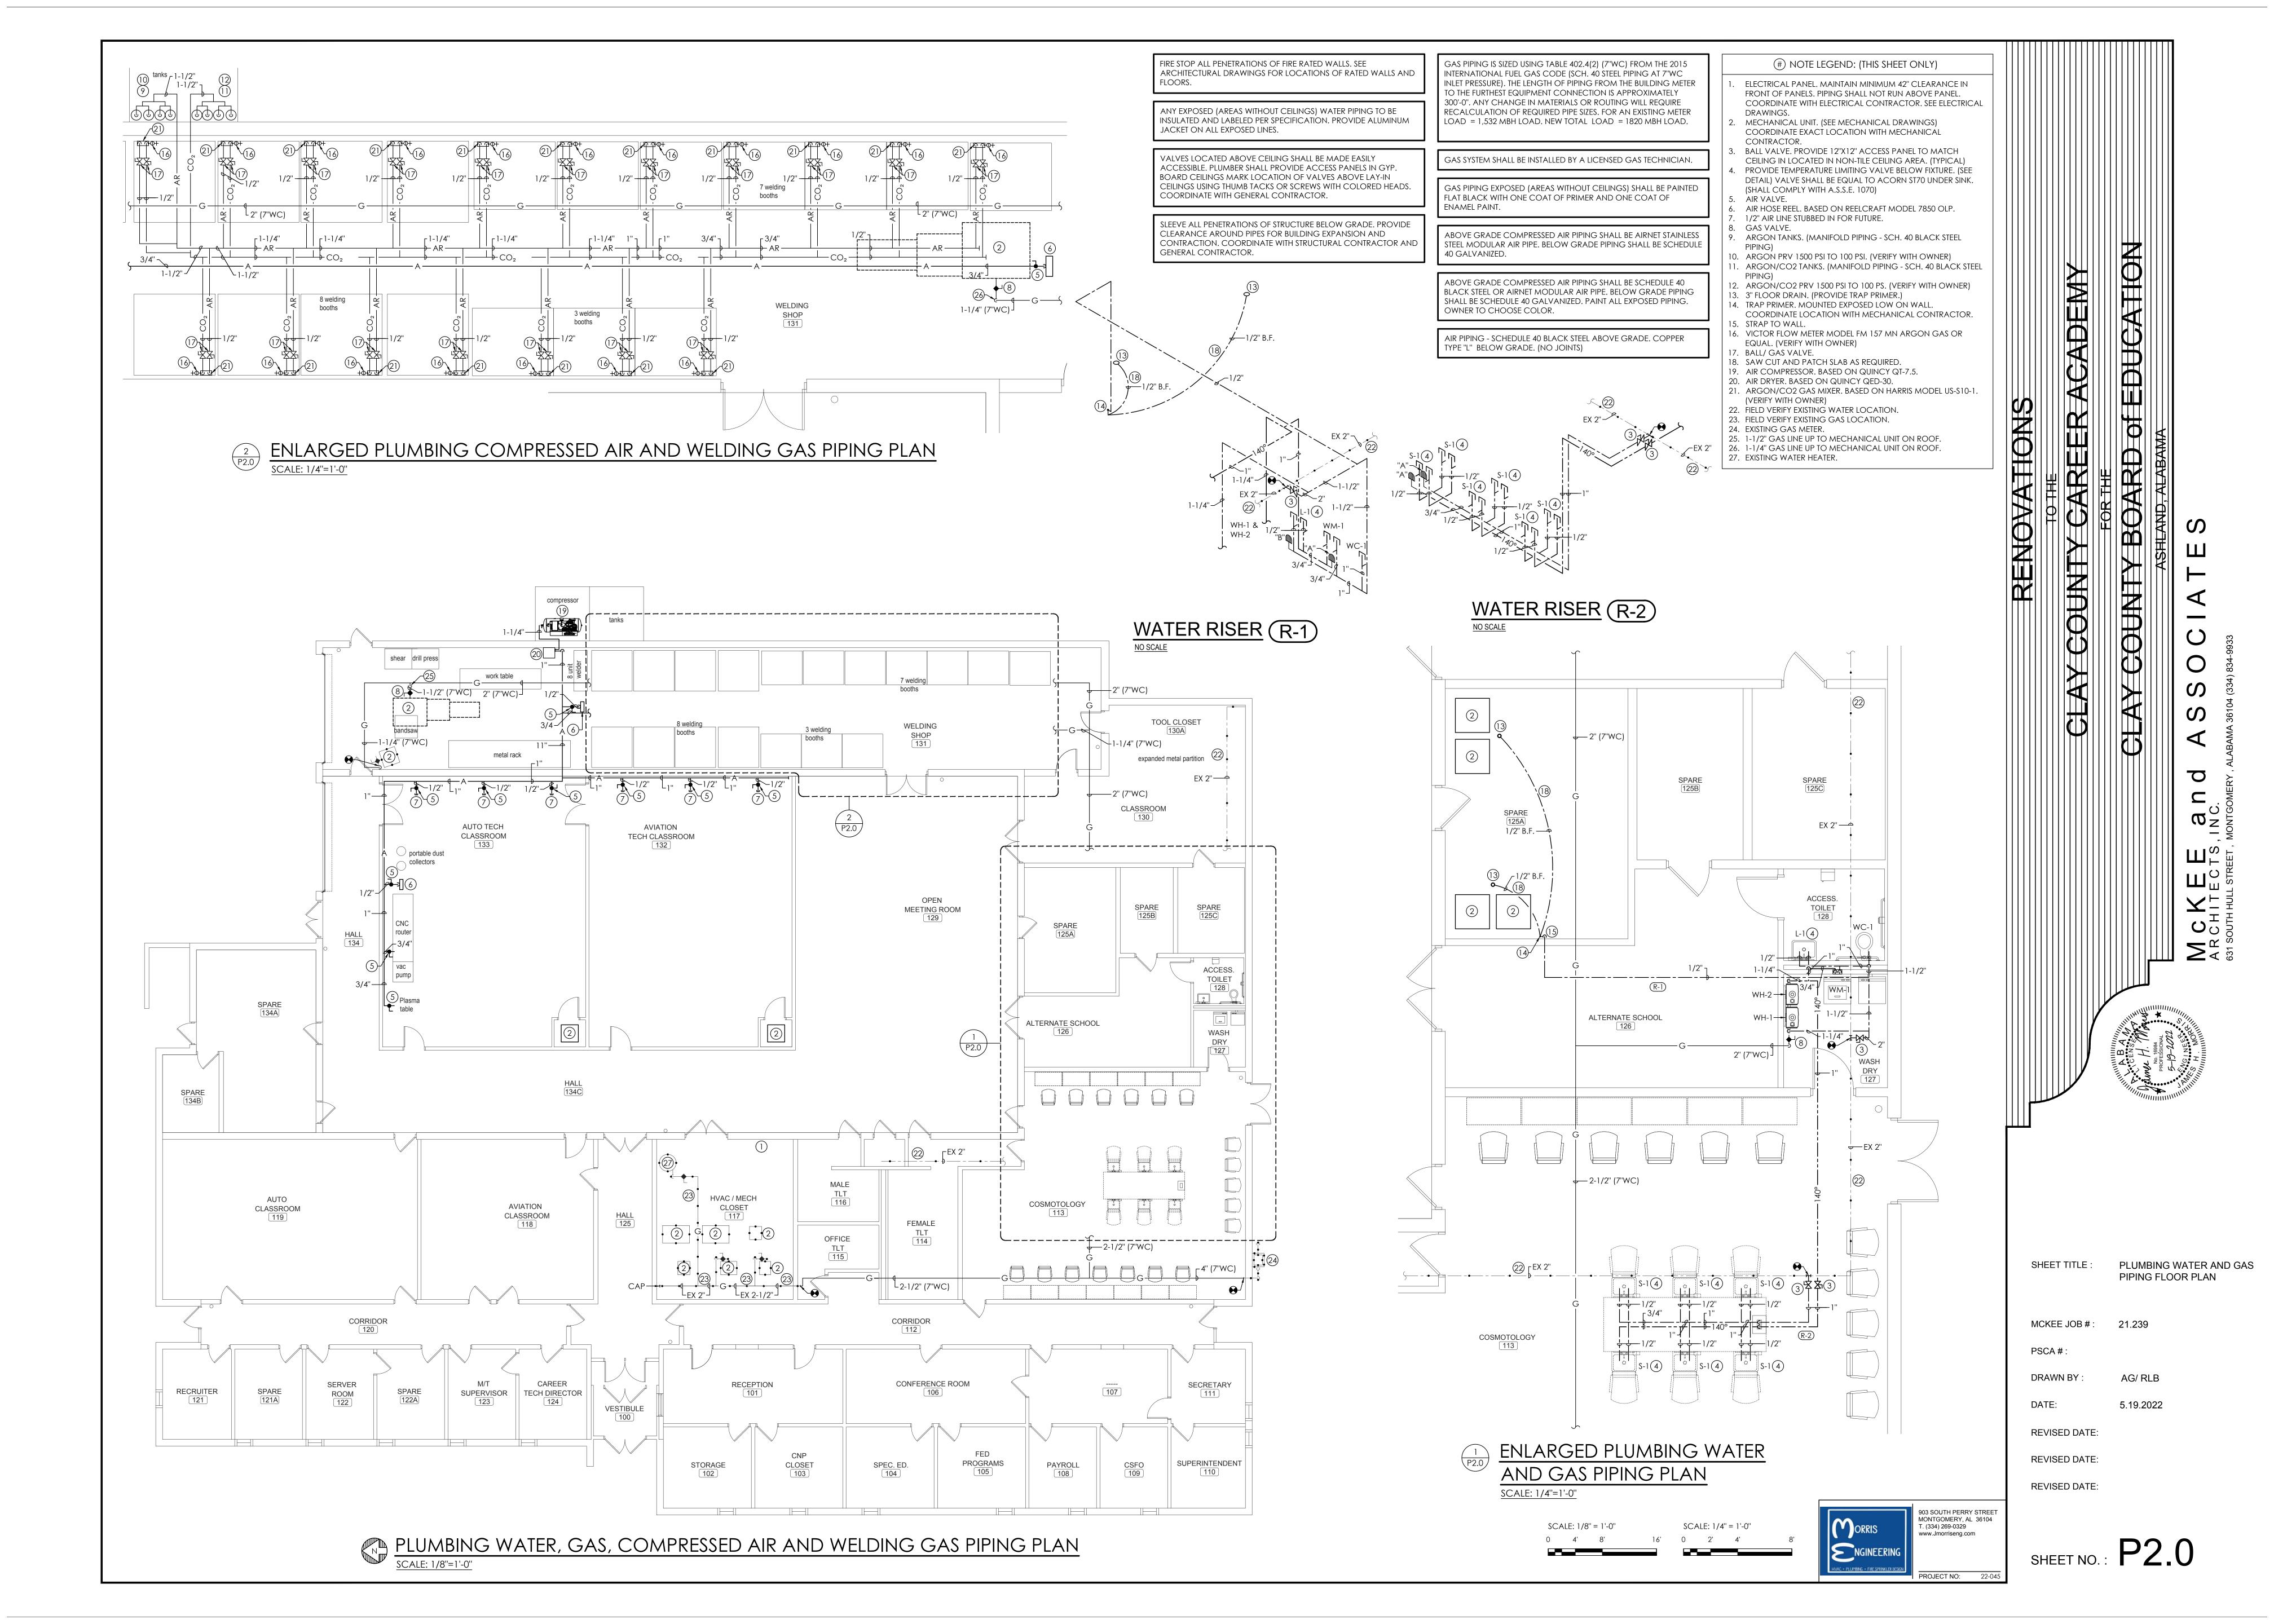PLUMBING GENERAL NOTES PROVIDE DISINFECTION OF WATER PIPING SYSTEM WITH CHLORINE SOLUTION AS PER CODE. 2. ALL OVERHEAD WATER PIPING TO BE RUN BELOW INSULATION AT BOTTOM OF TRUSSES FOR FREEZE PROTECTION. ALL REQUIRED OPENINGS AND EXCAVATIONS. ALL REQUIRED OPENINGS IN FOUNDATIONS, FLOORS, WALLS 3. INSTALLATION OF BACKFLOW PREVENTER SHALL COMPLY WITH THE 2015 INTERNATIONAL PLUMBING CODE. AND ROOFS SHALL BE DESIGNED INTO THE STRUCTURE INITIALLY BY THE USE OF SLEEVES, CURBS, ETC. CUTTING 4. ALL INDIRECT DRAINS TO HAVE INSULATED DEEP SEAL P-TRAPS.

- 5. ALL WALL HYDRANTS TO BE FREEZE PROOF AND TO HAVE VACUUM BREAKERS.
- 6. INSULATION ON ALL PIPING SHALL MEET SMOKE/ FLAME RATING OF 25 & 50.
- 7. ALL FLOOR DRAINS TO HAVE DEEP SEAL P-TRAPS. 8. INSTALL WATER HAMMER ARRESTORS AS FOLLOWS:
- A. LAY IN CEILING: MOUNT WATER HAMMER ARRESTOR ABOVE CEILING FOR ACCESS. B. SHEETROCK CEILING: MOUNT WATER HAMMER ARRESTOR IN CHASE WALL. PROVIDE 12" X 12" STAINLESS
- STEEL ACCESS PANEL IN WALL. THESE DRAWINGS NOT INTENDED TO SHOW ALL POSSIBLE CONDITIONS. IT IS INTENDED THAT A COMPLETE PLUMBING SYSTEM BE PROVIDED WITH ALL NECESSARY EQUIPMENT, APPURTENANCES AND CONTROLS, COMPLETELY COORDINATED WITH ALL DISCIPLINES. ALL PARAMETERS GIVEN IN THESE DOCUMENTS SHALL BE STRICTLY CONFORMED WITH ANY ITEMS AND LABOR REQUIRED FOR A COMPLETE PLUMBING SYSTEM IN ACCORDANCE WITH ALL APPLICABLE CODES, STANDARDS AND THESE CONTRACT DOCUMENTS SHALL BE FURNISHED WITHOUT INCURRING ANY ADDITIONAL COST TO THE PROJECT. CAREFULLY REVIEW ALL
- CONTRACT DOCUMENTS AND THE DESIGN OF OTHER TRADES BEFORE PREPARING SHOP DRAWINGS. 10. COORDINATE PLUMBING PIPING WITH STRUCTURAL, PLUMBING, HVAC AND ELECTRICAL. MAKE OFFSETS AND TRANSITIONS TO COORDINATE WITH OTHER TRADES WITHOUT ANY ADDITIONAL COST TO THE PROJECT.
- 11. NO PIPING TO BE RUN ABOVE ELECTRICAL PANELS. 12. THE CONTRACTOR SHALL VISIT THE SITE PRIOR TO ANY BID SUBMISSION TO FAMILIARIZE HIMSELF WITH THE EXISTING CONDITIONS. THE CONTRACTOR SHALL MAKE ADJUSTMENTS IN ROUTING AND LOCATION, IF NECESSARY, IN SIZE, IN ORDER TO ACHIEVE THE SPECIFIED PERFORMANCE WITHOUT INCURRING ADDITIONS TO THE CONTRACT. WHERE EXISTING CONDITIONS DIFFER SIGNIFICANTLY ENOUGH TO AFFECT PRICING, THE CONTRACTOR SHALL NOTIFY THE ARCHITECT PRIOR TO BID SUBMISSION FOR A RESOLUTION. NO ALLOWANCE WILL BE MADE FOR LACK OF KNOWLEDGE OF EXISTING CONDITIONS.
- 13. MAINTAIN A MAXIMUM OF 55 PSIG WATER PRESSURE AT PLUMBING FIXTURES, CONSISTENT WITH ADEQUATE
- 14. ALL WASTE AND VENT IN CORRIDOR WALLS, RATED WALLS OR RETURN AIR PLENUMS TO BE CAST IRON PIPE. 15. ALL VTR'S TO BE CAST IRON (3'-0" MIN. LENGTH) AT ROOF PENETRATION.
- 16. SUPPORT PIPE AS REQUIRED BY THE 2015 INTERNATIONAL PLUMBING CODE. 17. FIRESTOP ALL RATED WALLS AND FLOOR PENETRATIONS. SEE ARCHITECTURAL DRAWINGS FOR RATED WALL
- AND FLOOR LOCATIONS.


WITH ANY DRAINS, SCUTTLES, JOINTS, VENTS, EQUIPMENT, ETC.

- 18. COORDINATE ALL PLUMBING IN SLAB WITH BUILDING FOOTINGS. 19. OFFSET ALL VTR'S TO BACKSIDE OF ROOF RIDGE OR ON FLAT ROOF (AS SHOWN).
- 20. ALL CEILING ACCESS PANELS SHALL BE PAINTED TO MATCH CEILING.
- 21. PROVIDE FIRESTOPPING ASSEMBLIES AT ANY AND ALL FIRE-RATED PENETRATIONS. EQUAL TO ROXTEC. 22. DO NOT BEGIN WORK UNTIL ELEVATION OF FINAL CONNECTION POINT IS VERIFIED AND GRADING OF ENTIRE SYSTEM CAN BE DETERMINED (EVEN IF FINAL CONNECTION IS SPECIFIED UNDER ANOTHER SECTION).
- 23. PROVIDE 12"X12" CEILING ACCESS PANEL (MI FAB OR EQUAL) TO MATCH CEILING FOR ALL VALVES IF LOCATED IN TILE CEILING AREA. (TYPICAL) 24. ALL PLUMBING PRODUCTS THAT COME INTO CONTACT WITH POTABLE (DRINKABLE) WATER SHALL COMPLY
- WITH SAFE DRINKING WATER ACT (SDWA) AND THE REDUCTION OF LEAD IN DRINKING WATER. REDUCTION OF LEAD IN DRINKING WATER ACT THAT WENT INTO EFFECT ON JANUARY 4, 2014
- 25. THE CONTRACTOR SHALL EXECUTE ALL WORK SO THAT IT PROCEEDS WITH A MINIMUM OF INTERFERENCE WITH OTHER TRADES AND NORMAL FUNCTIONING OF EXISTING FACILITIES AND SERVICES.
- 26. VERIFY EXACT ROUGH-IN AND FINAL EQUIPMENT REQUIREMENTS IN FIELD 27. THE CONTRACTOR SHALL VERIFY THAT ALL PIPING, AS SHOWN ON THESE DRAWINGS WILL NOT CONFLICT

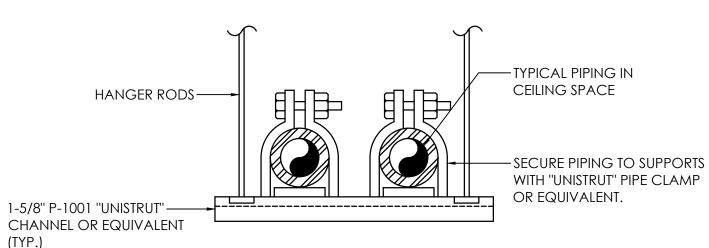

SUSPENDED PIPING SUPPORT AT **CEILING DETAIL**


NO SCALE

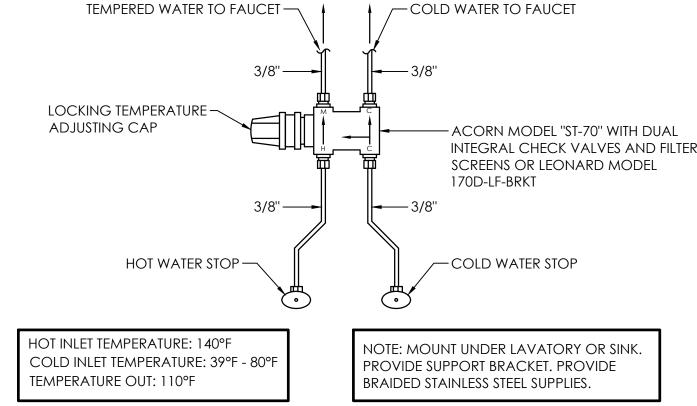

TEMPERATURE LIMITING VALVE

NO SCALE ~STRUCTURE SIDE BEAM CLAMP THREADED ROD CUT-TO LENGTH -CLEVIS HANGER -CARRIER PIPE -PIPE INSULATION NSULATION SADDLE OR SHIELD: SADDLE FOR PIPES 2-1/2" DIA. AND LARGER. SHIELD FOR PIPES 2" AND SMALLER, SHIELD LENGTH = 1.5 X

PIPE HANGER DETAIL

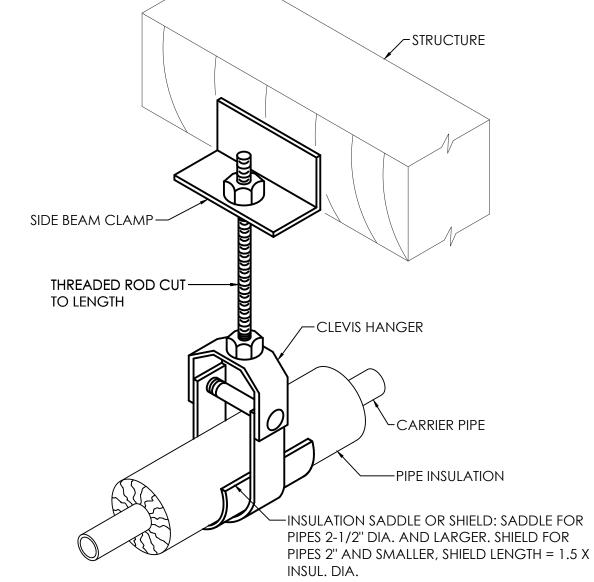

NO SCALE



28. COORDINATE ROUTING AND LOCATIONS OF WASTE AND VENT PIPING WITH ALL OTHER TRADES. 29. THE PLUMBING CONTRACTOR SHALL COORDINATE WITH THE GENERAL CONTRACTOR AND OTHER TRADES,

- AND PATCHING SHALL BE HELD TO A MINIMUM. 30. ALL ITEMS PROJECTING THROUGH THE ROOF SHALL BE FLASHED A MINIMUM OF 12" ABOVE THE ROOF. ALL
- VENTS SHALL BE A MINIMUM OF 10'-0" FROM ANY OUTSIDE AIR INTAKE DEVICE. 31. PROVIDE STOPS AND SHOCK ABSORBERS AT EACH FIXTURE OR GROUP OF FIXTURES.
- 32. THE CONTRACTOR SHALL BE RESPONSIBLE FOR ALL FINAL CONNECTIONS TO GAS FIRED EQUIPMENT AND SPECIFIED FIXTURES. ALL GAS FIRED EQUIPMENT AND FIXTURES SHALL BE OPERABLE.
- 33. PROVIDE VACUUM BREAKERS AT FIXTURES WITH HOSE THREAD CONNECTIONS AND APPLIANCES WITH DIRECT CONNECTIONS TO DOMESTIC WATER.
- 34. WHERE DISSIMILAR PIPING MATERIALS (STEEL AND COPPER) ARE CONNECTED, INSTALL A THREADED BRASS NIPPLE FOR PIPE SIZES 2" AND LESS. FOR PIPE SIZES 2-1/2" AND ABOVE, INSTALL ISOLATING FLANGES.
- DIELECTRIC UNIONS ARE NOT TO BE USED EXCEPT AT THE WATER HEATERS. 35. ALL WATER LINES INSTALLED IN EXTERIOR WALLS SHALL BE INSTALLED INSIDE OF WALL INSULATION AND
- INSULATED INDIVIDUALLY TO PROTECT FROM FREEZING PIPING AND FITTINGS.
- 36. ALL PLUMBING FIXTURES SHALL BE WHITE. (UNLESS STATED OTHERWISE) 37. INSTALL "TRAPGUARD" FOR FLOOR DRAINS IN BATHROOMS, RESTROOMS, JANITOR, MECHANICAL ROOMS AND PARTY ROOM FLOOR DRAINS. ALL FLOOR DRAINS ARE TO HAVE 4" DEEP SEAL TRAPS AND "TRAPGUARD".
- (NO EXCEPTIONS). 38. PROVIDE APPROVED BACKFLOW PREVENTION AT ALL EQUIPMENT DIRECTLY CONNECTED TO WATER SYSTEM
- 39. PROVIDE CLEANOUTS EVERY 75'-0" OR AT EACH CHANGE IN DIRECTION MORE THAN 45° AS REQUIRED BY CODE. COORDINATE LOCATIONS WITH ARCHITECT. 40. PROVIDE PRESSURE REDUCING VALVE IF THE INCOMING PRESSURE EXCEEDS 80 PSI. IF A PRV IS UTILIZED THEN IT

SHALL BE SET TO 80 PSI. IT IS THE RESPONSIBILITY OF THE CONTRACTOR TO DETERMINE IF REQUIRED.

- 41. THESE PLANS (ALL PLUMBING SHEETS) ARE SCHEMATIC IN NATURE AND ARE INTENDED TO ESTABLISH SIZE, GENERAL ROUTING, LOCATION, PERFORMANCE AND ARE NOT INTENDED TO SHOW ALL POSSIBLE CONDITIONS. ALL WORK SHALL BE FULLY COORDINATED WITH OTHER TRADES TO INSURE THE INSTALLATION OF A COMPLETE OPERABLE SYSTEM THAT FITS IN THE SPACE ALLOTTED. PROVIDE ALL LABOR, EQUIPMENT, APPURTENANCES AND MATERIALS NECESSARY, AND PERFORM ALL OPERATIONS REQUIRED FOR THE INSTALLATION OF COMPLETE, FUNCTIONAL PLUMBING SYSTEMS AS OUTLINED ON THE DRAWINGS AND
- DESCRIBED IN THE SPECIFICATIONS. 42. ALL WORK SHALL COMPLY WITH APPLICABLE NATIONAL, STATE AND LOCAL CODES.

--- WALL OR PARTITION

1. FIRE STOP FOAM

3. RISER CLAMP

4. SLEEVE

2. FIRE STOP SEALANT

PIPE THRU STRUCTURE DETAIL

-GAS LINE

LGAS VALVE

TYPICAL GAS CONNECTION DETAIL

GAS FIRED EQUIPMEN

PIPE THRU STRUCTURE LEGEND:


PIPE THRU WALI

NO SCALE

- 43. VERIFY ALL POINTS OF CONNECTION WITH OTHER DISCIPLINES (LOCATION AND INVERT) PRIOR TO INSTALLATION. THIS SHALL INCLUDE EXISTING SITE UTILITIES AS WELL AS NEW SITE UTILITIES INSTALLED UNDER THE SCOPE OF WORK FOR THIS PROJECT.
- 44. COORDINATE WITH OTHER TRADES TO PREVENT INTERFERENCE WITH HVAC DUCTS, ELECTRICAL LIGHTING AND STRUCTURE IN THE CEILING PLENUMS.
- 45. WHEN / IF A CONFLICT EXISTS BETWEEN THE DRAWINGS AND SPECIFICATIONS, THE HIGHER STANDARD / DIRECTION SHALL APPLY. THE FINAL DECISION SHALL BE MADE BY THE ARCHITECT AND / OR ENGINEER. THE HIGHER PRICE SHALL BE INCLUDED IN THE BID PRICE.
- 46. COORDINATE ALL DWV PIPING WITH THE JOIST LAYOUT BELOW. COORDINATE THROUGH THE ARCHITECT, GENERAL CONTRACTOR, THIS SET OF CONSTRUCTION DOCUMENTS (STRUCTURAL / ARCHITECTURAL) ETC. THERE WILL NOT BE ANY CHANGE ORDERS ISSUED OR PAID FOR GENERAL / REQUIRED OFFSETS DUE TO THE FAILURE OF THE CONTRACTOR TO FAMILIARIZE HIMSELF WITH THE STRUCTURE PRIOR TO BID. THE SUBMITTED BID PRICE SHALL HAVE A ALLOWANCE FOR ALL REQUIRED OFFSETS, ETC.

PIPE THRU FLOOR

FLOOR DRAIN TOP

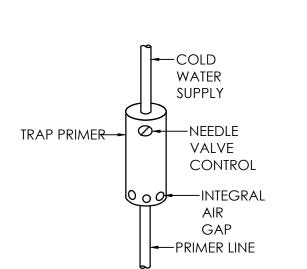


	PLUMBING FIXTURE SCHEDULE												
MARK	FIXTURE	COLD	НОТ	WASTE	REMARKS								
WC-1	WATER CLOSET (H/C) *	1/2"		3"	FLOOR MOUNTED, FLUSH VALVE (H/C)								
L-1	LAVATORY (H/C) * *	1/2"	1/2"	1-1/4"	WALL MOUNTED, PROVIDE LEVER TYPE HANDLES (H/C) HANG 34" RIM TO FINISHED FLOOR								
S-1	SHAMPOO BOWL	1/2"	1/2"	1-1/4"	WALL MOUNTED								
FI	XTURE SCHEDULE NOTES:												

* HANDLE TO WIDE SIDE OF STALL.

* * INSULATE P-TRAP, DRAIN AND SUPPLIES WITH HANDI LAV GUARD INSULATION KIT #102W OR EQUAL BY TRAP WRAP AND McGUIRE PRO WRAP.

TRAP PRIMER DETAIL

<u>no scale</u>

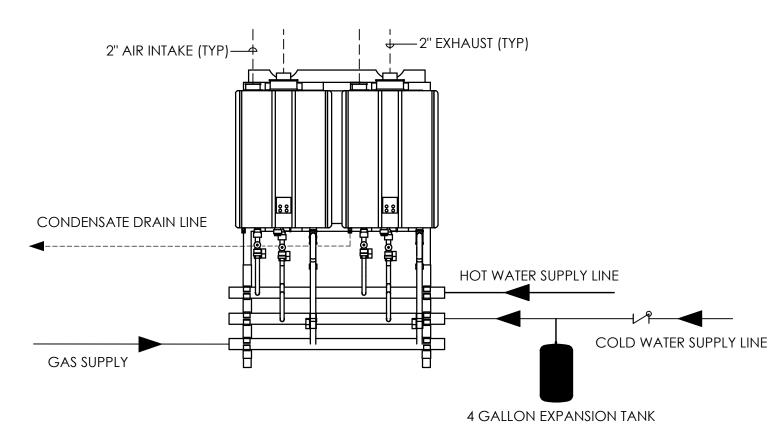

WATER HEATER CONNECTION DETAIL

NO SCALE: (WH-1) (WATER HEATER SUPPLIED BY OWNER AND INSTALLED BY PLUMBING CONTRACTOR)

NOTES (THIS DETAIL ONLY):

-TRAP GUARD ELASTOMERIC

-TYPICAL FLOOR DRAIN

QUINCY QED-30

(LOCATE ON INTERIOR)

DTE: PROVIDE TRAP SEAL PROTECTION FOR ALL FLOOR

DRAINS, HUB DRAINS, FLOOR SINKS AND INDIRECT DRAINS.

TRAP GUARD DETAIL

INSTALL AND SEAL TRAP GUARD ACCORDING TO MANUFACTURERS RECOMMENDATIONS.

FLOOR DRAIN

NO SCALE

COMPRESSOR

QUINCY QT-7.5

NO SCALE

FILTER QUINCY QPF 50 ———

(LOCATE ON INTERIOR WALL)

COMPRESSED AIR SYSTEM DETAIL

AND QUINCY QCF 50


INSERT FOR TRAP SEAL

- 1. CONDENSATE PIPING SHALL BE CPVC OR PVC MATERIAL AND SHALL NOT BE SMALLER THAN THE DRAIN CONNECTION
- ON THE APPLIANCE. 2. COMPONENTS OF THE CONDENSATE DRAINAGE SHALL BE CPVC OR PVC MATERIAL. ALL COMPONENTS SHALL BE
- SELECTED FOR THE PRESSURE AND TEMPERATURE RATING OF THE INSTALLATION. . WHERE THE DRAIN PIPES FROM MORE THAN ONE UNIT ARE MANIFOLDED TOGETHER FOR CONDENSATE DRAINAGE, THE
- PIPE OR TUBING SHALL BE SIZED IN ACCORDANCE WITH AN APPROVED METHOD AS DICTATED BY LOCAL CODES.
- 4. CONDENSATE MUST BE DISPOSED OF ACCORDING TO LOCAL CODES
- 5. SEE PLANS FOR PIPE SIZES.


-FLOW CONTROLLER

(LOCATE ON INTERIOR)

QUINCY PPFC-75

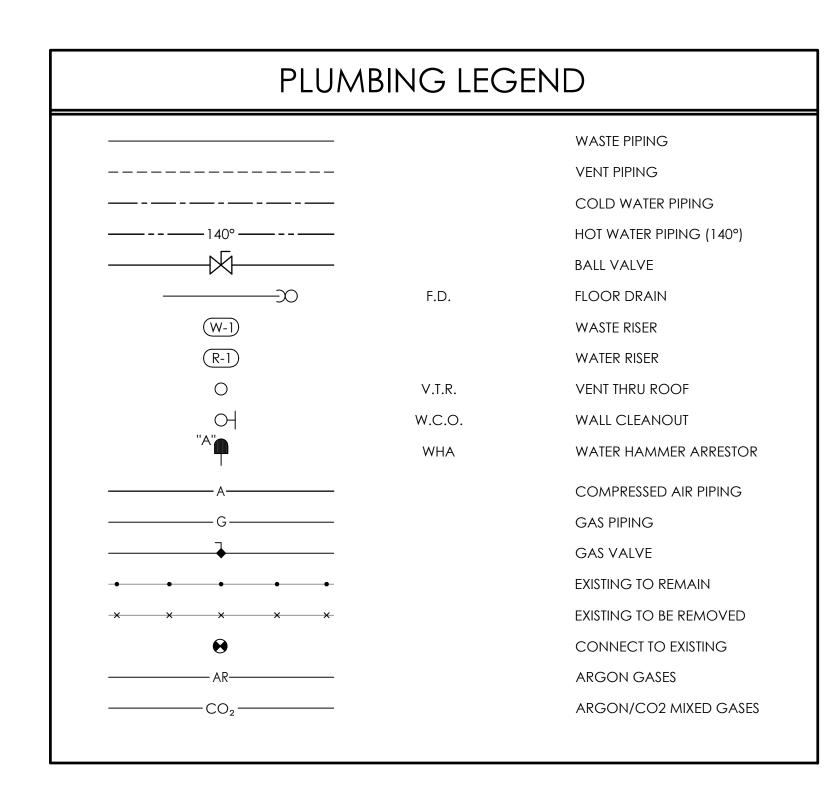



WATER HAMMER ARRESTOR SCHEDULE													
P.D.I. UNITS	А	В	С	D	Е	F							
FIXTURE UNITS	1-11	12-32	33-60	61-113	114-154	155-330							

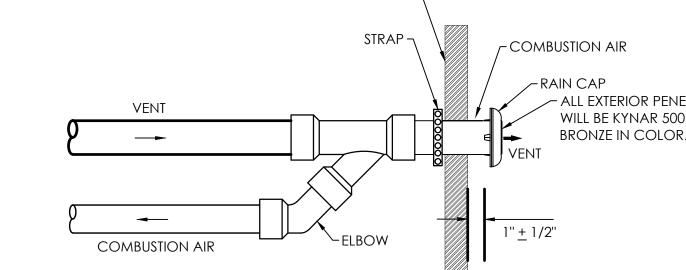



GAS VALVE(TYP.)

CONSENTRIC GAS VENT NO SCALE

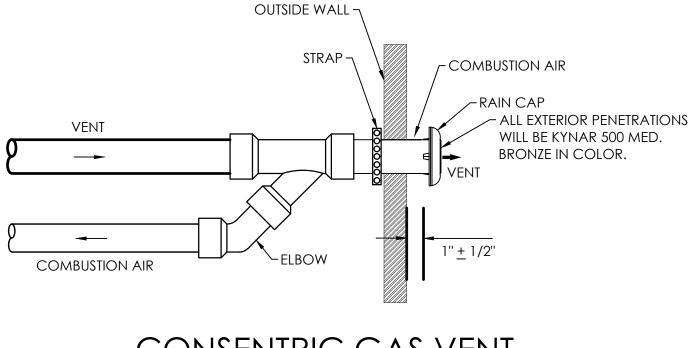


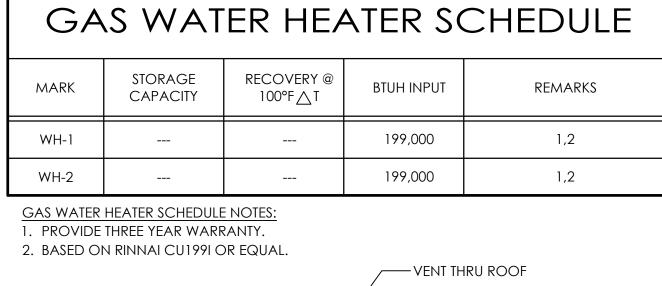

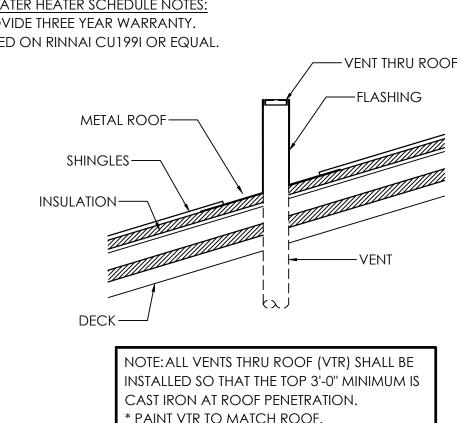

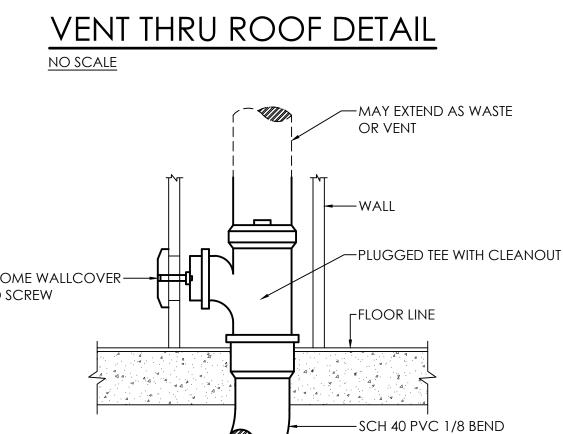



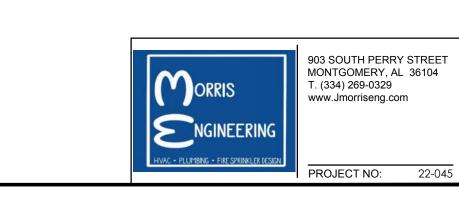

-BALANCE OF PIPING TO BE AS



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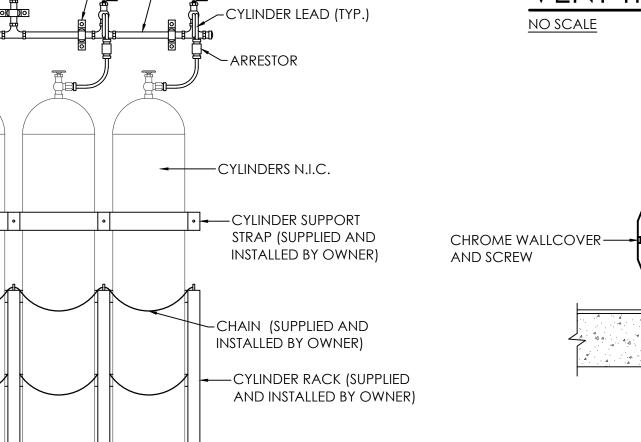
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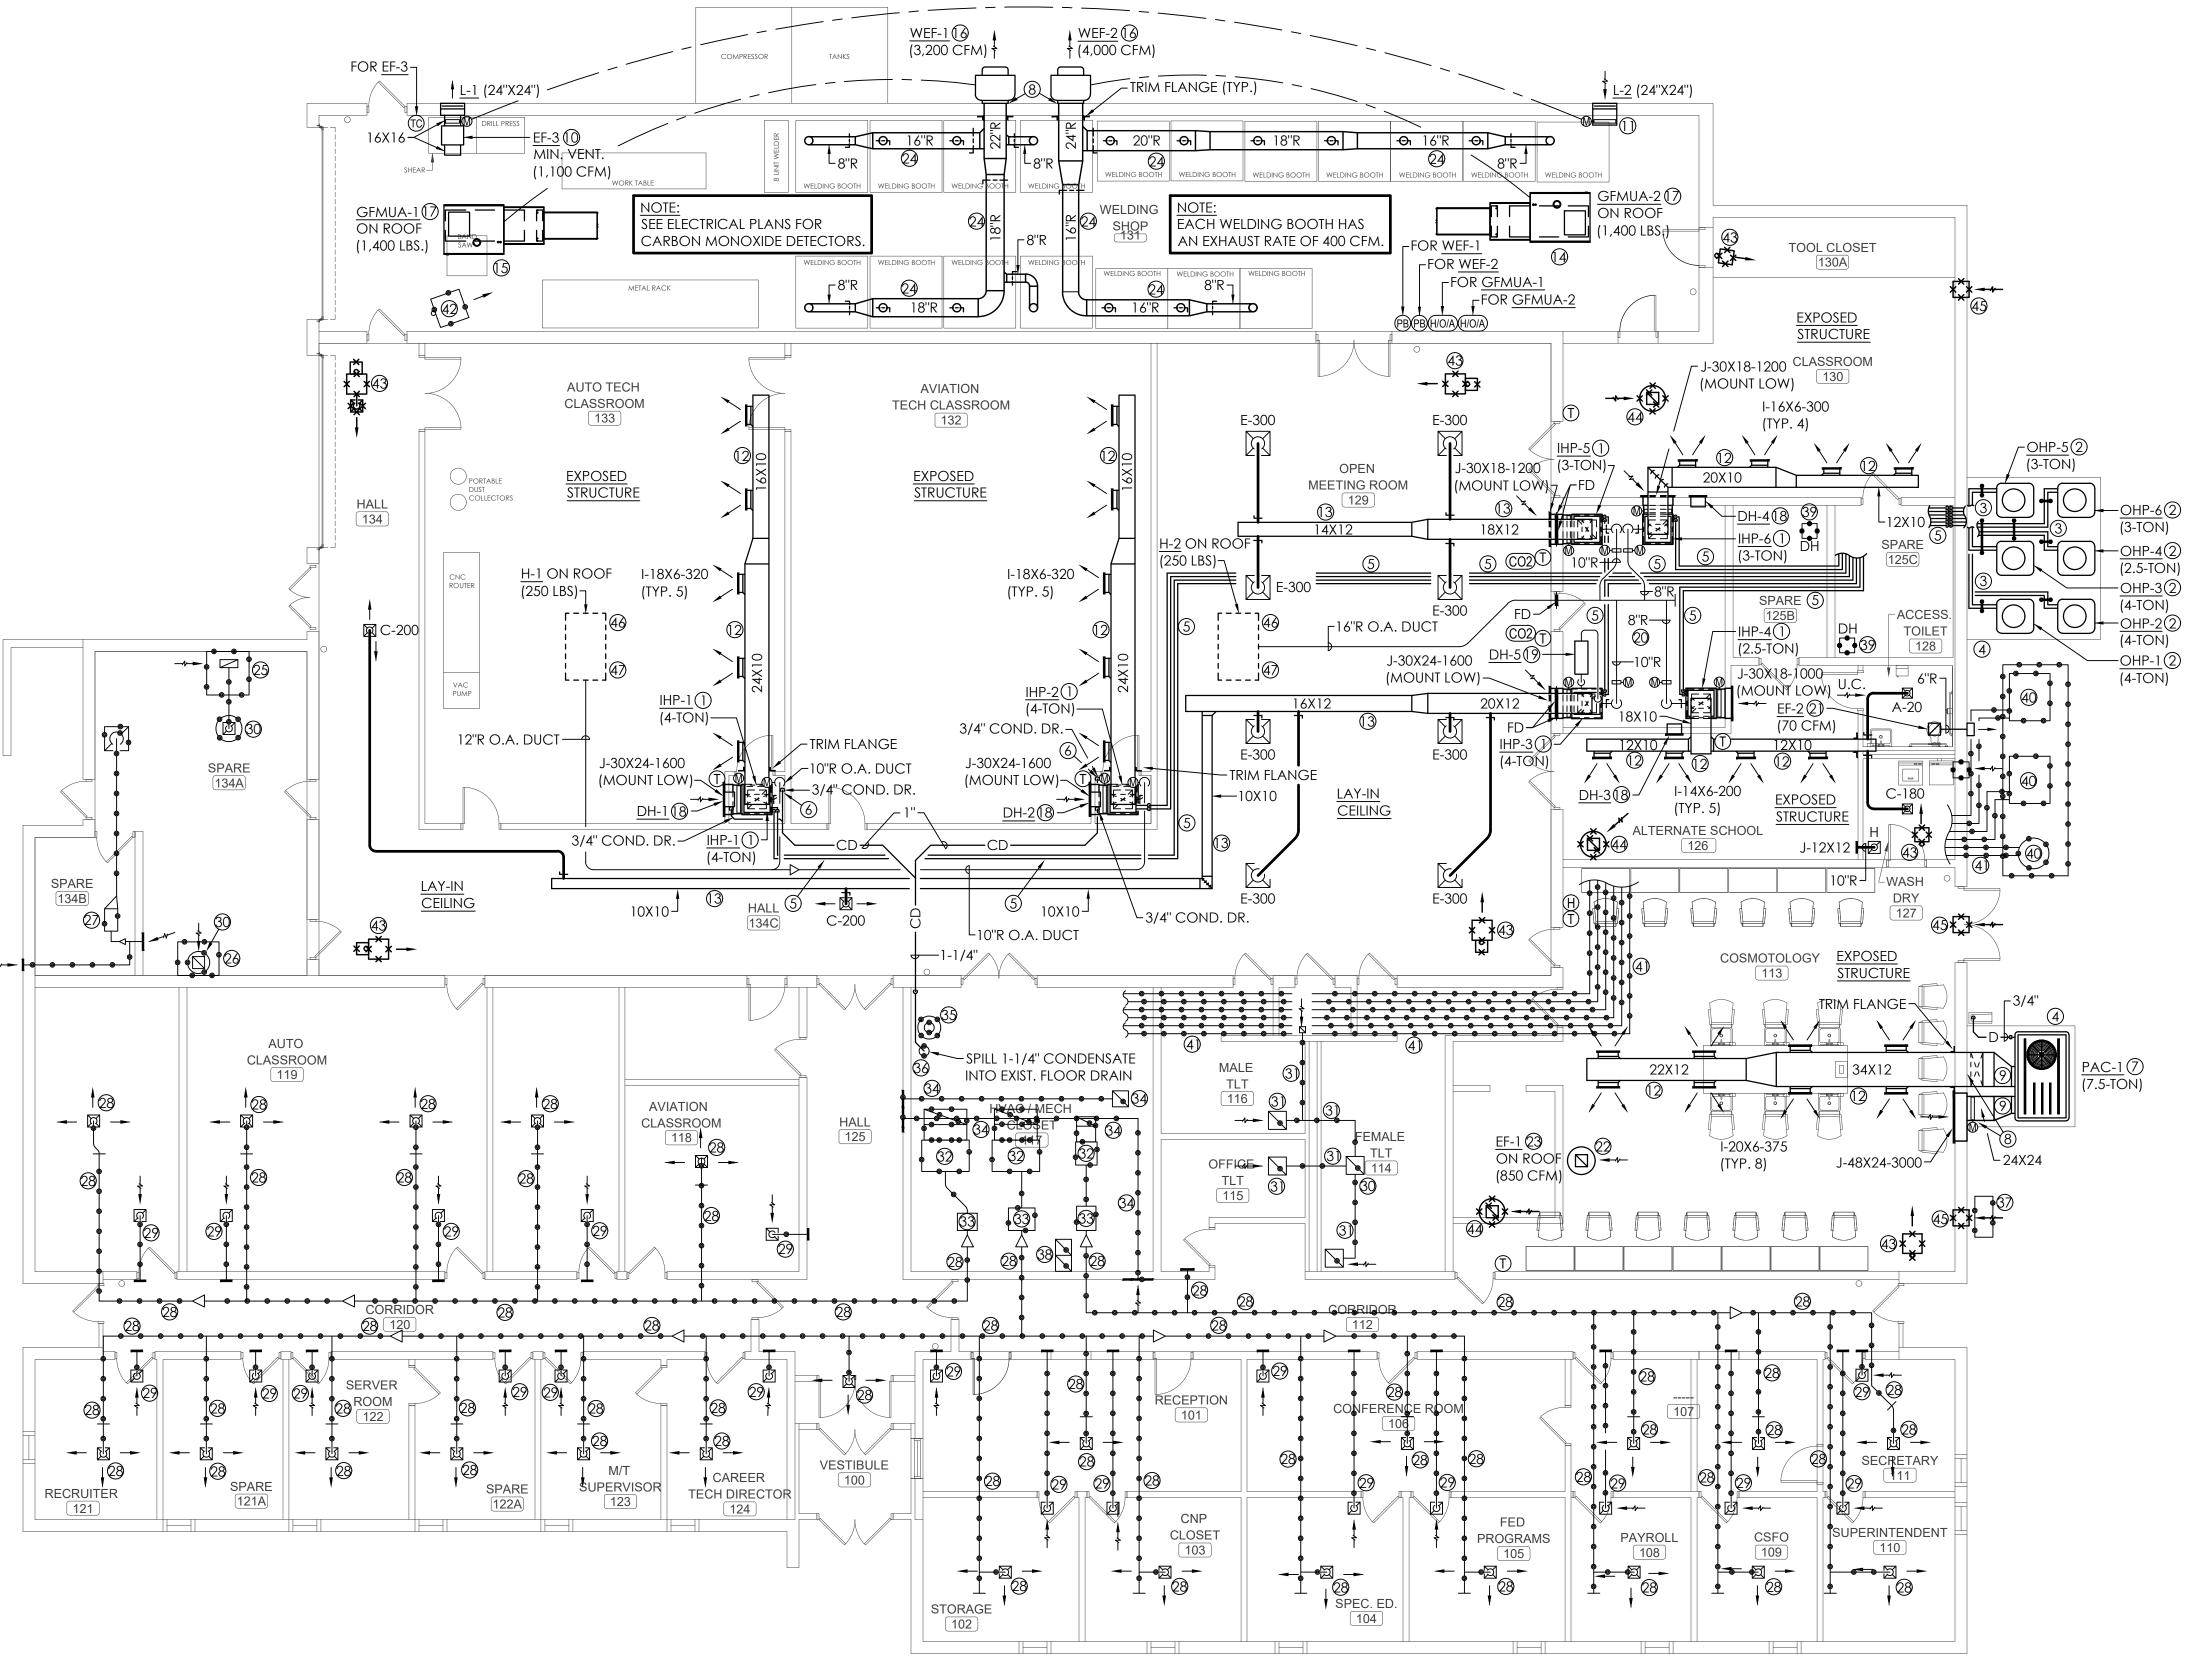


SUPPORT BRACKET (TYP.

(UNISTRUT TYPE SUPPORT)

GAS MANIFOLD AND RACK DETAIL

NOTE: FUEL GAS AND OXYGEN MANIFOLDS SHALL BE LISTED OR APPROVED EITHER SEPARATELY FOR EACH COMPONENT PART OR AS AN ASSEMBLED UNIT PER NFPA 51 5.1.1 & 5.2.2. (1) PROVIDE PRESSURE RELIEF FOR PIPING SYSTEM IN ACCORDANCE WITH NFPA 51 7.2



MECHANICAL FLOOR PLAN

SCALE: 1/8"=1'-0"

GENERAL NOTES: (THIS SHEET ONLY)

VERIFY LOCATION OF ALL THERMOSTATS AND WALL CONTROLS WITH

ARCHITECT BEFORE INSTALLATION. COORDINATE DUCTWORK WITH ALL TRADES TO AVOID CONFLICT. ANY COST OF RE-SIZING OR RE-ROUTING DUCTWORK TO COORDINATE WITH STRUCTURAL AND ALL OTHER TRADES SHALL BE AT THE

MECHANICAL CONTRACTOR'S EXPENSE. 3. ALL OUTSIDE AIR INTAKES SHALL BE MOUNTED AT LEAST 10'-0" AWAY FROM ALL EXHAUST RELIEFS AND PLUMBING VENTS.

4. CONTRACTOR SHALL VISIT THE SITE AND NOTIFY THE ENGINEER AND ARCHITECT IN WRITING OF ANY PROBLEMS OR DISCREPANCIES IN THE DRAWINGS BEFORE SUBMITTING A BID, ORDERING EQUIPMENT OR INSTALLATION OF EQUIPMENT AND ACCESSORIES.

MECHANICAL CONTRACTOR SHALL PROVIDE PROPER SERVICE CLEARANCE FOR EACH PIECE OF MECHANICAL EQUIPMENT

6. SEE LIFE SAFETY PLANS FOR ALL RATED WALLS. PROVIDE FIRE DAMPERS AT ALL RATED WALLS AND CEILINGS. COORDINATE WITH ARCH. LIFE SAFETY PLANS FOR RATED WALLS AND CEILINGS. MECHANICAL CONTRACTOR SHALL PROVIDE WIND RESTRAINTS ON EACH PIECE OF GRADE MOUNTED MECHANICAL EQUIPMENT - SEE

"OUTDOOR HEAT PUMP/CONDENSING UNIT DETAIL" FOR GRADE


MOUNTED NOTES. ARCHITECT SHALL COORDINATE WEIGHTS AND LOCATIONS FOR ALL NEW ROOF MOUNTED EQUIPMENT WITH STRUCTURAL ENGINEER.

MECHANICAL NOTE LEGEND: (THIS SHEET ONLY)


- (1) PROVIDE AND INSTALL A COMPLETE OPERATIONAL SPLIT SYSTEM AIR HANDLING UNIT WITH ALL RELATED CONTROLS, WIRING, ACCESSORIES, ETC. PROVIDE FACTORY
- RECOMMENDED SERVICE CLEARANCE TO UNIT. (2) PROVIDE AND INSTALL A COMPLETE OPERATIONAL SPLIT SYSTEM CONDENSING UNIT/HEAT PUMP UNIT WITH ALL RELATED CONTROLS, WIRING, ACCESSORIES, ETC.
- PROVIDE FACTORY RECOMMENDED SERVICE CLEARANCE TO UNIT. 3) REFRIGERANT PIPING AND CONTROL WIRING FROM OUTDOOR UNIT TO RELATED INDOOR UNIT. COVER EXTERIOR PIPING WITH ALUMINUM JACKET. INSTALL CONTROL WIRING IN EXTERIOR TYPE CONDUIT. MAXIMUM LENGTH OF FLEXIBLE CONDUIT SHALL BE 3'-0". STRAP CONDUIT AND REFRIGERANT PIPING TO ANCHORED UNISTRUT EVERY 3'-0"
- 4) MOUNT UNIT ON 4" THICK LEVEL CONCRETE PAD. PAD BY G.C.
- 5) RUN REFRIGERANT LINES ABOVE CEILING FROM INDOOR UNIT TO RELATED OUTDOOR
- UNIT. SEE "SUSPENDED REFRIGERANT PIPE SUPPORT AT CEILING DETAIL". PROVIDE AND INSTALL A "LITTLE GIANT" MODEL "VCMA" (OR APPROVED EQUAL) CONDENSATE PUMP WITH ALL RELATED PIPING, WIRING, ACCESSORIES, ETC. PUMP CONDENSATE UP TO ABOVE CEILING, RUN OVER TO EXISTING HVAC/MECH. CLOSET 117 TURN DOWN AND RUN TO EXISTING FLOOR DRAIN. INSULATE CONDENSATE DRAIN LINES AND PROVIDE PIPE SUPPORTS AS REQUIRED
- PROVIDE AND INSTALL A COMPLETE OPERATIONAL PACKAGED COOLING ONLY WITH ELECTRIC HEAT UNIT WITH ALL RELATED CONTROLS, WIRING, ACCESSORIES, ETC. PROVIDE SIDE DISCHARGE, FACTORY CONVENIENCE OUTLET AND FACTORY HOT-GAS RE-HEAT FOR DEHUMIDIFICATION. RUN 3/4" (FULL-SIZE) CONDENSATE DRAIN TO SPLASH-BLOCK ON GRADE.
-) Provide water and air tight seal at penetrations of exterior wall.) PROVIDE SHEET METAL COVER OVER EXTERIOR DUCTWORK AND DUCTWORK PENETRATIONS OF EXTERIOR WALL. PAINT SHEET METAL COVER TO MATCH BUILDING.
- (1) PROVIDE AND INSTALL A COMPLETE OPERATIONAL IN-LINE MOUNTED EXHAUST FAN WITH ALL RELATED CONTROLS, WIRING, MOUNTING HARDWARE, ACCESSORIES, ETC. FAN SHALL PROVIDE REQUIRED MINIMUM VENTILATION TO WELDING SHOP. PROVIDE WALL MOUNTED TIME-CLOCK SET TO ALLOW FAN TO RUN DURING ALL OCCUPIED TIMES. PROVIDE MOTORIZED DAMPER AT FAN AND INTERLOCK MOTORIZED DAMPER TO MOTORIZED DAMPER AT RELATED INTAKE LOUVER. (1)) PROVIDE AND INSTALL AN INTAKE LOUVER IN EXTERIOR WALL. LOUVER SHALL PROVIDE
- MAKE-UP AIR FOR REQUIRED MINIMUM VENTILATION TO WELDING SHOP. PROVIDE LINED PLENUM ON BACK-SIDE OF LOUVER FULL SIZE OF LOUVER. PROVIDE MOTORIZED DAMPER IN PLENUM. INTERLOCK MOTORIZED DAMPER WITH MOTORIZED DAMPER AT RELATED ROOF MOUNTED EXHAUST FAN AS SHOWN ON PLAN. SEE SEQUENCE OF OPERATION FOR MINIMUM VENTILATION EXHAUST FAN IN NOTE LEGEND NOTE #?. (2) RUN RECTANGULAR DUCTWORK EXPOSED IN SPACE. PROVIDE PAINT-GRIP FINISH AND
- PAINT TO MATCH EXPOSED STRUCTURE. VERIFY EXACT COLOR/FINISH WITH OWNER PRIOR TO PAINTING. COORDINATE DUCTWORK WITH ALL TRADES TO AVOID CONFLICT. DAMAGED/SCRATCHED/DENTED/ETC. DUCTWORK WILL NOT BE ACCEPTED AND SHALL BI REPLACED AT MECHANICAL CONTRACTOR'S EXPENSE.
- (3) RUN DUCTWORK ABOVE CEILING AND BELOW STRUCTURE. RE-ROUTE, RE-SIZE AND RE-SHAPE DUCTWORK AS REQUIRED TO FIT ABOVE CEILING, BELOW STRUCTURE AND TO COORDINATE WITH ALL TRADES TO AVOID CONFLICT. EXISTING ROOF MOUNTED EXHAUST FAN (SERVING EXISTING SMALL ARMS RANGE) AND
- ALL RELATED CONTROLS, ROOF CURB, WIRING, ACCESSORIES, ETC. TO BE REMOVED. EXISTING ROOF OPENING TO BE RE-USED FOR NEW GAS FIRED MAKE-UP AIR FAN UNIT. EXISTING ROOF MOUNTED INTAKE HOOD (SERVING EXISTING SMALL ARMS RANGE) AND ALL RELATED ROOF CURB, ACCESSORIES, ETC. TO BE REMOVED. EXISTING ROOF
- OPENING TO BE RE-USED FOR NEW GAS FIRED MAKE-UP AIR FAN UNIT. B PROVIDE AND INSTALL A COMPLETE OPERATIONAL WALL MOUNTED EXHAUST FAN WITH ALL RELATED CONTROLS, WIRING, MOUNTING HARDWARE, ACCESSORIES, ETC. FAN SHALL BE USED FOR WELDING BOOTH EXHAUST. INTERLOCK FAN WITH RELATED GAS FIRED MAKE-UP AIR UNIT AS SHOWN ON PLAN. PROVIDE PUSH-BUTTON ON/OFF SWITCH FOR FAN. SEE SEQUENCE OF OPERATION FOR RELATED GAS FIRED MAKE-UP AIR FAN IN NOTE LEGEND NOTE #15 BELOW.
- (1) PROVIDE AND INSTALL A COMPLETE OPERATIONAL ROOF MOUNTED GAS FIRED MAKE-UP AIR UNIT WITH ALL RELATED GAS PIPING (SEE PLUMBING PLANS FOR GAS PIPING), WIRING, CONTROLS, ROOF CURB, ACCESSORIES, ETC. PROVIDE DOWN/VERTICAL DISCHARGE. MOUNT UNIT ON NEW 20" TALL INSULATED ROOF CURB AND MOUNT DISCHARGE DIRECTLY OVER EXISTING ROOF OPENING. MAINTAIN AT LEAST 10'-0" FROM EDGE OF UNIT TO EDGE OF ROOF. PROVIDE FACTORY RECOMMENDED SERVICE CLEARANCE AROUND UNIT. INTERLOCK UNIT WITH RELATED WALL MOUNTED EXHAUST FAN AS SHOWN ON PLAN. PROVIDE HAND/OFF/AUTO SWITCH ON WALL. IN THE HAND POSITION, THE UNIT AND RELATED FAN SHALL RUN CONTINUOUSLY - IN THE AUTO POSITION, THE UNIT SHALL RUN SUBJECT TO RELATED FAN BEING ENERGIZED. PROVIDE 24"X24" SUPPLY DUCT DOWN AND TERMINATE 18" BELOW UNIT OPENING - COVER OPENING WITH WIRE-MESH SCREEN. PROVIDE THERMOSTAT IN SUPPLY DUCT -THERMOSTAT SHALL MODULATE GAS FURNACE TO MAINTAIN A 65-DEG. ADJUSTABLE
- DISCHARGE AIR TEMPERATURE. (8) PROVIDE AND INSTALL A COMPLETE OPERATIONAL WALL MOUNTED DEHUMIDIFIER WITH
- ALL RELATED CONTROLS, WIRING, ACCESSORIES, ETC. (19) Provide and install a complete operational side-stream dehumidifier with all RELATED CONTROLS, WIRING, ACCESSORIES, ETC. PROVIDE AUXILIARY DRAIN PAN WITH FLOAT MICR-SWITCH TO SHUT UNIT OFF IF WATER IS DETECTED. MOUNT UNIT HIGH AS POSSIBLE! SEE "DEHUMIDIFIER DETAIL" FOR DUCT CONN.
- (2) RUN CONDENSATE FOR AIR HANDLING UNITS AND DEHUMIDIFIERS TO FLOOR DRAINS IN THIS SPACE - SEE PLUMBING PLANS. (2) PROVIDE AND INSTALL A COMPLETE OPERATIONAL CEILING MOUNTED EXHAUST FAN
- WITH ALL RELATED CONTROLS, WIRING, ACCESSORIES, ETC. PROVIDE SPEED CONTROLLER ON FAN. INTERLOCK FAN WITH OCC. SENS./LIGHT SWITCH TO RUN CONTINUOUSLY DURING OCCUPIED TIMES. RUN EXHAUST DUCT OUT TO COOK MODEL "WC" WALL CAP OR APPROVED EQUAL. PROVIDE BAKED ENAMEL FINISH ON WALLCAP TO MATCH BUILDING.
- $\colone{1}{2}$ existing roof mounted exhaust fan and all related controls, wiring, ACCESSORIES, ETC. TO BE REMOVED. EXISTING ROOF CURB TO REMAIN. EXISTING ROOF OPENING TO BE RE-USED FOR NEW ROOF MOUNTED EXHAUST FAN. PROVIDE CURB ADAPTER FOR NEW FAN AS REQUIRED
- (2) PROVIDE AND INSTALL A COMPLETE OPERATIONAL ROOF MOUNTED EXHAUST FAN WITH ALL RELATED CONTROLS, WIRING, ACCESSORIES, ETC. MOUNT NEW FAN ON EXISTING ROOF CURB - PROVIDE CURB ADAPTER AS REQUIRED. PROVIDE A MOTOR STARTER AND INTERLOCK EXHAUST FAN WITH PACKAGE UNIT (PAC-1) FAN TO RUN CONTINUOUSLY DURING OCCUPIED TIMES.
- 24 PROVIDE A COMPLETE OPERATIONAL WELDING BOOTH EXHAUST SYSTEM CONSISTING OF 18-GUAGE SINGLE WALL SPIRAL DUCTWORK (NEGATIVE 4" WG) ALONG WITH LINCOLN WELDING K-1657-5 DUCT CONNECTOR - PROVIDE AT EACH WELDING BOOTH DROP FOR CONNECTION OF CENTRAL EXHAUST SYSTEM.
- (5) EXISTING KITCHEN HOOD AND RELATED FAN TO REMAIN. EXISTING DISH-WASH HOOD AND RELATED FAN TO REMAIN.
- EXISTING UNIT HEATER AND RELATED DUCTWORK AND AIR DISTRIBUTION TO REMAIN. EXISTING SUPPLY DUCTWORK AND RELATED AIR DISTRIBUTION TO REMAIN.
- $oldsymbol{ec{ extit{9}}}$ existing transfer air ductwork and related air distribution to remain. EXISTING ROOF MOUNTED EXHAUST FAN TO REMAIN.
- EXISTING EXHAUST DUCTWORK AND RELATED AIR DISTRIBUTION TO REMAIN. $\cite{Mathemath{\mathfrak{P}}}$ existing air handling unit and related ductwork to remain.
- 3 EXISTING DUCT FURNACE AND RELATED VENTING TO REMAIN. EXISTING OUTSIDE AIR DUCTWORK TO REMAIN.
- 35) EXISTING WATER HEATER AND RELATED VENTING TO REMAIN.

(4) EXISTING OUTDOOR CONDENSING UNIT TO REMAIN.

- 36 EXISTING FLOOR DRAIN TO REMAIN. DEXISTING GAS METER TO REMAIN.
- 88) EXISTING COMBUSTION AIR DUCTWORK TO REMAIN. 39) EXISTING DEHUMIDIFIER TO REMAIN.
- (1) EXISTING REFRIGERANT PIPING TO REMAIN. (42) EXISTING UNIT HEATER AND RELATED PIPING, CONTROLS, VENTING AND ACCESSORIES TO
- 43 EXISTING UNIT HEATER AND RELATED PIPING, CONTROLS, VENTING AND ACCESSORIES TO BE REMOVED. PATCH AND PAINT EXISTING HOLES IN WALLS, CEILINGS, ROOF, ETC. TO MATCH EXISTING FINISHES. ALL PATCHING SHALL BE WATER AND AIR TIGHT.
- EXISTING ROOF MOUNTED EXHAUST FAN AND RELATED CURB, DUCTWORK, AIR DISTRIBUTION, WIRING, CONTROLS, ACCESSORIES, ETC. TO BE REMOVED. PATCH AND PAINT EXISTING HOLES IN WALLS, CEILINGS, ROOF, ETC. TO MATCH EXISTING FINISHES. ALL PATCHING SHALL BE WATER AND AIR TIGHT.
- (4) EXISTING INTAKE LOUVER TO BE REMOVED. PATCH AND PAINT EXISTING HOLE IN WALL TO MATCH EXISTING FINISHES. ALL PATCHING SHALL BE WATER AND AIR TIGHT AND SHALL BE INSULATED.
- (4) EXISTING ROOF MOUNTED SUPPLY FAN AND RELATED DUCTWORK, AIR DISTRIBUTION, WIRING, CONTROLS, ACCESSORIES, ETC. TO BE REMOVED. EXISTING CURB TO REMAIN. EXISTING OPENING SHALL BE RE-USED FOR NEW OUTSIDE AIR INTAKE HOOD. PROVIDE CURB ADAPTER FOR NEW HOOD AS REQUIRED.
- 4) Provide and install a new roof mounted outside air intake hood mounted ON EXISTING ROOF CURB - PROVIDE CURB ADAPTER AS REQUIRED. MOUNT HOOD OPENING DIRECTLY OVER EXISTING ROOF OPENING. PROVIDE A LINED SHEET METAL PLENUM ON BOTTOM SIDE OF HOOD AND CONNECT NEW OUTSIDE AIR DUCT INTO BOTTOM OR SIDE OF NEW PLENUM.

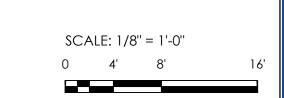



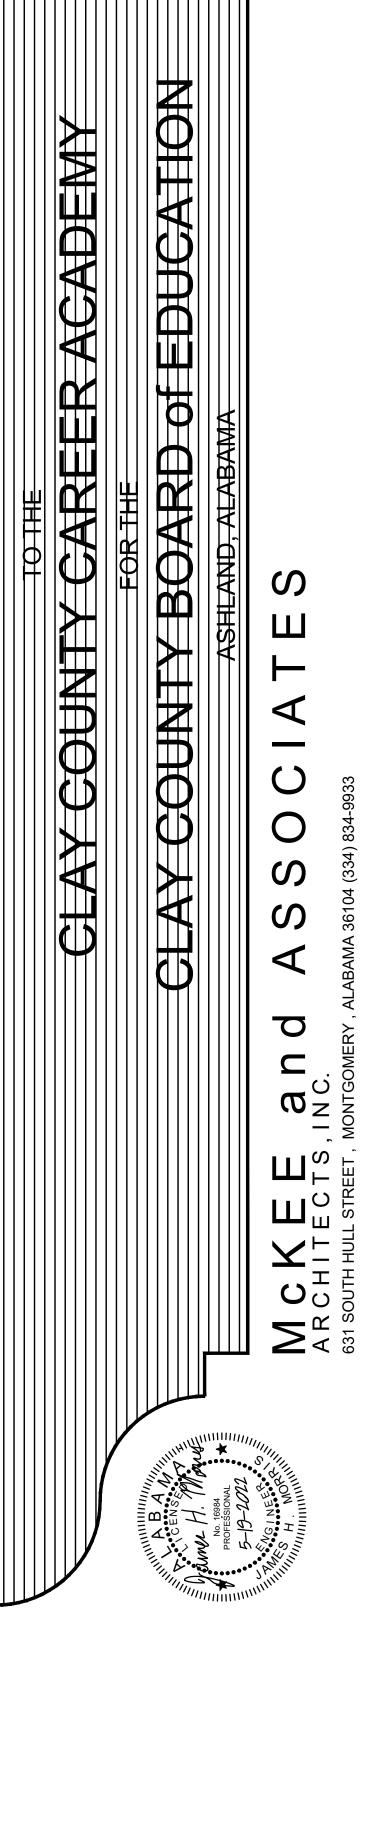


MECHANICAL FLOOR PLAN

MCKEE JOB #: 21.239

DRAWN BY: JBB/JHM 5.19.2022

REVISED DATE: REVISED DATE:

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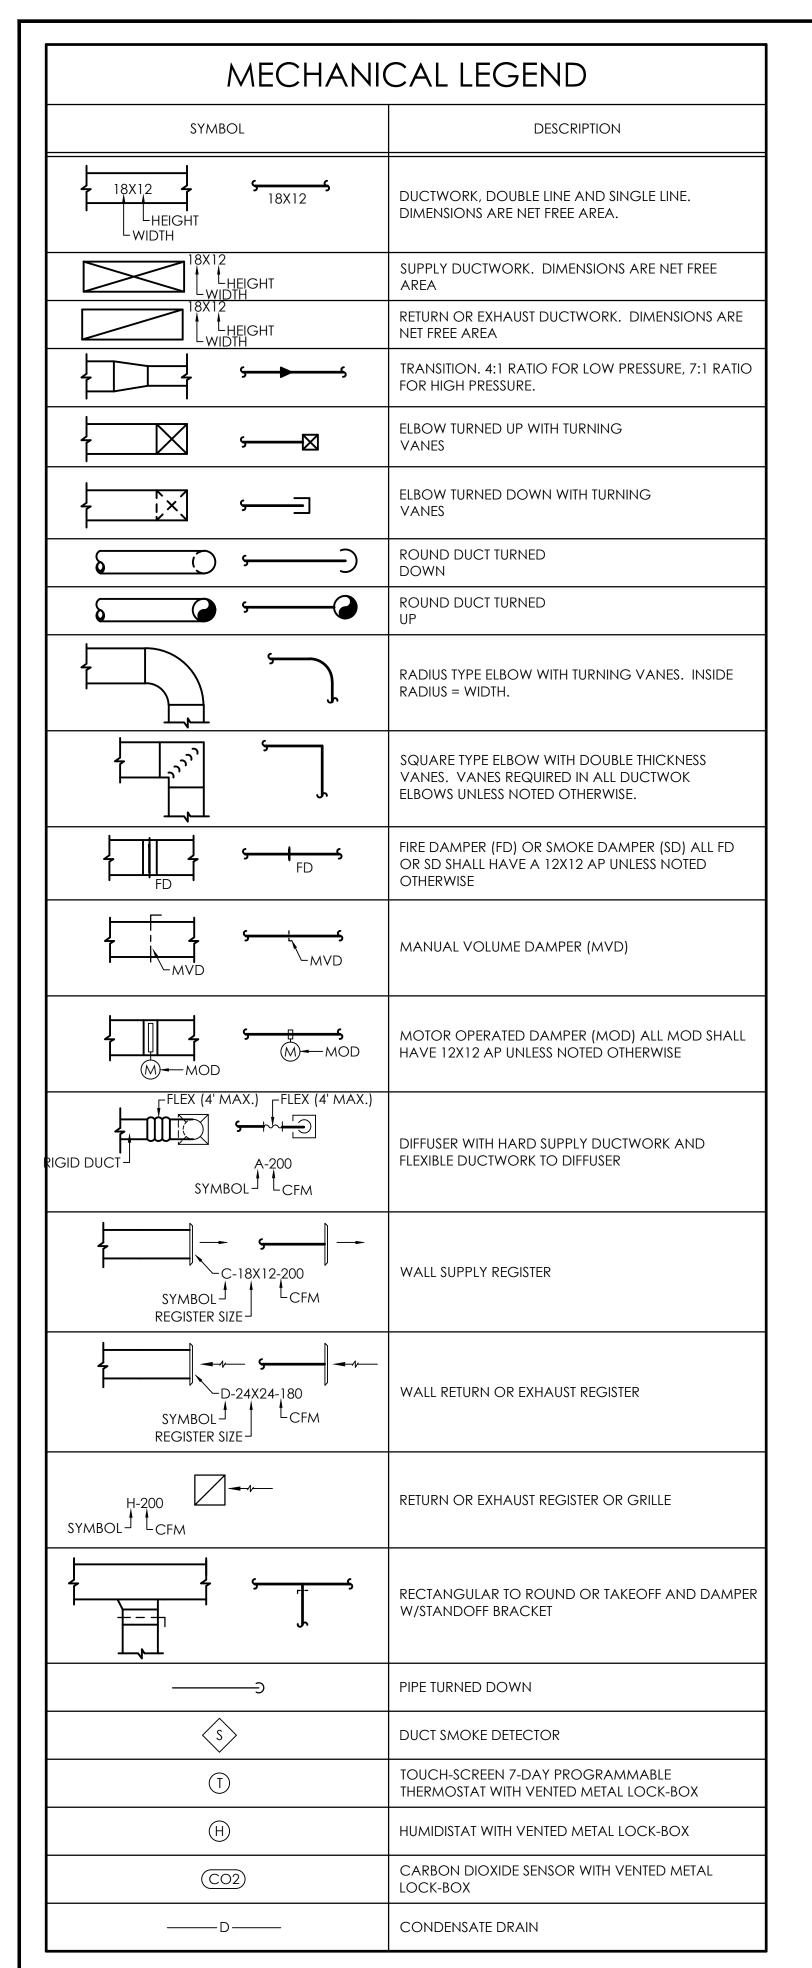
MECHANICAL

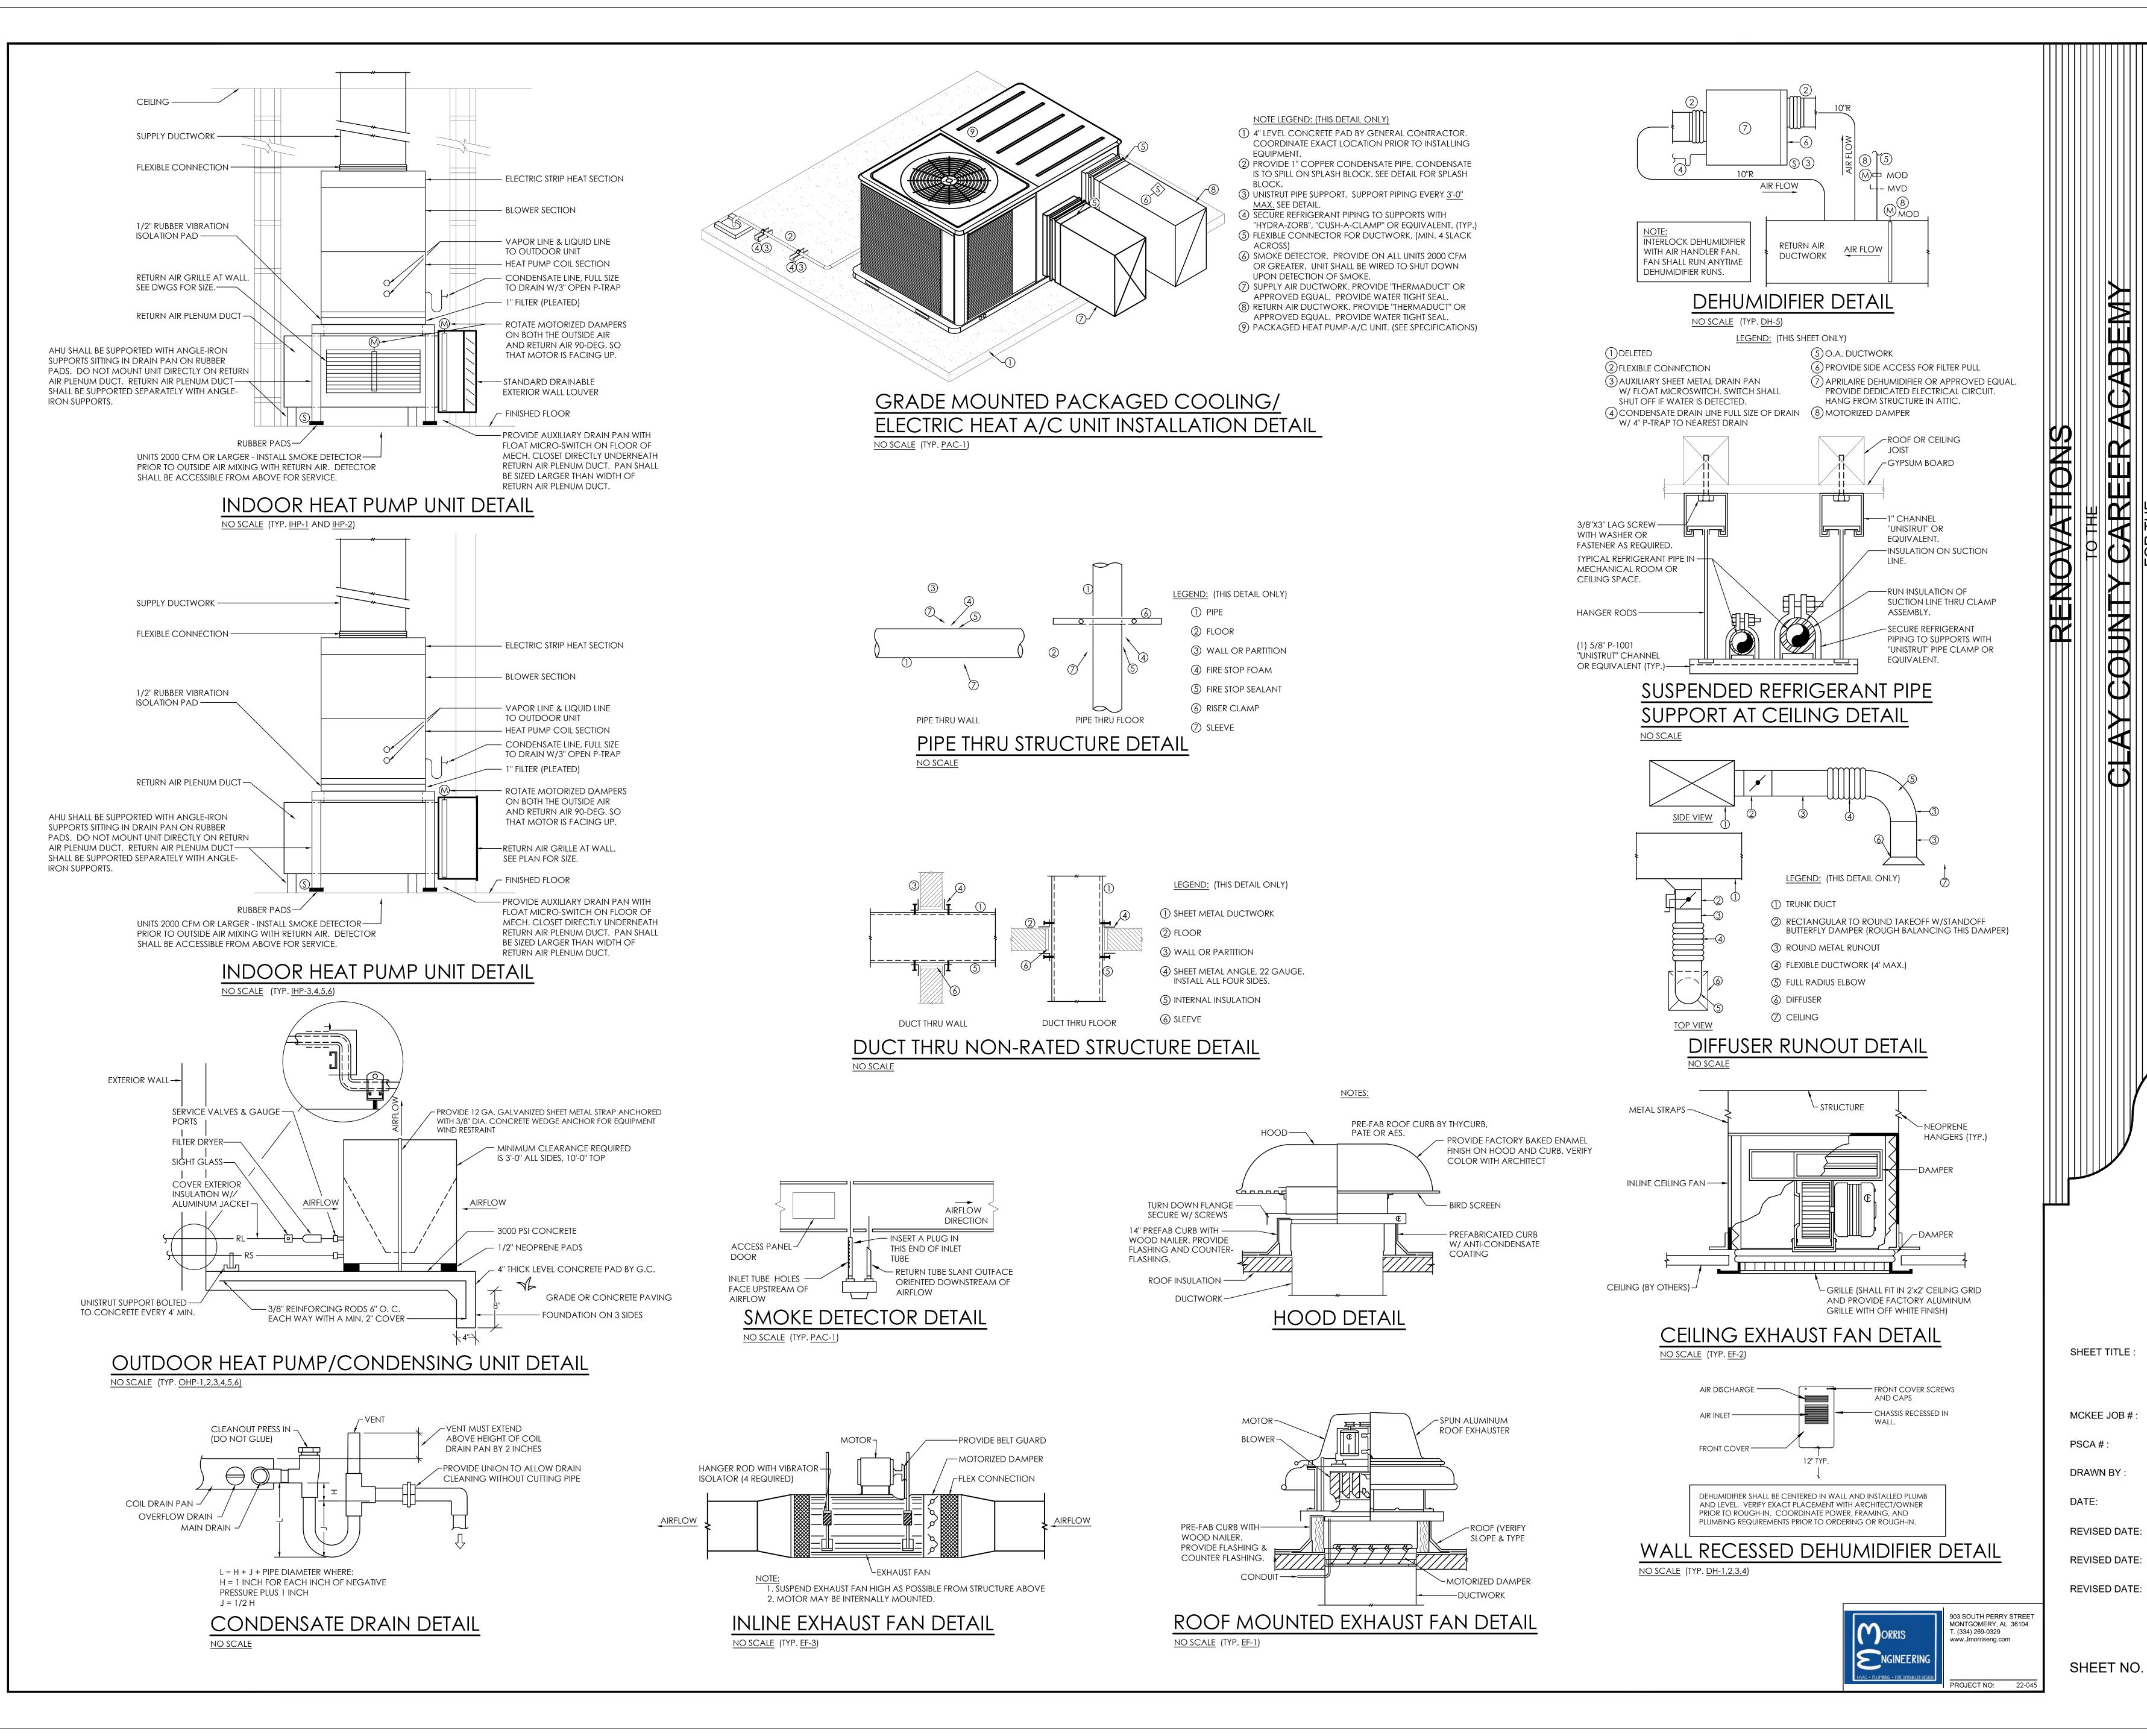DETAILS

JBB/JHM

5.19.2022

21.239



MECHANICAL GENERAL NOTES

- THESE DRAWINGS ARE NOT INTENDED TO SHOW ALL POSSIBLE CONDITIONS. IT IS INTENDED THAT A COMPLETE AND OPERATIONAL HVAC SYSTEM BE PROVIDED WITH ALL NECESSARY EQUIPMENT, ACCESS PANELS FOR SERVICE, APPURTENANCES, AND CONTROLS, COMPLETELY COORDINATED WITH ALL DISCIPLINES. ALL PARAMETERS GIVEN IN THESE DOCUMENTS SHALL BE STRICTLY CONFORMED WITH. ANY ITEMS AND LABOR REQUIRED FOR A COMPLETE AND OPERATIONAL HVAC SYSTEM IN ACCORDANCE WITH ALL APPLICALABLE CODES, STANDARDS, AND THESE CONTRACT DOCUMENTS SHALL BE FURNISHED WITHOUT INCURRING ANY ADDITIONAL COST TO THE OWNER. CAREFULLY REVIEW ALL CONTRACT DOCUMENTS AND THE DESIGN OF THE OTHER TRADES BEFORE PREPARING SHOP DRAWINGS.
- COORDINATE DUCTWORK AND PIPING WITH STRUCTURAL, PLUMBING, AND ELECTRICAL. MAKE OFFSETS AND TRANSITIONS TO COORDINATE WITH OTHER TRADES WITHOUT ANY ADDITIONAL COST TO THE OWNER. 3. REFER TO ARCHITECTURAL CEILING PLANS FOR EXACT LOCATION OF ALL CEILING MOUNTED
- AIR DISTRIBUTION DEVICES. COORDINATE EXACT LOCATION OF GRILLES, REGISTERS, AND DIFFUSERS WITH ARCHITECTURAL AND INTERIOR REFLECTED CEILING PLANS AND LIGHT FIXTURES. IF A PARTICULAR ITEM IS NOT SHOWN ON THE ARCHITECTURAL REFLECTED CEILING PLAN, PREPARE A DRAWING AND PRESENT IT TO THE ARCHITECT FOR THEIR REVIEW AND/OR APPROVAL.
- 4. ALL DUCT TRANSITIONS FROM SQUARE TO ROUND SHALL BE SMOOTH SQUARE TO ROUND TRANSITIONS. SPIN-IN FITTINGS AT THE END OF CAPPED DUCTS ARE NOT ACCEPTABLE.
- PORTIONS OF DUCTWORK VISIBLE THROUGH GRILLES, REGISTERS, AND DIFFUSERS IN FINISHED AREAS SHALL BE PAINTED FLAT BLACK.
- 6. ALL FAN MOTORS 1/8 HP AND ABOVE SHALL HAVE A DISCONNECT SWITCH MOUNTED AT 7. ALL OPEN ENDED DUCTS SHALL BE REINFORCED WITH 1-1/2" X 1-1/2" X 1/8" GALVANIZED
- STEEL ANGLES BOLTED OR RIVETED 6" ON THE CENTER (MAX.) ALL AROUND THE EXTERIOR PERIMETER OF THE DUCT. MOUNT THERMOSTATS, HUMIDITY SENSORS AND OTHER CONTROLLERS 48" A.F.F. UNLESS NOTED OTHERWISE. SEE MECHANICAL DRAWINGS FOR LOCATIONS. WHERE THERE IS A CONFLICT OF LOCATIONS BETWEEN THE DRAWINGS, NOTIFY THE ARCHITECT IMMEDIATELY.
- VERIFY EXACT LOCATION BEFORE INSTALLATION. 9. ALL BRANCH DUCTWORK SHALL BE SIZED TO MATCH THE DIFFUSER SERVED UNLESS NOTED
- 10. PROVIDE INTERNAL INSULATION (1" THICK CLOSED CELL) FOR SUPPLY, RETURN, AND OUTDOOR AIR DUCTS WITHIN 20' OF EACH INDOOR AIR HANDLING UNIT (UNLESS NOTED OTHERWISE), FAN, ETC. ALL OTHER DUCTWORK SHALL BE INSULATED WITH 2" THICK, FOIL
- BACKED 3/4 LB. DENSITY BLANKET INSULATION UNLESS NOTED OTHERWISE. 11. CONDENSATE DRAIN LINES RUNNING HORIZONTALLY SHALL BE SLOPED 1/4" PER FOOT DOWN IN THE DIRECTION OF FLOW AS INDICATED. ALL CONDENSATE LINES SHALL BE INSULATED.
- 12. DUCT DIMENSIONS SHOWN ARE INSIDE CLEAR, ADJUST FOR LINER. 13. IN ADDITION TO OFFSETS IN DUCTWORK SHOWN, PROVIDE OFFSETS REQUIRED TO MAINTAIN
- TOP OF DUCTWORK AND PIPING TIGHT TO STRUCTURE. 14. DUCTS AND EQUIPMENT WITH STANDING BRACES SHALL BE ARRANGED SO THAT THE BRACES WILL NOT BE OVER LIGHTS OR UNDER BEAMS IN AREAS WHERE THE CLEARANCE BETWEEN LIGHTS AND BEAMS IS LIMITED.
- 15. EACH CEILING DIFFUSER INDICATED SHALL HAVE RECTANGULAR TO ROUND TAKE-OFF WITH STANDING BRACKET AND MANUAL VOLUME CONTROL DAMPER AT THE SHEET METAL TRUNK DUCT SUCH THAT AIR CAN BE BALANCED.
- 16. DUCTWORK SHALL BE IN ACCORDANCE WITH THE LATEST SMACNA STANDARD. SEAL ALL JOINTS WITH HARD-CAST PRIOR TO INSULATING. 17. VERIFY EXACT LOCATION OF CONTROLS AND THERMOSTATS WITH ARCHITECT BEFORE
- WIRING AND INSTALLATION. 18. COORDINATE UNDERCUTTING OF DOORS WITH GENERAL CONTRACTOR. 19. COORDINATE THE LOCATION OF ALL FLOOR DRAINS REQUIRED FOR MECHANICAL
- EQUIPMENT WITH PLUMBING CONTRACTOR TO INSURE PROPER LOCATION FOR SERVICE TO 20. THE MECHANICAL CONTRACTOR SHALL NOTIFY THE GENERAL CONTRACTOR OF ALL WALL, FLOOR, AND ROOF OPENINGS (DIMENSIONS AND LOCATIONS). THE GENERAL CONTRACTOR SHALL BE RESPONSIBLE FOR OPENINGS IN THE STRUCTURE. COORDINATE THE LOCATION OF FLOOR DRAINS WITH MECHANICAL EQUIPMENT PRIOR TO ROUGHING IN OR
- PLACEMENT OF MECHANICAL EQUIPMENT. 21. ALL DUCTWORK SHALL BE CONNECTED TO AIR HANDLING UNITS WITH FLEXIBLE SLEEVES. EACH SLEEVE SHALL HAVE AT LEAST 7" SLACK ACROSS A CLEAR METAL-TO-METAL GAP OF
- 22. MECHANICAL CONTRACTOR SHALL BE RESPONSIBLE FOR COORDINATING WITH THE ARCHITECTURAL LIFE SAFETY PLANS PRIOR TO BIDDING, ORDERING EQUIPMENT/MATERIALS AND/OR STARTING ANY WORK ON SITE AND SHALL PROVIDE A U.L. LISTED DYNAMIC FIRE DAMPER ASSEMBLY AT ALL DUCTWORK PENETRATIONS OF FIRE RATED WALLS, CEILINGS,
- LAYERS, ETC. REGARDLESS IF SHOWN ON MECHANICALS OR NOT. 23. PROVIDE LONG-LINE REFRIGERANT KITS FOR ALL HVAC SYSTEMS REQUIRING LINE-SETS THAT EXTEND BEYOND THE MANUFACTURER'S RECOMMENDED LINE-SET LENGTH. COORDINATE LINE SIZE AND LENGTH WITH HVAC SYSTEMS MANUFACTURER PRIOR TO ORDERING AND INSTALLATION.
- 24. MECHANICAL CONTRACTOR SHALL REVIEW MECHANICAL PLANS/NOTES/SPECS/ETC. PRIOR TO BIDDING AND SHALL BE RESPONSIBLE FOR PROVIDING ACCESS PANELS ALLOWING ACCESS TO MECHANICAL ITEMS REQUIRING SERVICE.

		2015 INTER							JTDOOR						
P.	VENTILATION AIR TABLE 403.3 (SINGLE ZONE)														
UNIT TAG	ROOM	ROOM CLASSIFICATION PER TABLE 403.3		EST. OCC. LOAD (Pz)	OCC. O.A RATE PER PERSON (Rp)	AREA O.A. RATE PER FT ² (Ra)	TOTAL OCC. O.A. RATE (CFM) (RpPz)	TOTAL AREA O.A. RATE (CFM) (RaAz)	,	ZONE O.A. (CFM) (Voz)	O.A. INTAKE FLOW (CFM) (Vot)	ZONE AIR DISTRUBUTION EFFECTIVENESS (Ez)			
IHP/OHP-1	Auto Tech Classroom 133	Classrooms (age 9 plus)	1240	44	10	0.12	440	148.8	588.8	588.8	588.8	1			
IHP/OHP-2	Auto Tech Classroom 133	Classrooms (age 9 plus)	1240	44	10	0.12	440	148.8	588.8	588.8	588.8	1			
IHP/OHP-3	Open Meeting Room 129 (Half)	Conference/Meeting	865	44	5	0.06	220	51.9	271.9	271.9	271.9	1			
	Hall 134 and 134C	Corridors	1210	0	0	0.06	0	72.6	72.6	72.6	72.6	1			
								124.5			344.5				
IHP/OHP-4	Alternate School 126	Classrooms (age 9 plus)	525	19	10	0.12	190	63	253	253	253	1			
IHP/OHP-5	Open Meeting Room 129 (Half)	Conference/Meeting	865	44	5	0.06	220	51.9	271.9	271.9	271.9	1			
0.		731	70												

2015 IMC VENTILATION CALCULATIONS												
EQUATION 4-1	Vbz = RpPz + RaAz											
TABLE 403.3.1.2	Ez = 1											
EQUATION 4-2	$V_{OZ} = \frac{V_{DZ}}{Ez}$											
EQUATION 4-4	Vot = ∑ all zones Voz											
EQUATION 4-5	Zp = Voz/Vpz											
EQUATION 4-6	Vou = D X ∑ all zones (RpPz) + ∑ all zones (RaAz)											
EQUATION 4-7	$D = \frac{Ps}{\sum Pz}$											
EQUATION 4-8	$Vot = \frac{Vou}{Ev}$											

Classroom 130

NOTE:
UNITS APPLYING TO 2015 IMC 403.2 (NEEDLEPOINT BI-POLAR IONIZATION) ARE AS FOLLOWS:
IHP/OHP-1 IHP/OHP-2 IHP/OHP-4 IHP/OHP-6
UNITS APPLYING TO 2015 IMC 403.3 (STANDARD VENTILATION REQUIREMENT) ARE AS FOLLOWS:
IHP/OHP-3 IHP/OHP-5

	PACKAGED COOLING/ELECTRIC HEAT UNIT SCHEDULE																
Symbol	TOTAL CFM	MIN. O.A. CFM	MAX. O.A. CFM	ECON. CFM	EXT. S.P. INCHES H₂O	FAN HP	COOLING MIN. TOTAL SEN SEER/EER MBH MBH		HEATING MIN. TOTAL COP ELEC. INDOOR K.W. ELEC.			MAX. ARI SOUND RATING (dB)	remarks	TONNAGE	TRANE MODEL		
PAC-1	3000	850	850	3000	.5	2.75	92.0	68.6	14.5/12.6	61.4	3.7	18.0	240/3/60	85.0	1,2,3,4,5,6,7,8	7.5-TON	THC092F3RGA

Classrooms (age 9 plus)

- RATED IN ACCORDANCE WITH WITH AHRI STANDARD 210-81. PROVIDE VIBRATION ISOLATION RAILS.
- 3. PROVIDE MOTORIZED OUTSIDE AIR DAMPER AND MOTORIZED
- BAROMETRIC RELIEF DAMPER.
- COMPRESSORS, SIDE DISCHARGE, HAIL GUARDS, POWERED CONVENIENCE OUTLETS, BAROMETRIC RELIEF AND 5-YEAR PARTS WARRANTY.
- 5. PROVIDE SINGLE POINT POWER CONNECTION FOR UNIT. ALL WIRING, TRANSFORMERS, ETC. SHALL BE FACTORY INSTALLED.
- 6. INSTALL ON 4" THICK LEVEL CONCRETE PAD (PAD BY G.C.). 7. COOLING WITH ELECTRIC HEAT, CONSTANT VOLUME OPERATION,
- PROVIDE HOT GAS REHEAT AND APR (RAWALL) VALVE. 4. PROVIDE 7-DAY TOUCH-SCREEN PROGRAMMABLE THERMOSTAT, DUAL 8. RUN 3/4" CONDENSATE DRAIN LINE TO SPLASH-BLOCK ON GRADE.

	SPLIT SYSTEM UNIT SCHEDULE																
			EV	AP. FAN		COO	LING M	1IN. (1)		HEA	ATING M	IN.		MAX.	BASIS OF		
symbol	TOTAL	O.A.	CFM	EXT. SP.	HP	TOTAL	SEN	SEER	TOTAL		ELEC.	INDOOR	OUTDOOR ELEC.	AHRI SOUND	DESIGN (TRANE OR APPROVED	REMARKS	TONNAGE
	CFM	MIN.	MAX.	"H20	'''	MBH	MBH	JLLK	MBH	(2)	KW	ELEC.		RATING	EQUAL)		
IHP/OHP-1	1600	220	220	.5	.75	48.0	34.0	14.0	46.0	3.4	14.2	240/3/60	240/3/60	86.0 dB	TEM/4TWA	1,2,3,4,5,6,7,8	4-TON
IHP/OHP-2	1600	220	220	.5	.75	48.0	34.0	14.0	46.0	3.4	14.2	240/3/60	240/3/60	86.0 dB	TEM/4TWA	1,2,3,4,5,6,7,8	4-TON
IHP/OHP-3	1600	125	345	.5	.75	48.0	34.0	14.0	46.0	3.4	14.2	240/3/60	240/3/60	86.0 dB	TEM/4TWA	1,2,3,4,5,6,7,8	4-TON
IHP/OHP-4	1000	135	135	.5	.3	28.6	22.8	14.0	27.8	3.6	9.6	240/3/60	240/1/60	83.0 dB	TEM/4TWR	1,2,3,4,5,6,7,8	2.5-TON
IHP/OHP-5	1200	55	275	.5	.5	35.7	26.7	14.0	33.0	3.7	9.6	240/3/60	240/3/60	86.0 dB	TEM/4TWA	1,2,3,4,5,6,7,8	3-TON
IHP/OHP-6	1200	145	145	.5	.5	35.7	26.7	14.0	33.0	3.7	9.6	240/3/60	240/3/60	86.0 dB	TEM/4TWA	1,2,3,4,5,6,7,8	3-TON

- L. CAPACITY BASED ON EDB 80 DEGREES F, EWB 67 DEGREES F AND AMBIENT 95 DEGREES F. CAPACITY BASED ON EDB 70 DEGREES F, AMBIENT DB 47 DEGREES F AND AMBIENT RH 70%.
- RATED IN ACCORDANCE WITH AHRI STANDARD 210-81. 4. FILTER SECTION W/2" PLEATED FILTER. E-Z FILTER BASE MFG. INC. MODEL E-Z OR EQUIVALENT. PROVIDE SINGLE-STAGE COOLING AND TWO-STAGE HEATING.
- PROVIDE SINGLE POINT POWER CONNECTION FOR INDOOR UNITS. ALL WIRING, TRANSFORMERS, ECT. SHALL BE FACTORY INSTALLED. PROVIDE DISCONNECTS FOR INDOOR
- 7. PROVIDE LONG-LINE KITS FOR ALL REFRIGERANT LINE-SETS THAT EXTEND BEYOND 80'-0". 8. CONSTANT VOLUME HEAT PUMP OPERATION.

		DE	ΞΗL	JMI	DIFIER	SCI	HEDU	LE	
SYMBOL	TOTAL CFM	EXT. SP H₂O	CAP.	MAX. AMP DRAW	ELECTRICAL	SOUND RATING (dBA)	REMARKS	MODEL # (OR APP. EQUAL)	LOCATION
DH-1,2,3,4	155	0.2	33	2.8	120/1/60	46	1,2,3	INNOVATIVE IW-25-1 (SURFACE)	H.S. BLDG. 400
DH-5	267	0.2	130	8.3	120/1/60	50	1,2,3,4	APRILAIRE 1870	H.S. ROTC BLDG.

- CAPACITY BASED ON 80 DEGREES F., EWB 60% R.H. (ANSI/AHAM DH-1-2003). 2. PROVIDE FACTORY FILTER SECTION, DUCTWORK, INLET AND OUTLET, CONDENSATE DRAIN, CONDENSATE PUMP (IF REQUIRED), INSULATED CABINET, FACTORY DEHUMIDIFICATION CONTROL AND REMOTE HUMIDISTAT, TRANSFORMER, CONDENSATE OVERFLOW SAFETY SWITCH AND BACK-DRAFT DAMPER. SEE ELECTRICAL PLANS
- FOR DISCONNECT. 3. UNIT SHALL BE WIRED WITH FACTORY INSTALLED PLUG (VERIFY LOCAL AND STATE CODE REQUIREMENTS FOR WIRING). SEE ELECTRICAL PLANS.

 4. PROVIDE A RELAY THAT WILL ENERGIZE THE ASSOCIATED AIR HANDLING UNIT FAN WHEN THE DEHUMIDIFIER IS

			AIR DIST	TRIBUTION SCHEDULE	
Symbol	MAX. N.C. SONES	MAX. VEL. FPM	MODEL	DESCRIPTION	REMARKS
А	25	500	TITUS TDCA-AA	6"X6" LOUVERED FACE DIFFUSER	1,2,3,4,5,6
С	25	500	TITUS TDCA-AA	10"X10" LOUVERED FACE DIFFUSER	1,2,3,4,5,7
Е	25	500	TITUS TDCA-AA	24"X24" LOUVERED FACE DIFFUSER	1,2,3,4,5,8
I	25	500	TITUS 300FS	SIDEWALL SUPPLY REGISTER	1,2,5,9
	25	500	TITUS 33R	HEAVY DUTY SIDEWALL RETURN REGISTER	1 2 5 10

- . REFER TO ARCHITECTURAL PLANS FOR EXACT LOCATION. 2. PROVIDE OFF-WHITE FINISH. VERIFY WITH ARCHITECT PRIOR TO ORDERING. 3. EXTEND 24" X 24" PANEL IN LAY-IN CEILING. SURFACE MOUNT IN GYP. BOARD CEILING.
- 4. PROVIDE OPPOSED BLADE DAMPER WITH EXTERNAL ADJUSTMENT. 5. PROVIDE TRANSITION ADAPTER AS REQUIRED. ROUND TO REC. OR REC. TO REC. OR ROUND TO ROUND.
- 6. PROVIDE 6" ROUND RUNOUT UNLESS OTHERWISE NOTED. 7. PROVIDE 10" ROUND RUNOUT UNLESS OTHERWISE NOTED.
- 8. PROVIDE 14" ROUND RUNOUT UNLESS OTHERWISE NOTED. 9. INSTALL WITH FRONT BLADES PERPENDICULAR TO FLOOR.
- 10. INSTALL WITH FRONT BLADES PARALLEL TO FLOOR.

	LO	JVEI	R SCH	HED	ULE	
SYMBOL	TYPE	EXT. SP H₂O	SIZE	CFM	MIN. SQ. FEET FREE AREA	REMARKS
L-1	R	.05	24"X24"	1,100	2.28	1
L-2	I	.05	24"X24"	1,100	1.88	2

- 1. RUSKIN MODEL ELF 6375D (.57 FREE AREA) OR APPROVED EQUIVALENT. PROVIDE SCREEN WITH 5/8" MESH OPENING AND BAKED ENAMEL FINISH
- TO MATCH BUILDING. ARCHITECT TO SELECT COLOR. RUSKIN MODEL EME745 (.47 FREE AREA) OR APPROVED EQUIVALENT.
- PROVIDE SCREEN WITH 5/8" MESH OPENING AND BAKED ENAMEL FINISH TO MATCH BUILDING. ARCHITECT TO SELECT COLOR.

ŀ	100	OD	SCHE	DULE	
Symbol	TYPE	EXT. SP H₂O	COOK MODEL #	CFM	REMARKS
H-1	I	.017	12X12 GI	440	1,2
H-2	I	.017	12X18 GI	900	1,2

- 1. BASED ON COOK MODEL GIOR APPROVED EQUAL BY PENN OR GREENHECK.
- 2. PROVIDE BIRDSCREEN AND FLASHING FLANGE. PROVIDE FACTORY DARK BRONZE BAKED ENAMEL FINISH ON CURB AND HOOD. VERIFY COLOR/FINISH WITH ARCH./OWNER PRIOR TO ORDERING AND INSTALLATION.

	ΕX	(HA	UST	FAN	1 SCH	HEDUL	.E	
Symbol	СҒМ	EXT. SP H₂O	MAX. RPM	sones	POWER	ELEC.	REMARKS	INTERLOCK WITH
EF-1	850	.5	1,167	8.0	.25 H.P.	120/1/60	1	PAC-1 FAN
EF-2	70	.5	1,075	2.0	34.8 W	120/1/60	2,3	LIGHT SW./ OCC. SENS.
EF-3	1,100	.25	1,040	8.1	.5 H.P.	120/1/60	4,5	SEE NOTE #5

SCHEDULE NOTES:

- 1. COOK MODEL ACE-B ROOF MOUNTED DOWN-BLAST EXHAUST FAN OR APPROVED EQUAL. PROVIDE CENTRIFUGAL WHEEL, 200,000 HOUR BEARINGS, OPEN DRIP PROOF MOTOR, PRE-FAB ROOF CURB, BELT-DRIVE MOTOR, FACTORY MOUNTED DISCONNECT SWITCH, STARTER, SPEED CONTROLLER, THE AMCA SEAL AND FACTORY PAINTED DARK BRONZE BAKED ENAMEL FINISH - VERIFY FINISH WITH ARCHITECT/OWNER PRIOR TO ORDERING AND INSTALLATION. INTERLOCK EXHAUST FAN WITH
- 2. COOK MODEL GC CEILING MOUNTED EXHAUST FAN OR APPROVED EQUAL. 3. PROVIDE BACK-DRAFT DAMPER, SPEED CONTROLLER, FACTORY MOUNTED VOLTAGE TRANSFORMER
- AND FACTORY DISCONNECT SWITCH.
- 4. PROVIDE COOK MODEL DB IN-LINE DUCT BLOWER OR APPROVED EQUAL. 5. PROVIDE WALL MOUNTED TIME-CLOCK SET TO ALLOW FAN TO RUN DURING ALL OCCUPIED TIMES. PROVIDE MOTORIZED DAMPER AT FAN AND INTERLOCK MOTORIZED DAMPER TO MOTORIZED DAMPER AT RELATED INTAKE LOUVER AS SHOWN ON PLAN.



PACKAGE UNIT (PAC-1) FAN TO RUN CONTINUOUSLY DURING OCCUPIED TIMES. DRAWN BY JBB/JHM 5.19.2022 **REVISED DATE:** REVISED DATE: REVISED DATE:

MCKEE JOB #: 21.239

MECHANICAL SCHEDULES

FOR QUESTIONS, CALL THE Panhandle REGION 39 PHONE: (850) 288-0726 EMAIL: reg39@captiveaire.com

				_	
EXHAUST	FAN	INFORMATION	_	J0B#54679	59

UNIT	TAG	QTY	FAN UNIT MODEL #	MANUFACTURER	CFM	ESP	RPM	MOTOR ENCL	HP	BHP	PHASE	VOLT	FLA	DISCHARGE VELOCITY	WEIGHT (LBS)	SONES
1	WEF-1	1	DU180HFA	CAPTIVEAIRE	4000	0.200	1180	EXPLOSIONPROOF	1.500	1.1120	3	230	4.3	924 FPM	222	19.1
2	WEF-2	1	DU180HFA	CAPTIVEAIRE	3200	0.200	970	EXPLOSIONPROOF	1,500	0.6240	3	230	4.3	739 FPM	222	14.7
MIIA	FAN	INFO		o O			•			•						

MU	$\frac{A}{A} \frac{FAN}{IN} \frac{IN}{IN}$	FORM	MATION - JOB #5467958	9															
FAI UNI NE	T TAG	QTY	FAN UNIT MODEL #	BLOWER	HOUSING	MIN CFM	DESIGN CFM	ESP	RPM	M□T□R ENCL	HP	BHP	PHASE	VOLT	FLA	MCA	MOCP	WEIGHT (LBS)	SONES
3	GFMUA-1	1	A2-IBT-300-20D	20MF-2-MOD	A2-IBT-300	1200	4000	0.250	1420	EXPLOSIONPROOF	3.000	1.8240	თ	230	7.7	11.8A	15A	1232	13.3
1					l											I			1 1

GAS FIRED MAKE-UP AIR UNIT(S)

FAN UNIT NO	TAG	INPUT BTUs	OUTPUT BTUs	TEMP RISE	REQUIRED INPUT GAS PRESSURE	GAS TYPE	BURNER EFFICIENCY(%)
3	GFMUA-1	248430	198744	43°F	7 IN. W.C. – 14 IN. W.C.	NATURAL	80
4	GFMUA-2	198744	158995	43°F	7 IN. W.C. – 14 IN. W.C.	NATURAL	80

TAG UNIT I UPBLAST FAN WHEEL ACCESS PORT VALLEDUNT 27.5 SG. X 5" SPEL LOSS DISCRIPCTION 16/20 (D60 ISDLATORS), 70.8 MOTOR MAX FOR WALL MOUNTING LEXHAUST FAN HEAT BAFFLE CLASS C SPARK RESISTANT CONSTRUCTION FOR PRVS TOWN PACKAGE WYPESEL OR REFERENCE SPEEDS (VFD INCLUDED) VEF-1 VEF	FAN	OPTION	IS	
1 WALLMOUNT 27.5 SG. X 5' 1 SHIP LODGS DISCONNECT FOR REMOTE MOUNT 1 VALL MOUNT CONSTRUCTION 18/20 (D60 ISOLATORS), 70LB MOTOR MAX FOR WALL MOUNTING 1 EACHAUST FAN HEAT 36FFLE 1 CLASS C SPARK RESISTANT CONSTRUCTION FOR PRVS 1 TOWNS - TEFLON COLITED WHEEL 1 VAY PACKAGE WYPESET OR REFERENCE SPEEDS (VFD INCLUDED) 1 VED FACTORY MOUNTED AND WIRED IN EXHAUST FAN 1 VED MOUNTING BRACKET FOR DU/DR 180 - 200 1 2 YEAR PARTS WARRANTY 1 UPBLAST FAN WHEEL ACCESS PORT 1 WALL MOUNT 27.5 SG. X 5' 1 SHIP LODGS DISCONNECT FOR REMOTE MOUNT 1 VALL MOUNT CONSTRUCTION 18/20 (D60 ISOLATORS), 70LB MOTOR MAX FOR WALL MOUNTING 1 CLASS C SPARK RESISTANT CONSTRUCTION FOR PRVS 1 TOWNS - TEFLON COLITED WHEEL 1 VAY PACKAGE WYPESET OR REFERENCE SPEEDS (VFD INCLUDED) 1 VFD FACTORY MOUNTED AND WIRED IN EXHAUST FAN 1 VFD MOUNTING BRACKET FOR DU/DR 180 - 200 1 VFT PACTORY MOUNTED AND WIRED IN EXHAUST FAN 1 VFD MOUNTING BRACKET FOR DU/DR 180 - 200 1 VFT PACTORY MOUNTED AND WIRED IN EXHAUST FAN 1 VFT MOUNTING BRACKET FOR DU/DR 180 - 200 1 VFT PACTORY MOUNTED AND WIRED IN LEHAUST FAN 1 SIZE 2 TALL TEMPERED COMMERCIAL DWIN DISCHARGE FOR IBTS 1 COMMERCIAL SMIKE DETECTOR/ALARM INTERLECT - ALARM SUPPLIED BY DITHERS 1 SIZE 2 TALL TEMPERED COMMERCIAL DWIN DISCHARGE FOR IBTS 1 COMMERCIAL SMIKE DETECTOR/ALARM INTERLECT - ALARM SUPPLIED BY DITHERS 1 USED IN THE 18T HEATER, THE 188, HAY, NS., YMA, DR 122 PREVISE DETION MUST 1 VAY PACKAGE WY MANUAL/DID CONTROL OF VFT WINGE IN THE IST AND POOR PREVISE IS 1 SIZE 2 TALL TEMPERED COMMERCIAL DWIN DISCHARGE FOR IBTS 1 INSET PRESSURE GAUGE, O-35' 1 MAINTEILD PRESSURE GAUGE, O-35' 2 MAINTEILD PRESSURE GAUGE, O-35' 2 MAINTEILD DID PRESSURE FOR ACE! HOUSING - MEETS ANDA CLASS IA RATING 3 SIZE 2 TALL TEMPERED COMMERCIAL DOWN DISCHARGE FOR IBTS 4 MAINTEILD	FAN UNIT			DESCRIPTION
1 SHIP LODSE DISCONNECT FOR REMOTE MEUNT 1 WALL MOUNT CONSTRUCTION 18/20 COGO ISCLATORS), 70LB MOTOR MAX FOR VALL MOUNTING 1 CHANGE FAR RESISTANT CONSTRUCTION FOR PRVS 1 CLASS C SPARK RESISTANT CONSTRUCTION FOR PRVS 1 TOVIS A TEFLON COATED WHEEL 1 VAV PACKAGE WYPRESET OR REFERENCE SPEEDS (VFD INCLUDED) 1 VFD FACTORY MOUNTED AND WIRED IN EXHAUST FAN 1 VFD MOUNTING BRACKET FOR DUTOR 186 - 200 2 R YEAR PARTS WARRANTY 1 UPBLAST FAN WHEEL ACCESS PORT 1 WALLMOUNT 27.5 SQ. X S' 2 SHIP LODSE DISCONNECT FOR REMOTE MOUNT 1 WALLMOUNT 27.5 SQ. X S' 2 SHIP LODSE DISCONNECT FOR REMOTE MOUNT 1 WALLMOUNT 27.5 SQ. X S' 2 SHIP LODSE DISCONNECT FOR REMOTE MOUNT 1 WALLMOUNT 27.5 SQ. X S' 2 SHIP LODSE DISCONNECT FOR REMOTE MOUNT 2 WEF-8 1 CLASS C SPARK RESISTANT CONSTRUCTION FOR PRVS 1 CLASS C SPARK RESISTANT CONSTRUCTION FOR PRVS 2 WEF-8 2 WEF-8 2 WEF-8 2 TOWNS A TEFLON COATED WHEEL 2 VAY PACKAGE WYRESET OR REFERENCE SPEEDS (VFD INCLUDED) 3 VFD MOUNTING BRACKET FOR DUJOR 186 - 200 2 YEAR PARTS WARRANTY 2 INLET PRESSURE GAUGE, 0-35' 1 MAINFOLD PRESSURE GAUGE, 0			1	UPBLAST FAN WHEEL ACCESS PORT
1 WALL MOUNT CONSTRUCTION 18/20 (D60 ISOLATORS), 70LB MOTOR MAX FOR WALL MOUNTING 1 EXHAUST FAN HEAT BAFFLE 1 CLASS C SPAKE RESISTANT CONSTRUCTION FOR PRVS 1 TOWIS - TEFLON COLATED WHEEL 1 VAV PACKAGE WYPRESET OR REFERENCE SPEEDS (VFD INCLUDED) 1 VFD FACTORY MOUNTED AND WIRED IN EXHAUST FAN 1 VFD MOUNTING BRACKET FOR BUYER 100 - 200 1 2 YEAR PARTS WARRANTY 1 UPBLAST FAN WHEEL ACCESS PORT 1 WALLMOUNT 27.5 SG. X 5* 1 SHPL LODSED BISCONNECT FOR REMDIE MOUNT 1 WALL MOUNT CONSTRUCTION 18/20 (D60 ISOLATORS), 70LB MOTOR MAX FOR WALL MOUNTING 1 CLASS C SPAKE RESISTANT CONSTRUCTION FOR PRVS 1 EXHAUST FAN HEAT BAFFLE 1 TOWIS - TEFLON COLATED WHEEL 1 VAV PACKAGE WYRESET OR REFERENCE SPEEDS (VFD INCLUDED) 1 VFD FACTORY MOUNTED AND WIRED IN EXHAUST FAN 1 VFD MOUNTING BRACKET FOR DUYER 180 - 200 1 2 YEAR PARTS WARRANTY 1 INLET PRESSURE GAUGE, 0.35* 1 MANIFOLD PRESSURE GAUGE, 0.35* 1 COMMERCIAL SMOKE DETECTIONALARM INTERLOCK - ALARM SUPPLIED BY DTHERS 2 GEMUA-1 SIGNE PRINT ELECTRICAL COMMERCIAL DOWN DISCHARGE FOR ISS IN THE IST HEATER, THE HEAPER, THE HEAPER HEAPER, THE WORLD HEAPER HEAPER HEAPER, THE HEAPER HEAPER, THE HEAPER HEAPER HEAPER, THE HEAPER HEAPE			1	WALLMOUNT 27.5 SQ. X 5"
1 EXHAUST FAN HEAT BAFFLE 1 CLASS C SPARK RESISTANT CONSTRUCTION FOR PRVS 1 TOWIS - TEFLOW COATCO WHEEL 1 VAV PACKAGE W/PRESET OR REFERENCE SPEEDS (VFD INCLUDED) 1 VFD MOUNTING BRACKET FOR DUVR 180 - 200 1 VFD MOUNTING BRACKET FOR DUVR 180 - 200 1 2 YEAR PARTS WARRANIY 1 UPBLAST FAN WHEEL ACCESS PORT 1 VALLMOUNT 2.5 SO X 5" 1 SHIP LODSE DISCONNECT FOR REMOTE MOUNT 1 VALLMOUNT SONSTRUCTION 1820 OS ISOLATORS), 70LB MOTOR MAX FOR WALL MOUNTING 1 CLASS C SPARK RESISTANT CONSTRUCTION FOR PRVS 1 EXHAUST FAN HEAT BAFFLE 1 TOWIS - TEFLOW COATCO WHEEL 1 VAV PACKAGE W/PRESET OR REFERENCE SPEEDS (VFD INCLUDED) 1 VFD MOUNTING BRACKET FOR DUVRP 180 - 200 1 VFD MOUNTING BRACKET FOR DUVRP 180 - 200 1 VFD MOUNTING BRACKET FOR DUVRP 180 - 200 1 VFD MOUNTING BRACKET FOR DUVRP 180 - 200 1 VFD MOUNTING BRACKET FOR DUVRP 180 - 200 1 SYEAR PARTS WARRANIY 1 INLET PRESSURE GAUGE, 0-35" 1 MANIFOLD PRESSURE GAUGE, 0 TO 10" WC, 1 FURNACE 1 MOTORIZED BACKBRATT DAMPER FOR A2-1 HOUSING - MEETS ANDA CLASS 14 RATING 1 SIZE 2 TALL TEMESED COMMERCIAL DOWN DISCHARGE FOR 181S 2 COMMERCIAL SMOKE DETECTION AND INSENDE MODULE. IF A NON-DOV PREWIRE IS 2 SIGNOED PILITER SWITCH - NOTIFICATION ON HILL 3 VAV PACKAGE W/ MANUAL/DOC CONTROL (571 VFD INCLUDED) 4 VFD FACTORY MOUNTED AND VIRED IN 18T COMMERCIAL CONTROL VESTIBLE 5 VFD FACTORY MOUNTED AND VIRED IN 18T COMMERCIAL CONTROL VESTIBLE 6 VFD FACTORY MOUNTED AND VIRED IN 18T COMMERCIAL CONTROL VESTIBLE 7 VFD FACTORY MOUNTED AND VIRED IN 18T COMMERCIAL CONTROL VESTIBLE 8 SINGLE POINT ELECTRICAL CONNECTION SINGLE MODULE. IF A NON-DOV PREWIRE IS 9 SINGLE POINT ELECTRICAL CONNECTION SINGLE MODULE. IF A NON-DOV PREWIRE IS 1 SIZE 2 TALL TEMESED COMMERCIAL DOWN DISCHARGE FOR 18TS 1 COMMERCIAL SMOKE DETECTION AND SINGLE MODULE. IF A NON-DOV PREWIRE IS 1 SIZE 2 TALL TEMESED COMMERCIAL DOWN DISCHARGE FOR 18TS 1 COMMERCIAL SMOKE DETECTION AND SINGLE MODULE. IF A NON-DOV PREWIRE IS 1 SIZE 2 TALL TEMESED COMMERCIAL DOWN DISCHARGE FOR 18TS 1 COMMERCIAL SMOKE DETECTION AND SINGLE MODULE. IF A NON-DOV PREWIRE IS 1 SIZE			1	SHIP LOOSE DISCONNECT FOR REMOTE MOUNT
1			1	WALL MOUNT CONSTRUCTION 18/20 (D60 ISOLATORS), 70LB MOTOR MAX FOR WALL MOUNTING
1 TCW18 - TEFLON COATED WHEEL 1 VAV PACKAGE W/PREST OR REFERENCE SPEEDS (VFD INCLUDED) 1 VFD FACTORY MUDITED AND VIRED IN EXHAUST FAN 1 VFD MOUNTING BRACKET FOR DU/DR 180 - 200 1 2 YEAR PARTS WARRANTY 1 UPBLAST FAN WHEEL ACCESS PORT 1 WALLMOUNT 27.5 SQ, X, 5° 1 SHIP LODGE DISCONNECT FOR REMDTE MOUNT 1 WALL MOUNT CONSTRUCTION 18/20 (050 ISOLATORS), 70LB MOTOR MAX FOR WALL MOUNTING 1 CLASS C SPARK RESISTANT CONSTRUCTION FOR PRVS 1 CLASS C SPARK RESISTANT CONSTRUCTION FOR PRVS 1 CLASS C SPARK RESISTANT CONSTRUCTION FOR PRVS 1 TCW18 - TEFLON COATED WHEEL 1 VAV PACKAGE W/PREST OR REFERENCE SPEEDS (VFD INCLUDED) 1 VFD MOUNTING BRACKET FOR DU/DR 180 - 200 1 VFD MOUNTING AND WIRED IN 18T COMMERCIAL CONTROL VESTIBULE 1 VAN PACKAGE W/ MANUAL/DDC CONTROL CS71 VFD INCLUDED) 1 VFD MOTOR ELECTRICAL CONNECTION SINGLE MODULE. IF A NON-DCV PREWIRE IS SESIENTED. DO NOT PROVIDE SUPPLY STATER IN PREVISE PREVIRE UPTION MUST BE SELECTED. DO NOT PROVIDE SUPPLY STATER IN PREVISE PREVIRE UPTION MUST BE SELECTED. DO NOT PROVIDE SUPPLY STATER IN PREVISE PREVIRE UPTION MUST BE SELECTED. DO NOT PROVIDE SUPPLY ST			1	EXHAUST FAN HEAT BAFFLE
1 VAV PACKAGE W/PRESET OR REFERENCE SPEEDS (VFD INCLUDED) 1 VPD MOUNTING BRACKET FOR DU/DR 180 - 200 1 2 YEAR PARTS WARRANTY 1 UPBLAST FAN WHEEL ACCESS PORT 1 VALLMOUNT 727 SQ, X 5' 1 SHIP LODGE DISCONNECT FOR REMOTE MOUNT 1 VALLMOUNT 727 SQ, X 5' 1 SHIP LODGE DISCONNECT FOR REMOTE MOUNT 1 VALLMOUNT 727 SQ, X 5' 1 SHIP LODGE DISCONNECT FOR REMOTE MOUNT 1 VALLMOUNT 727 SQ, X 5' 1 SHIP LODGE DISCONNECT FOR REMOTE MOUNT 1 VALLMOUNT 727 SQ, X 5' 1 SHIP LODGE DISCONNECT FOR REMOTE MOUNT 1 VALLMOUNT 727 SQ, X 5' 1 SHIP LODGE DISCONNECT FOR REMOTE MOUNT 1 VALLMOUNT 727 SQ, X 5' 1 SHIP LODGE DISCONNECT FOR REMOTE MOUNT 1 VALLMOUNT 727 SQ, X 5' 1 SHIP LODGE DISCONNECT FOR REMOTE MOUNT 1 VALLMOUNT 727 SQ, X 5' 1 SHIP LODGE DISCONNECT FOR REMOTE MOUNT 1 VEF ALL MOUNT MAKE TOWN TOWN TOWN TOWN THE MOUNT FOR PA'S 1 COMMENCIAL SWORE DETECTOR DU/DR 180 - 200 1 VFD FACTORY MOUNTED AND WIRED IN SINGLE MOUNT 1 SIZE 2 TALL TEMPERED COMMERCIAL DOWN DISCHARGE FOR IBTS 1 SINGLE POINT ELECTRICAL CONNECTION SINGLE MOUNT. 1 SIZE 2 TALL TEMPERED COMMERCIAL DOWN DISCHARGE FOR IBTS 2 SELECTED. DO NOT PROVIDE SUPPLY STARTER IN PREVIRE DEPTION MUST BE SELECTED. DO NOT PROVIDE SUPPLY STARTER IN PREVIRE DEPTION MUST BE SELECTED. DO NOT PROVIDE SUPPLY STARTER IN PREVIRE DEPTION MUST BE SELECTED. DO NOT PROVIDE SUPPLY STARTER IN PREVIRE DEPTION MUST BE SELECTED. DO NOT PROVIDE SUPPLY STARTER IN PREVIRE DEPTION MUST BE SELECTED. DO NOT PROVIDE SUPPLY STARTER IN PREVIRE DEPTION MUST BE SELECTED. DO NOT PROVIDE SUPPLY STARTER IN PREVIRE DEPTION MUST BE SELECTED. DO NOT PROVIDE SUPPLY STARTER IN PREVIRE DEPTION MUST BE SELECTED. DO NOT PROVIDE SUPPLY STARTER IN PREVIRE DEPTION MUST BE SELECTED. ALL MIN SUPPLIED BY DITHES SELECTED. DO NOT PROVIDE SUPPLY STARTER IN PREVIRE DEPTION MUST BE SELECTED. DO NOT PROVIDE SUPPLY STARTER IN PREVIRE DEPTION MUST BE SELECTED. DO NOT PROVIDE SUPPLY STARTER IN PREVIRE DEPTION MUST BE SELECTED. DO NOT PROVIDE SUPPLY STARTER IN PREVIRE DEPTION MUST BE SELECTED. DO NOT PROVIDE SUPPLY STARTER IN PREVIRE DEPTION MUST BE	1	WEF-1	1	CLASS C SPARK RESISTANT CONSTRUCTION FOR PRVS
1 VFD FACTORY MOUNTED AND WIRED IN EXHAUST FAN 1 VFD MOUNTING BRACKET FOR DU/DR 180 - 200 1 2 YEAR PARTS WARRANTY 1 UPBLAST FAN WHEEL ACCESS PORT 1 VALLMOUNT 27.5 SG. X 5' 1 SHIP LODSE DISCONNECT FOR REMOTE MOUNT 1 VALL MOUNT CONSTRUCTION 18/20 (D60 ISOLATORS), 70LB MOTOR MAX FOR WALL MOUNTING 1 CLASS C SPARK RESISTANT CONSTRUCTION FOR PRVS 1 CEMANDS FAN HEAT BAFFLE 1 TOWNS - TEPLON COLSTED WHEEL 1 VAV PACKAGE W/PRESET OR REFERENCE SPEEDS (VFD INCLUDED) 1 VFD MOUNTING BRACKET FOR DU/DR 180 - 200 1 VFD FACTORY MOUNTED AND WIRED IN EXHAUST FAN 1 VFD MOUNTING BRACKET FOR DU/DR 180 - 200 1 VFD FACTORY MOUNTED AND WIRED IN EXHAUST FAN 1 NINET PRESSURE GAUGE, 0-35' 1 MANIFOLD PRESSURE GAUGE, 0-5' 1 MANIFOLD PRESSURE GAUGE, 0 TO 10' WC, 1 FURNACE 1 SIZE 2 TALL TEMPERED COMMERCIAL DOWN DISCHARGE FOR 18TS 1 COMMERCIAL SMOKE DETECTOR/ALARM INTERCIOCK - ALARM SUPPLIED BY OTHERS 1 SIZE 2 TALL TEMPERED COMMERCIAL DOWN DISCHARGE FOR 18TS 1 COMMERCIAL SMOKE DETECTOR/ALARM INTERCIOCK - ALARM SUPPLIED BY OTHERS 1 SIZE DIN THE 18T HEATER, THE #28, #47, *WS', *WAY, DR *C2' PREVIRE OPTION MUST 1 SE SELECTED. DO NOT PROVIDE SUPPLY STAFFER IN PREVIRE 1 CLOGGED FILTER SWITCH - NOTIFICATION ON HMI 1 VAV PACKAGE W/ MANUAL/DDC CONTROL (S71 VFD INCLUDED) 1 VFD FACTORY MOUNTED AND WIRED IN 18T COMMERCIAL CONTROL VESTIBULE 1 SYEAR ENTIRE UNIT PARTS WARRANTY, 25 YEAR STAINLESS STEEL FURNACE PARTS WARRANTY 1 INLET PRESSURE GAUGE, 0-35' 1 MANIFOLD PRESSURE GAU			1	TCW18 - TEFLON COATED WHEEL
1 VFD MOUNTING BRACKET FOR DU/DR 180 - 200 1 2 YEAR PARTS WARRANTY 1 UPBLAST FAN WHEEL ACCESS PORT 1 VALLMOUNT 27.5 SG. X 5' 1 SHIP LOOSE DISCONNECT FOR REMOTE MOUNT 1 WALL MOUNT CONSTRUCTION 18/20 GB60 ISOLATORS), 70LB MOTOR MAX FOR WALL MOUNTING 1 CLASS C SPARK RESISTANT CONSTRUCTION FOR PRVS 1 EXHAUST FAN HEAT BAFFLE 1 TOW18 - TEFLON CONATED WHEEL 1 VAV PACKAGE W/PRESET OR REFERENCE SPEEDS (VFD INCLUDED) 1 VFD FACTORY MOUNTED AND WIRED IN EXHAUST FAN 1 VFD MOUNTING BRACKET FOR DU/DR 180 - 200 1 2 YEAR PARTS WARRANTY 1 INLET PRESSURE GAUGE, 0-35' 1 MANIFOLD PRESSURE GAUGE, 0-35' 1 LUSED ON THE 18T HEATER, THE #28, #47, "NS", "MA", DR "FEZ" PREWIRE OPTION MUST 1 SINGLE POINT ELECTRICAL CONNECTION SINGLE MODULE. IF A NON-DOV PREWIRE IS 2 YEAR ENTIRE UNIT PARTS WARRANTY, 25 YEAR STAINLESS STEEL FURNACE PARTS WARRANTY 1 LUSED ON THE 18T HEATER, THE #28, #47, "NS", "MA", DR "FEZ" PREWIRE OPTION MUST 1 VFD FACTORY MOUNTED AND VIRED IN 18T COMMERCIAL CONTROL VESTIBULE 4 GFMUA-1 4 GFMUA-2 4 GFMUA-2 4 GFMUA-2 4 GFMUA-2 5 INDICATE SURE GAUGE, 0 TO 10' WC, 1 FURNACE 1 MOTORIZED BACKDRAFT DAMPER FOR A2-1 HOUSING - MEETS AMCA CLASS IA RATING 1 LOGGED FILTER SWITCH - NOTIFICATION ON HMI 1 VAV PACKAGE W/MANUAL/DDC CONTROL (S71 VFD INCLUDED) 4 VFD FACTORY MOUNTED AND VIRED IN 18T COMMERCIAL CONTROL VESTIBULE 1 SIZE 2 TALL TEMPERED COMMERCIAL DOWN DISCHARCE FOR 18TS 1 MANIFOLD PRESSURE GAUGE, 0 TO 10' WC, 1 FURNACE 1 MOTORIZED BACKDRAFT DAMPER FOR A2-1 HOUSING - MEETS AMCA CLASS IA RATING 1 SIZE 2 TALL TEMPERED COMMERCIAL DOWN DISCHARCE FOR 18TS 1 MANIFOLD PRESSURE GAUGE, 0 TO 10' WC, 1 FURNACE 1 MOTORIZED BACKDRAFT DAMPER FOR A2-1 HOUSING - MEETS AMCA CLASS IA RATING 1 SIZE 2 TALL TEMPERED COMMERCIAL DOWN DISCHARCE FOR 18TS 1 COMMERCIAL SMIKE DETECTORYALARM INTERLOCK - ALARM SUPPLIED BY DITHERS 1 CLOGGED FILTER SWITCH - NOTIFICATION ON HMI 1 VAV PACKAGE W/ MANUAL/JODC CONTROL (S71 VFD INCLUDED) 1 VFD FACTORY MOUNTED AND VIRED IN 18T COMMERCIAL CONTROL VESTIBULE			1	VAV PACKAGE W/PRESET OR REFERENCE SPEEDS (VFD INCLUDED)
1 2 YEAR PARTS WARRANTY 1 UPBLAST FAN WHEEL ACCESS PORT 1 WALLMOUNT 2.75 SO. X 5' 1 SHIP LODSE DISCONNECT FOR REMOTE MOUNT 1 WALL MOUNT CONSTRUCTION 18/20 (D60 ISDLATORS), 70LB MOTOR MAX FOR VALL MOUNTING 1 CLASS C SPARK RESISTANT CONSTRUCTION FOR PRVS 1 EXHAUST FAN HEAT BAFFLE 1 TCV18 - TEFLON CONTENT WITHOUT FOR PRVS 1 EXHAUST FAN HEAT BAFFLE 1 TCV18 - TEFLON CONTENT WITHOUT AND VIRED IN EXHAUST FAN 1 VFD MOUNTING BRACKET FOR DU/DR 180 - 200 1 2 YEAR PARTS WARRANTY 1 INLET PRESSURE GAUGE, 0-35' 1 MANIFOLD PRESSURE GAUGE, 0-35' 1 MANIFOLD PRESSURE GAUGE, 0-35' 1 MANIFOLD PRESSURE GAUGE, 0-35' 1 SINGLE POINT ELECTRICAL DOWNERCIAL DOWN DISCHARGE FOR 1BTS 1 COMMERCIAL SMOKE DETECTOR/ALARM INTERLOCK - ALARM SUPPLIED BY OTHERS 1 SUBJED IN THE IST HEATER, THE HEAR, 47, 7/SS, 7/AS,			1	VFD FACTORY MOUNTED AND WIRED IN EXHAUST FAN
1 UPBLAST FAN WHEEL ACCESS PORT 1 WALLMOUNT 27.5 SO, X 5' 1 SHIP LODSE DISCONNECT FOR REMOTE MOUNT 1 WALL MOUNT CONSTRUCTION 18/20 (D60 ISOLATORS), 70LB MOTOR MAX FOR WALL MOUNTING 1 CLASS C SPARK RESISTANT CONSTRUCTION FOR PRVS 1 EXHAUST FAN HEAT BAFFLE 1 TCW18 - TEFLON COATED WHEEL 1 VAV PACKAGE W/PRESET OR REFERENCE SPEEDS (VFD INCLUDED) 1 VFD FACTORY MOUNTED AND WIRED IN EXHAUST FAN 1 VFD MOUNTING BRACKET FOR DU/DR 180 - 200 1 2 YEAR PARTS WARRANTY 1 INLET PRESSURE GAUGE, 0 TO 10' WC, 1 FURNACE 1 MANIFOLD PRESSURE GAUGE, 0 TO 10' WC, 1 FURNACE 1 MOTORIZED BACKDRAFT DAMPER FOR A2-I HOUSING - MEETS AMCA CLASS 1A RATING 1 SIZE 2 TALL TEMPERED COMMERCIAL DOWN DISCHARGE FOR 18TS 2 GFMUA-1 SINGLE POINT ELECTRICAL CONNECTION SINGLE MODULE. IF A NON-DCV PREVIRE IS 2 USED BUT THE 18T HEATER, THE #88, #47, "NS", "MA", OR "E2" PREVIRE OPTION MUST 3 ES ESLECTED. DO NOT PROVIDE SUPPLY STARTER IN PREVIRE UPTION MUST 4 CLOGGED FILTER SWITCH - NOTIFICATION ON HMI 1 VAV PACKAGE W/ MANUAL/DDC CONTROL (S71 VFD INCLUDED) 1 VFD FACTORY MOUNTED AND WIRED IN 18T COMMERCIAL CONTROL VESTIBULE 1 2 YEAR ENTIRE UNIT PARTS WARRANTY, 25 YEAR STAINLESS STEEL FURNACE PARTS WARRANTY 1 INLET PRESSURE GAUGE, 0 TO 10' WC, 1 FURNACE 1 MOTORIZED BACKDRAFT DAMPER FOR A2-I HOUSING - MEETS AMCA CLASS 1A RATING 1 SIZE 2 TALL TEMPERED COMMERCIAL DOWN DISCHARGE FOR 18TS 1 MANIFOLD PRESSURE GAUGE, 0 TO 10' WC, 1 FURNACE 1 MOTORIZED BACKDRAFT DAMPER FOR A2-I HOUSING - MEETS AMCA CLASS 1A RATING 2 SYEAR ENTIRE UNIT PARTS WARRANTY, 25 YEAR STAINLESS STEEL FURNACE PARTS WARRANTY 2 SINGLE POINT ELECTRICAL CONNECTION SINGLE MODULE. IF A NON-DOV PREVIRE IS 3 COMMERCIAL SMOKE DETECTORY/LARM INTERLICOK - ALARM SUPPLIED BY DTHERS 4 GFMUA-2 1 SINGLE POINT ELECTRICAL CONNECTION SINGLE MODULE. IF A NON-DOV PREVIRE IS 3 COMMERCIAL SMOKE DETECTORY/LARM INTERLICOK - ALARM SUPPLIED BY DTHERS 4 CLOGGED FILTER SWITCH - NOTIFICATION ON HMI 3 VFD FACTORY MOUNTED AND WIRED IN 18T COMMERCIAL CONTROL VESTIBULE			1	VFD MOUNTING BRACKET FOR DU/DR 180 - 200
1 WALLMOUNT 27.5 SQ. X 5" 1 SHIP LODSE DISCONNECT FOR REMOTE MOUNT 1 WALL MOUNT CONSTRUCTION 18/20 (D60 ISOLATORS), 70LB MOTOR MAX FOR WALL MOUNTING 1 CLASS C SPARK RESISTANT CONSTRUCTION FOR PRVS 1 EXHAUST FAN HEAT BAFFLE 1 TOWIS - TEFLON COATED WHEEL 1 VAV PACKAGE W/PRESET OR REFERENCE SPEEDS (VFD INCLUDED) 1 VFD FACTORY MOUNTED AND WIRED IN EXHAUST FAN 1 VFD MOUNTING BRACKET FOR DU/DR 180 - 200 1 2 YEAR PARTS WARRANTY 1 INLET PRESSURE GAUGE, 0 -35" 1 MANTFOLD PRESSURE GAUGE, 0 TO 10" WC, 1 FURNACE 1 MOTORIZED BACKDRAFT DAMPER FOR A2-I HOUSING - MEETS AMCA CLASS 1A RATING 1 SIZE 2 TALL TEMPERED COMMERCIAL DOWN DISCHARGE FOR 18TS 1 COMMERCIAL SMOKE DETECTOR/ALARM INTERLOCK - ALARM SUPPLIED BY OTHERS 2 SINGLE POINT ELECTRICAL CONNECTION SINGLE MODULE. IF A NON-DOV PREVIRE IS USED ON THE 18TH HEATER, THE #88, #47, "NS", "MA", OR "REVEYEE OPTION MUST BE SELECTED. DO NOT PROVIDE SUPPLY STARTER IN PREWIRE 1 VAV PACKAGE W/ MANUAL/DDC CONTROL (ST) VFD INCLUDED) 1 VFD FACTORY MOUNTED AND WIRED IN 18TH COMMERCIAL CONTROL VESTIBULE 2 YEAR ENTIRE UNIT PARTS WARRANTY, 25 YEAR STAINLESS STEEL FURNACE PARTS WARRANTY 1 INLET PRESSURE GAUGE, 0 -35" 1 MANIFOLD PRESSURE GAUGE, 0 TO 10" WC, 1 FURNACE 1 MOTORIZED BACKDRAFT DAMPER FOR A2-I HOUSING - MEETS AMCA CLASS 1A RATING 1 SIZE 2 TALL TEMPERED COMMERCIAL DOWN DISCHARGE FOR 18TS 1 COMMERCIAL SMOKE DETECTOR/ALARM INTERLOCK - ALARM SUPPLIED BY OTHERS 1 SINGLE POINT ELECTRICAL CONNECTION SINGLE MODULE. IF A NON-DCV PREVIRE IS 1 COMMERCIAL SMOKE DETECTOR/ALARM INTERLOCK - ALARM SUPPLIED BY OTHERS 1 SINGLE POINT ELECTRICAL CONNECTION SINGLE MODULE. IF A NON-DCV PREVIRE IS 1 SINGLE POINT ELECTRICAL CONNECTION SINGLE MODULE. IF A NON-DCV PREVIRE IS 2 SINGLE POINT ELECTRICAL CONNECTION SINGLE MODULE. IF A NON-DCV PREVIRE IS 3 INGLE POINT ELECTRICAL CONNECTION SINGLE MODULE. IF A NON-DCV PREVIRE IS 4 SELECTED. DO NOT PROVIDE SUPPLY STARTER IN PREVIRE 1 LAVY PACKAGE W/ MANUAL/DDC CONTROL (ST) VFD INCLUDED) 1 VFD FACTORY MOUNTED AND WIRED IN 18T COMMERCIAL CONTROL VESTIBULE			1	2 YEAR PARTS WARRANTY
1 SHIP LODGE DISCONNECT FOR REMOTE MOUNT 1 WALL MOUNT CONSTRUCTION 18/20 (D60 ISOLATORS), 70LB MOTOR MAX FOR WALL MOUNTING 1 CLASS C SPARK RESISTANT CONSTRUCTION FOR PRVS 1 EXHAUST FAN HEAT BAFFLE 1 TCW18 - TEFLON COATED WHEEL 1 VAY PACKAGE W/PRESET DR REFERENCE SPEEDS (VFD INCLUDED) 1 VFD FACTORY MOUNTED AND WIRED IN EXHAUST FAN 1 VFD MOUNTING BRACKET FOR DU/DR 180 - 200 1 2 YEAR PARTS WARRANTY 1 INLET PRESSURE GAUGE, 0 -35" 1 MANIFOLD PRESSURE GAUGE, 0 TO 10" WC, 1 FURNAGE 1 MOTORIZED BACKDRAFT DAMPER FOR A2-I HOUSING - MEETS AMCA CLASS 1A RATING 1 SIZE 2 TALL TEMPERED COMMERCIAL DOWN DISCHARGE FOR 18TS 1 COMMERCIAL SMOKE DETECTOR/ALARM INTERLOCK - ALARM SUPPLIED BY DTHERS 2 SINGLE POINT ELECTRICAL CONNECTION SINGLE MODULE. IF A NON-DCV PREVIRE IS USED DN THE 18T HEATER, THE #28, #47, "NS," MA", OR "E2" PREWIRE OPTION MUST BE SELECTED. DD NOT PROVIDE SUPPLY STARTER IN PREWIRE 1 CLOGGED FILTER SWITCH - NOTIFICATION ON HMI 1 VAY PACKAGE W/ MANUAL/DDC CONTROL 671 VFD INCLUDED) 1 VFD FACTORY MOUNTED AND WIRED IN 18T COMMERCIAL CONTROL VESTIBULE 2 YEAR ENTIRE UNIT PARTS WARRANTY, 25 YEAR STAINLESS STEEL FURNACE PARTS WARRANTY 1 INLET PRESSURE GAUGE, 0 TO 10" WC, 1 FURNAGE 1 MANIFOLD PRESSURE GAUGE, 0 TO 10" WC, 1 FURNAGE 2 MOTORIZED BACKDRAFT DAMPER FOR A2-I HOUSING - MEETS AMCA CLASS 1A RATING 3 IZE 2 TALL TEMPERED COMMERCIAL DOWN DISCHARGE FOR 18TS 1 COMMERCIAL SMOKE DETECTOR/ALARM INTERLOCK - ALARM SUPPLIED BY DTHERS 3 INGLE POINT ELECTRICAL CONNECTION SINGLE MODULE. IF A NON-DCV PREVIRE IS USED ON THE 18T HEATER, THE #28, #47, "NS,", "M", "M", "M", "P" FREVIRE OPTION MUST 3 ESELECTED. DO NOT PROVIDE SUPPLY STARTER IN PREVIRE OPTION MUST 4 ESELECTED. DO NOT PROVIDE SUPPLY STARTER IN PREVIRE 1 VAY PACKAGE W/ MANUAL/DDC CONTROL G571 VFD INCLUDED) 1 VFD FACTORY MOUNTED AND WIRED IN 18T COMMERCIAL CONTROL CONTR			1	UPBLAST FAN WHEEL ACCESS PORT
1 WALL MOUNT CONSTRUCTION 18/20 (D60 ISOLATORS), 70LB MOTOR MAX FOR WALL MOUNTING 1 CLASS C SPARK RESISTANT CONSTRUCTION FOR PRVS 1 EXHAUST FAN HEAT BAFFLE 1 TOWIS - TEFLON COLATED WHEEL 1 VAV PACKAGE W/PRESET OR REFERENCE SPEEDS (VFD INCLUDED) 1 VFD FACTORY MOUNTED AND WIRED IN EXHAUST FAN 1 VFD MOUNTING BRACKET FOR DU/DR 180 - 200 1 2 YEAR PARTS WARRANTY 1 INLET PRESSURE GAUGE, 0 -35' 1 MANIFOLD PRESSURE GAUGE, 0 -0 TO 10' WC, 1 FURNACE 1 MOTORIZED BACKDRAFT DAMPER FOR A2-I HOUSING - MEETS AMCA CLASS 1A RATING 1 SIZE 2 TALL TEMPERED COMMERCIAL DOWN DISCHARGE FOR 18TS 1 COMMERCIAL SMOKE DETECTOR/ALARM INTERLOCK - ALARM SUPPLIED BY DTHERS 1 USED ON THE 18T HEATER, THE #28, #47, *NS', *MA', OR *E2' PREWIRE OPTION MUST 1 CLOGGED FILTER SWITCH - NOTIFICATION ON HMI 1 VAV PACKAGE W/ MANUAL/DDC CONTROL (571 VFD INCLUDED) 1 VFD FACTORY MOUNTED AND WIRED IN 18T COMMERCIAL CONTROL VESTIBULE 1 2 YEAR ENTIRE UNIT PARTS WARRANTY, 25 YEAR STAINLESS STEEL FURNACE PARTS WARRANTY 1 INLET PRESSURE GAUGE, 0 -35' 1 MANIFOLD PRESSURE GAUGE, 0 TO 10' WC, 1 FURNACE 1 SIZE 2 TALL TEMPERED COMMERCIAL DOWN DISCHARGE FOR 18TS 1 COMMERCIAL SMOKE DETECTOR/ALARM INTERCOCK - ALARM SUPPLIED BY DTHERS 1 STINGLE POINT ELECTRICAL CONNECTION SINGLE MODULE. IF A NON-DCV PREWIRE 1S USED ON THE 18TH FARTS WARRANTY, 25 YEAR STAINLESS STEEL FURNACE PARTS WARRANTY 1 INLET PRESSURE GAUGE, 0 -35' 1 MANIFOLD PRESSURE GAUGE, 0 -35' 1 MANIFOLD PRESSURE GAUGE, 0 -35' 1 MANIFOLD PRESSURE GAUGE, 0 TO 10' WC, 1 FURNACE 1 SIZE 2 TALL TEMPERED COMMERCIAL DOWN DISCHARGE FOR 18TS 1 COMMERCIAL SMOKE DETECTOR/ALARM INTERCOCK - ALARM SUPPLIED BY DTHERS 1 COMMERCIAL SMOKE DETECTOR/ALARM INTERCOCK - ALARM SUPPLIED BY DTHERS 1 LOSD ON THE 18TH FLATER, THE #28, #447, *N5', *M4', GR *2e' PREWIRE OPTION MUST BE SELECTED. DO NOT PROVIDE SUPPLY STARTER IN PREWIRE 1 USED ON THE 18TH HEATER, THE #28, #447, *N5', *M4', GR *2e' PREWIRE OPTION MUST BE SELECTED. DO NOT PROVIDE SUPPLY STARTER IN PREWIRE 1 USED ON THE 18TH HEATER, THE #28, #447, *N5', *M4', GR *2e' PREWIRE OPTION M			1	WALLMOUNT 27.5 SQ. X 5"
1 CLASS C SPARK RESISTANT CONSTRUCTION FOR PRVS 1 EXHAUST FAN HEAT BAFFLE 1 TCW18 - TEFLON COATED WHEEL 1 VAV PACKAGE WYPRESET OR REFERENCE SPEEDS (VFD INCLUDED) 1 VFD FACTORY MOUNTED AND WIRED IN EXHAUST FAN 1 VFD MOUNTING BRACKET FOR DUYDR 180 - 200 1 2 YEAR PARTS WARRANTY 1 INLET PRESSURE GAUGE, 0-35' 1 MANIFOLD PRESSURE GAUGE, 0 TO 10' WC, 1 FURNACE 1 MOTORIZED BACKDRAFT DAMPER FOR A2-I HOUSING - MEETS AMCA CLASS 1A RATING 1 SIZE 2 TALL TEMPERED COMMERCIAL DOWN DISCHARGE FOR IBTS 1 COMMERCIAL SMOKE DETECTOR/ALARM INTERLOCK - ALARM SUPPLIED BY DTHERS 1 SINGLE POINT ELECTRICAL CONNECTION SINGLE MODULE. IF A NON-DCV PREWIRE IS 1 USED ON THE IBT HEATER, THE #28, #47, "NS', MA', OR '22' PREWIRE OPTION MUST BE SELECTED. DO NOT PROVIDE SUPPLY STARTER IN PREWIRE 1 CLOGGED FILTER SWITCH - NOTIFICATION ON HMI 1 VAV PACKAGE W/ MANUAL/DIC CONTROL (571 VFD INCLUDED) 1 VFD FACTORY MOUNTED AND WIRED IN 1BT COMMERCIAL CONTROL VESTIBULE 1 2 YEAR ENTIRE UNIT PARTS WARRANTY, 25 YEAR STAINLESS STEEL FURNACE PARTS WARRANTY 1 INLET PRESSURE GAUGE, 0-35' 1 MANIFOLD PRESSURE GAUGE, 0-35' 1 MANIFOLD PRESSURE GAUGE, 0 TO 10' WC, 1 FURNACE 1 MOTORIZED BACKDRAFT DAMPER FOR A2-I HOUSING - MEETS AMCA CLASS 1A RATING 1 SIZE 2 TALL TEMPERED COMMERCIAL DOWN DISCHARGE FOR 1BTS 1 COMMERCIAL SMOKE DETECTOR/ALARM INTERLOCK - ALARM SUPPLIED BY DTHERS 1 COMMERCIAL SMOKE DETECTOR/ALARM INTERLOCK - ALARM SUPPLIED BY DTHERS 1 USED ON THE 1BT HEATER, THE #28, #47, "NS', "Ma', fin "e2" PREWIRE OPTION MUST BE SELECTED. DID NOT PROVIDE SUPPLY STARTER IN PREWIRE 1 USED ON THE 1BT HEATER, THE #28, #47, "NS', "Ma', fin "e2" PREWIRE DITION MUST BE SELECTED. DID NOT PROVIDE SUPPLY STARTER IN PREWIRE 1 VAV PACKAGE W/ MANUAL/DDC CONTROL (571 VFD INCLUDED) 1 VAV PACKAGE W/ MANUAL/DDC CONTROL (571 VFD INCLUDED) 1 VAV PACKAGE W/ MANUAL/DDC CONTROL (571 VFD INCLUDED) 1 VAV PACKAGE W/ MANUAL/DDC CONTROL (571 VFD INCLUDED)			1	SHIP LOOSE DISCONNECT FOR REMOTE MOUNT
VEF-2 1 EXHAUST FAN HEAT BAFFLE 1 TCW18 - TEFLON COLATED WHEEL 1 VAV PACKAGE W/PRESET OR REFERENCE SPEEDS (VFD INCLUDED) 1 VFD FACTORY MOUNTED AND WIRED IN EXHAUST FAN 1 VFD MOUNTING BRACKET FOR DU/DR 180 - 200 1 2 YEAR PARTS WARRANTY 1 INLET PRESSURE GAUGE, 0 -35' 1 MANIFOLD PRESSURE GAUGE, 0 TO 10' WC, 1 FURNACE 1 MOTORIZED BACKDRAFT DAMPER FOR A2-I HOUSING - MEETS AMCA CLASS 1A RATING 1 SIZE 2 TALL TEMPERED COMMERCIAL DOWN DISCHARGE FOR IBTS 1 COMMERCIAL SMOKE DETECTOR/ALARM INTERLOCK - ALARM SUPPLIED BY OTHERS 2 SINGLE POINT ELECTRICAL CONNECTION SINGLE MODULE. I FA NON-DCV PREWIRE IS 1 USED ON THE 18T HEATER, THE #28, #47'. 'NS', 'MA', OR 'E2' PREWIRE OPTION MUST BE SELECTED. DO NOT PROVIDE SUPPLY STATTER IN PREWIRE 1 CLOGGED FILTER SWITCH - NOTIFICATION ON HMI 1 VAV PACKAGE W/ MANUAL/DDC CONTROL (571 VFD INCLUDED) 1 VFD FACTORY MOUNTED AND WIRED IN 18T COMMERCIAL CONTROL VESTIBULE 1 2 YEAR ENTIRE UNIT PARTS WARRANTY, 25 YEAR STAINLESS STEEL FURNACE PARTS WARRANTY 1 INLET PRESSURE GAUGE, 0 -35' 1 MANIFOLD PRESSURE GAUGE, 0 TO 10' WC, 1 FURNACE 1 MOTORIZED BACKDRAFT DAMPER FOR A2-I HOUSING - MEETS AMCA CLASS 1A RATING 1 SIZE 2 TALL TEMPERED COMMERCIAL DOWN DISCHARGE FOR 18TS 1 COMMERCIAL SMOKE DETECTOR/ALARM INTERLOCK - ALARM SUPPLIED BY OTHERS 1 SINGLE POINT ELECTRICAL CONNECTION SINGLE MODULE. IF A NON-DCV PREWIRE IS 1 USED ON THE 18T HEATER, THE #28, #47, 'NS', 'MA', OR 'E2' PREWIRE OPTION MUST BE SELECTED. DO NOT PROVIDE SUPPLY STATER IN PREWIRE 1 CLOGGED FILTER SWITCH - NOTIFICATION ON HMI 1 VAV PACKAGE W/ MANUAL/DDC CONTROL (571 VFD INCLUDED) 1 VFD FACTORY MOUNTED AND WIRED IN 18T COMMERCIAL CONTROL VESTIBULE			1	WALL MOUNT CONSTRUCTION 18/20 (D60 ISOLATORS), 70LB MOTOR MAX FOR WALL MOUNTING
1 TCW18 - TEFLDIN CDATED WHEEL 1 VAV PACKAGE W/PRESET OR REFERENCE SPEEDS (VFD INCLUDED) 1 VFD FACTORY MOUNTED AND WIRED IN EXHAUST FAN 1 VFD MOUNTING BRACKET FOR DU/DR 180 - 200 1 2 YEAR PARTS WARRANTY 1 INLET PRESSURE GAUGE, 0 -35' 1 MANIFOLD PRESSURE GAUGE, 0 TO 10' WC, 1 FURNACE 1 MOTORIZED BACKDRAFT DAMPER FOR A2-I HOUSING - MEETS AMCA CLASS 1A RATING 1 SIZE 2 TALL TEMPERED COMMERCIAL DOWN DISCHARGE FOR IBTS 1 COMMERCIAL SMOKE DETECTOR/ALARM INTERLOCK - ALARM SUPPLIED BY OTHERS 2 SINGLE POINT ELECTRICAL CONNECTION SINGLE MODULE. IF A NON-DCV PREWIRE IS USED ON THE 1BT HEATER, THE #28, #47, "NS', "MA", OR "SE" PREWIRE DPTION MUST BE SELECTED. DO NOT PROVIDE SUPPLY STARTER IN PREWIRE 1 CLOGGED FILTER SWITCH - NOTIFICATION ON HMI 1 VAV PACKAGE W/ MANUAL/DDC CONTROL (S71 VFD INCLUDED) 1 VFD FACTORY MOUNTED AND WIRED IN 1BT COMMERCIAL CONTROL VESTIBULE 1 2 YEAR ENTIRE UNIT PARTS WARRANTY, 25 YEAR STAINLESS STEEL FURNACE PARTS WARRANTY 1 INLET PRESSURE GAUGE, 0 TO 10' WC, 1 FURNACE 1 MANIFOLD PRESSURE GAUGE, 0 TO 10' WC, 1 FURNACE 1 MANIFOLD PRESSURE GAUGE, 0 TO 10' WC, 1 FURNACE 1 SIZE 2 TALL TEMPERED COMMERCIAL DOWN DISCHARGE FOR IBTS 1 COMMERCIAL SMOKE DETECTOR/ALARM INTERLOCK - ALARM SUPPLIED BY OTHERS 1 SINGLE POINT ELECTRICAL CONNECTION SINGLE MODULE. IF A NON-DCV PREWIRE IS USED ON THE 1BT HEATER, THE #28, #47, "NS", "MA", OR "SE" PREWIRE DPTION MUST BE SELECTED. DO NOT PROVIDE SUPPLY STARTER IN PREWIRE 1 CLOGGED FILTER SWITCH - NOTIFICATION ON HMI 1 VAV PACKAGE W/ MANUAL/DDC CONTROL (S71 VFD INCLUDED) 1 VFD FACTORY MOUNTED AND WIRED IN 1BT COMMERCIAL CONTROL VESTIBULE			1	CLASS C SPARK RESISTANT CONSTRUCTION FOR PRVS
1 VAV PACKAGE W/PRESET OR REFERENCE SPEEDS (VFD INCLUDED) 1 VFD FACTORY MOUNTED AND WIRED IN EXHAUST FAN 1 VFD MOUNTING BRACKET FOR DU/DR 180 - 200 1 2 YEAR PARTS WARRANTY 1 INLET PRESSURE GAUGE, 0-35' 1 MANIFOLD PRESSURE GAUGE, 0 10 10' WC, 1 FURNACE 1 MOTORIZED BACKDRAFT DAMPER FOR A2-I HOUSING - MEETS AMCA CLASS 1A RATING 1 SIZE 2 TALL TEMPERED COMMERCIAL DOWN DISCHARGE FOR 18TS 1 COMMERCIAL SMOKE DETECTOR/ALARM INTERLOCK - ALARM SUPPLIED BY DITHERS SINGLE POINT ELECTRICAL CONNECTION SINGLE MODULE. IF A NON-DCV PREWIRE IS USED ON THE 18T HEATER, THE #28, #47, "NS", "MA", OR "E2" PREWIRE OPTION MUST BE SELECTED. DO NOT PROVIDE SUPPLY STARTER IN PREWIRE 1 CLOGGED FILTER SWITCH - NOTIFICATION ON HMI 1 VAV PACKAGE W/ MANUAL/DDC CONTROL (571 VFD INCLUDED) 1 VFD FACTORY MOUNTED AND WIRED IN 18T COMMERCIAL CONTROL VESTIBULE 2 YEAR ENTIRE UNIT PARTS WARRANTY, 25 YEAR STAINLESS STEEL FURNACE PARTS WARRANTY 1 INLET PRESSURE GAUGE, 0-35' 1 MANIFOLD PRESSURE GAUGE, 0 TO 10' WC, 1 FURNACE 1 MOTORIZED BACKDRAFT DAMPER FOR A2-I HOUSING - MEETS AMCA CLASS 1A RATING 1 SIZE 2 TALL TEMPERED COMMERCIAL DOWN DISCHARGE FOR 18TS 1 COMMERCIAL SMOKE DETECTOR/ALARM INTERLOCK - ALARM SUPPLIED BY DITHERS SINGLE POINT ELECTRICAL CONNECTION SINGLE MODULE. IF A NON-DCV PREWIRE IS USED ON THE 18T HEATER, THE #28, #47, "NS", "MA", OR "E2" PREWIRE OPTION MUST BE SELECTED. DO NOT PROVIDE SUPPLY STARTER IN PREWIRE 1 CLOGGED FILTER SWITCH - NOTIFICATION ON HMI 1 VAV PACKAGE W/ MANUAL/DDC CONTROL (571 VFD INCLUDED) 1 VFD FACTORY MOUNTED AND WIRED IN 18T COMMERCIAL CONTROL VESTIBULE	2	WEF-2	1	EXHAUST FAN HEAT BAFFLE
1 VFD FACTORY MOUNTED AND WIRED IN EXHAUST FAN 1 VFD MOUNTING BRACKET FOR DU/DR 180 - 200 1 2 YEAR PARTS WARRANTY 1 INLET PRESSURE GAUGE, 0-35' 1 MANIFOLD PRESSURE GAUGE, 0 TO 10' WC, 1 FURNACE 1 MOTORIZED BACKDRAFT DAMPER FOR A2-I HOUSING - MEETS AMCA CLASS 1A RATING 1 SIZE 2 TALL TEMPERED COMMERCIAL DOWN DISCHARGE FOR IBTS 1 COMMERCIAL SMOKE DETECTOR/ALARM INTERLOCK - ALARM SUPPLIED BY OTHERS 1 SINGLE POINT ELECTRICAL CONNECTION SINGLE MODULE. IF A NON-DOV PREWIRE IS USED DIN THE IBT HEATER, THE #28, #47, "MS", "MA", DR "E2" PREWIRE OPTION MUST BE SELECTED. DO NOT PROVIDE SUPPLY STARTER IN PREWIRE 1 CLOGGED FILTER SWITCH - NOTIFICATION DIN HMI 1 VAV PACKAGE W/ MANUAL/DDC CONTROL (571 VFD INCLUDED) 1 VFD FACTORY MOUNTED AND WIRED IN IBT COMMERCIAL CONTROL VESTIBULE 1 2 YEAR ENTIRE UNIT PARTS WARRANTY, 25 YEAR STAINLESS STEEL FURNACE PARTS WARRANTY 1 INLET PRESSURE GAUGE, 0-35' 1 MANIFOLD PRESSURE GAUGE, 0 TO 10' WC, 1 FURNACE 1 MOTORIZED BACKDRAFT DAMPER FOR A2-I HOUSING - MEETS AMCA CLASS 1A RATING 1 SIZE 2 TALL TEMPERED COMMERCIAL DOWN DISCHARGE FOR IBTS 1 COMMERCIAL SMOKE DETECTOR/ALARM INTERLOCK - ALARM SUPPLIED BY OTHERS SINGLE POINT ELECTRICAL CONNECTION SINGLE MODULE. IF A NON-DOV PREWIRE IS 1 USED DIN THE IBT HEATER, THE #28, #47, "NS", "MA", OR "E2" PREWIRE OPTION MUST BE SELECTED. DO NOT PROVIDE SUPPLY STARTER IN PREWIRE 1 CLOGGED FILTER SWITCH - NOTIFICATION DIN HMI 1 VAV PACKAGE W/ MANUAL/DDC CONTROL (571 VFD INCLUDED) 1 VFD FACTORY MOUNTED AND WIRED IN IBT COMMERCIAL CONTROL VESTIBULE			1	TCW18 - TEFLON COATED WHEEL
1 VFD MOUNTING BRACKET FOR DU/DR 180 - 200 1 2 YEAR PARTS WARRANTY 1 INLET PRESSURE GAUGE, 0-35' 1 MANIFOLD PRESSURE GAUGE, 0 TO 10' WC, 1 FURNACE 1 MOTORIZED BACKDRAFT DAMPER FOR A2-I HOUSING - MEETS AMCA CLASS 1A RATING 1 SIZE 2 TALL TEMPERED COMMERCIAL DOWN DISCHARGE FOR 1BTS 1 COMMERCIAL SMOKE DETECTOR/ALARM INTERLOCK - ALARM SUPPLIED BY OTHERS 1 USED DN THE IBT HEATER, THE #28, #47, "NS", "MA", OR "62' PREWIRE OPTION MUST 1 SELECTED. DO NOT PROVIDE SUPPLY STARTER IN PREWIRE 1 CLOGGED FILTER SWITCH - NOTIFICATION DN HMI 1 VAV PACKAGE W/ MANUAL/DDC CONTROL (S71 VFD INCLUDED) 1 VFD FACTORY MOUNTED AND WIRED IN 1BT COMMERCIAL CONTROL VESTIBULE 1 2 YEAR ENTIRE UNIT PARTS WARRANTY, 25 YEAR STAINLESS STEEL FURNACE PARTS WARRANTY 1 INLET PRESSURE GAUGE, 0-35' 1 MANIFOLD PRESSURE GAUGE, 0 TO 10' WC, 1 FURNACE 1 MOTORIZED BACKDRAFT DAMPER FOR A2-I HOUSING - MEETS AMCA CLASS 1A RATING 1 SIZE 2 TALL TEMPERED COMMERCIAL DOWN DISCHARGE FOR IBTS 1 COMMERCIAL SMOKE DETECTOR/ALARM INTERLOCK - ALARM SUPPLIED BY OTHERS 1 SINGLE POINT ELECTRICAL CONNECTION SINGLE MODULE. IF A NON-DCV PREWIRE IS 2 SINGLE POINT ELECTRICAL CONNECTION SINGLE MODULE. IF A NON-DCV PREWIRE IS 3 USED DN THE IBT HEATER, THE #28, #47, "NS", "MA", DR "62' PREWIRE OPTION MUST BE SELECTED. DO NOT PROVIDE SUPPLY STARTER IN PREWIRE 1 CLOGGED FILTER SWITCH - NOTIFICATION DN HMI 1 VAV PACKAGE W/ MANUAL/DDC CONTROL (571 VFD INCLUDED) 1 VFD FACTORY MOUNTED AND WIRED IN 1BT COMMERCIAL CONTROL VESTIBULE			1	VAV PACKAGE W/PRESET OR REFERENCE SPEEDS (VFD INCLUDED)
1 2 YEAR PARTS WARRANTY 1 INLET PRESSURE GAUGE, 0-35' 1 MANIFOLD PRESSURE GAUGE, 0 TO 10' WC, 1 FURNACE 1 MOTORIZED BACKDRAFT DAMPER FOR A2-I HOUSING - MEETS AMCA CLASS 1A RATING 1 SIZE 2 TALL TEMPERED COMMERCIAL DOWN DISCHARGE FOR IBTS 1 COMMERCIAL SMOKE DETECTOR/ALARM INTERLOCK - ALARM SUPPLIED BY OTHERS SINGLE POINT ELECTRICAL CONNECTION SINGLE MODULE. IF A NON-DCV PREWIRE IS 1 USED ON THE IBT HEATER, THE #28, #47, "NS", "MA", OR "E2" PREWIRE OPTION MUST 1 DESCRIPTION ON THE WARNAL/DDC CONTROL (\$71 VFD INCLUDED) 1 VFD FACTORY MOUNTED AND WIRED IN IBT COMMERCIAL CONTROL VESTIBULE 1 2 YEAR ENTIRE UNIT PARTS WARRANTY, 25 YEAR STAINLESS STEEL FURNACE PARTS WARRANTY 1 INLET PRESSURE GAUGE, 0-35' 1 MANIFOLD PRESSURE GAUGE, 0 TO 10' WC, 1 FURNACE 1 MOTORIZED BACKDRAFT DAMPER FOR A2-I HOUSING - MEETS AMCA CLASS 1A RATING 1 SIZE 2 TALL TEMPERED COMMERCIAL DOWN DISCHARGE FOR IBTS 1 COMMERCIAL SMOKE DETECTOR/ALARM INTERLOCK - ALARM SUPPLIED BY OTHERS 4 GFMUA-2 4 GFMUA-2 5 SINGLE POINT ELECTRICAL CONNECTION SINGLE MODULE. IF A NON-DCV PREWIRE IS 1 USED ON THE IBT HEATER, THE #28, #47, "NS", "MA", OR "E2" PREWIRE OPTION MUST 1 BE SELECTED. DO NOT PROVIDE SUPPLY STARTER IN PREWIRE 1 CLOGGED FILTER SWITCH - NOTIFICATION ON HMI 1 VAV PACKAGE W/ MANUAL/DDC CONTROL (\$71 VFD INCLUDED) 1 VFD FACTORY MOUNTED AND WIRED IN IBT COMMERCIAL CONTROL VESTIBULE			1	VFD FACTORY MOUNTED AND WIRED IN EXHAUST FAN
1 INLET PRESSURE GAUGE, 0-35' 1 MANIFOLD PRESSURE GAUGE, 0 TO 10' WC, 1 FURNACE 1 MOTORIZED BACKDRAFT DAMPER FOR A2-I HOUSING - MEETS AMCA CLASS 1A RATING 1 SIZE 2 TALL TEMPERED COMMERCIAL DOWN DISCHARGE FOR 1BTS 1 COMMERCIAL SMOKE DETECTOR/ALARM INTERLOCK - ALARM SUPPLIED BY OTHERS SINGLE POINT ELECTRICAL CONNECTION SINGLE MODULE. IF A NON-DCV PREWIRE IS USED ON THE 1BT HEATER, THE #28, #47, 'NS', 'MA', OR 'E2' PREWIRE OPTION MUST BE SELECTED. DO NOT PROVIDE SUPPLY STARTER IN PREWIRE 1 CLOGGED FILTER SWITCH - NOTIFICATION ON HMI 1 VAV PACKAGE W/ MANUAL/DDC CONTROL (571 VFD INCLUDED) 1 VFD FACTORY MOUNTED AND WIRED IN 1BT COMMERCIAL CONTROL VESTIBULE 1 2 YEAR ENTIRE UNIT PARTS WARRANTY, 25 YEAR STAINLESS STEEL FURNACE PARTS WARRANTY 1 INLET PRESSURE GAUGE, 0 TO 10' WC, 1 FURNACE 1 MOTORIZED BACKDRAFT DAMPER FOR A2-I HOUSING - MEETS AMCA CLASS 1A RATING 1 SIZE 2 TALL TEMPERED COMMERCIAL DOWN DISCHARGE FOR 1BTS 1 COMMERCIAL SMOKE DETECTOR/ALARM INTERLOCK - ALARM SUPPLIED BY OTHERS 4 GFMUA-2 4 GFMUA-2 5 INGLE POINT ELECTRICAL CONNECTION SINGLE MODULE. IF A NON-DCV PREWIRE IS USED ON THE 1BT HEATER, THE #28, #47, 'NS', 'MA', OR 'E2' PREWIRE OPTION MUST BE SELECTED. DO NOT PROVIDE SUPPLY STARTER IN PREWIRE 1 CLOGGED FILTER SWITCH - NOTIFICATION ON HMI 1 VAV PACKAGE W/ MANUAL/DDC CONTROL (571 VFD INCLUDED) 1 VFD FACTORY MOUNTED AND WIRED IN 1BT COMMERCIAL CONTROL VESTIBULE			1	VFD MOUNTING BRACKET FOR DU/DR 180 - 200
1 MANIFOLD PRESSURE GAUGE, 0 TO 10° WC, 1 FURNACE 1 MOTORIZED BACKDRAFT DAMPER FOR A2-I HOUSING - MEETS AMCA CLASS 1A RATING 1 SIZE 2 TALL TEMPERED COMMERCIAL DOWN DISCHARGE FOR IBTS 1 COMMERCIAL SMOKE DETECTOR/ALARM INTERLOCK - ALARM SUPPLIED BY DTHERS 2 SINGLE POINT ELECTRICAL CONNECTION SINGLE MODULE. IF A NON-DCV PREWIRE IS USED ON THE IBT HEATER, THE #28, #47, "NS", "MA", OR "E2" PREWIRE OPTION MUST BE SELECTED. DO NOT PROVIDE SUPPLY STARTER IN PREWIRE 1 CLOGGED FILTER SWITCH - NOTIFICATION ON HMI 1 VAV PACKAGE W/ MANUAL/DDC CONTROL (571 VFD INCLUDED) 1 VFD FACTORY MOUNTED AND WIRED IN 1BT COMMERCIAL CONTROL VESTIBULE 1 2 YEAR ENTIRE UNIT PARTS WARRANTY, 25 YEAR STAINLESS STEEL FURNACE PARTS WARRANTY 1 INLET PRESSURE GAUGE, 0 -35" 1 MANIFOLD PRESSURE GAUGE, 0 -35" 1 MANIFOLD PRESSURE GAUGE, 0 TO 10" WC, 1 FURNACE 1 MOTORIZED BACKDRAFT DAMPER FOR A2-I HOUSING - MEETS AMCA CLASS 1A RATING 1 SIZE 2 TALL TEMPERED COMMERCIAL DOWN DISCHARGE FOR 1BTS 1 COMMERCIAL SMOKE DETECTOR/ALARM INTERLOCK - ALARM SUPPLIED BY OTHERS 1 USED ON THE 1BT HEATER, THE #28, #47, "NS", "MA", OR "E2" PREWIRE OPTION MUST BE SELECTED. DO NOT PROVIDE SUPPLY STARTER IN PREWIRE 1 CLOGGED FILTER SWITCH - NOTIFICATION ON HMI 1 VAV PACKAGE W/ MANUAL/DDC CONTROL (571 VFD INCLUDED) 1 VFD FACTORY MOUNTED AND WIRED IN 1BT COMMERCIAL CONTROL VESTIBULE			1	2 YEAR PARTS WARRANTY
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1 VFD FACTORY MOUNTED AND WIRED IN 1BT COMMERCIAL CONTROL VESTIBULE			1	CLOGGED FILTER SWITCH - NOTIFICATION ON HMI
			1	VAV PACKAGE W/ MANUAL/DDC CONTROL (571 VFD INCLUDED)
1 2 YEAR ENTIRE UNIT PARTS WARRANTY, 25 YEAR STAINLESS STEEL FURNACE PARTS WARRANTY			1	VFD FACTORY MOUNTED AND WIRED IN IBT COMMERCIAL CONTROL VESTIBULE
			1	2 YEAR ENTIRE UNIT PARTS WARRANTY, 25 YEAR STAINLESS STEEL FURNACE PARTS WARRANTY

			1	2 YEAR PARTS WARRANTY
			1	INLET PRESSURE GAUGE, 0-35"
			1	MANIFOLD PRESSURE GAUGE, 0 TO 10" WC, 1 FURNACE
			1	MOTORIZED BACKDRAFT DAMPER FOR A2-I HOUSING - MEETS AMCA CLASS 1A RATING
			1	SIZE 2 TALL TEMPERED COMMERCIAL DOWN DISCHARGE FOR IBTS
			1	COMMERCIAL SMOKE DETECTOR/ALARM INTERLOCK - ALARM SUPPLIED BY OTHERS
	3	GFMUA-1	1	SINGLE POINT ELECTRICAL CONNECTION SINGLE MODULE. IF A NON-DOV PREWIRE IS USED ON THE IBT HEATER, THE #28, #47, "NS", "MA", OR "E2" PREWIRE OPTION MUST BE SELECTED. DO NOT PROVIDE SUPPLY STARTER IN PREWIRE
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			1	VFD FACTORY MOUNTED AND WIRED IN IBT COMMERCIAL CONTROL VESTIBULE
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			1	SIZE 2 TALL TEMPERED COMMERCIAL DOWN DISCHARGE FOR IBTS
			1	COMMERCIAL SMOKE DETECTOR/ALARM INTERLOCK - ALARM SUPPLIED BY OTHERS
	4	GFMUA-2	1	SINGLE POINT ELECTRICAL CONNECTION SINGLE MODULE. IF A NON-DOV PREWIRE IS USED ON THE IBT HEATER, THE #28, #47, "NS", "MA", OR "E2" PREWIRE OPTION MUST BE SELECTED. DO NOT PROVIDE SUPPLY STARTER IN PREWIRE
			1	CLOGGED FILTER SWITCH - NOTIFICATION ON HMI
			1	VAV PACKAGE W/ MANUAL/DDC CONTROL (571 VFD INCLUDED)
			1	VFD FACTORY MOUNTED AND WIRED IN IBT COMMERCIAL CONTROL VESTIBULE
			1	2 YEAR ENTIRE UNIT PARTS WARRANTY, 25 YEAR STAINLESS STEEL FURNACE PARTS WARRANTY


FAN ACCESSORIES


FAN UNIT	TAG		EXHAUST			SUPF	PLY	
ND	1	GREASE CUP	GRAVITY DAMPER	WALL MOUNT	SIDE DISCHARGE	GRAVITY DAMPER	MOTORIZED DAMPER	WALL MOUNT
1	WEF-1			YES				
2	WEF-2			YES				
3	GFMUA-1						YES	
4	GFMUA-2						YES	

CURB ASSEMBLIES

N□	□N FAN	TAG	WEIGHT	ITEM	SIZE
1	# 4	GFMUA-1	107 LBS	CURB	31.000"W X 79.000"L X 20.000"H ALONG WIDTH, RIGHT INSULATED.
	# 4			RAIL	6.000"W X 31.000"L X 20.000"H RIGHT.
Ω	# 3	GFMUA-1	107 LBS	CURB	31.000"W X 79.000"L X 20.000"H ALONG WIDTH, RIGHT INSULATED.
	# 3			RAIL	6.000"W X 31.000"L X 20.000"H RIGHT.

FANS #1 (EF-1), #2 (EF-2) - DU180HFA EXHAUST FAN

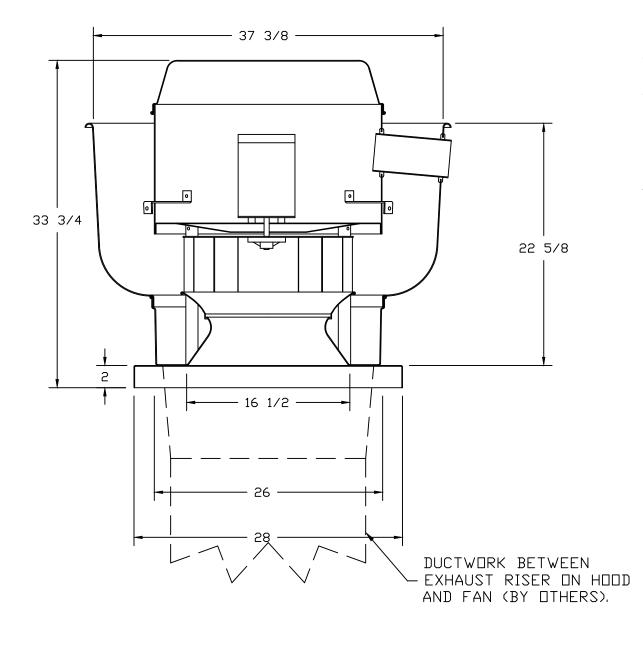

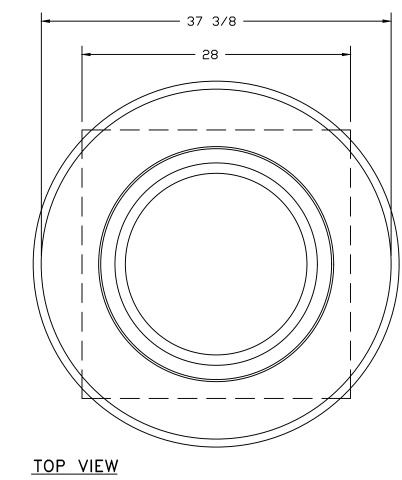

FEATURES:

- DIRECT DRIVE CONSTRUCTION (NO BELTS/PULLEYS). - ROOF MOUNTED FANS.
- RESTAURANT MODEL. - UL705
- VARIABLE SPEED CONTROL. INTERNAL WIRING.
- THERMAL OVERLOAD PROTECTION (SINGLE PHASE). - HIGH HEAT OPERATION 300°F (149°C).
- NEMA 3R SAFETY DISCONNECT SWITCH.

NORMAL TEMPERATURE TEST EXHAUST FAN MUST OPERATE CONTINUOUSLY WHILE EXHAUSTING AIR AT 300°F (149°C)

UNTIL ALL FAN PARTS HAVE REACHED THERMAL EQUILIBRIUM, AND WITHOUT ANY DETERIORATING EFFECTS TO THE FAN WHICH WOULD CAUSE UNSAFE OPERATION.

UPBLAST FAN WHEEL ACCESS PORT. WALLMOUNT 27.5 SQ. X 5". SHIP LOOSE DISCONNECT FOR REMOTE WALL MOUNT CONSTRUCTION 18/20 (D60 ISOLATORS), 70LB MOTOR MAX FOR WALL MOUNTING. EXHAUST FAN HEAT BAFFLE. CLASS C SPARK RESISTANT CONSTRUCTION FOR PRVS. TCW18 - TEFLON COATED WHEEL.


VAV PACKAGE W/PRESET OR REFERENCE

SPEEDS (VFD INCLUDED).

VFD FACTORY MOUNTED AND WIRED IN EXHAUST FAN. VFD MOUNTING BRACKET FOR DU/DR 180 -

200. 2 YEAR PARTS WARRANTY.

WALL MOUNT BRACKET

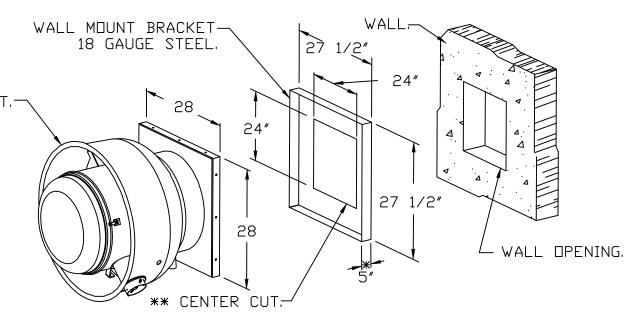

- WALL BRACKET FITS INTO BASE OF FAN. - SELF DRILLING SCREWS SHOULD BE USED

FOR UNIT ATTACHMENT TO WALL MOUNT BRACKET. * DIMENSION = 5" WHEN USED WITH DAMPER.

** CENTERED IN WALL MOUNT.

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EXHAUST AND MAKE-UP AIR FAN **DETAILS AND** SCHEDULES

21.239

JBB/JHM

WELDING SHOP

PSCA#:

DRAWN BY:


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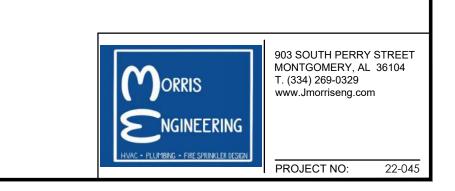
5.19.2022 REVISED DATE:

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903 SOUTH PERRY STREET MONTGOMERY, AL 36104 T. (334) 269-0329 www.Jmorriseng.com





CLAY COUNTY BOAR
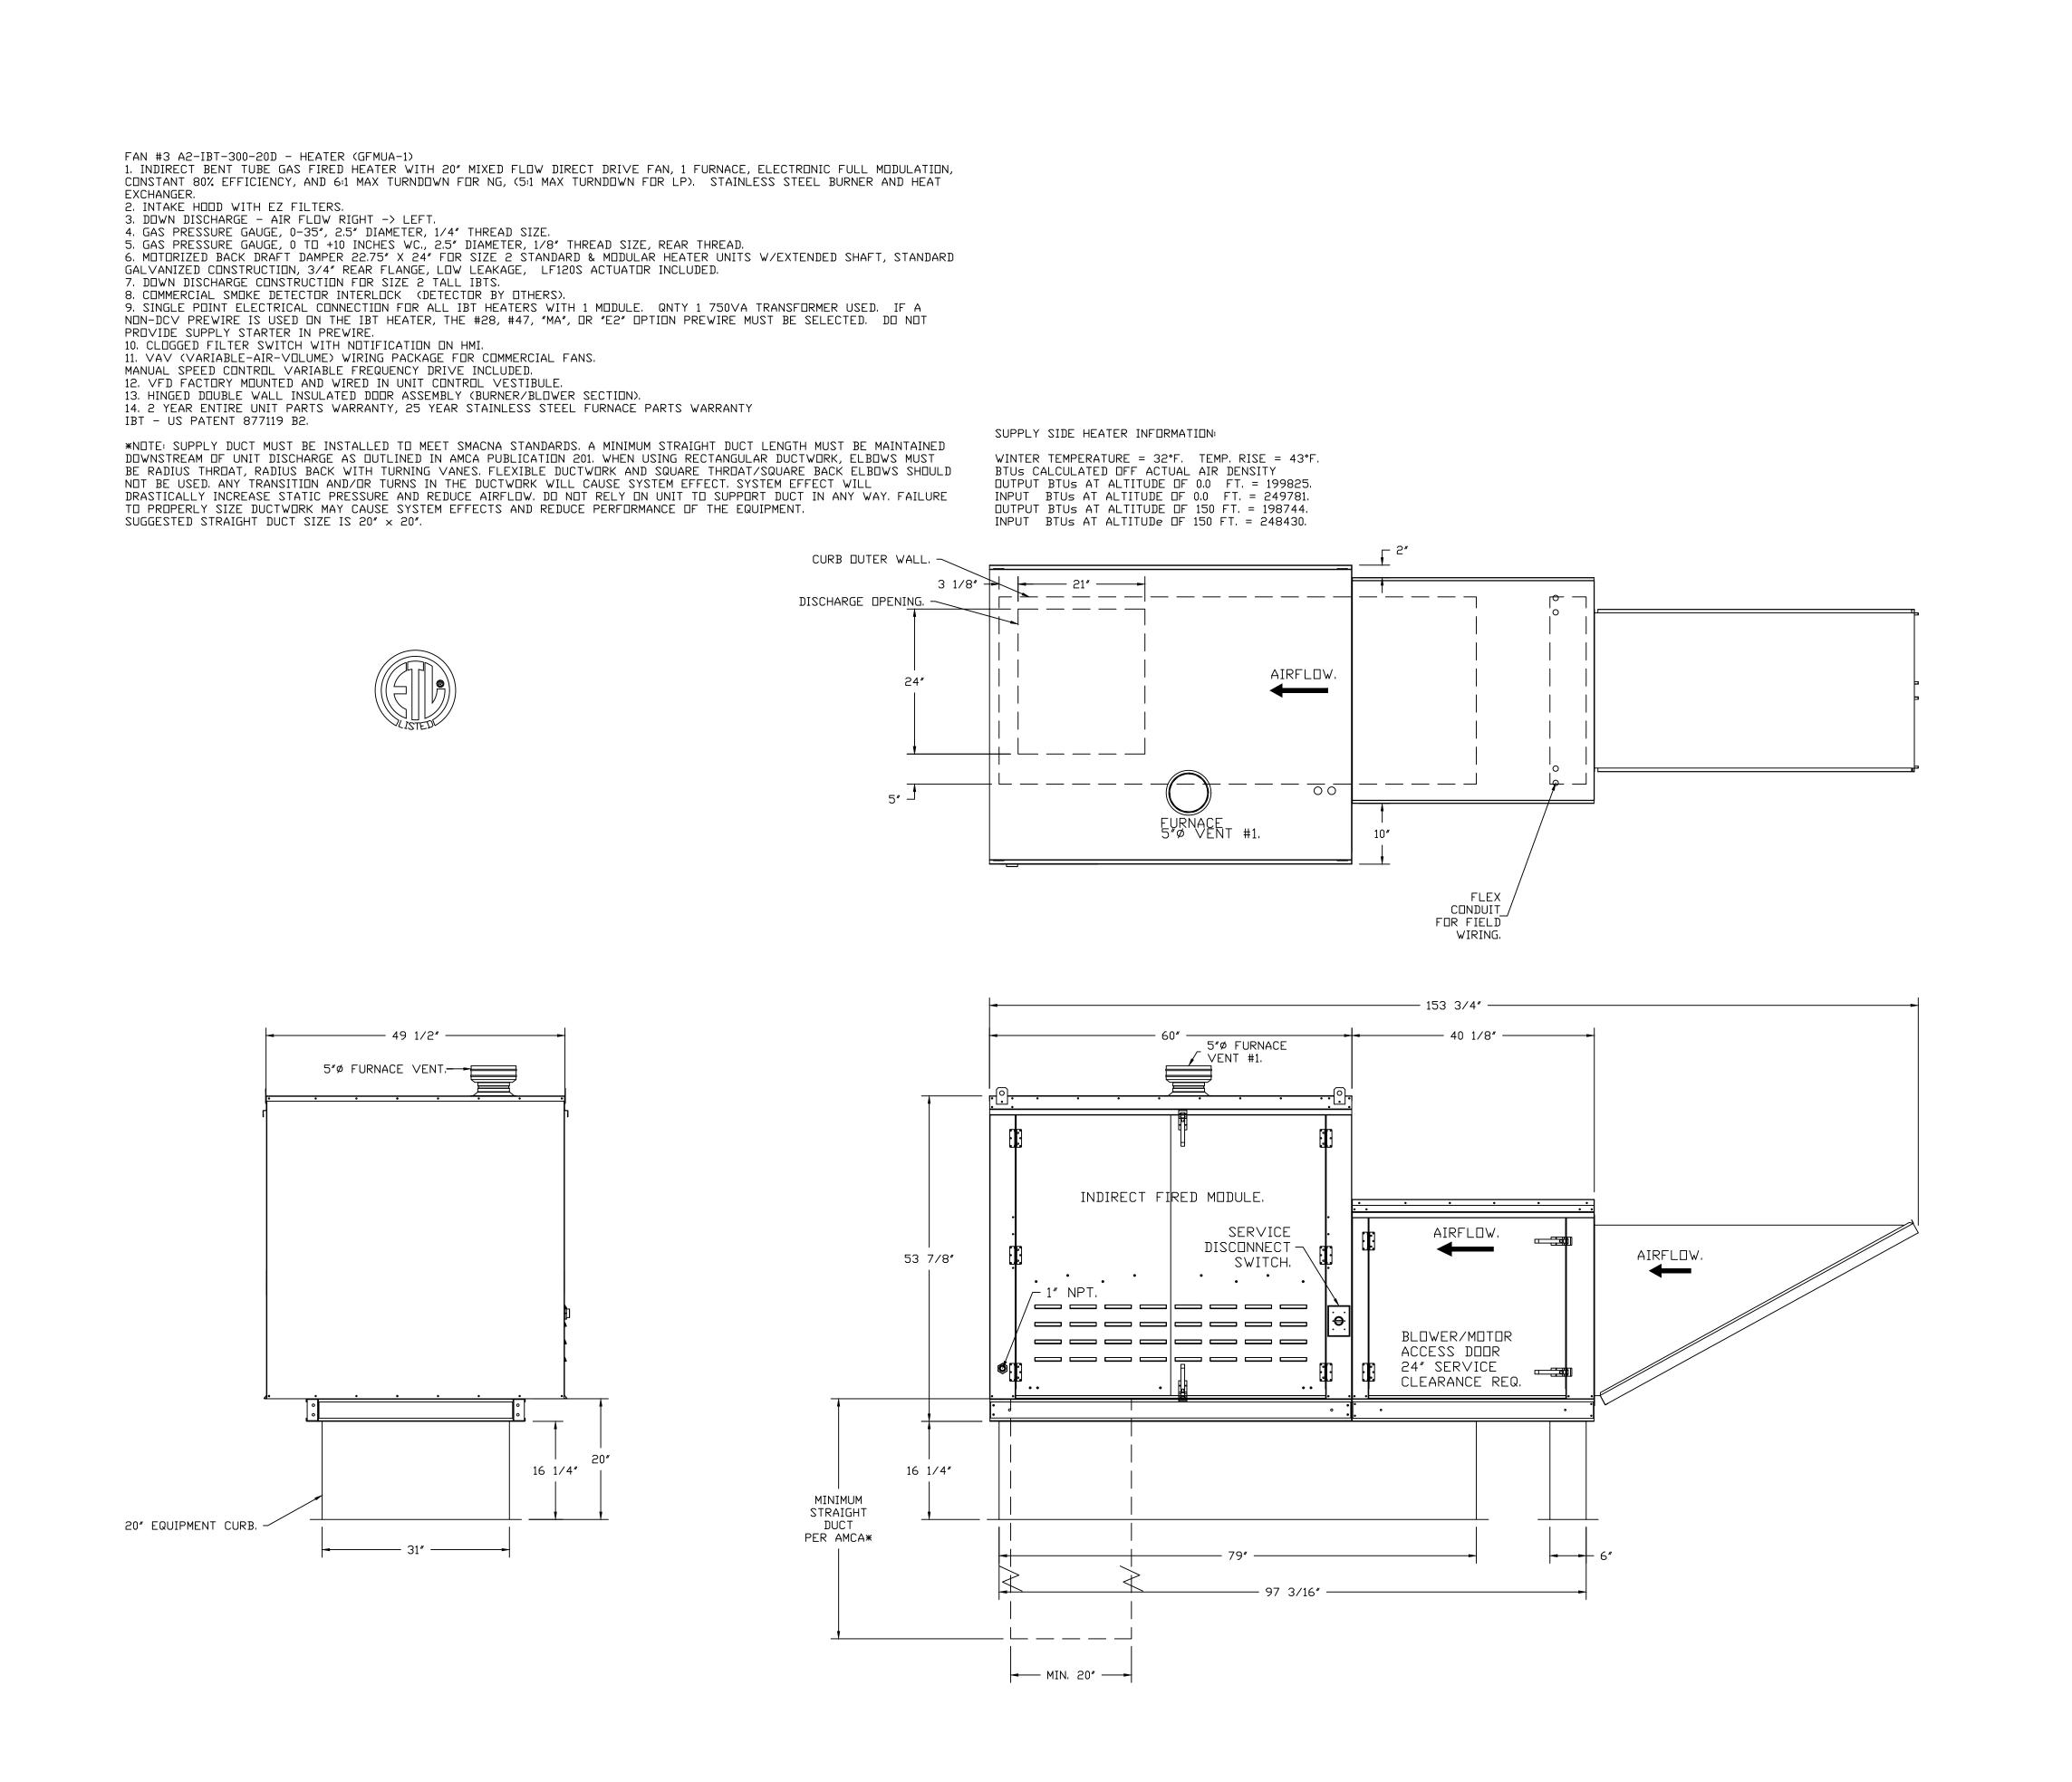
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SHEET TIT

WELDING SHOP EXHAUST AND MAKE-UP AIR FAN DETAILS AND

SCHEDULES

21.239

JBB/JHM

5.19.2022

MCKEE JOB #:


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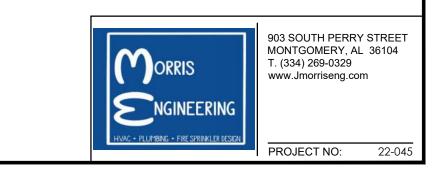
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TINDONIAN WEEL AND ASSOCIATE

SHEET TITLE

WELDING SHOP EXHAUST AND MAKE-UP AIR FAN DETAILS AND SCHEDULES 21.239

MCKEE JOB # :

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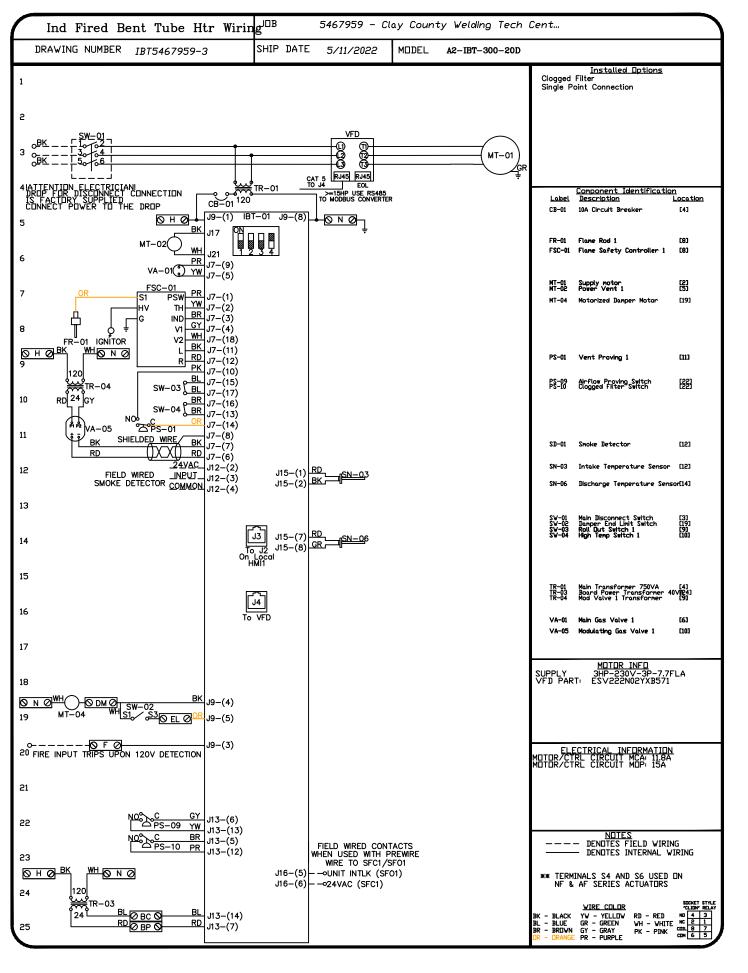
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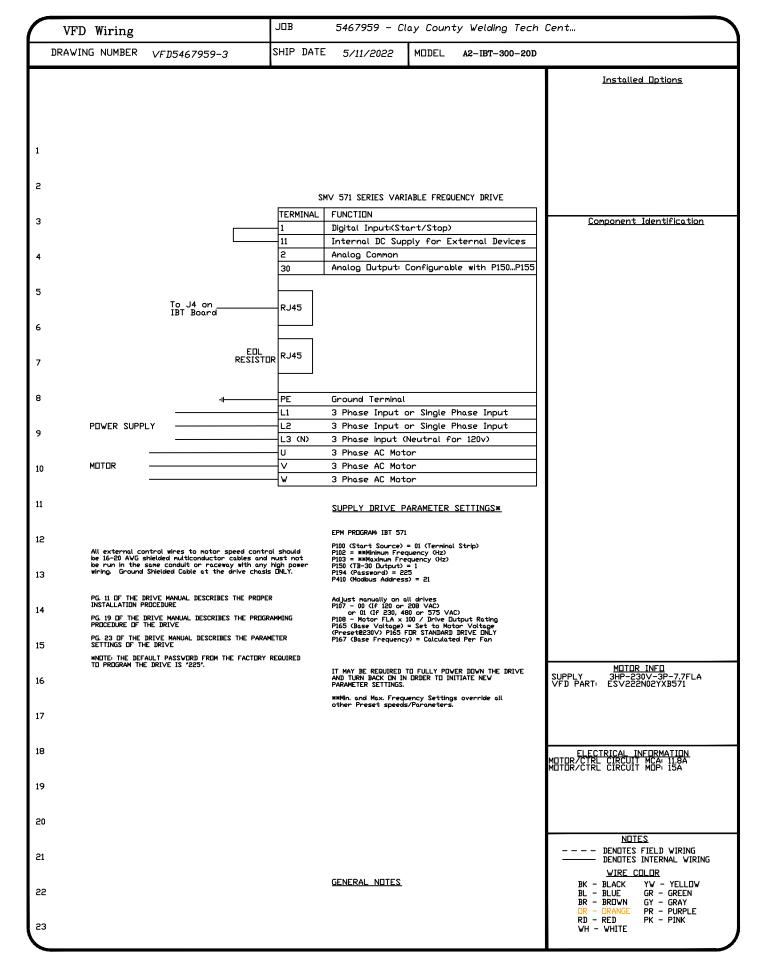
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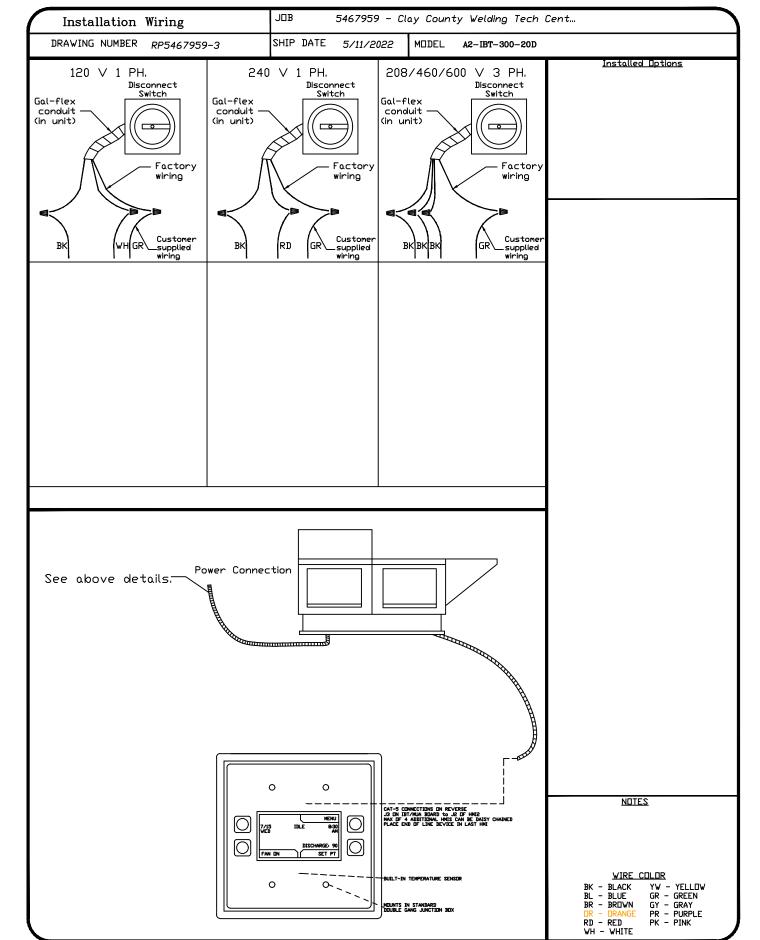
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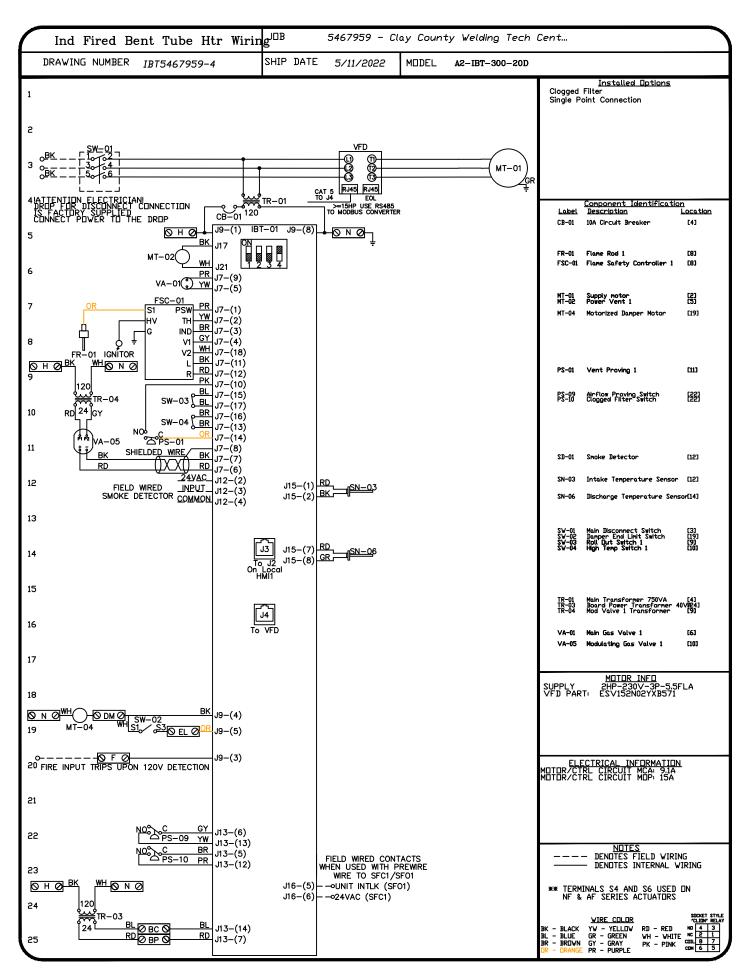
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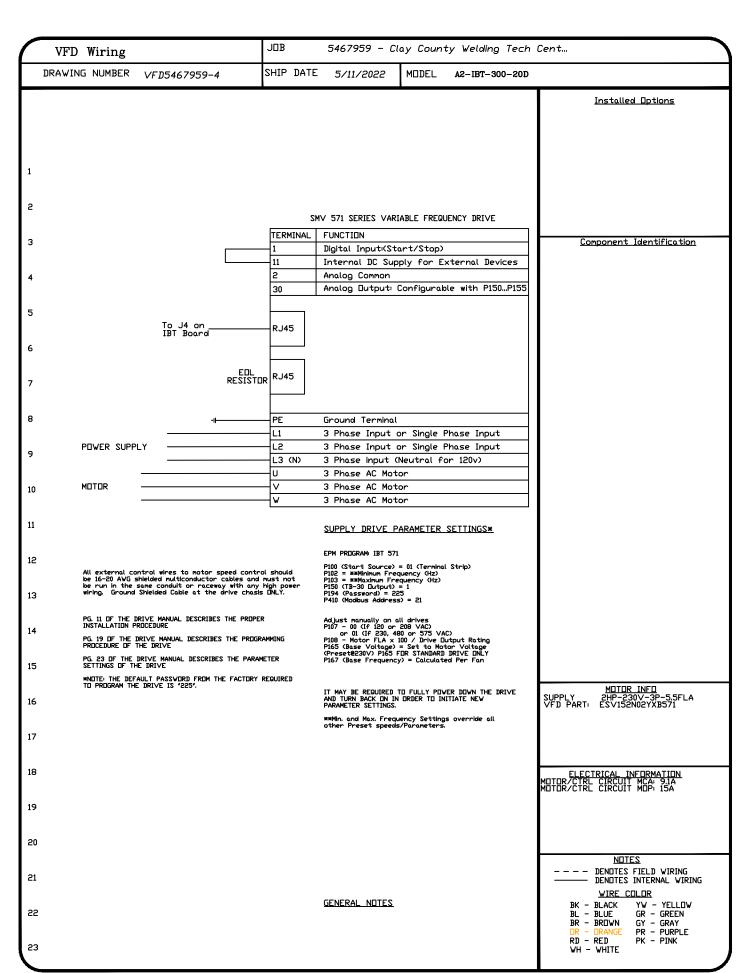
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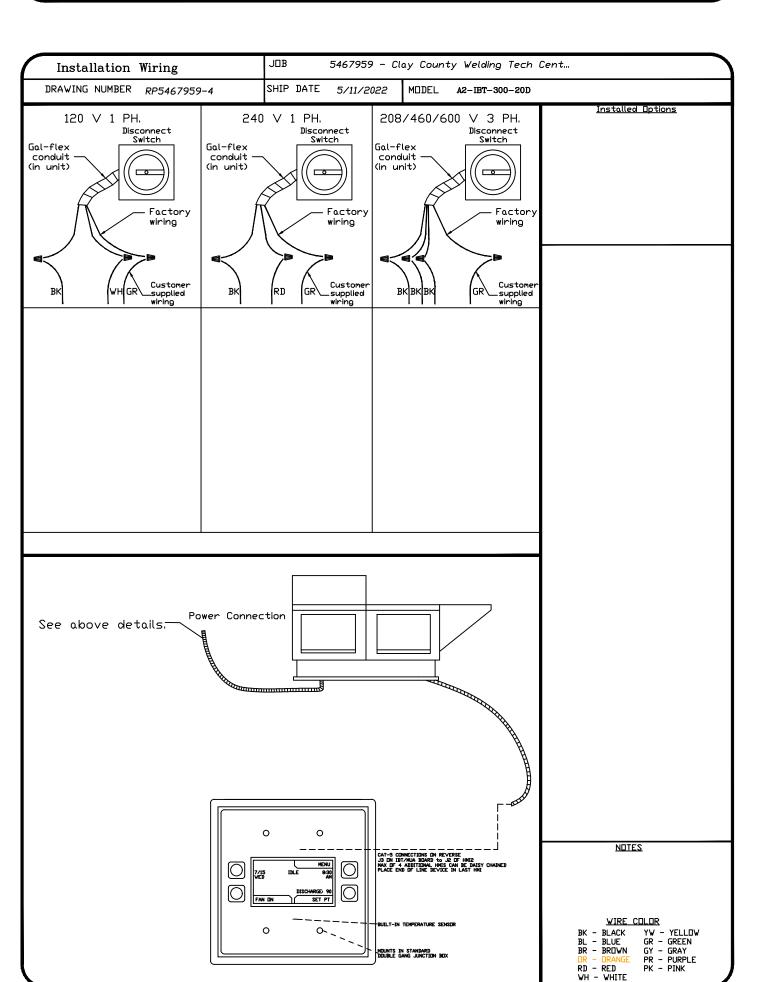


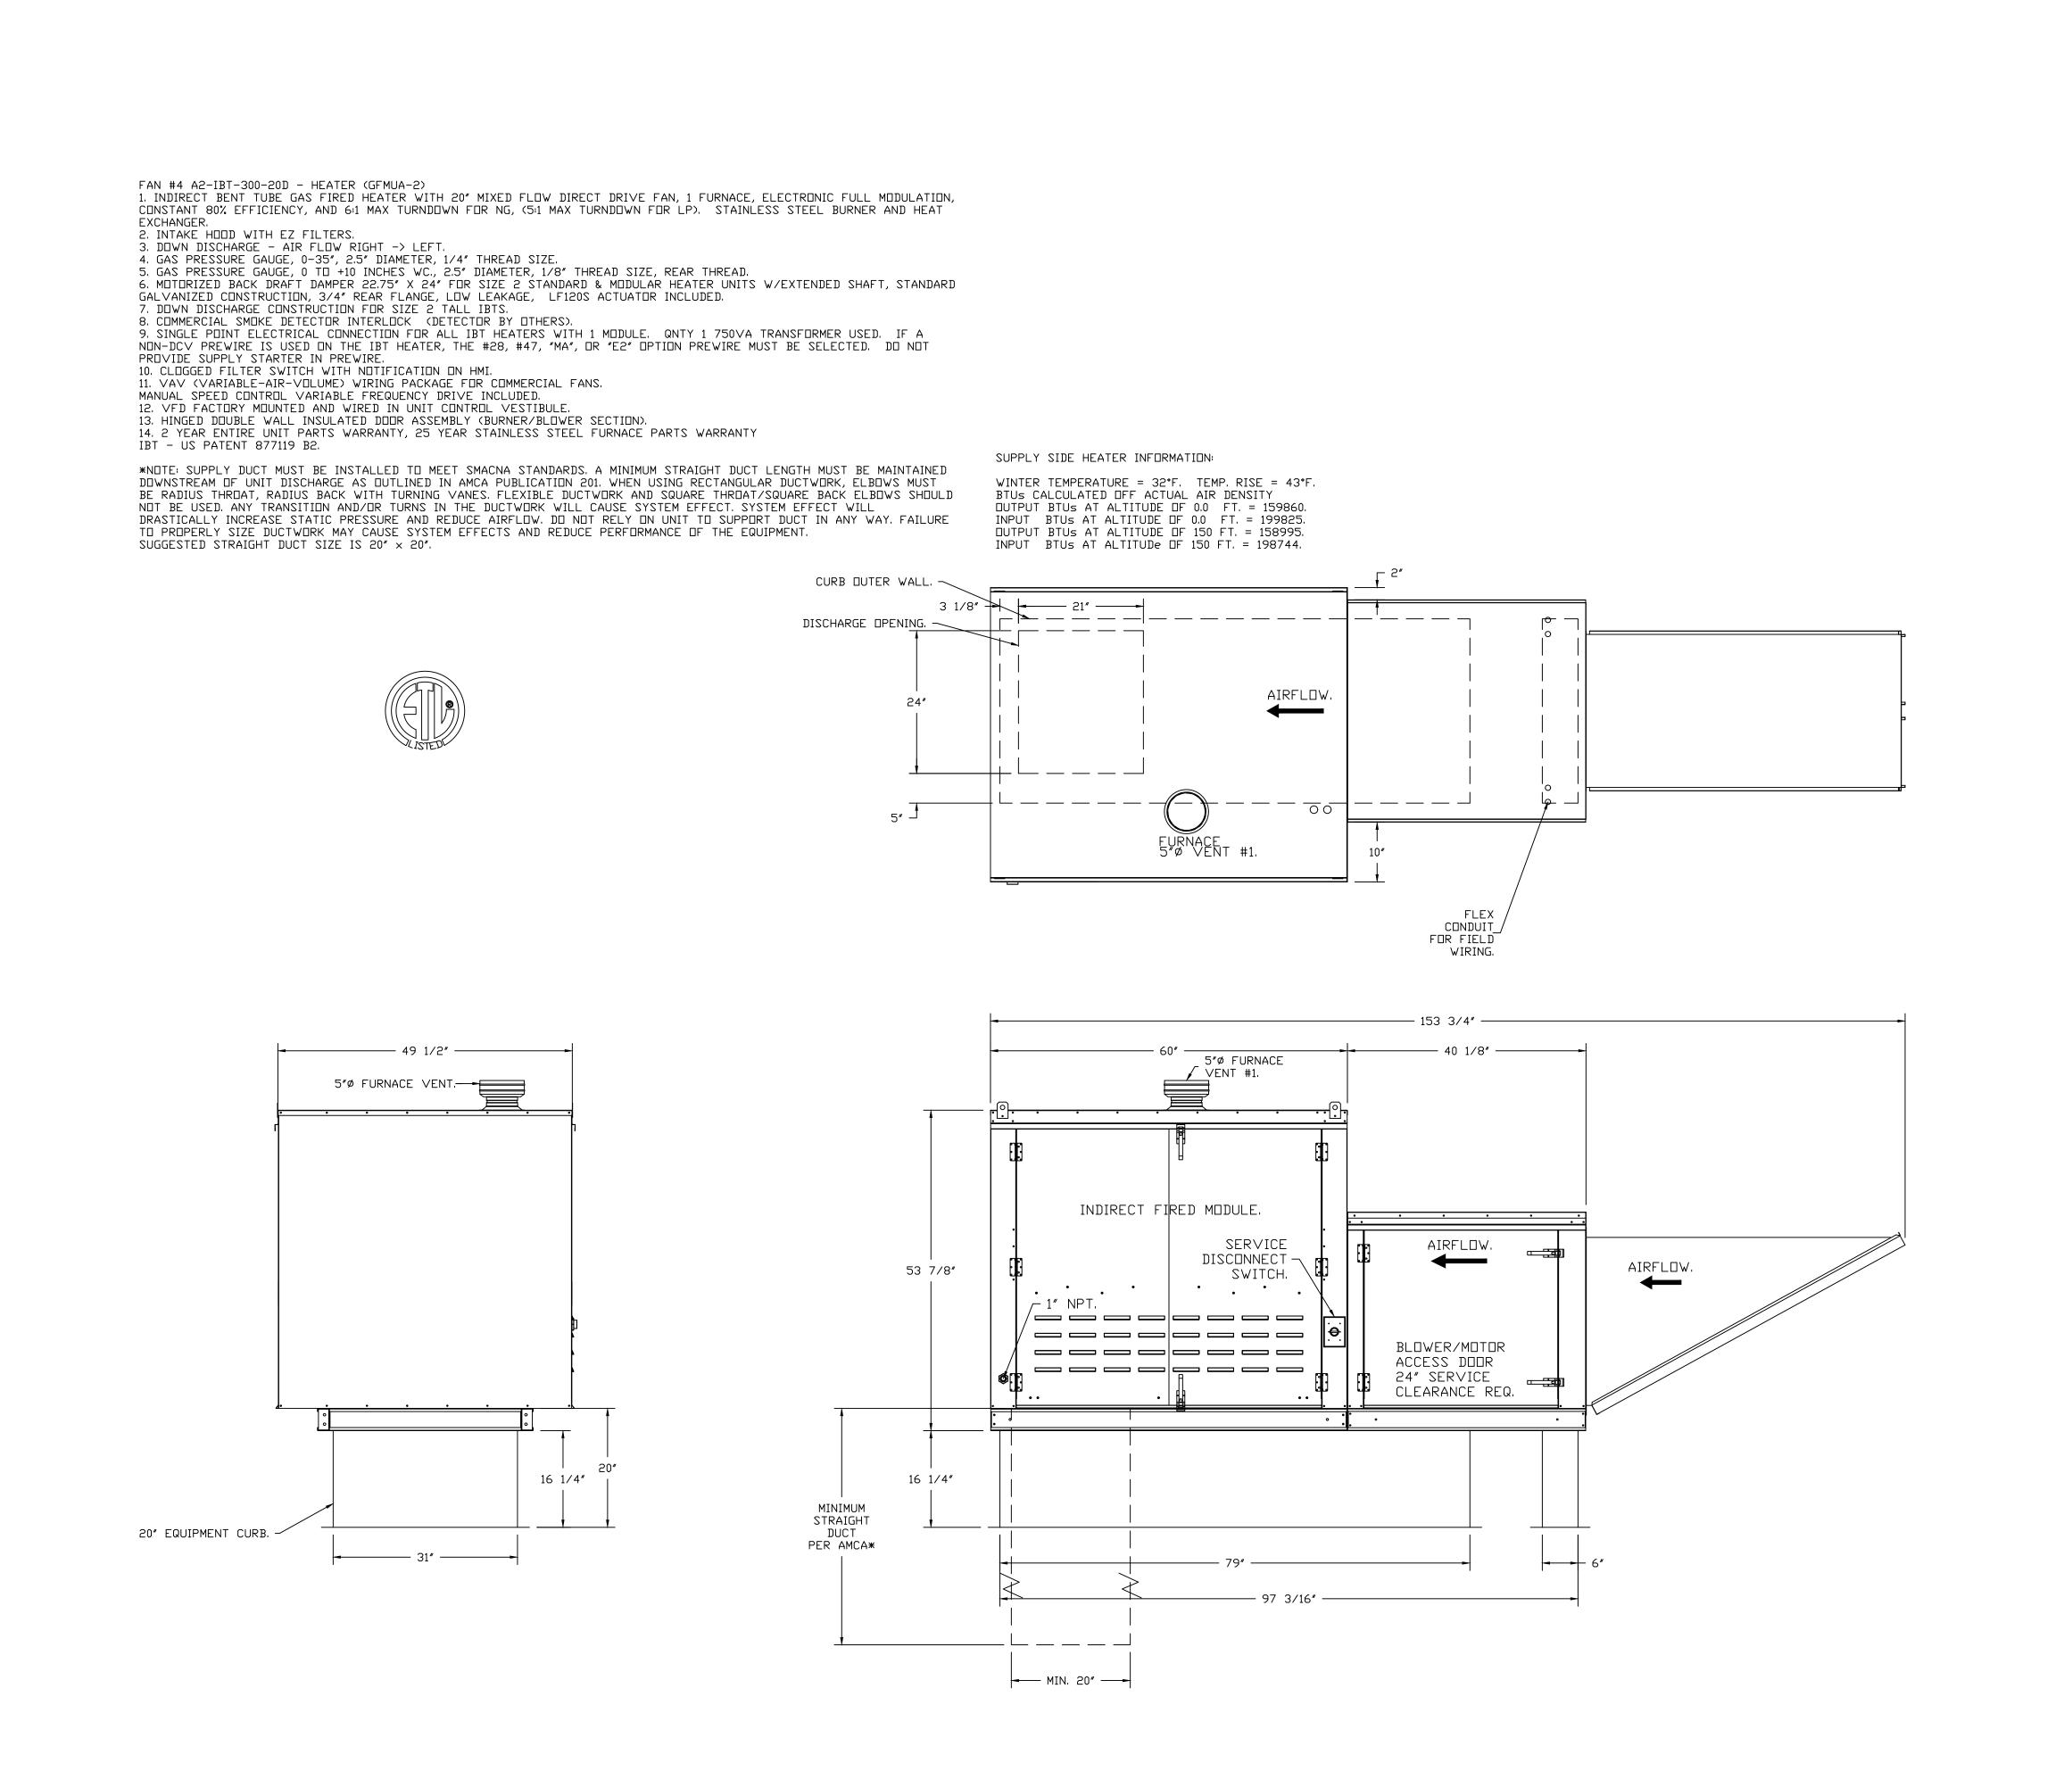









MCKEE and ASSOCIATE
ARCHITECTS, INC.

AREER ACADEMY

MCKEE JOB # :
PSCA # :

DRAWN BY: JBB/JHM

DATE: 5.19.2022

WELDING SHOP EXHAUST AND

DETAILS AND

SCHEDULES

21.239

MAKE-UP AIR FAN


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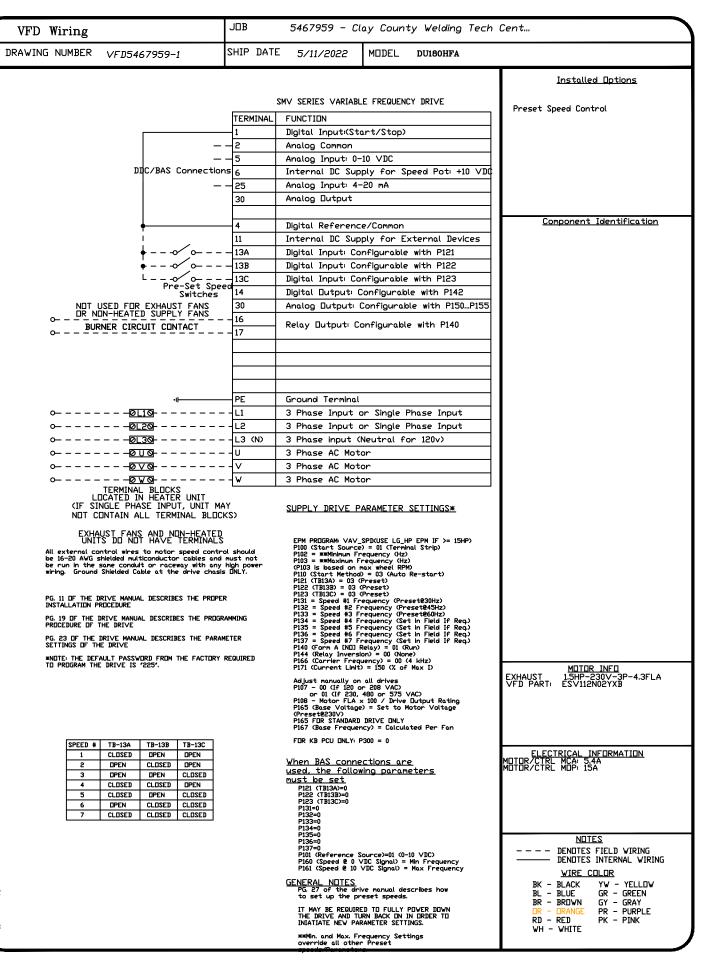
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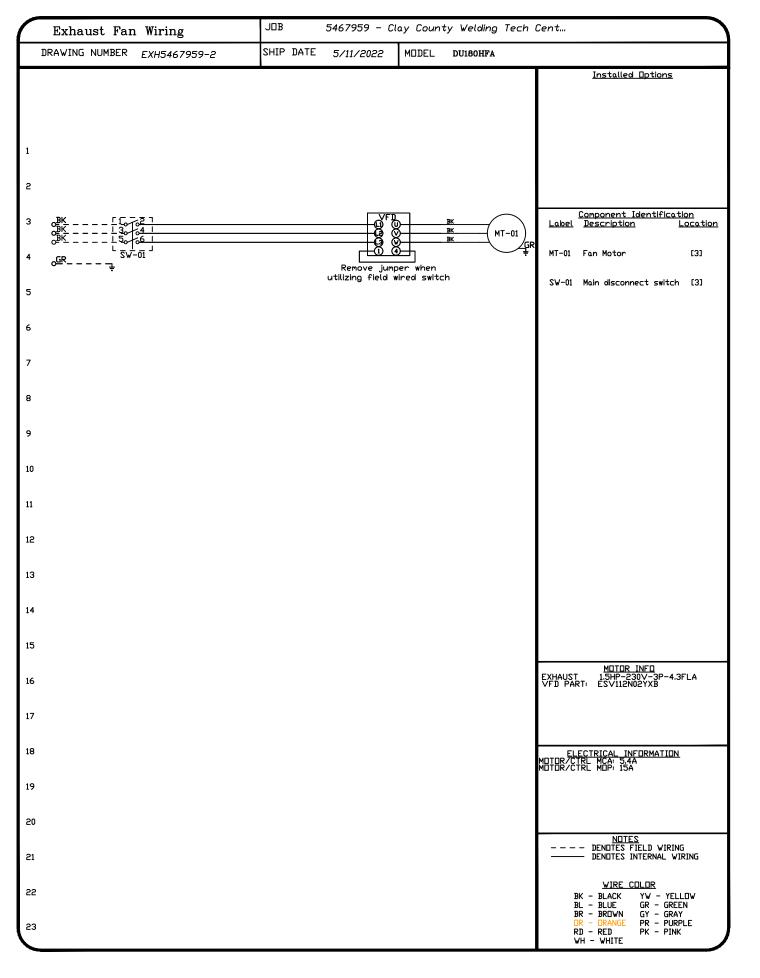
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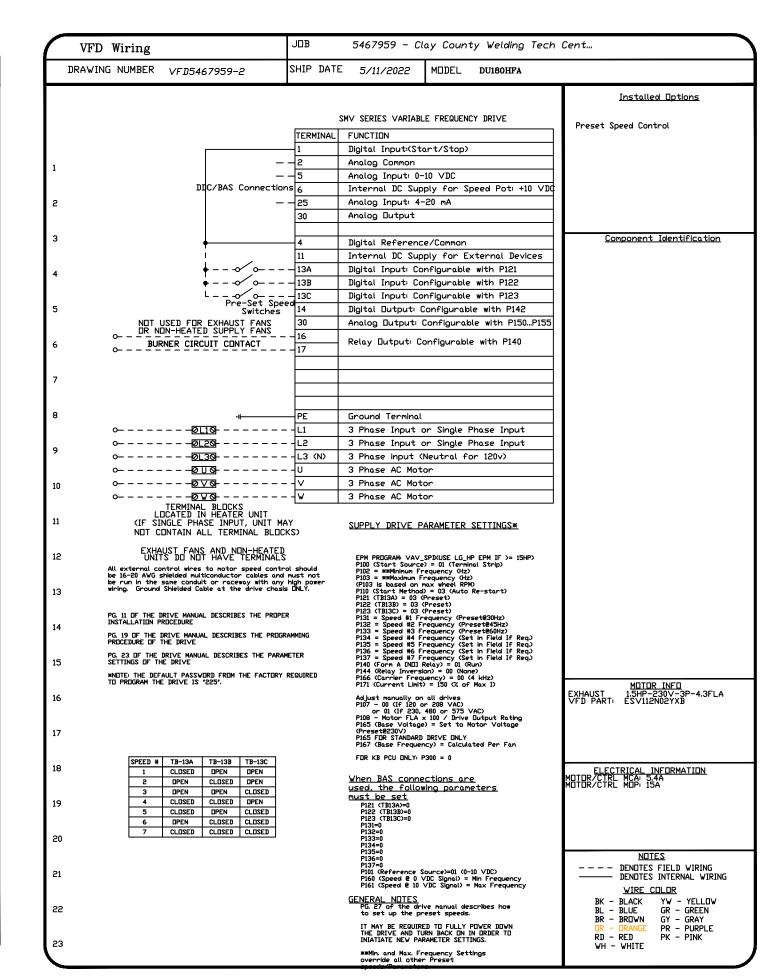
ENGINEERING

SHEET NO.: M3.4







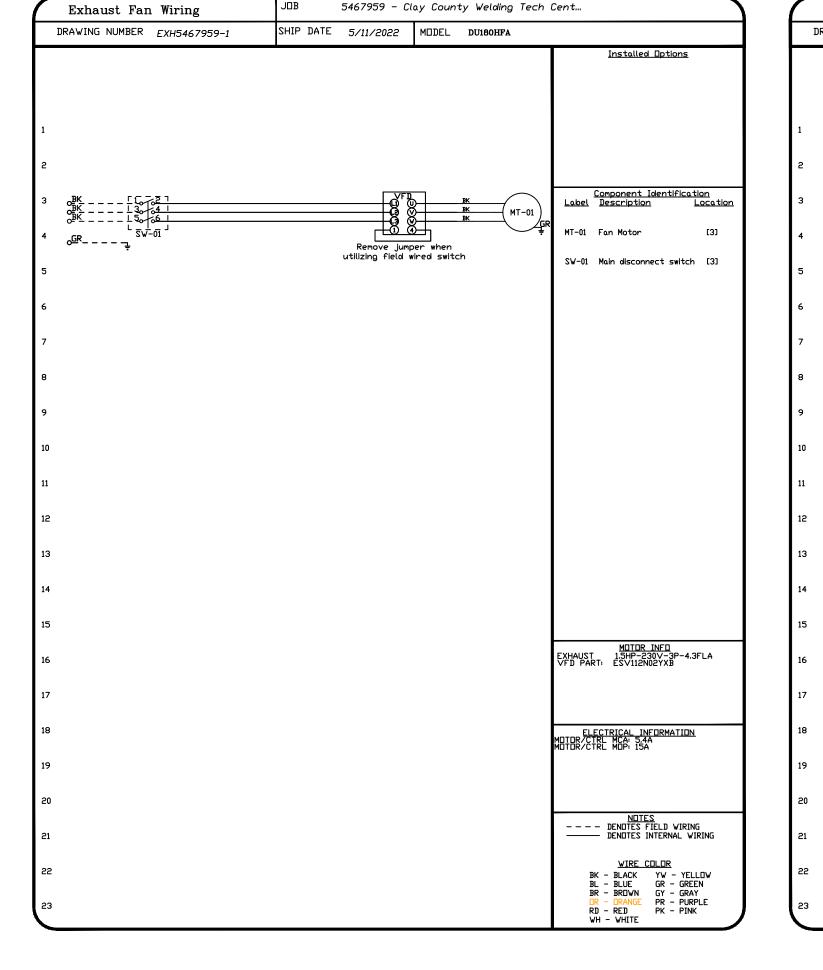

903 SOUTH PERRY STREET
MONTGOMERY, AL 36104
T. (334) 269-0329
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PROJECT NO: 22-045

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CLAY COUNTY BOARD

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SHEET TITLE :

WELDING SHOP EXHAUST AND MAKE-UP AIR FAN DETAILS AND

SCHEDULES

21.239

JBB/JHM

MCKEE JOB #:

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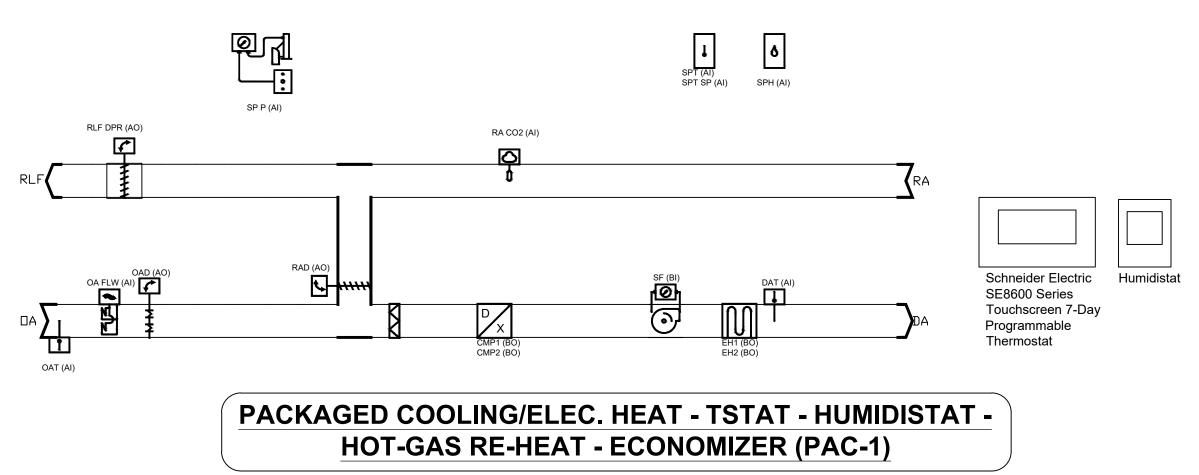
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Local Schedule:

A local schedule (7 days. 2 or 4 events) internal to the controller is used to trigger the different occupancy levels op the controller. Coordinate with the owner's representative for programing each thermostats occupied and unoccupied period(s).

Smoke Detector:

Provide a Smoke Detector in the return air ductwork before mixing with outside air ductwork. Unit shall shut-down upon smoke detector activation. Smoke Detector shall be furnished by Electrical Contractor and installed by Mechanical Contractor. Provide for units 2000 cfm or larger.

Occupied:

The DX cooling and the electric heat shall control to maintain the active discharge air temperature setpoint. If economizing is enabled, the outdoor air or mixed air dampers shall modulate to maintain the discharge air temperature setpoint and the relief air damper shall track the mixed air dampers. The discharge air temperature setpoint shall be dynamically reset based on the deviation of actual space temperature from the active space temperature setpoint. If the discharge air temperature sensor fails, the DX cooling and the electric heat shall control to maintain the active space temperature setpoint. If the discharge air temperature sensor and the space temperature sensor fail, the DX cooling and electric heat shall be disabled.

Optimal Start:

The t-stat shall monitor the scheduled occupied time, occupied space setpoints and space temperature to calculate when the optimal start occurs.

Morning Warm-Up Mode:

During optimal start, if the space temperature is below the occupied heating setpoint a morning warm-up mode shall be activated. When morning warm-up is initiated the unit shall enable the heating and fan(s). The outside air damper shall remain closed. When the space temperature reaches the occupied heating setpoint (adj.), the unit shall transition to the occupied mode.

Pre-Cool Mode:

During optimal start, if the space temperature is above the occupied cooling setpoint, pre-cool mode shall be activated. When pre-cool is initiated the unit shall enable the fan and cooling or economizer. The outside air damper shall remain closed, unless economizing. When the space temperature reaches occupied cooling setpoint (adj.), the unit shall transition to the occupied mode.

Optimal Stop:

The t-stat shall monitor the scheduled unoccupied time, occupied setpoints and space temperature to calculate when the optimal stop occurs. When the optimal stop mode is active the unit controller shall maintain the space temperature to the space temperature offset setpoint. Outside air damper shall remain enabled to provide minimum ventilation.

Occupied Bypass:

The t-stat shall monitor the status of the ON and CANCEL buttons of the space temperature sensor. When an occupied bypass request is received from a space sensor, the unit shall transition from its current occupancy mode to occupied bypass mode and the unit shall maintain the space temperature to the occupied setpoints

Heat/Cool Mode:

When the space temperature rises above the occupied cooling setpoint the mode shall transition to cooling. When the space temperature falls below the occupied heating setpoint the mode shall transition to heating. When the space temperature is above the occupied cooling setpoint or below the occupied heating setpoint the mode shall remain in its last state. If the space temperature sensor fails the mode shall remain in its last state. If the local and communicated setpoints fail the controller shall disable the supply fan.

The unit shall be in dehumidification mode if the return air humidity is above the dehumidification setpoint. In the dehumidification mode, the supply air fan shall be enabled, the outside air damper shall be commanded to minimum position, and the unit controller shall energize mechanical cooling and the reheat solenoid.

SINGLE CURCUIT UNITS: During dehumidification mode, cooling capacity shall be dictated by the reheat capacity control.

MULTI-CIRCUIT UNITS: During dehumidification mode the outside air temperature shall be monitored. If this temperature rises above the reheat capacity limit setpoint, or falls below the reheat capacity limit setpoint – 3.0 deg. F, the unit shall stage down or stage up the compressors respectively to meet full or part load capacity requirements based on ambient temperature. Factory installed hot gas reheat shall allow application of dehumidification. Dehumidification shall be allowed only when the outside air temperature is above 40.0 deg. F and below 100.0 deg. F. The economizer outside air damper shall drive to minimum position during dehumidification.

SINGLE COMPRESSOR UNITS: On a call for dehumidification, the reheat valve shall energize and the compressor shall enable. When the humidity control setpoint is satisfied, the valve shall be de-energized and the compressor shall be disabled. If there is a call for cooling from the space temperature controller, while in reheat, the reheat valve shall be de-energized and the compressor continues to run.

DUAL COMPRESSOR UNITS: On a call for dehumidification, the reheat valve shall energize and both compressors shall enable. When the humidity control setpoint is satisfied, the valve shall be de-energized and both compressors shall be disabled. If there is a call for 1st stage cooling while in the dehumidification mode, no action shall take place. If there is a call for 2nd stage cooling, the reheat valve shall be de-energized, and the unit shall revert to the cooling mode. If 2nd stage cooling is satisfied and there is still a call for dehumidification, the reheat valve shall once again be energized.

Economizer:

ENABLE (Reference Dry Bulb): Outside air (OA) temperature shall be compared with a reference dry bulb setpoint. The economizer shall enable when the OA temperature is less than reference dry bulb setpoint. The economizer shall be disabled when OA temperature is greater than reference dry bulb setpoint + 2.0 deg.

OPERATION: The unit shall measure the dry bulb supply air temperature and dry bulb outdoor air temperature and economizer shall be enabled when the outdoor air temperature is below the dry bulb change over setpoint. When economizing is enabled and the unit is operating in the cooling mode, the economizer damper shall be modulated between its minimum position and 100% to maintain the discharge air temperature setpoint. The economizer damper shall modulate toward minimum position in the event the discharge air temperature falls below the discharge low limit temperature setpoint. Compressors shall be delayed from operating until the economizer has opened to 100%.

Ventilation Control:


When the space CO2 level is greater than or equal to the Design Minimum CO2 Setpoint, the outdoor air damper shall open to the Design Minimum Outdoor Air Damper Setpoint. When the space CO2 level is less than or equal to the DCV Minimum CO2 Setpoint, the outdoor air damper shall close to the DCV Minimum Outdoor Air Damper Setpoint. If there is a call for economizer cooling, the damper shall be opened further to satisfy the cooling request.

Supply Fan:

The supply fan shall be enabled while in the occupied mode and cycled on during the unoccupied mode.

Relief Air and Building Pressure Control:

A differential pressure transducer shall actively monitor the difference in pressure between the building (indoors) and outdoors. If the building pressure increases above the desired setpoint, the associated controller shall modulate the relief air damper to control building pressure at setpoint. If the building pressure decreases below the desired setpoint, the associated controller shall close the relief air damper.

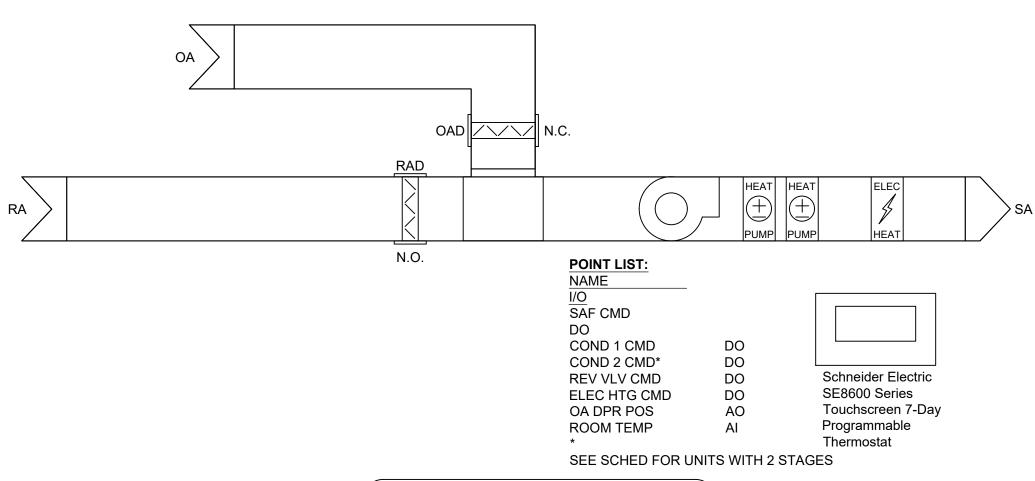


HP - TSTAT (IHP-1,2,4,6)

SEQUENCE OF OPERATION - SINGLE-ZONE CONSTANT-VOLUME HEAT PUMP EACH HEAT PUMP UNIT IS A SINGLE-ZONE, CONSTANT AIR VOLUME SYSTEM WITH A MODULATING OUTSIDE AIR DAMPER, CONSTANT-SPEED SUPPLY AIR FAN, HEAT PUMP AND A STANDALONE TOUCH-SCREEN 7-DAY PROGRAMMABLE THERMOSTAT WITH BUILT-IN HUMIDITY SENSOR.

- A LOCAL SCHEDULE (7 DAYS, 2 OR 4 EVENTS) INTERNAL TO THE CONTROLLER IS USED TO TRIGGER THE DIFFERENT OCCUPANCY LEVELS OP THE CONTROLLER. COORDINATE WITH THE OWNER'S REPRESENTATIVE FOR PROGRAMING EACH THERMOSTATS OCCUPIED AND UNOCCUPIED PERIOD(S).
- THE OCCUPIED COOLING AND HEATING SET-POINTS ARE USED (COOLING: 75 °F; HEATING: 68 °F). THE OCCUPIED SPACE TEMPERATURES SET-POINTS FOR THE UNITS WILL BE ADJUSTABLE (+/-3°F) AT THE LOCAL THERMOSTAT.
- UNOCCUPIED MODE: DURING UNOCCUPIED PERIODS, THE UNOCCUPIED HEATING & COOLING SET-POINTS ARE USED. (COOING: 65 7; HEATING: 55 7)
- THE UNOCCUPIED SPACE TEMPERATURES SET-POINTS FOR THE UNITS WILL BE ADJUSTABLE AT THE LOCAL THERMOSTAT.
- THE CONTROLLER WILL REVERT BACK TO THE OCCUPIED MODE AS SPECIFIED BY A CONFIGURATION TIMER WHEN A LOCAL OVER-RIDE IS REQUESTS AT THE CONTROLLER
- THE SUPPLY FAN CAN BE SET TO EITHER AUTOMATIC ON DEMAND) OR ALWAYS ON. THE SUPPLY FAN SHALL RUN CONTINUOUSLY DURING OCCUPIED PERIODS. DURING UNOCCUPIED PERIODS, FAN SHALL CYCLE ON A CALL FOR EITHER HEATING OR COOLING ON A CALL FOR COOLING:
- THE REVERSING VALVE WILL INDEX FOR COOLING AND THE COMPRESSOR WILL OPERATE ACCORDING TO DEMAND.
- ON A CALL FOR HEATING:
- THE REVERSING VALVE WILL INDEX FOR HEATING AND THE COMPRESSOR WILL OPERATE ACCORDING TO DEMAND. ELECTRIC HEATING WILL OPERATE AS A SECOND STAGE. DEHUMIDIFICATION IS NOT AUTHORIZED DURING HEATING OPERATION.

OUTSIDE AIR DAMPER • DURING OCCUPIED PERIODS, OUTSIDE AIR DAMPER SHALL OPEN.

- OUTSIDE AIR DAMPER SHALL BE SET BY TEST & BALANCE CONTRACTOR TO ACHIEVE SCHEDULED OUTSIDE AIR CFM.
- UPON SHUTDOWN OR DURING ALL UNOCCUPED PERIODS, OUTSIDE AR DAMPER SHALL CLOSE.

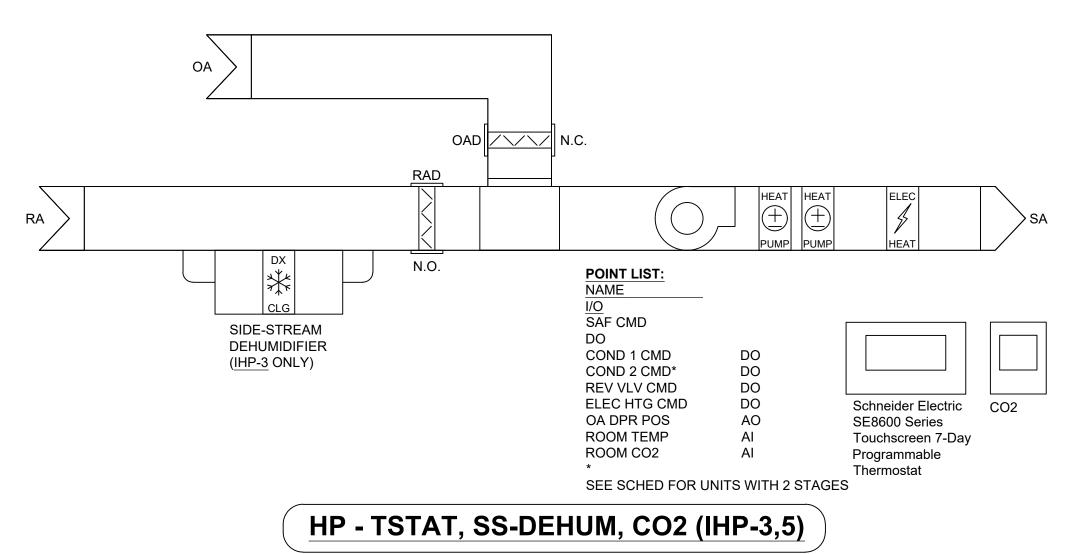

SEQUENCE OF OPERATION - SINGLE-ZONE CONSTANT-VOLUME HEAT PUMP WITH CO2


EACH HEAT PUMP UNIT IS A SINGLE-ZONE, CONSTANT AIR VOLUME SYSTEM WITH A MODULATING OUTSIDE AIR DAMPER, CONSTANT-SPEED SUPPLY AIR FAN, HEAT PUMP AND A STANDALONE TOUCH-SCREEN 7-DAY PROGRAMMABLE THERMOSTAT WITH BUILT-IN HUMIDITY AND CO2 SENSORS.

- A LOCAL SCHEDULE (7 DAYS. 2 OR 4 EVENTS) INTERNAL TO THE CONTROLLER IS USED TO TRIGGER THE DIFFERENT OCCUPANCY LEVELS OP THE CONTROLLER. COORDINATE WITH THE OWNER'S REPRESENTATIVE FOR PROGRAMING EACH THERMOSTATS OCCUPIED AND UNOCCUPIED PERIOD(S).
- THE OCCUPIED COOLING AND HEATING SET-POINTS ARE USED (COOLING: 75 °F; HEATING: 68 °F). THE OCCUPIED SPACE TEMPERATURES SET-POINTS FOR THE UNITS WILL BE ADJUSTABLE (+/-3°F) AT THE LOCAL THERMOSTAT
- UNOCCUPIED MODE: DURING UNOCCUPIED PERIODS, THE UNOCCUPIED HEATING & COOLING SET-POINTS ARE USED. (COOING: 65 7; HEATING: 55 7).
- THE UNOCCUPIED SPACE TEMPERATURES SET-POINTS FOR THE UNITS WILL BE ADJUSTABLE AT THE LOCAL THERMOSTAT. LOCAL OVERIDE:

ON A CALL FOR HEATING:

- THE CONTROLLER WILL REVERT BACK TO THE OCCUPIED MODE AS SPECIFIED BY A CONFIGURATION TIMER WHEN A LOCAL OVERIDE IS REQUESTS AT THE CONTROLLER.
- THE SUPPLY FAN CAN BE SET TO EITHER AUTOMATIC ON DEMAND) OR ALWAYS ON. THE SUPPLY FAN SHALL RUN CONTINUOUSLY DURING OCCUPIED PERIODS. DURING UNOCCUPIED PERIODS, FAN SHALL CYCLE ON A CALL FOR EITHER HEATING OR COOLING.
- ON A CALL FOR COOLING: THE REVERSING VALVE WILL INDEX FOR COOLING AND THE COMPRESSOR WILL OPERATE ACCORDING TO DEMAND.
- THE REVERSING VALVE WILL INDEX FOR HEATING AND THE COMPRESSOR WILL OPERATE ACCORDING TO DEMAND. ELECTRIC HEATING WILL OPERATE AS A SECOND STAGE. DEHUMIDIFICATION IS NOT AUTHORIZED DURING HEATING OPERATION.
- **OUTSIDE AIR DAMPER** DURING OCCUPIED PERIODS, OUTSIDE AIR DAMPER SHALL OPEN.
- OUTSIDE AIR DAMPER SHALL BE SET BY TEST & BALANCE CONTRACTOR TO ACHIEVE SCHEDULED OUTSIDE AIR CFM.
- UPON SHUTDOWN OR DURING ALL UN-OCCUPIED PERIODS, OUTSIDE AR DAMPER SHALL CLOSE. CO2 CONTROL
- UPON A RISE IN SPACE CO2 LEVELS ABOVE SET-POINT THE OUTSIDE AIR DAMPER SHALL BE COMMANDED FULLY OPEN OUTSIDE AIR DAMPER SHALL REVERT BACK TO MINIMUM POSITION AFTER SPACE CO2 LEVELS HAVE BEEN AT SAFE LEVELS FOR 5MIN
- ON A DEMAND FOR DEHUMIDIFICATION (IHP-3 ONLY):
- DEHUMIDIFICATION IS ACHIEVED VIA A SIDE-STREAM DEHUMIDIFIER IN THE RETURN AIR DUCT.
- DEHUMIDIFIER IS ENABLED IF THE SPACE RELATIVE HUMIDITY EXCEEDS SET-POINT.
- DEHUMIDIFIER IS DISABLED ONCE THE SPACE RELATIVE HUMIDITY HAS BEEN BELOW MAXIMUM SETPOINT FOR 5MIN OR IS BELOW MINIMUM SETPOINT.
- DEHUMIDIFICATION IS DISABLED IF THE ROOM TEMPERATURE FALLS BELOW THE ROOM LOW-AMBIENT DEHUMIDIFICATION TEMPERATURE (37 BELOW HEATING SETPOINT).



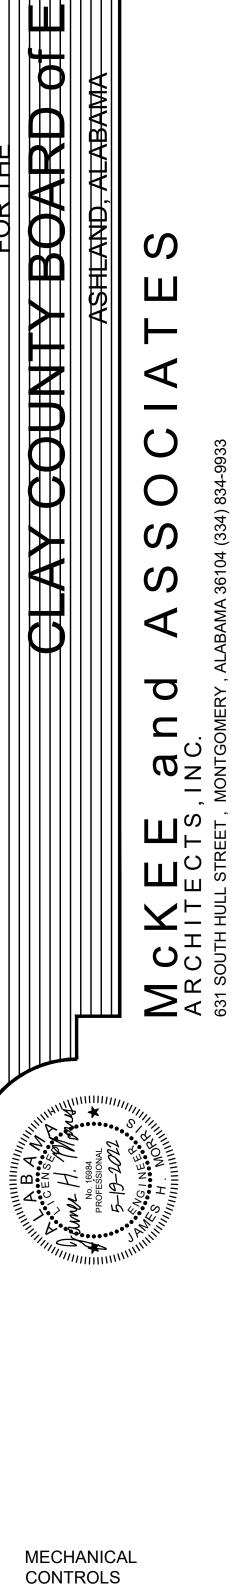

SHEET TITLE:

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21.239

JBB/JHM

5.19.2022

CEILING OUTLETS

RECESSED 2' X 4' LED FIXTURE MARK "A" CIRCUIT No. 2 TYPICAL

RECESSED 2' X 4' LED FIXTURE MARK "A" CIRCUIT No. 2 TYPICAL "EMERGENCY POWER"

A 2 RECESSED 1' X 4' LED FIXTURE MARK "A" CIRCUIT No. 2 TYPICAL

A 2 RECESSED 1' X 4' LED FIXTURE MARK "A" CIRCUIT No. 2 TYPICAL "EMERGENCY POWER"

RECESSED 2' X 2' LED FIXTURE MARK "A" CIRCUIT No. 2 TYPICAL

RECESSED 2' X 2' LED FIXTURE MARK "A" CIRCUIT No. 2 TYPICAL "EMERGENCY POWER" FS - SURFACE OR PENDANT MOUNTED LED STRIP FIXTURE MARK "FS" CIRCUIT No. 2 TYPICAL

SURFACE OR PENDANT MOUNTED LED STRIP FIXTURE MARK "FS" CIRCUIT No. 2 TYPICAL

"EMERGENCY POWER"

RECESSED OR SURFACE MOUNT DOWNLIGHT

RECESSED OR SURFACE MOUNT DOWNLIGHT "EMERGENCY POWER"

SURFACE OR PENDANT MOUNTED ROUND FIXTURE

JUNCTION BOX

EF EXHAUST FAN

DUPLEX RECEPTACLE - 20 AMP, 125 VOLT, 2 POLE, 3 WIRE GROUNDED TYPE, NEMA 5-20R. MOUNT IN CEILING. UNLESS NOTED OTHERWISE UPPER RECEPTACLE NON CONTROLLED/LOWER RECEPTACLE CONTROLLED BY ROOM AUTOMATION SYSTEM. CONTROLLED RECEPTACLE SHALL BE MARKED WITH THE SYMBOL SHOWN IN NEC FIGURE 406.3 (E) AND LOCATED ON THE CONTROLLED RECEPTACLE OUTLET WHERE VISIBLE AFTER INSTALLATION.

DUPLEX RECEPTACLE - 20 AMP, 125 VOLT, GFI, 2 POLE, 3 WIRE GROUNDED TYPE NEMA 5-20R. CEILING MOUNTED.

WALL OUTLETS

WALL MOUNTED OCCUPANCY SENSOR WITH WIRE GUARD

GYM HUBBELL NO. LO-IR-WV

ALL 120V RECEPTACLES ON THIS PROJECT SHALL BE TAMPER PROOF TYPE PER THE NATIONAL ELECTRIC CODE

⊢⊗ WALL MOUNTED COMBO EXIT LIGHT/EMERGENCY

₩ WALL MOUNTED LIGHTING FIXTURE

₩ALL MOUNTED LIGHTING FIXTURE "EMERGENCY POWER"

BATTERY OPERATED EMERGENCY WALL PACK

DUPLEX RECEPTACLE - 20 AMP, 125 VOLT, 2 POLE, 3 WIRE GROUNDED TYPE, NEMA 5-20R. MOUNT 18" A.F.F. UNLESS NOTED OTHERWISE

G DUPLEX RECEPTACLE - 20 AMP, 125 VOLT, GFI, 2 POLE, 3 WIRE GROUNDED TYPE, NEMA 5-20R. MOUNT 18" A.F.F. UNLESS NOTED OTHERWISE

DUPLEX RECEPTACLE - 20 AMP, 125 VOLT, GFI, 2 POLE, 3 WIRE GROUNDED TYPE, NEMA ₩ 5-20R. MOUNT 18" A.F.F. UNLESS NOTED OTHERWISE; PROVIDE WEATHERPROOF BOX FOR

DUPLEX RECEPTACLE - 20 AMP, 125 VOLT, 2 POLE, 3 WIRE GROUNDED TYPE, NEMA 5-20R.

DUPLEX RECEPTACLE - 20 AMP, 125 VOLT, GFI, 2 POLE, 3 WIRE GROUNDED TYPE, NEMA 5-20R. MOUNT 6" ABOVE COUNTER

QUADRAPLEX RECEPTACLE - 20 AMP, 125 VOLT, GFI, 2 POLE, 3 WIRE GROUNDED TYPE, NEMA 5-20R. MOUNT 18" A.F.F. UNLESS NOTED OTHERWISE QUADRAPLEX RECEPTACLE - 20 AMP, 125 VOLT, 2 POLE, 3 WIRE GROUNDED TYPE, NEMA

5-20R. MOUNT 18" A.F.F. UNLESS NOTED OTHERWISE

QUADRAPLEX RECEPTACLE - 20 AMP, 125 VOLT, 2 POLE, 3 WIRE GROUNDED TYPE, NEMA 5-20R. MOUNT 6" ABOVE COUNTER UNLESS NOTED OTHERWISE

DUPLEX RECEPTACLE - 20 AMP, 125 VOLT, GFI, 3 POLE, 3 WIRE GROUNDED TYPE, NEMA 5-20R. MOUNT 26" AFF TO C/L FOR DRINKING FOUNTAIN

SINGLE RECEPTACLE - 30 AMP, 125 VOLT, 2 POLE, 3 WIRE GROUNDED TYPE, NEMA L6-30R. MOUNT AS DIRECTED FOR RACK UPS SYSTEM

SINGLE RECEPTACLE - 30 AMP, 125 VOLT, 2 POLE, 3 WIRE GROUNDED TYPE, NEMA L6-30R. MOUNT AS DIRECTED FOR RACK UPS SYSTEM

JUNCTION BOX SIZE NOTED OR REQUIRED, WITH BLANK SCREW COVER AND FLEXIBLE CONDUIT

PHOTOCELL; TORK MODEL 5231 (120V), TWIST RECEPTACLE: TORK 2421.

250V RECEPTACLE; 4 WIRE; MT 14" A.F.F. TO C/L; NEMA 10-30R; HUBBELL SERIES 9350

250V RECEPTACLE; 4 WIRE; MT 14" AFF TO C/L; NEMA 14-30R; HUBBELL SERIES 9350

CEILING MOUNTED OUTLET. NEMA 5-20R IN SINGLE GANG BOX SUSPENDED FROM CEILING USING TYPE "SO" CORD (2#10 WITH GROUND) AND KELLEMS GRIP AT BOTH ENDS. SUSPEND FROM STRUCTURE $_{LA-1}^{E}$

WELDING RECEPTACLE - NEMA 6-50R

UNLESS NOTED OTHERWISE ON SHEET 1/E3.1

TELEPHONE & TELEVISION SYSTEMS

WALL OUTLET -4-1/2" SQ X 3-1/2" DEEP BOX; MOUNT 18" AFF; FOR TYPICAL UNITS—SEE TELEPHONE RISER DIAGRAM

TELEPHONE BACKBOARD - 3/4" EXTERIOR GRADE PLYWOOD WITH TWO COATS OF INSULATING VARNISH, SIZE AS SHOWN

PANELS AND POWER

PANELBOARD

PANELBOARD FLUSH MOUNTED

CON CONTROL PANEL

NON-FUSIBLE DISCONNECT SWITCH; XX/YY/ZZ WHERE X INDICATES AMPERAGE, Y INDICATES # OF POLES, AND Z INDICATES NEMA RATING

FUSIBLE DISCONNECT SWITCH; XX/YY/ZZ WHERE X INDICATES AMPERAGE, Y INDICATES # OF POLES, AND Z INDICATES NEMA RATING; FURNISH AND INSTALL FUSES PER MANUFACTURER'S RECOMMENDATIONS

MOTOR FURNISHED BY OTHERS AND CONNECTED BY ELECTRICAL CONTRACTOR; '5' INDICATES HORSE POWER RATING

—ó ò— CIRCUIT BREAKER

_____ NONFUSIBLE SWITCH ______FUSIBLE SWITCH

→> DRAWOUT CONNECTION TRANSFORMER

ENCLOSED CIRCUIT BREAKER

ELECTRIC METER

GROUND BUSS

FIRE ALARM SYSTEM

FACP FIRE ALARM SYSTEM CONTROL PANEL

ANN FIRE ALARM SYSTEM REMOTE ANNUNCIATOR — FLUSH MOUNTING

FIRE ALARM SYSTEM MANUAL PULL STATION

SH FIRE ALARM SYSTEM VOICE EVAC SPEAKER/STROBE

WEATHERPROOF FIRE ALARM SYSTEM SIGNAL HORN;

FIRE ALARM SYSTEM STROBE;

(TS) FIRE ALARM SYSTEM TAMPER SWITCH (FS) FIRE ALARM SYSTEM FLOW SWITCH

(HD) FIRE ALARM SYSTEM AUTOMATIC HEAT DETECTOR; 135 DEGREE/RATE OF RISE TYPE; CEILING MOUNTED

(SD) FIRE ALARM SYSTEM AUTOMATIC SMOKE DETECTOR; CEILING MOUNTED

© FIRE ALARM SYSTEM AUTOMATIC CO DETECTOR BASE; CEILING MOUNTED

(DD) FIRE ALARM SYSTEM AUTOMATIC AIR DUCT SMOKE DETECTOR MOUNTED IN MECHANICAL DUCT

RT FIRE ALARM SYSTEM REMOTE TEST STATION ZC FIRE ALARM SYSTEM ZONE MODULE, CONTROL TYPE

ZM FIRE ALARM SYSTEM ZONE MODULE, MONITOR TYPE

— F — FIRE ALARM SYSTEM SUPERVISED CIRCUITING IN CONDUIT, RACEWAY INSTALLED CONCEALED

FIRE ALARM SYSTEM MAGNETIC DOOR HOLDERS

BRANCH CIRCUITING

The run concealed under floor or in grade

RUN CONCEALED IN CEILING OR WALLS

HOMERUN TO PANEL. ANY CIRCUIT WITHOUT FURTHER IDENTIFICATION INDICATES 2 #12, 1 #12 GROUND - 3/4" C; /// 3 #12, 1 #12 GROUND - 3/4" C; NUMERALS INDICATE PANEL AND CIRCUIT NUMBER.

HOMERUN TO PANEL. ANY CIRCUIT WITHOUT FURTHER IDENTIFICATION INDICATES 2 #10, 1 #10 GROUND - 3/4" C; -10/// 3 #10, 1 #10 GROUND - 3/4" C; _10////___ 4 #10, 1 #10 GROUND - 1" C; ETC." AS PER NEC. LETTERS AND NUMERALS INDICATE PANEL AND CIRCUIT NUMBER.

HOMERUN TO PANEL. ANY CIRCUIT WITHOUT FURTHER IDENTIFICATION INDICATES 2 #8, 1 #10 GROUND - 1" C; \sim 8 # 3 #8, 1 #10 GROUND - 3/4" C; -8° ///// "4 #8, 1 #10 GROUND - 1 1/4" "C; ETC". AS PER NEC. LETTERS AND NUMERALS INDICATE PANEL AND CIRCUIT NUMBER.

WHERE A NUMBER IS SHOWN NEXT TO OR ON THE CIRCUIT OR HOMERUN. THE NUMBER INDICATES CONDUCTOR SIZE OTHER THAN #12 - NUMBER #6 CONDUCTORS INDICATED. PROVIDE GROUND SIZED PER NEC TABLE 250-95 FOR MAX AMPACITY OF CONDUCTOR SIZE AS SHOWN. SIZE CONDUIT PER NEC ANNEX C.

LIQUID-TIGHT FLEXIBLE CONDUIT CONNECTION

SURFACE MOUNTED CONDUIT; RUN PARALLEL OR PERPENDICULAR TO BUILDING LINES

WALL SWITCHES (UNLESS OTHERWISE NOTED, MOUNT 48" A.F.F.)

S A.C. TYPE, SINGLE POLE, 20 AMP, 120/277 VOLT

 S_3 A.C. TYPE, 3-WAY, 20 AMP, 120/277 VOLT

MOTOR RATED TOGGLE SWITCH DISCONNECT, WITH THERMAL OVERLOADS A.C. TYPE, 20 AMP, 120/277 VOLT

SM MOTOR RATED TOGGLE SWITCH DISCONNECT, WITH THERMAL OVERLOADS 30/1 SM A.C. TYPE, 30 AMP, 120/277 VOLT

ST PRESET INTERVAL TIMER SWITCH, HUBBELL TD-300 SERIES OR EQUALS

PUSH BUTTON, TOGGLE SWITCH, ROTARY SWITCH, ETC., FURNISHED WITH EQUIPMENT BY OTHERS, INSTALLED AND WIRED BY THE ELECTRICAL CONTRACTOR.

MISCELLANEOUS

AMERICANS WITH DISABILITIES ACT ABOVE FINISH FLOOR AMPERE INTERRUPTING CAPACITY AUTOMATIC TRANSFER SWITCH CONDUIT CENTER LINE COLD WATER PIPE EMERGENCY ELECTRIC METALLIC TUBING GROUND FAULT INTERRUPTER GALVANIZED RIGID METAL CONDUIT GROUND MAIN CIRCUIT BREAKER MOTOR CONTROL CENTER MAIN LUGS ONLY NEUTRAL NOT IN CONTRACT NATIONAL ELECTRICAL CODE NATIONAL ELECTRICAL MANUFACTURER'S ASSOC. NATIONAL FIRE PROTECTION ASSOCIATION NIGHT LIGHT NOT TO SCALE POLE POWER FACTOR PHASE

PVC (POLYVINYL CHLORIDE) CONDUIT SINGLE LINE DIAGRAM TBB TELEPHONE BACKBOARD TRANSIENT VOLTAGE SURGE SUPPRESSORS UNDERWRITER'S LABORATORY

UNLESS NOTED OTHERWISE VOLTAGE WEATHERPROOF NUMBER

NEMA 3R WEATHERPROOF ENCLOSURE NEMA 4X WEATHERPROOF/CORROSION ENCLOSURE

MISCELLANEOUS EQUIPMENT

CONTACTOR

EXTERIOR POLE LIGHT

WH) WATER HEATER

LIGHTING CONTROLS

SCREEN MONITOR

(0S) CEILING MOUNTED OCCUPANCY SENSOR

POWER PACK FOR OCCUPANCY SENSOR

ROOM CONTROLLER - 1 ZONE DIMMING

ROOM CONTROLLER - 2 ZONE DIMMING

ROOM CONTROLLER - EMERGENCY LIGHTING UL924 DEVICE

ROOM CONTROLLER - ON/OFF NO DIMMING

WALL DIMMER - ON/OFF & 0-10V 1-ZONE DIMMING

WALL DIMMER - ON/OFF & 0-10V 2-ZONE DIMMING

LOW VOLTAGE SWITCH, 2-BUTTON

 \mathbb{S}_{LX} LOW VOLTAGE SWITCH CONNECTED TO LIGHITNG CONTROL PANEL, 2-BUTTON Sol OCCUPANCY SENSOR WALL SWITCH, ULTRASONIC TECHNOLOGY, 1-BUTTON SIMILAR TO HUBBELL LIGHT HAWK 2

*COORDINATE WITH LIGHTING CONTROL DETAILS FOR MORE REQUIREMENTS

GENERAL ELECTRICAL NOTES:

1. THE SERVICE VOLTAGE TO THE FACILITY SHALL BE 240/120V, 3PH, DELTA 4-WIRE

2. INSTALLATION SHALL COMPLY WITH THE NATIONAL ELECTRICAL CODE, STATE AND LOCAL CODES, AND MANUFACTURER'S RECOMMENDATIONS.

3. MAINTAIN ALL CLEARANCES FOR ELECTRICAL EQUIPMENT PER THE NEC.

4. COORDINATE ROUGH-IN OF ALL ELECTRICAL DEVICES WITH ARCHITECTURAL FLOOR PLANS, ELEVATIONS AND MILLWORK SHOP DRAWINGS PRIOR TO ROUGH-IN. AVOID ALL BACKSPLASHES AT COUNTERS.

5. ALL DIMENSIONS INDICATED IN THESE DOCUMENTS ARE FOR REFERENCE AND COORDINATION PURPOSES ONLY. THE CONTRACTOR IS RESPONSIBLE FOR VERIFYING ALL DIMENSIONS IN THE FIELD, AND COORDINATING WORK WITH OTHER TRADES TO AVOID CONFLICTS.

6. VERIFY ALL DOOR SWINGS WITH ARCHITECTURAL BEFORE ROUGH-IN OF LIGHT SWITCHES TO ENSURE PROPER SWITCH

7. THE LOCATION OF OUTLETS, FIXTURES, AND EQUIPMENT SHOWN ON THE DRAWINGS ARE APPROXIMATE, OFFSET AS NEEDED OR AS REQUESTED BY THE OWNER. THE OWNER SHALL HAVE THE RIGHT TO RELOCATE ANY OUTLETS OR FIXTURES BEFORE THEY ARE INSTALLED WITHOUT ANY ADDITIONAL COST

8. COORDINATE EXACT LOCATION OF ALL ELECTRICAL FLOOR DEVICES WITH ARCHITECT PRIOR TO INSTALLATION.

9. ALL CONDUIT SIZE SHALL BE A MINIMUM 3/4" UNLESS NOTED OTHERWISE IN THE DRAWINGS OR SPECIFICATIONS.

10. ALL ELECTRICAL RACEWAYS AND CABLING SHALL BE INSTALLED CONCEALED WITHIN THE CONFINES OF THE BUILDING FOUNDATIONS EXCEPT THOSE SPECIFICALLY SERVING LOADS OR EQUIPMENT EXTERIOR OF THE BUILDING. ALL SUCH RACEWAYS SHALL BE A MINIMUM 18" INSIDE FOUNDATIONS AND POWER AND COMMUNICATIONS RACEWAYS SHALL BE SEPARATED BY A MINIMUM 18".

11. ALL CONDUITS INSTALLED UNDERFLOOR SHALL BE ROUTED UNDER STRUCTURAL CONCRETE FLOOR SLABS, CONTRACTOR SHALL NOT INSTALL CONDUITS IN CONCRETE FLOORING WITHOUT THE EXPRESS WRITTEN PERMISSION OF THE STRUCTURAL ENGINEER. CONDUITS PENETRATING THRU CONCRETE FLOORS SHALL ADHERE TO THE ELECTRICAL SPECIFICATIONS AND RECOMMENDATIONS OF THE STRUCTURAL ENGINEER.

12. ALL RACEWAYS INSTALLED ON EXTERIOR OF THE BUILDING, INCLUDING CONDUIT UNDER CANOPIES, SHALL BE GRC. EMT WILL NOT BE ACCEPTED

13. ALL RACEWAYS SHALL BE SUPPORTED PER NEC AND AT LEAST EVERY 10' AND WITHIN 3' OF EVERY JUNCTION BOX. RACEWAYS SUPPORTED ON BOTTOM OF SECONDARY CEILING SHALL BE SUPPORTED FROM THE STRUCTURE NOT FROM THE GYPBOARD CEILING.

14. ALL EMPTY WALL MOUNTED JUNCTION BOXES SHALL BE PROVIDED WITH A WALL BLANK AND ALL EMPTY RACEWAYS SHALL BE PROVIDED WITH A PULL WIRES.

15. PROVIDE ALL CONDUIT STUBS WITH A PROTECTIVE COLLAR.

16. INSURE THAT ALL PENETRATIONS OF FIRE WALLS AND DECKS ARE PROPERLY SEALED PER INTERNATIONAL BUILDING CODE 712 AND WITH AN UL APPROVED DEVICE OR FIRE CAULK. REFER TO ARCHITECTURAL PLANS FOR THE LOCATIONS OF RATED FIRE WALLS AND UL ASSEMBLY LOCATIONS AND TYPES AND BID ACCORDINGLY

17. PROVIDE A CONDUIT EXPANSION JOINTS WITH BONDING JUMPER IN ALL CONDUITS CROSSING AN EXPANSION JOINT. REFER TO ARCHITECTURAL DRAWINGS FOR EXPANSION JOINT LOCATIONS.

18. ALL UNDERGROUND CONDUITS RUNS ENTERING THE BUILDING SHALL BE SEALED TO PREVENT THE ENTRANCE OF

19. ALL FLEXIBLE CONDUITS ON THE EXTERIOR, IN WET LOCATIONS OR ANY MECHANICAL ROOM SHALL BE LIQUID TIGHT WITH SUITABLE FITTINGS.

20. THE CONTRACTOR SHALL BE RESPONSIBLE FOR SEALING AROUND DEVICES, PENETRATIONS, OUTLETS, AND CONDUITS THAT PENETRATE THE WALLS ABOVE THE CEILING TO MAINTAIN SOUNDPROOFING. CONTRACTOR SHALL VERIFY THAT THE OPENINGS SIZES ARE LESS THAN 1/2" ON ALL SIDES OF THE PENETRATIONS. ALL OPENINGS IN EXCESS OF 1/2" SHALL BE CAULKED/SEALED WITH SHEET ROCK MUD. THE DRYWALL CONTRACTOR SHALL BE RESPONSIBLE FOR SEALING PENETRATIONS IN PLACE WHEN THE SHEETROCK ARE INSTALLED. PENETRATIONS MADE AFTER THE DRYWALL CONTRACTOR HAS FINISHED IN AN AREA SHALL BE SEALED BY THE CONTRACTOR MAKING THE PENETRATION

21. PLANNED INTERRUPTIONS OF UTILITY SERVICE TO ANY EXISTING FACILITY OR AREAS WITHIN ANY FACILITY AFFECTED BY THIS CONTRACT, SHALL BE CAREFULLY PLANNED AND COORDINATED IN ADVANCE OF THE REQUESTED INTERRUPTION THE CONTRACTOR SHALL NOT INTERRUPT SERVICES UNTIL SPECIFIED APPROVAL HAS BEEN GRANTED. THE REQUES SHALL INDICATE SERVICES AND AREAS TO BE AFFECTED, DATE AND TIME OF INTERRUPTION AND DURATION OF OUTAGE. REQUEST FOR INTERRUPTION OF SERVICE WILL NOT BE APPROVED UNTIL ALL EQUIPMENT AND MATERIA REQUIRED FOR THE COMPLETION OF THAT PARTICULAR PHASE OF WORK ARE ON THE JOB SITE. CONTRACTOR IS RESPONSIBLE FOR ALL OVERTIME, HOLIDAY, AND WEEKEND PAY TO THEIR EMPLOYEES TO DO THIS WORK DURING SCHEDULED NON-NORMAL WORK HOURS.

22. BUILDING OWNER MUST RECEIVE RECORD DRAWINGS AND MANUALS THAT PROVIDE INSTRUCTIONS ABOUT THE OPERATION AND MAINTENANCE OF THE BUILDING'S ELECTRICAL DISTRIBUTION SYSTEM.

23. CONTRACTOR IS RESPONSIBLE FOR PROPER SENSITIVITY AND TIME DELAY SETTINGS FOR OCCUPANCY SENSORS PROVIDE PROPER NUMBER OF POWER PACKS AND LOCATE POWER PACKS AND OCCUPANCY SENSORS ACCORDING TO MANUFACTURER'S RECOMMENDATIONS.

SYSTEM THEY CONTAIN. 25. HVAC EQUIPMENT POWER WIRING SHALL BE FURNISHED AND INSTALLED BY THIS CONTRACTOR. CONTROL EQUIPMENT AND CONTROL WIRING SHALL BE FURNISHED UNDER DIVISION 15 UNLESS OTHERWISE NOTED. PROVIDE 3/4" CONDUITS WITH PULL WIRE BETWEEN INSIDE AND OUTSIDE UNITS, THERMOSTAT OUTLETS AND UNITS AND/OR MECHANICAL

CONTROL PANEL AS APPLICABLE. THERMOSTAT OUTLETS SHALL BE 4" SQUARE OUTLETS, FLUSH MOUNTED WITH SINGLE

GANG OR DOUBLE GANG PLASTER RINGS AS DIRECTED BY THE HVAC CONTRACTOR. COORDINATE EXACT LOCATION OF

ALL EQUIPMENT, DEVICES, OUTLETS, ETC, WITH THE MECHANICAL DRAWINGS AND DIVISION 15 SPECIFICATIONS.

24. ALL JUNCTION BOX COVERS ABOVE THE CEILING SHALL BE CLEARLY MARKED WITH WHICH CIRCUITS OR ELECTRICAL

WILL BE ALLOWED WHERE CONCEALABLE AND ALLOWED BY NEC.

COORDINATE WITH THE HVAC CONTRACTOR FOR EXACT LOCATIONS OF ALL EQUIPMENT.

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Konnetty R.Jun 05-18-2022

SHEET TITLE: ELECTRICAL LEGEND & **NOTES**

05.18.2022

MCKEE JOB #: 21.239

DRAWN BY: J. TILLERY

REVISED DATE:

REVISED DATE:

Gunn & Associates, P.C.

Tel: 334.285.1273

Consulting Engineers

3102 Highway 14 1200 Providence Park, Suite 200 Millbrook, AL 36054 Birmingham, AL 35242

GA#22-115

PSCA#:

REVISED DATE:

SHEET NO.: EO.

SITE LEGEND

- - UP - UNDERGROUND PRIMARY
- —US— — UNDERGROUND SECONDARY ——OP—— OVERHEAD PRIMARY
- — —UC— — UNDERGROUND COMMUNICATIONS

SHEET NOTES:

- 1 REMOVE EXISTING UNDERGROUND SECONDARY.
- (2) COORDINATE WITH ALABAMA POWER TO BRING OVERHEAD SECONDARY TO NEW SERVICE ENTRANCE PANEL.



APPROXIMATE LOCATION OF NEW PANEL "MSA"

APPROXIMATE LOCATION OF EXISTING RISER POLE. EXISTING SERVICE TO BE REMOVED BACK TO POINT OF ORIGIN.

SCALE: 1" = 40'-0"

UNDERGROUND UTILITY NOTES:

- 1. THE UNDERGROUND UTILITY PORTION OF THIS PROJECT CONSISTS OF BUT IS NOT LIMITED TO:
- a. TRENCHING/BACKFILLING FOR DUCT LINES AND CONDUIT SYSTEMS
- b. DUCTBANK INSTALLATIONS c. LOW VOLTAGE CONDUCTOR INSTALLATION
- d. PATCH/REPAIR ALL DAMAGED SURFACES AS A RESULT OF DUCTLINE INSTALLATIONS
- 2. INSTALLATION SHALL COMPLY WITH THE REQUIREMENTS OF THE NATIONAL ELECTRICAL SAFETY CODE (NESC) AND THE NATIONAL ELECTRICAL CODE (NEC).
- 3. ALL CONDUCTIVE PARTS OF EQUIPMENT, ENCLOSURES, SUPPORTS, FRAMES, CASES, CONDUIT SYSTEMS AND SURGE ARRESTORS, CABLE SHEATHS, CABLE SHIELDS, COMMON NEUTRALS, ETC., SHALL BE GROUNDED. UNLESS NOTED OTHERWISE CONNECTIONS BELOW GRADE SHALL BE FUSION—WELDED AND ABOVE GRADE FUSION—WELDED OR BOLTED SOLDERLESS. ALL GROUND CONDUCTORS SHALL BE COPPER.
- 4. ALL CLEARANCES SHALL BE MAINTAINED PER NESC AND NEC. ALL PARTS, DEVICES, EQUIPMENT, ETC. WHICH REQUIRE MAINTENANCE, ADJUSTMENT, OPERATION OR EXAMINATION DURING NORMAL NETWORK OPERATION SHALL BE ARRANGED SO AS TO BE ACCESSIBLE BY THE PROVISION OF ADEQUATE WORKING SPACES, WORKING FACILITIES AND CLEARANCES. UNLESS NOTED OTHERWISE ALL CLEARANCES ARE MEASURED FROM SURFACE TO SURFACE.
- 5. ALL DIMENSIONS INDICATED IN THESE DOCUMENTS ARE FOR REFERENCE AND COORDINATION PURPOSES ONLY. THE CONTRACTOR IS RESPONSIBLE FOR VERIFYING ALL DIMENSIONS IN THE FIELD.
- 6. UNLESS OTHERWISE SHOWN OR DIRECTED DUCT LINES SHALL NOT BE LOCATED DIRECTLY UNDER STRUCTURES AND NOT DIRECTLY UNDER OR OVER OTHER SUBSURFACE STRUCTURES. WHERE DUCT LINES ARE REQUIRED TO CROSS OTHER UTILITIES SUCH AS SEWERS, WATER LINES, OTHER POWER LINES, COMMUNICATION LINES, ETC., ADEQUATE SUPPORT SHALL BE PROVIDED ON EACH SIDE OF THE CROSSING TO PREVENT TRANSFERRING ANY DIRECT LOAD ONTO THE OTHER LINE. DUCT LINES SHALL BE SO INSTALLED AS TO PREVENT HEAT TRANSFER BETWEEN ANY HEAT PRODUCING LINES AND/OR
- a. ROUTING SHOWN ON DRAWINGS IS TYPICAL AND THE CONTRACTOR SHALL PROPOSE FINAL ROUTING BASED UPON ACTUAL FIELD DIMENSIONS, CONDITIONS AND EXISTING UNDERGROUND UTILITIES AND STRUCTURES. b. PRIOR TO TRENCHING, THE CONTRACTOR SHALL STAKE OUT THE ENTIRE NETWORK ARRANGEMENT. ONE GRADE A WOODEN STAKE WITH RED FLAG SHALL BE DRIVEN EVERY 50'-0" AND AT EACH CHANGE OF DIRECTION. FOUR STAKES SHALL BE DRIVEN TO OUTLINE EQUIPMENT AND/OR MANHOLE LOCATIONS. ON PAVEMENTS RED PAINT
- SHALL BE USED TO OUTLINE THE AREAS TO BE CUT. SECURE EXISTING UNDERGROUND UTILITY INFORMATION FROM THE CONTRACTING OFFICER PRIOR TO PERFORMING ANY TRENCHING. c. DEPTHS INDICATED FOR INSTALLATION ARE MINIMUM. ACTUAL DEPTHS MAY VARY DUE TO TERMINATIONS, COMPENSATIONS FOR RADIUS OF VERTICAL TRANSITIONS, EXISTING UTILITY CROSSINGS, ETC. APPROVAL SHALL BE OBTAINED FOR ANY DEPTH LESS THAN INDICATED. TRENCHES SHALL BE OVER-EXCAVATED AS NECESSARY TO ALLOW FOR PROPER TRENCH PREPARATION, DUCT BANK CONSTRUCTION, FORMING AND/OR BACKFILLING REQUIREMENTS. d. ALL TRENCHING AND BACKFILL COMPACTION SHALL COMPLY WITH GEOTECHNICAL REPORT AND DIVISION 200.

GENERAL NOTES:

- 1. LOCATIONS OF RISER POLES, AND TRANSFORMERS SHALL BE COORDINATED PRIOR TO BIDS. ADJUST FEEDER AND CONDUIT LENGTHS ACCORDINGLY. PAY ALL UTILITY COMPANY FEES. BID ACCORDINGLY.
- 2. COORDINATE WITH POWER RISER DIAGRAMS FOR FEEDER AND CONDUIT SIZES AND ALL OTHER ADDITIONAL REQUIREMENTS NOT SHOWN ON SITE PLAN.
- 3. ALL UNDERGROUND CONDUITS SHALL BE 36" MINIMUM BELOW GRADE. PRIMARY CONDUIT SHALL BE MINIMUM 48" BELOW GRADE.

4. ALL ROUTING IS SHOWN DIAGRAMMATIC. VERIFY ACTUAL ROUTING AND FIELD CONDITIONS PRIOR TO BIDS.

DRAWN BY: REVISED DATE: REVISED DATE: REVISED DATE:

SHEET NO.: E1.0


SHEET TITLE: SITE PLAN - ELECTRICAL

J. TILLERY

05.18.2022

MCKEE JOB #: 21.239

SCALE: 1'' = 40'-0''40' 20 0 40 80FT **GRAPHIC SCALE** Gunn & Associates, P.C. 3102 Highway 14 Millbrook, AL 36054 1200 Providence Park, Suite 200 Birmingham, AL 35242 GA#22-115 Tel: 334.285.1273

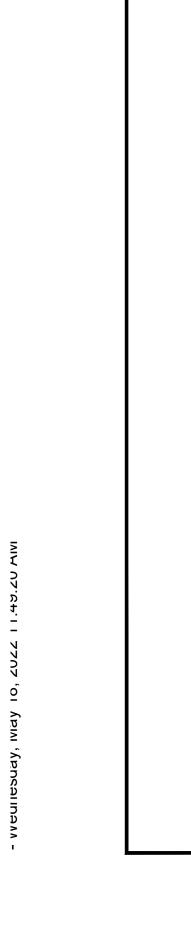

APPROXIMATE LOCATION OF NEW COMMUNICATIONS BACKBOARD

GENERAL NOTES:


- 1. CONTRACTOR RESPONSIBLE FOR REMOVING AND REINSTALLING ALL CEILING MOUNTED DEVICES IN ALL AREAS THAT NEW CEILINGS WILL BE INSTALLED. LOWER DEVICES TO NEW CEILINGS AS REQUIRED. INTERCEPT AND EXTEND CIRCUITRY AS NEEDED. VISIT SITE PRIOR TO BIDS TO QUANTIFY THE AMOUNT OF WORK AND BID ACCORDINGLY.
- 2. REMOVE ALL SWITCHING AS REQUIRED TO ACCOMPLISH NEW SWITCHING REQUIREMENTS. SEE LIGHTING PLANS FOR NEW SWITCH REQUIREMENTS FOR EACH SPACE. 3. CONTRACTOR RESPONSIBLE FOR REMOVING AND PROPERLY DISPOSING OF ALL EXISTING

LIGHTS AND LIGHT BULBS.

SHEET NOTES:

(1) CONTRACTOR SHALL REMOVE ALL EXISTING LIGHTING IN THIS AREA. EXISTING CIRCUITRY SHALL REMAIN FOR CONNECTION OF NEW LIGHTING FIXTURES.

EXISTING RACEWAYS: ELECTRICAL CONTRACTOR SHALL SUPPORT ALL EXISTING RACEWAYS TO REMAIN PER THE NATIONAL ELECTRICAL CODE. PROVIDE ALL EXISTING OPEN JUNCTION BOXES WITH COVERS AND PROVIDE PUSH PENNIES TO ANY EXISTING OPEN KNOCKOUTS. THE EXISTING OVERHEAD CONDUIT SYSTEM IS CURRENTLY NOT SUPPORTED CORRECTLY AND THERE IS OPEN JUNCTION BOXES AND KNOCKOUTS, ELECTRICAL CONTRACTOR WILL BE RESPONSIBLE TO CORRECT ALL THESE ITEMS IN THEIR BASE BID.

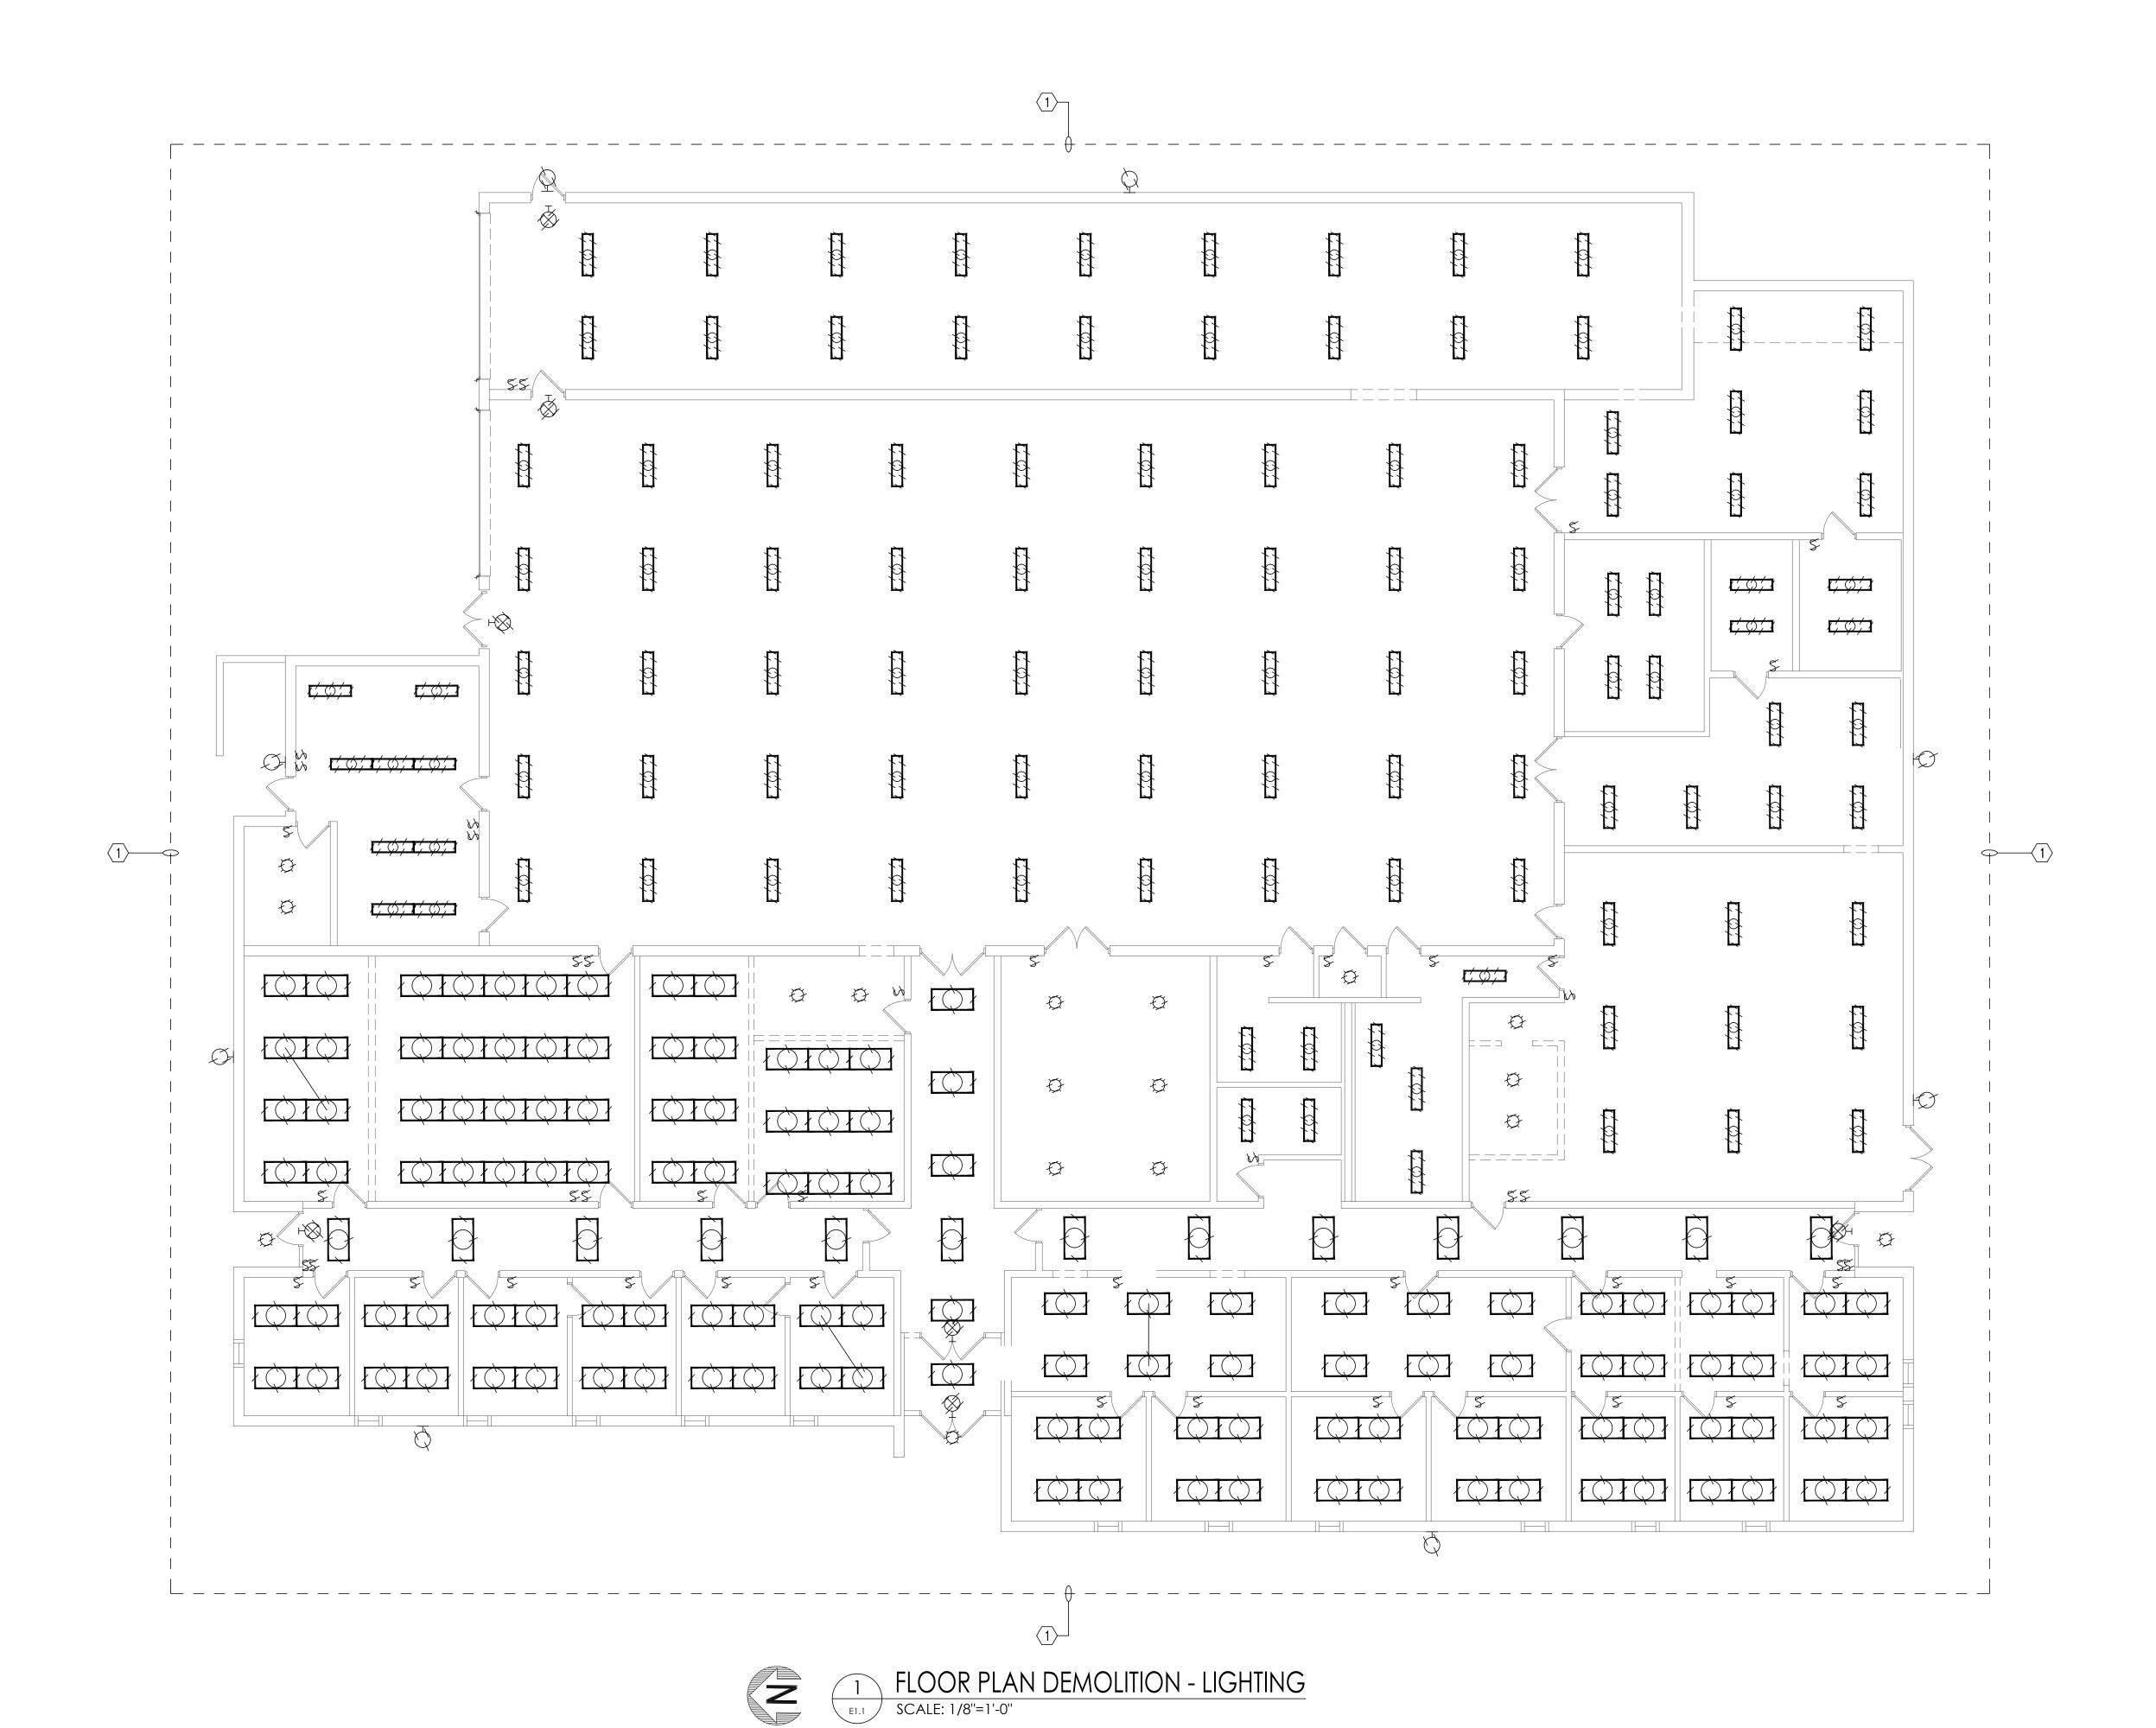

SHEET TITLE: FLOOR PLAN DEMOLITION LIGHTING MCKEE JOB #: 21.239

> PSCA#: J. TILLERY DRAWN BY:

05.18.2022 REVISED DATE:

REVISED DATE: REVISED DATE:

1/8" = 1'-0

GRAPHIC SCALE

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Consulting Engineers

3102 Highway 14 Millbrook, AL 36054 Tel: 334.285.1273

1200 Providence Park, Suite 200 Birmingham, AL 35242

GA#22-115

SHEET NO.: E1.1

GENERAL NOTES:


- CONTRACTOR RESPONSIBLE FOR REMOVING AND REINSTALLING ALL CEILING MOUNTED DEVICES IN ALL AREAS THAT NEW CEILINGS WILL BE INSTALLED. LOWER DEVICES TO NEW CEILINGS AS REQUIRED. INTERCEPT AND EXTEND CIRCUITRY AS NEEDED. VISIT SITE PRIOR TO BIDS TO QUANTIFY THE AMOUNT OF WORK AND BID ACCORDINGLY.
- 2. REMOVE ALL SWITCHING AS REQUIRED TO ACCOMPLISH NEW SWITCHING REQUIREMENTS. SEE LIGHTING PLANS FOR NEW SWITCH REQUIREMENTS FOR EACH SPACE.
- 3. CONTRACTOR RESPONSIBLE FOR REMOVING AND PROPERLY DISPOSING OF ALL EXISTING LIGHTS AND LIGHT BULBS.


SHEET NOTES:

- $\langle 1 \rangle$ EXISTING DEVICE TO REMAIN.
- REMOVE ALL ELECTRICAL FROM WALL AND DOORS TO BE REMOVED. INTERCEPT AND EXTEND EXISTING CIRCUITRY TO EXISTING DEVICES TO REMAIN.
- (3) CONTRACTOR SHALL REPLACE EXISTING RECEPTACLE ONE FOR ONE WITH NEW GFCI TYPE. CONTRACTOR SHALL INTERCEPT AND EXTEND EXISTING CIRCUIT AS REQUIRED.

EXISTING RACEWAYS:

ELECTRICAL CONTRACTOR SHALL SUPPORT ALL EXISTING RACEWAYS TO REMAIN PER THE NATIONAL ELECTRICAL CODE. PROVIDE ALL EXISTING OPEN JUNCTION BOXES WITH COVERS AND PROVIDE PUSH PENNIES TO ANY EXISTING OPEN KNOCKOUTS. THE EXISTING OVERHEAD CONDUIT SYSTEM IS CURRENTLY NOT SUPPORTED CORRECTLY AND THERE IS OPEN JUNCTION BOXES AND KNOCKOUTS. ELECTRICAL CONTRACTOR WILL BE RESPONSIBLE TO CORRECT ALL THESE ITEMS IN THEIR BASE BID.

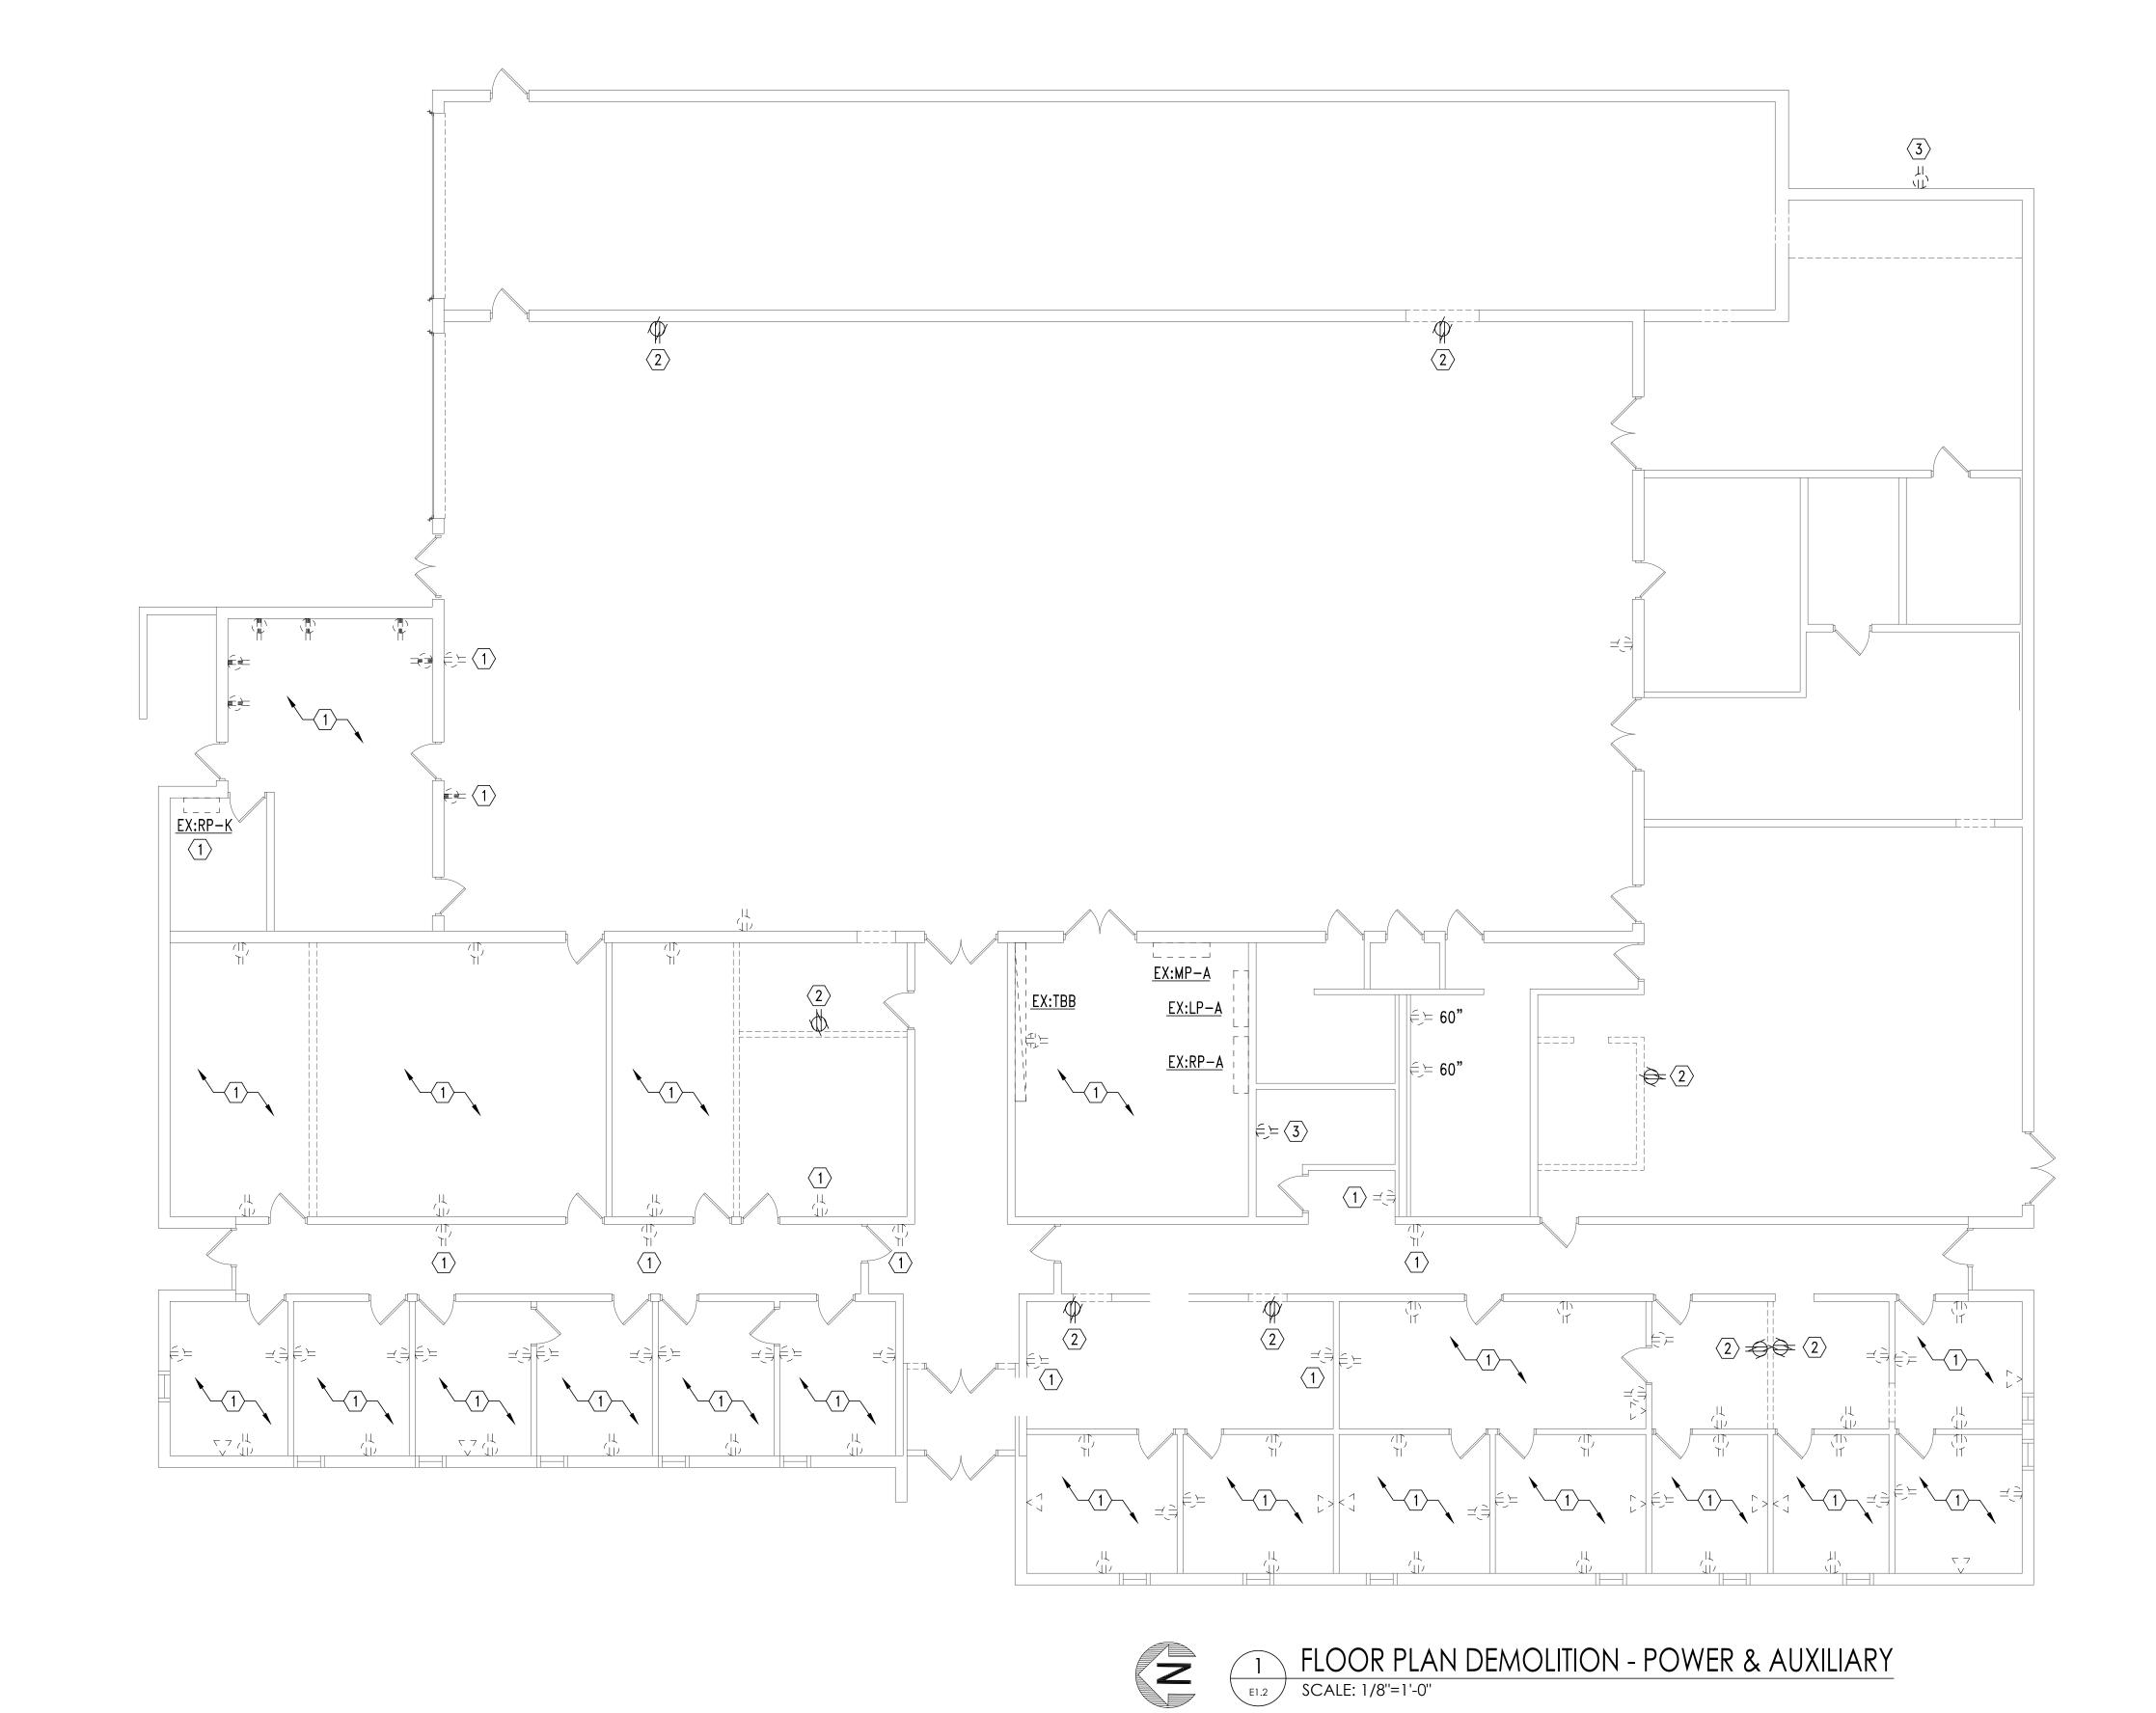

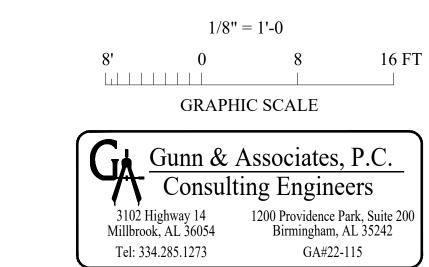

SHEET TITLE: FLOOR PLAN DEMOLITION POWER & AUXILIARY

MCKEE JOB #: 21.239

PSCA #:

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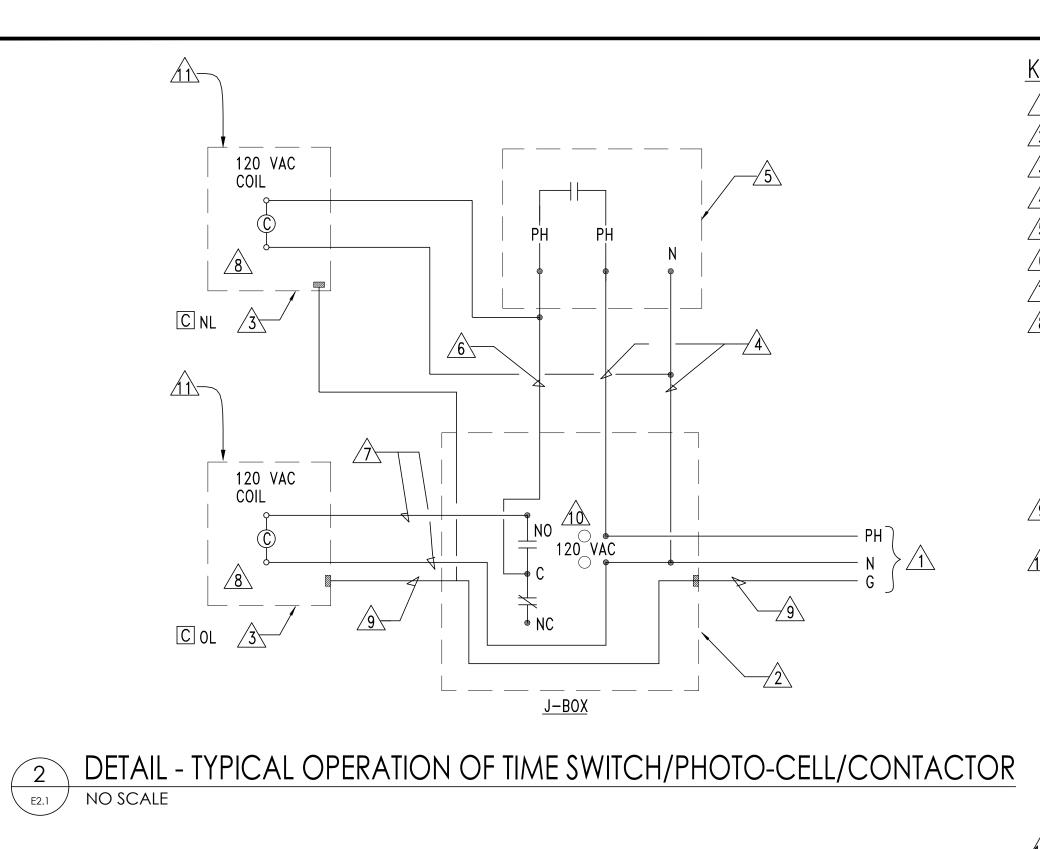
DATE: 05.18.2022

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SHEET NO.: **E1.2**



KEYED NOTES

- POWER SUPPLY 120V, 1PH, 60HZ
- TIME SWITCH ENCLOSURE NEMA 1 UNLESS NOTED OTHERWISE
- CONTACTOR ENCLOSURE NEMA 1 UNLESS NOTED OTHERWISE
- POWER TAP TO PHOTO-CELL IN GRC
- TURN-LOCK PHOTO-CELL, SEE DETAIL
- SWITCH LEG RETURN IN GRC
- POWER TO CONTACTOR COIL LIGHTING CONTACTOR C NL & C OL AS FOLLOWS:
- -NEMA ICS 2-211B INDUSTRIAL DUTY TYPE -ELECTRICALLY OPERATED-ELECTRICALLY HELD -RATING AND NUMBER OF POLES INDICATED -CONTACTS SHALL BE SILVER ALLOY, DOUBLE-BREAK, SUITABLE FOR TUNGSTEN, BALLAST LIGHTING, RESISTANCE AND MOTOR LOADS -FUSING FOR CONTROL CIRCUIT
- GROUND CONDUCTOR BOND TO EACH ENCLOSURE AND INSTALL IN EACH CONDUIT SYSTEM
- 10 DIGITAL TIME SWITCH AS FOLLOWS:
- -ONE CHANNEL WITH 24 HOUR, SEVEN DAY
 - PROGRAMMING AND SKIP-A-DAY FEATURE -INPUT: 120 VAC. 60HZ
- -OUTPUT: DPST DRY CONTACTS (UNPOWERED) -HEAVY DUTY CONTACTS RATED 20 AMPERE RESISTIVE AT 120 VAC
- -TEMPERATURE RANGE: -20 TO +60 DEGREES CELSIUS -RELATIVE HUMIDITY: 0 TO 90% RH
- -CLOCK ACCURACY: ±2 MINUTES PER YEAR -LED INDICATION OF TIME AND LOAD STATUS -FULL WEEK'S RESERVE POWER (BATTERY BACK-UP)
- / PROVIDE NUMBER OF POLES REQUIRED.

GENERAL NOTES:

- 1. ALL OCCUPANCY SENSORS LOCATIONS ARE APPROXIMATE, REFER TO MANUFACTURER'S INSTALLATION INSTRUCTIONS FOR EXACT MOUNTING AND SPACING REQUIREMENTS PRIOR TO INSTALLATION.
- 2. ULTRASONIC CEILING MOUNTED OCCUPANCY SENSORS SHALL BE LOCATED A MINIMUM OF SIX (6) FEET FROM HVAC SUPPLY/RETURN VENTS.
- 3. CONTRACTOR IS RESPONSIBLE FOR PROPER SENSITIVITY AND TIME DELAY SETTINGS FOR OCCUPANCY SENSORS, FOLLOWING THE MANUFACTURER'S RECOMMENDED PLACEMENT, AND FIELD VERIFICATION OF CIRCUITS WITH RESPECT TO POWER PACK PLACEMENT.
- 4. CONTRACTOR IS RESPONSIBLE FOR FIELD VERIFICATION OF REQUIRED NUMBER OF POWER PACKS FOR OCCUPANCY SENSORS AND THE FOLLOWING:
 - a. ONE POWER PACK IS REQUIRED FOR EACH CONTROLLED CIRCUIT. b. REFER TO MANUFACTURER'S INSTALLATION GUIDE FOR MAXIMUM NUMBER OF SENSORS CONNECTED TO
- c. IF MULTIPLE CIRCUITS OR DUAL SWITCHING ARE TO BE CONTROLLED BY OCCUPANCY SENSORS, PROVIDE ALL ADDITIONAL AUXILIARY RELAYS AND POWER PACKS AS NEEDED.
- 5. OCCUPANCY SENSORS MOUNTED OVER DOORWAYS SHALL BE PLACED ONE (1) FOOT INSIDE THRESHOLD.
- 6. OCCUPANCY SENSORS IN CLASSROOMS SHALL HAVE THE WALK-THROUGH FEATURE DISABLED. UNLESS
- SPECIFICALLY RECOMMENDED BY MANUFACTURER.
- 7. SEE POWER PLANS FOR PANEL LOCATIONS. 8. PROVIDE DEDICATED NEUTRALS FOR EACH MULTIWIRE HOMERUN PER NEC.
- 9. PROVIDE LOW VOLTAGE CABLING AS REQUIRED TO EACH LIGHT FIXTURE FROM THE 0-10V DIMMING SWITCH AS REQUIRED TO ACCOMPLISH THE 0-10V DIMMING.
- 10. EXTERIOR EXPOSED CONDUIT WILL NOT BE ALLOWED FOR EXTERIOR LIGHTS. RUN ALL CONDUIT INTERIOR OF THE BUILDING. THEN POKE THRU WALL TO THE EXTERIOR AS NEEDED.
- 11. CONTRACTOR SHALL INSURE THAT NEW DIMMER SWITCHES FIT AS REQUIRED IN EXISTING DOUBLE GANG SWITCH PLACEMENT. 12. PROVIDE ADDITIONAL GROUNDING AS NEEDED TO MAKE LIGHTING CONTROLS AND LED LIGHTING TO FUNCTION CORRECTLY.
- MISSING GROUNDS. VISIT SITE PRIOR TO BIDS TO QUANTIFY. 13. CONTRACTOR SHALL INCLUDE IN THEIR BASE BID PRICE TWO ADDITIONAL 20A/1P HOMERUN CIRCUITS TO USE IF ANY REUSED LIGHTING CIRCUIT BECOME OVER LOADED.

RE-PULL EXISTING LIGHTING CIRCUITS WITH NEW CONDUCTORS AND GROUNDS IF EXISTING LIGHTING CIRCUITRY IS

SHEET NOTES:


- (1) ROUTE EXTERIOR LIGHTING CIRCUITS THRU CONTACTORS AS SHOWN IN DETAIL 3. "NL' DESIGNATES LIGHTS ARE PHOTOCELL ON/PHOTOCELL OFF. "OL" DESIGNATES PHOTOCELL ON/TIMECLOCK OFF.
- (2) DUE TO SAFETY CONCERNS OF LIGHT TURNING OFF WHILE OPERATING EQUIPMENT, THE OWNER HAS ASKED TO ELIMINATE THE LIGHTING CONTROLS IN THIS ROOM.
- 3 PROVIDE WIREGUARD ON WALL MOUNTED LIGHT.
- 4 CONTRACTOR SHALL CONNECT NEW LIGHTS TO EXISTING CIRCUIT PREVIOUSLY SERVING THIS AREA. CONTRACTOR SHALL INTERCEPT AND EXTEND EXISTING CIRCUIT AS REQUIRED.

ROOM CONTROLLER NOTES:

CONTRACTOR SHALL LOCATE ALL ROOM CONTROLLERS ABOVE DOORS IN EACH ROOM 6" ABOVE CEILING GRID. PROVIDE ACCESS PANELS WHERE LOCATED ABOVE HARD CEILINGS OR MOUNT IN UTILITY TYPE ROOMS WHENEVER POSSIBLE. ROOM CONTROLLERS SHOWN ON THIS PLAN IS DIAGRAMMATIC FOR CIRCUITRY. DO NOT USE THESE FOR ACTUAL LOCATIONS. PROVIDE A WHITE PHENOLIC LABLEL WITH 1" BLACK TEXT THAT READS "RC" GLUED ON CEILING GRID UNDER POWER PACK FOR EACH LOCATION FOR FUTURE MAINTENANCE.

PHOTOCONTROL OF LIGHTING:

1. PHOTOCONTROL OF LIGHT FIXTURES WILL NOT BE REQUIRED FOR THE AREAS ON THIS PAGE. THE PRIMARY SIDELIGHTED AREA WILL NOT HAVE WATTAGES EXCEEDING 150W.

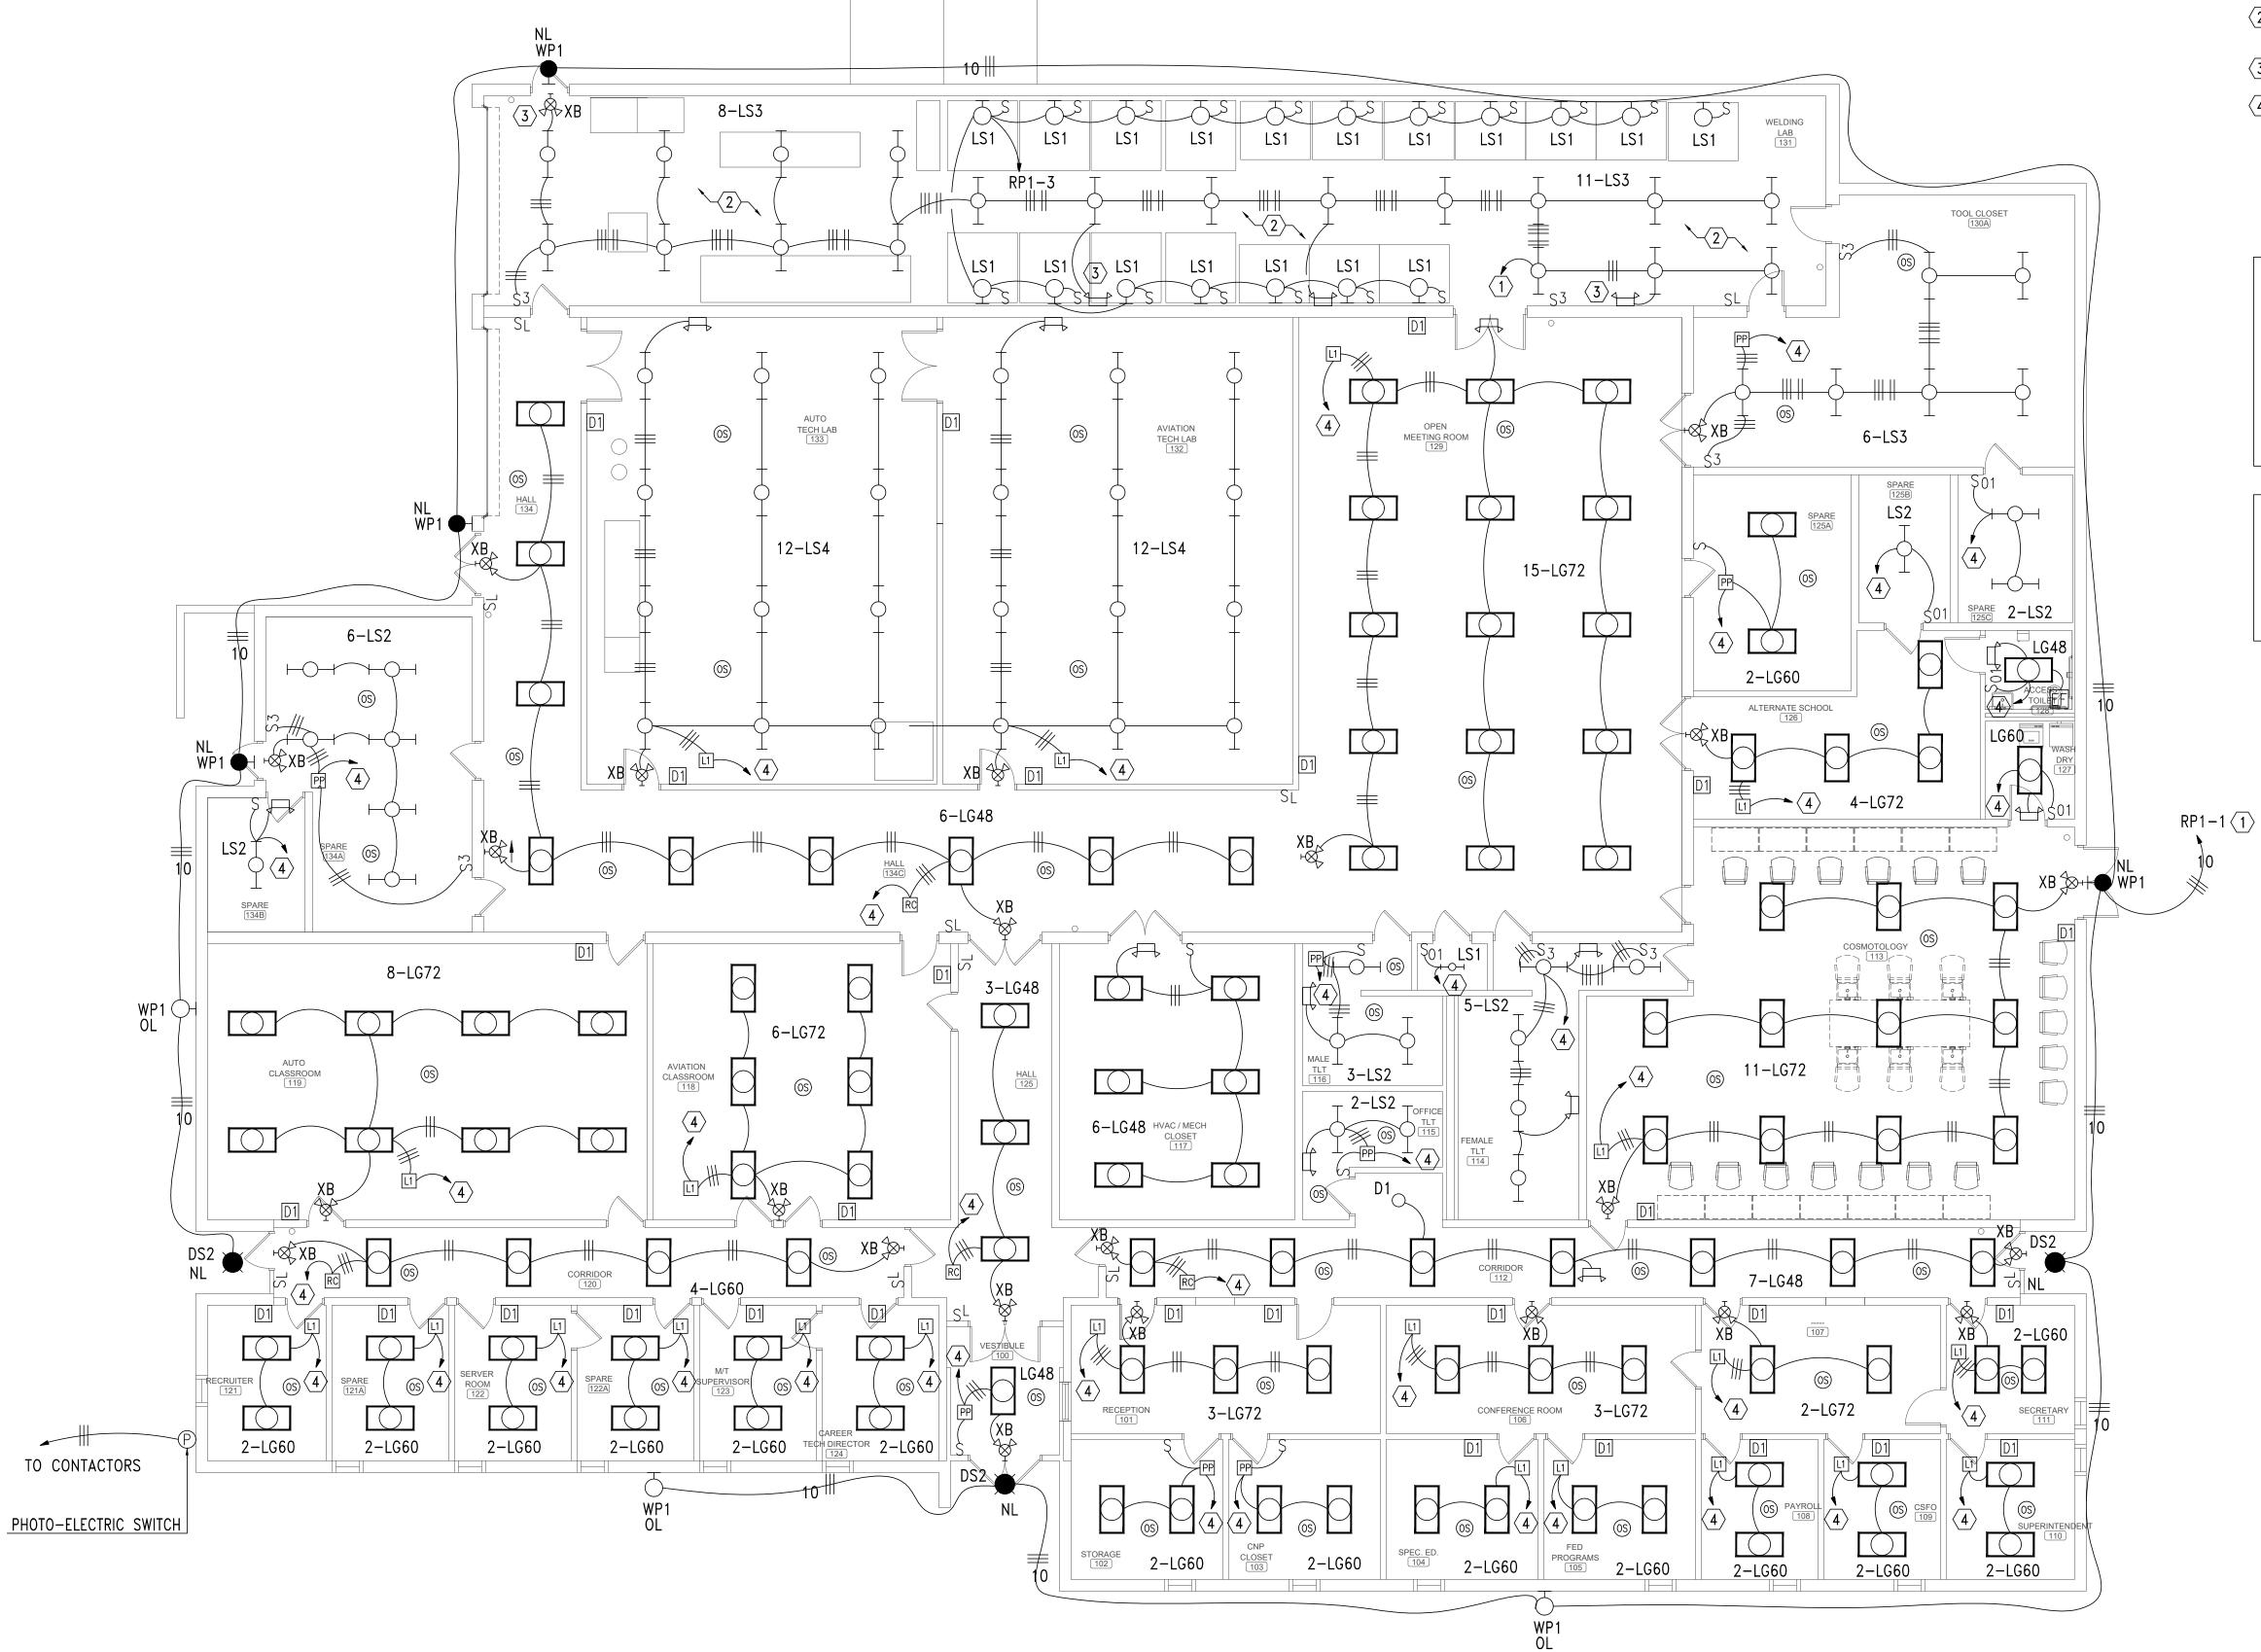

1/8" = 1'-0**GRAPHIC SCALE**

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>
> 1200 Providence Park, Suite 200 Birmingham, AL 35242 GA#22-115

SHEET NO.: E2.1

SHEET TITLE: FLOOR PLAN - LIGHTING

J. TILLERY

05.18.2022

MCKEE JOB #: 21.239

PSCA#:

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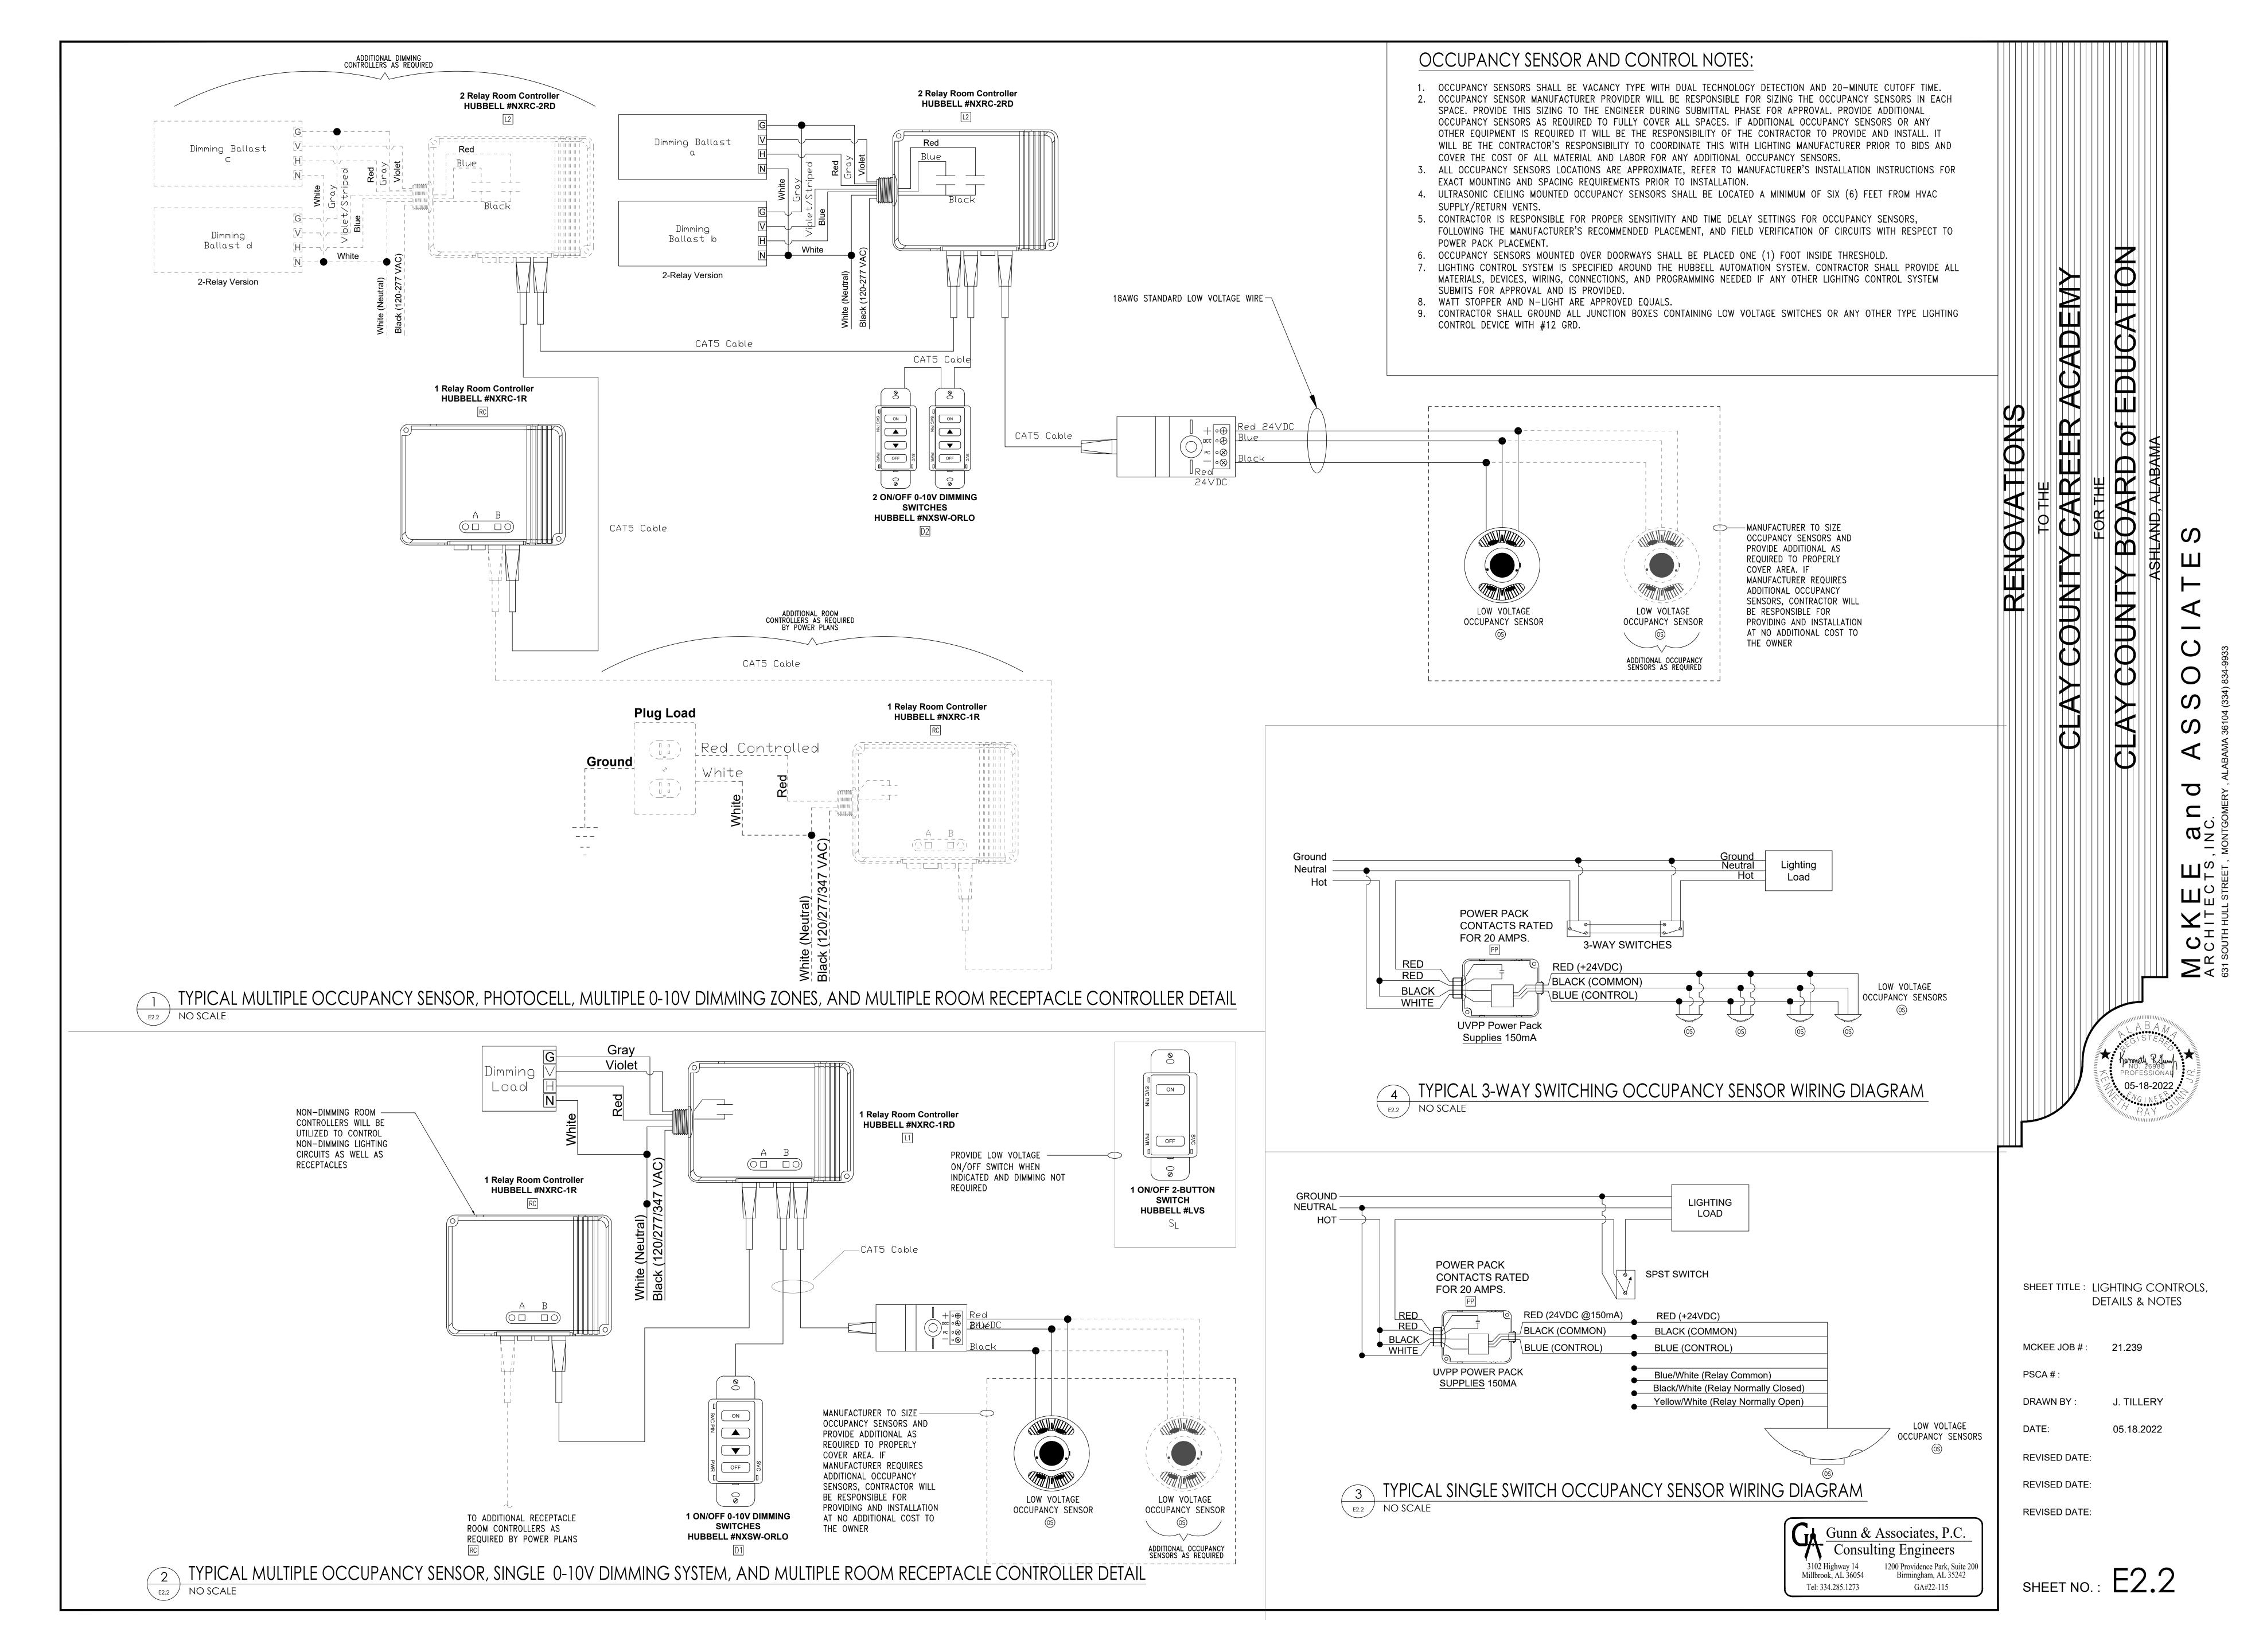
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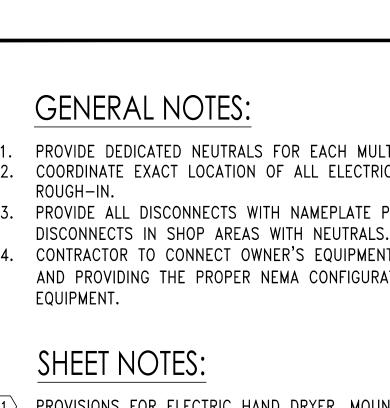
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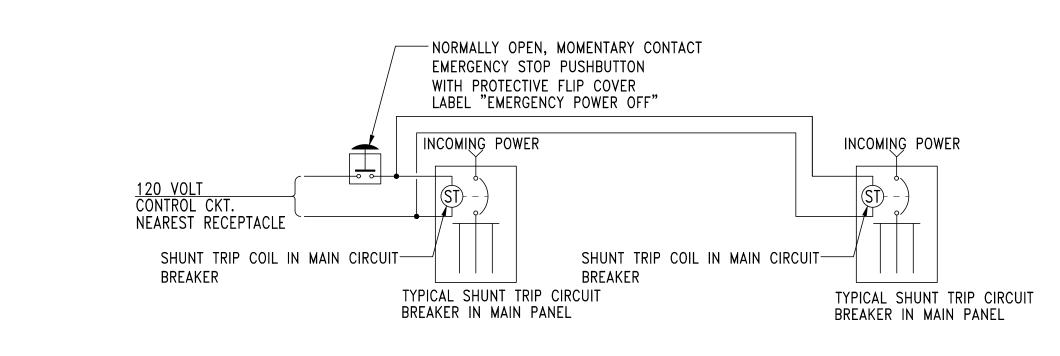
FLOOR PLAN - LIGHTING
SCALE: 1/8"=1'-0"




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- PROVIDE DEDICATED NEUTRALS FOR EACH MULTIWIRE HOMERUN PER NEC. 2. COORDINATE EXACT LOCATION OF ALL ELECTRICAL WITH MILLWORK PROVIDERS PRIOR TO
- 3. PROVIDE ALL DISCONNECTS WITH NAMEPLATE PER DETAIL (2) THIS SHEET. PROVIDE ALL
- 4. CONTRACTOR TO CONNECT OWNER'S EQUIPMENT. PROVIDE IN BASE BID THE COST OF FUSING AND PROVIDING THE PROPER NEMA CONFIGURATION RECEPTACLES TO CONNECT OWNER'S
- 1> PROVISIONS FOR ELECTRIC HAND DRYER. MOUNT JUNCTION BOX BEHIND PAPER TOWEL DISPENSER AND WALL BLANK OFF. CIRCUIT BREAKERS FEEDING CIRCUITRY SHALL BE SWITCHED OFF AND WIRE DISCONNECTED.
- $\overline{\langle 2 \rangle}$ EXISTING RECEPTACLE THAT HAS BEEN REPLACED ONE FOR ONE WITH NEW GFCI TYPE RECEPTACLE. CONTRACTOR SHALL INTERCEPT AND EXTEND EXISTING RECEPTACLE AS REQUIRED.
- $\overline{3}$ EXISTING RECEPTACLE THAT HAS BEEN REPLACED ONE FOR ONE WITH NEW WEATHERPROOF GFCI TYPE RECEPTACLE. CONTRACTOR SHALL INTERCEPT AND EXTEND EXISTING CIRCUITRY AS REQUIRED.
- 4 PROVIDE NEW 250A/3P SHUNT TRIP CIRCUIT BREAKER IN NEW MAIN PANEL MSA. PROVIDE 4#250KCMIL & 1#4GRD - 3"C.
- 5 PROVIDE POWER TO THE ELECTRIC STRIKE OF THE SECURE DOOR. PROVIDE CONDUIT AND LOW VOLTAGE CABLE TO CONTROL THE ELECTRIC STRIKE FROM A PUSHBUTTON STATION ON THE FRONT
- 6 PROVIDE 30' OF 120/240V DELTA, 3-PHASE, 4-WIRE, 100-AMP BUS DUCT SUSPENDED FROM CEILING. BUS DUCT TO PROVIDED WITH A MINIMUM 12 BUS PLUG OUTLETS AND THREE 30A/3P BUS PLUG DISCONNECTS AND ONE 60A/3P BUS PLUG OUTLETS EVENLY DISTRIBUTED ALONG BUS DUCT. ALUMINUM BUSSING IS ACCEPTABLE FOR THIS BUS DUCT.
- $\overline{\langle 7 \rangle}$ PROVIDE EMERGENCY POWER OFF SWITCH AND CONNECT TO THE MAIN SHUNT TRIP CIRCUIT BREAKER OF THE PANEL SERVING THIS AREA. PROVIDE LOW VOLTAGE CABLING IN CONDUIT AS REQUIRED.
- 8 PROVIDE EMERGENCY POWER OFF SWITCH AND CONNECT TO THE MAIN SHUNT TRIP CIRCUIT BREAKER OF THE PANEL SERVING THIS AREA AND 250A CIRCUIT BREAKER IN MSA SERVING WELDERS. PROVIDE LOW VOLTAGE CABLING IN CONDUIT AS REQUIRED.
- 9 PROVIDE ALUMINUM POWER POLE WITH TWO GFCI RECEPTACLES AT 18" AFF. MOUNT POWER POLE SUCH THAT IT IS SUPPORTED AT THE FLOOR AND AT THE CEILING. POWER POLE SHALL BE LONG ENOUGH TO GO FROM FLOOR TO ABOVE CEILING.




WIRING DIAGRAM - TYPICAL DUAL PANEL SHUNT TRIP "EPO" <u>3</u> E3.1



DETAIL - TYPICAL DISCONNECT NAMEPLATE

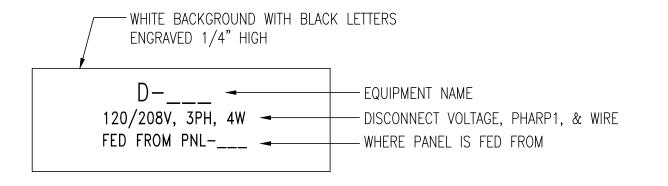TYPICAL NORMAL POWER NAMEPLATE

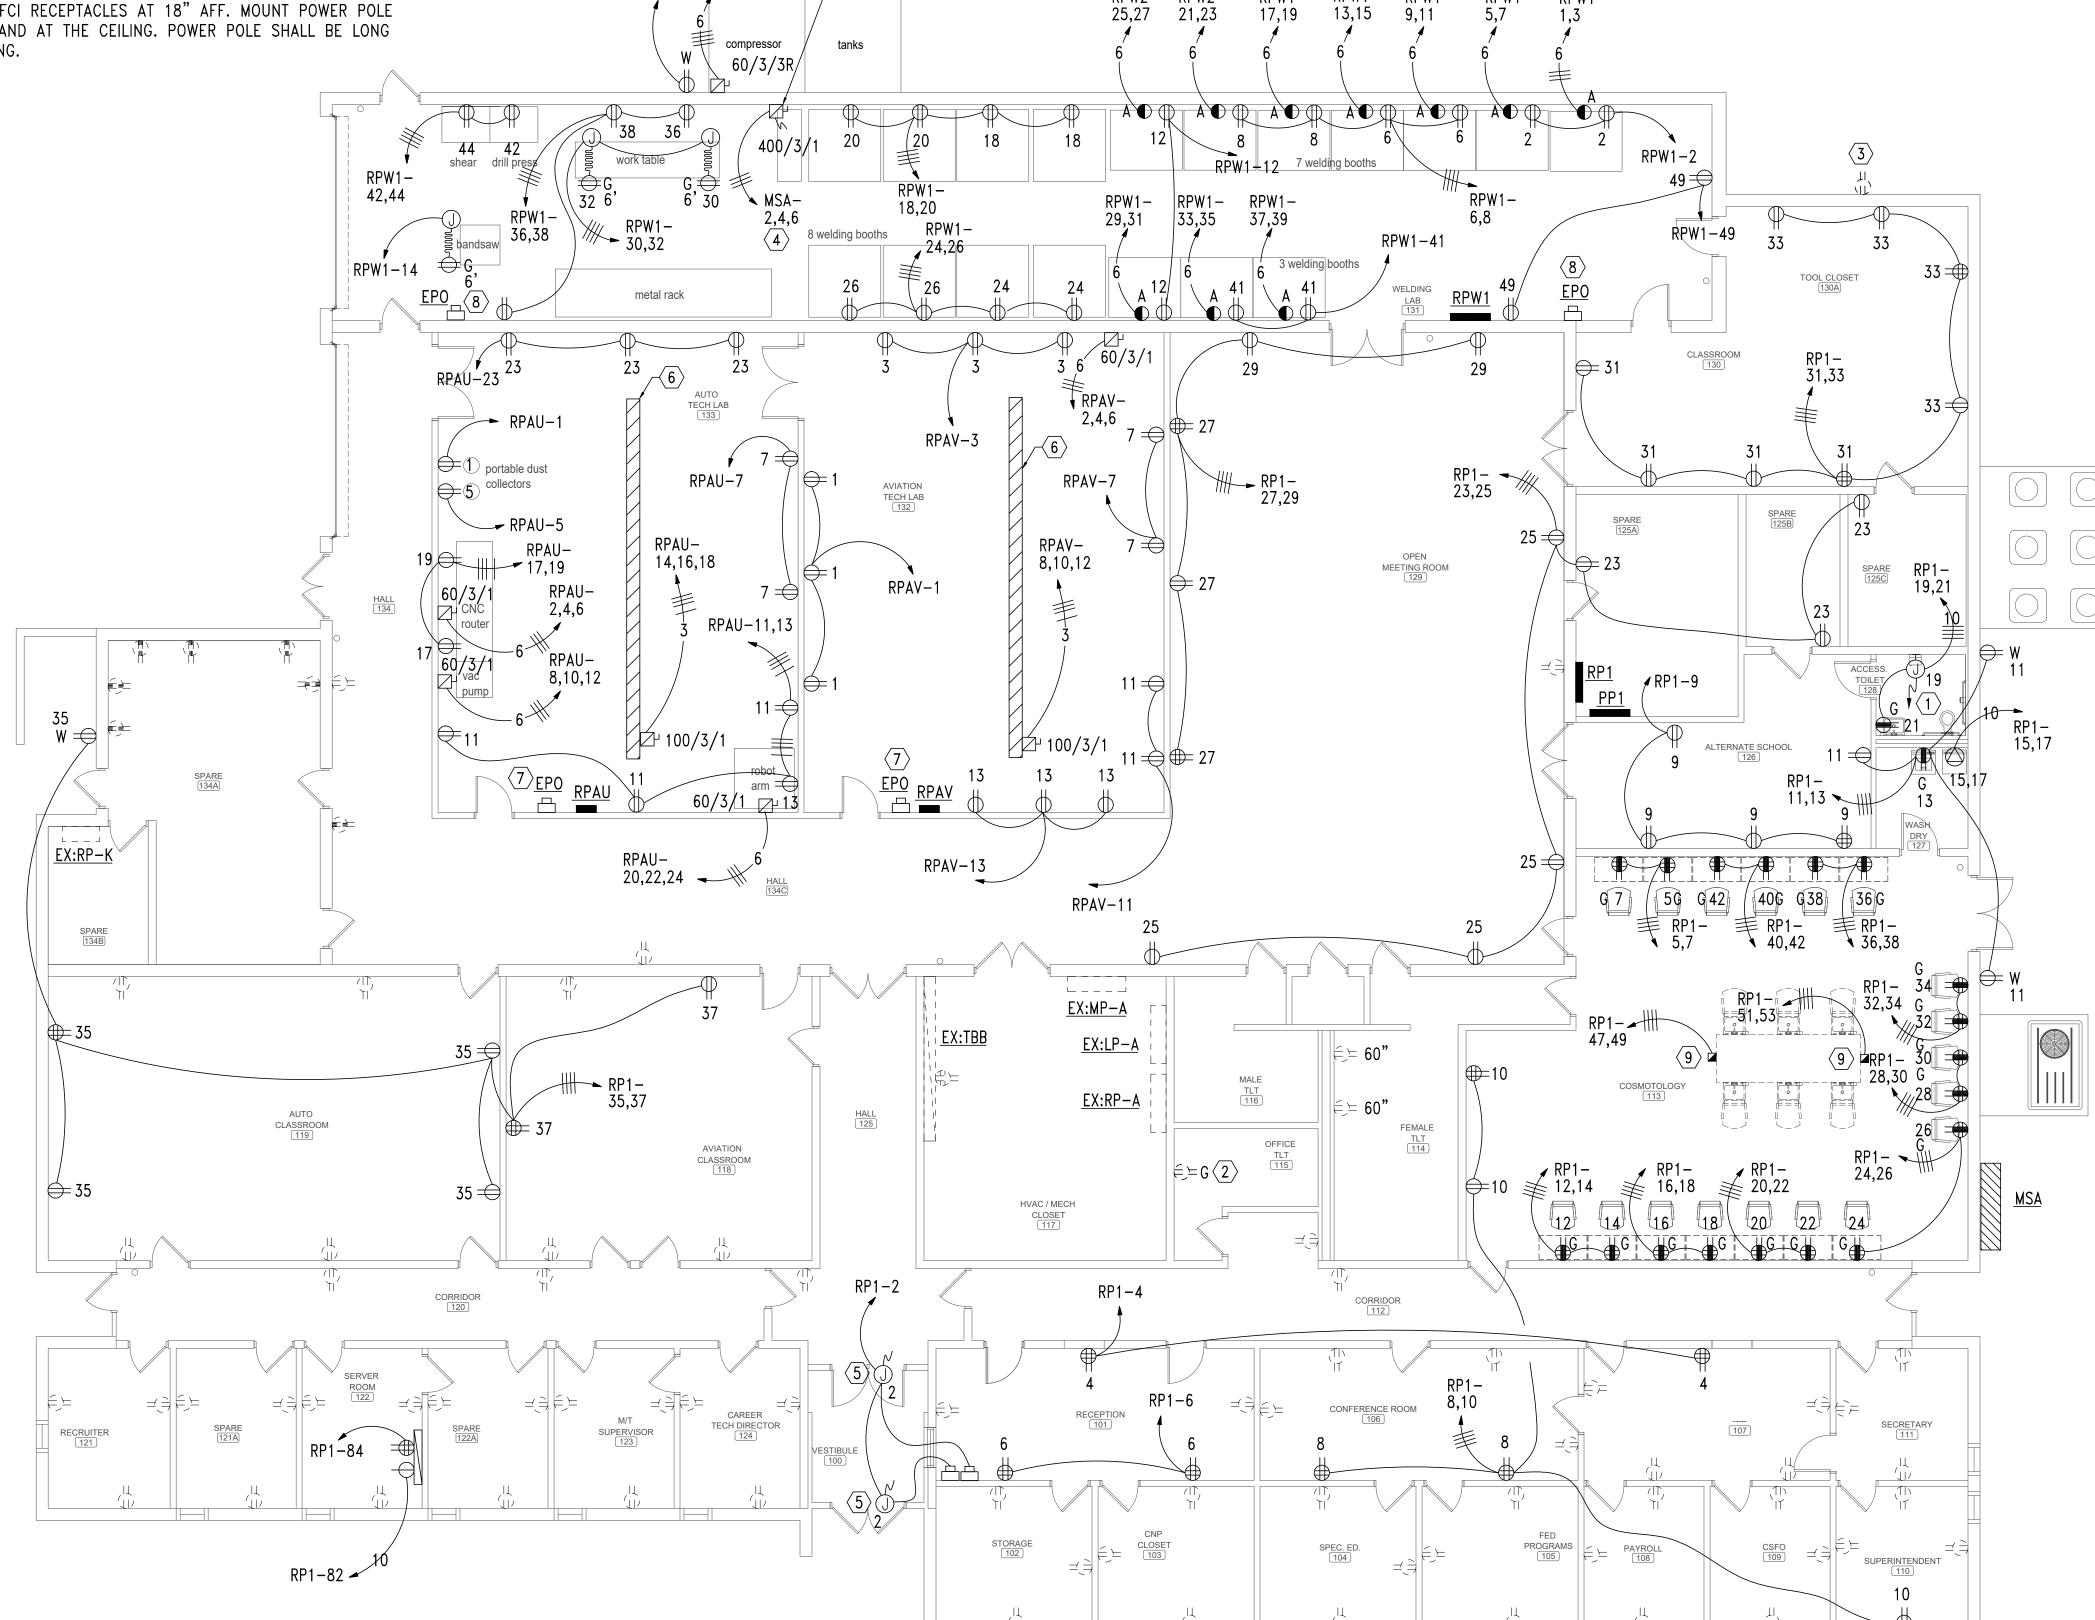

THIS WILL FEED 8 WELDING BOOTHS

RPW1-42

1/8" = 1'-0**GRAPHIC SCALE**

Gunn & Associates, P.C. Consulting Engineers

3102 Highway 14 Millbrook, AL 36054 Tel: 334.285.1273

1200 Providence Park, Suite 200 Birmingham, AL 35242 GA#22-115 SHEET NO.: E3.

SHEET TITLE: FLOOR PLAN - POWER

J. TILLERY

05.18.2022

MCKEE JOB #: 21.239

DRAWN BY

REVISED DATE:


REVISED DATE:

REVISED DATE:

FLOOR PLAN - POWER
SCALE: 1/8"=1'-0"




- 1. COORDINATE WITH MECHANICAL/PLUMBING DRAWINGS FOR EXACT LOCATIONS OF EQUIPMENT.
- 2. MOUNT EXTERIOR DISCONNECTS ON EXTERIOR WALLS AT LEAST 18" FROM WINDOWS. LOCATIONS OF DISCONNECTS AND EQUIPMENT ARE SHOWN FOR DRAWING CLARITY PURPOSES ONLY.
- 3. COORDINATE WITH MECHANICAL/PLUMBING CONTRACTORS TO INSURE OVERCURRENT PROTECTION DEVICES FOR THEIR EQUIPMENT IS SIZED PER MANUFACTURER'S RECOMMENDATIONS. ENGINEER SIZED OVERCURRENT PROTECTION ACCORDING TO MECHANICAL/PLUMBING DRAWINGS AND SPECIFICATIONS, ACTUAL EQUIPMENT SUPPLIED MAY DIFFER. ELECTRICAL CONTRACTOR SHALL WORK WITH OTHER TRADE
- DISCIPLINES TO INSURE ANY CHANGES WILL BE INSTALLED CORRECTLY AT THE COST OF THE PERSON MAKING
- 4. ALL FLEXIBLE CONNECT TO HVAC UNITS SHALL BE RUN PARALLEL TO HARD SURFACE AND STRAPPED AT LEAST EVERY 2'.
- 5. CONTRACTOR SHALL PROVIDE CONDUIT FOR MECHANICAL CONTROLS. COORDINATE EXACT LOCATIONS WITH MECHANICAL CONTRACTOR PRIOR TO ROUGH-IN.
- 6. ALL DISCONNECTS TO HAVE NAMEPLATE AS SHOWN IN DETAIL (2) THIS SHEET, NO EXCEPTIONS.
- 7. PROVIDE DEDICATED NEUTRALS FOR EACH MULTIWIRE HOMERUN PER NEC.
- 8. SEE DETAIL 1/E3.3 SHEET FOR MECHANICAL UNIT CONNECTION DETAIL.
- 9. COORDINATE WITH GENERAL EQUIPMENT SCHEDULE ON SHEET E3.3

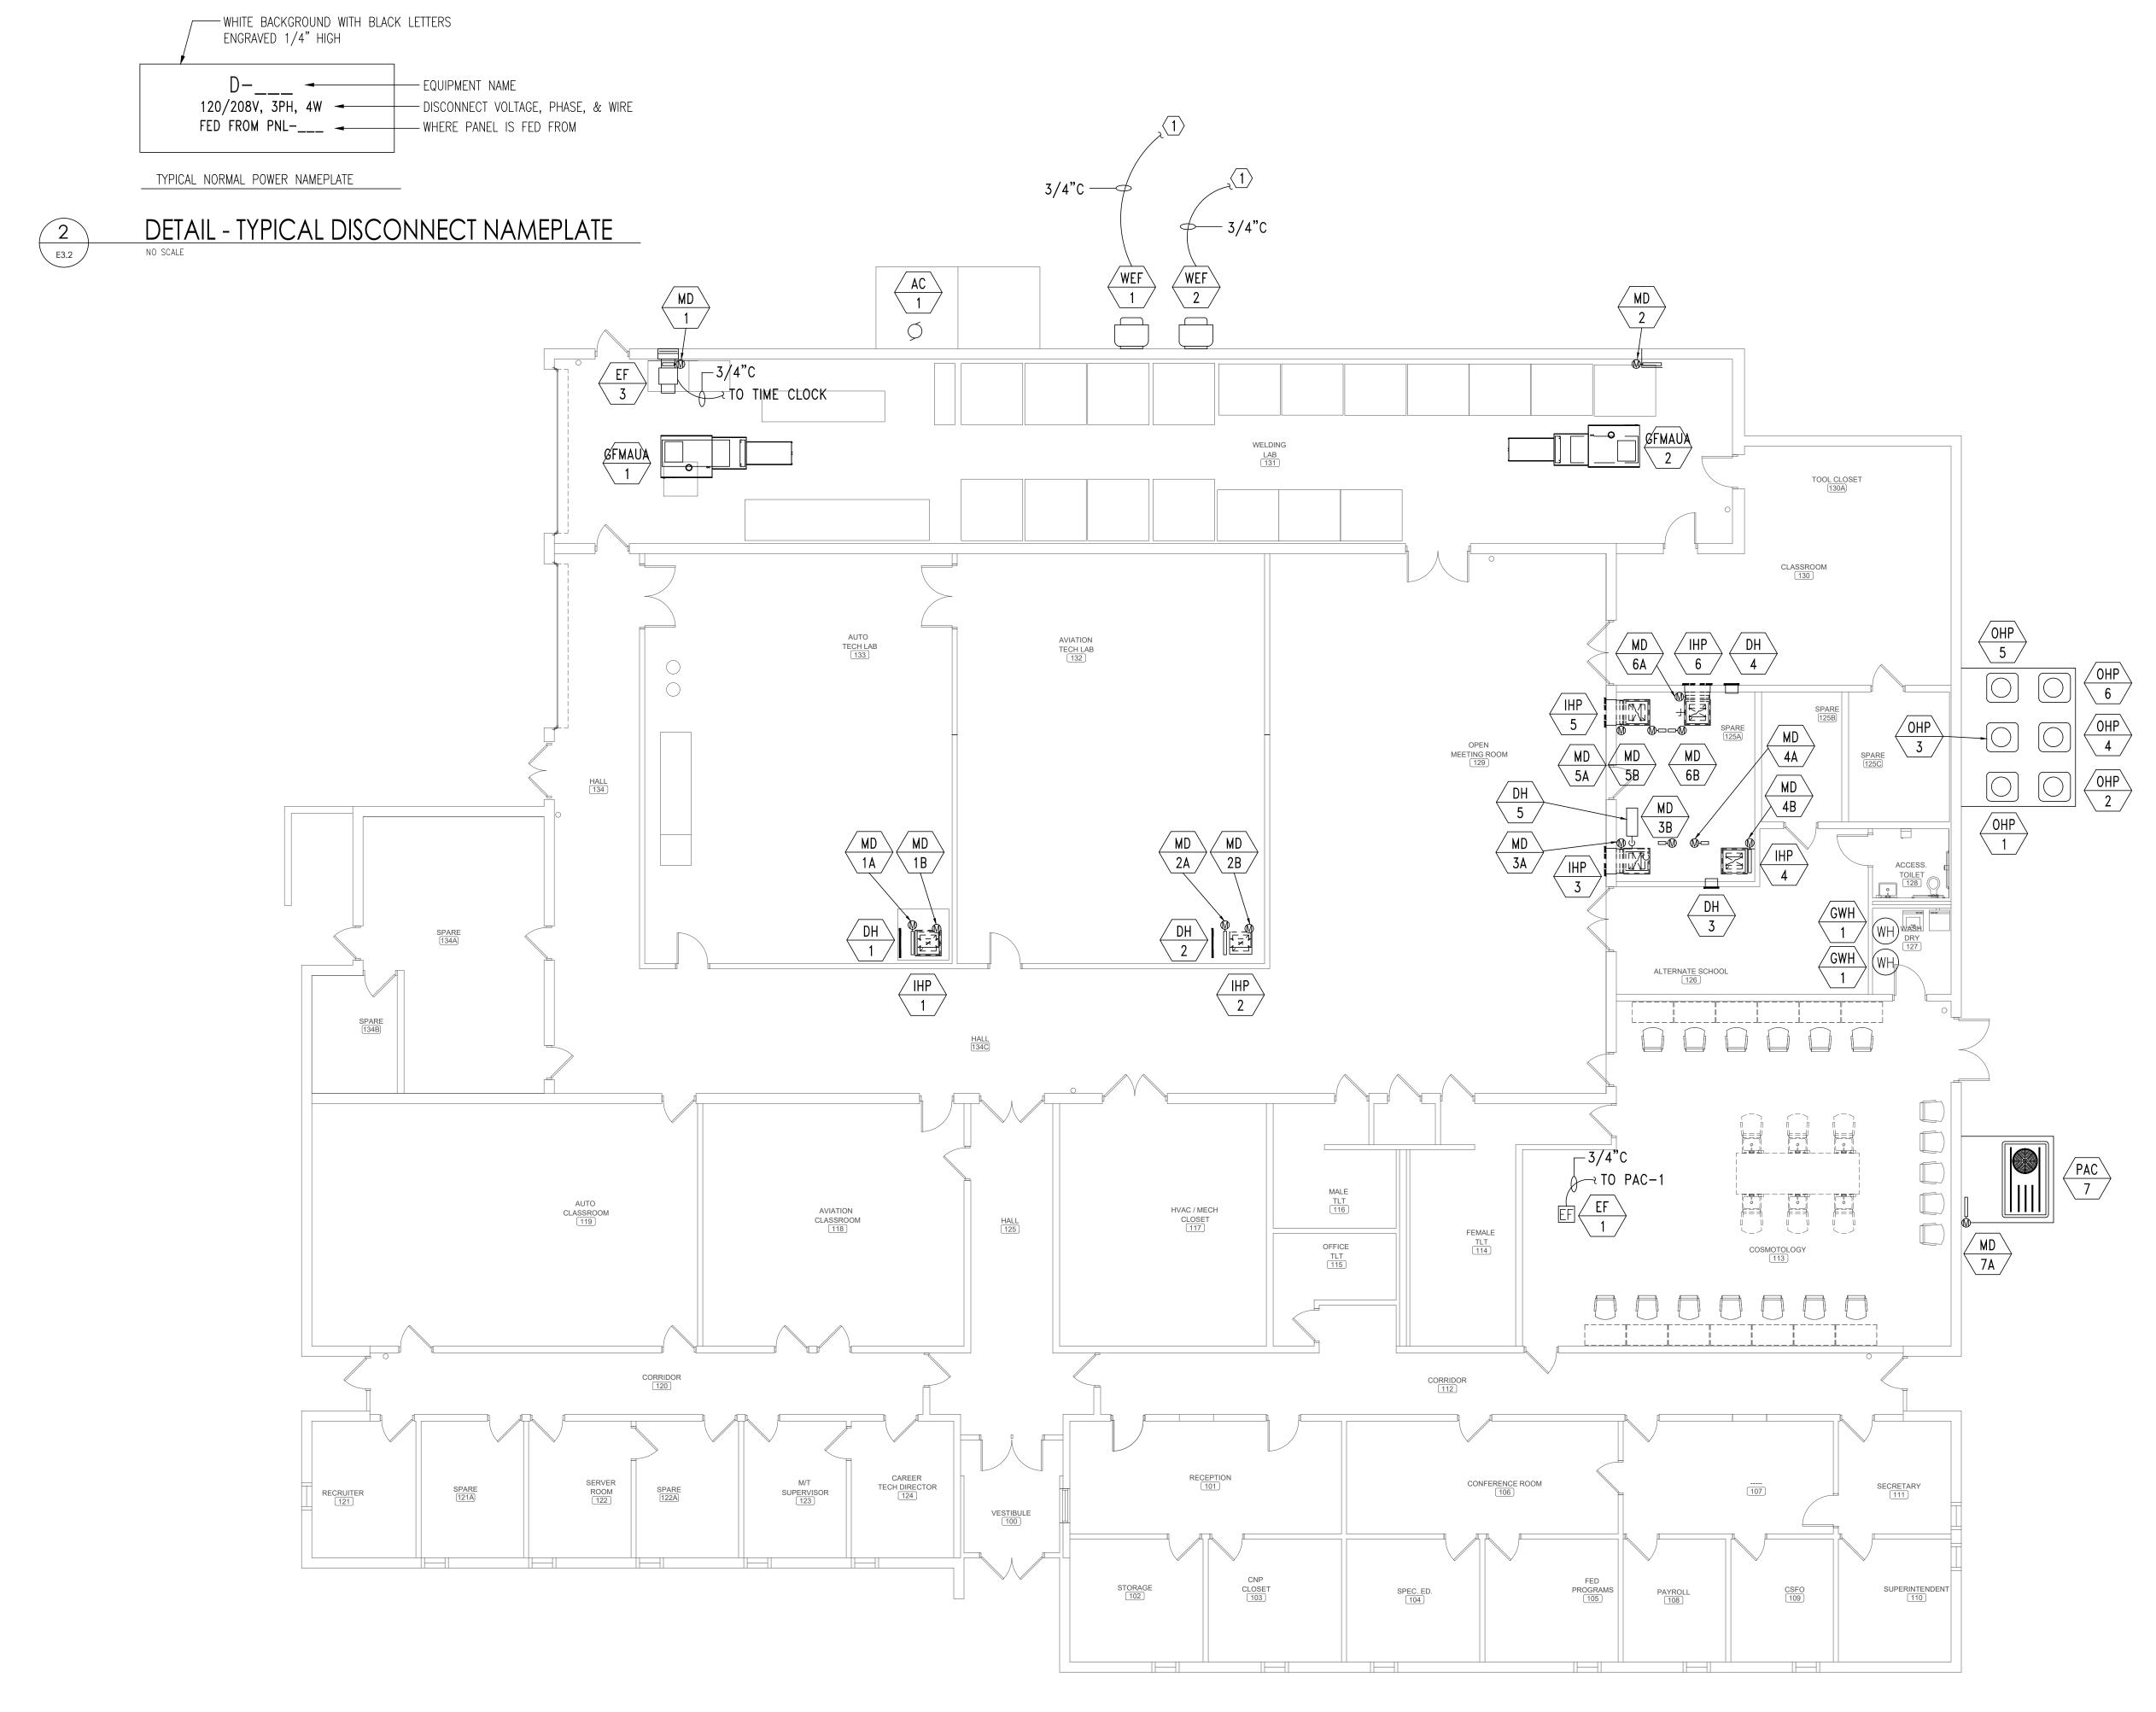

SHEET NOTES:

 $\langle 1 \rangle$ INTERLOCK WITH ASSOCIATED GAS FIRED MAKE UP UNIT AS REQUIRED.

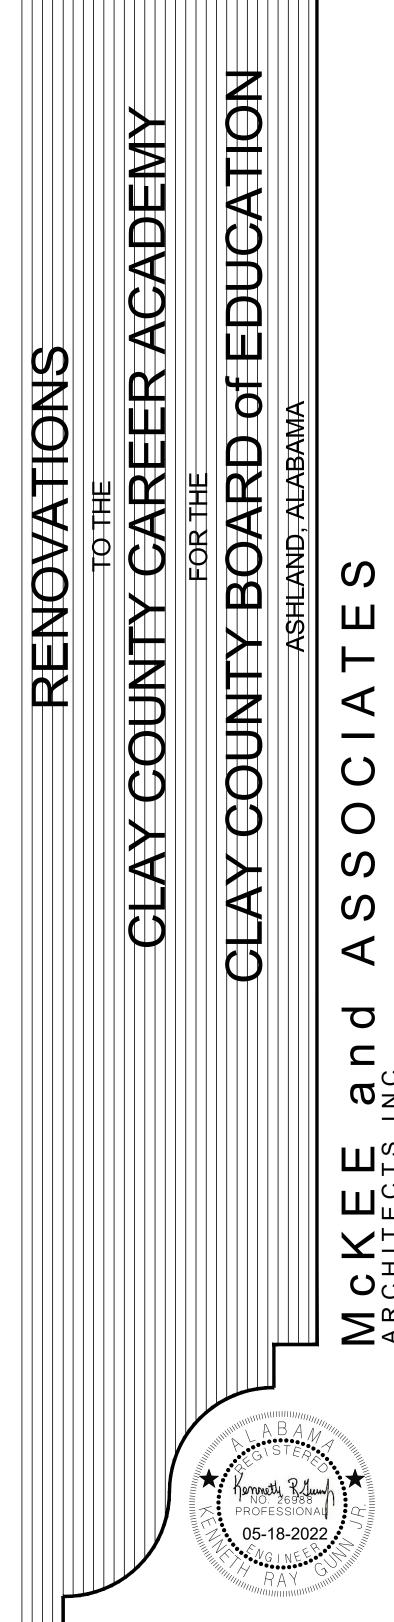

SHEET TITLE: FLOOR PLAN -MECHANICAL POWER

MCKEE JOB #: 21.239

PSCA#:

1/8" = 1'-0

GRAPHIC SCALE

Gunn & Associates, P.C.

Consulting Engineers

3102 Highway 14 Millbrook, AL 36054 Birmingham, AL 35242 Tel: 334.285.1273 GA#22-115

J. TILLERY DRAWN BY: 05.18.2022

REVISED DATE: REVISED DATE:

REVISED DATE:

SHEET NO.: **E3.2**

FLOOR PLAN - MECHANICAL POWER

SCALE: 1/8"=1'-0"

QUIPMENT MARK:	EQUIPMENT DESCRIPTION:	VOLTAGE/PHASE:	ELECTRICAL (CHARACTERISTIC	S:	DISCONNECT:	FUSE:	HOMERUN:	FEEDER:
			HP	KW	AMPS				
AC-1	AIR COMPRESSOR	240V/3PH	7 1/2			60/3/3R	F	MSA 19,21,23	3#6 & 1#10GRD - 1 1/4"C
EF-1	EXHAUST FAN	120V/1PH	1/4			TS		RP1 - 39	2#10 & 1#10GRD - 3/4"C
EF-3	EXHAUST FAN	120V/1PH	1/2			TS		RP1 - 41	2#10 & 1#10GRD - 3/4"C
WEF-1	EXHAUST FAN	240V/3PH	1 1/2			30/3/3R	F	PP1 - 25,27,29	3#10 & 1#10GRD - 3/4"C
WEF-2	EXHAUST FAN	240V/3PH	1 1/2			30/3/3R	F	PP1 - 31,33,35	3#10 & 1#10GRD - 3/4"C
GFMAU-1	ELECT. UNIT HEATER	240V/3PH	3			30/3/3R	F	PP1 - 20,22,24	3#10 & 1#10GRD - 3/4"C
GFMAU-1	ELECT. UNIT HEATER	240V/3PH	3			30/3/3R	F	PP1 - 26,28,30	3#10 & 1#10GRD - 3/4"C
MD-1,2,1A,1B,2A,2B	MOTORIZED DAMPER	120V/1PH		0.200		TS		PP1 - 37	2#12 & 1#12GRD - 3/4"C
MD-3A,3B,4A,4B,5A,5B	MOTORIZED DAMPER	120V/1PH		0.200		TS		PP1 - 39	2#12 & 1#12GRD - 3/4"C
MD-6A, 6B, 7A	MOTORIZED DAMPER	120V/1PH		0.200		TS		PP1 - 41	2#12 & 1#12GRD - 3/4"C
IHP-1	INDOOR HEAT PUMP	240V/3PH			50	60/3/1	F	PP1 - 1,3,5	3#6 & 1#10GRD - 1 1/4"C
IHP-2	INDOOR HEAT PUMP	240V/3PH			50	60/3/1	F	PP1 - 7,9,11	3#6 & 1#10GRD - 1 1/4"C
IHP-3	INDOOR HEAT PUMP	240V/3PH			50	60/3/1	F	PP1 - 13,15,17	3#6 & 1#10GRD - 1 1/4"C
IHP-4	INDOOR HEAT PUMP	240V/3PH			32	60/3/1	F	PP1 - 19,21,23	3#8 & 1#10GRD - 1 1/4"C
IHP-5	INDOOR HEAT PUMP	240V/3PH			32	60/3/1	F	PP1 - 25,27,29	3#8 & 1#10GRD - 1 1/4"C
IHP-6	INDOOR HEAT PUMP	240V/3PH			32	60/3/1	F	PP1 - 31,33,35	3#8 & 1#10GRD - 1 1/4"C
OHP-1	OUTDOOR HEAT PUMP	240V/3PH			18	30/3/3R	F	PP1 - 2,4,6	3#10 & 1#10GRD - 3/4"C
OHP-2	OUTDOOR HEAT PUMP	240V/3PH			18	30/3/3R	F	PP1 - 8,10,12	3#10 & 1#10GRD - 3/4"C
OHP-3	OUTDOOR HEAT PUMP	240V/3PH			18	30/3/3R	F	PP1 - 14,16,18	3#10 & 1#10GRD - 3/4"C
OHP-4	OUTDOOR HEAT PUMP	240V/3PH			17	30/3/3R	F	PP1 - 20,22,24	3#10 & 1#10GRD - 3/4"C
OHP-5	OUTDOOR HEAT PUMP	240V/3PH			13	30/3/3R	F	PP1 - 26,28,30	3#12 & 1#12GRD - 3/4"C
OHP-6	OUTDOOR HEAT PUMP	240V/3PH			13	30/3/3R	F	PP1 - 32,34,36	3#12 & 1#12GRD - 3/4"C
PAC-1	PACKAGED HEAT PUMP	240V/3PH			65	100/3/3R	F	EX:PNL SE" (NOTE 10)	3#4 & 1#8GRD - 1 1/2"C
GWH-1	ELEC. WATER HTR	120V/1PH		0.200		TS		RP1 - 43	2#12 & 1#12GRD - 3/4"C
GWH-2	ELEC. WATER HTR	120V/1PH		0.200		TS		RP1 - 45	2#12 & 1#12GRD - 3/4"C

. COORDINATE WITH MANUFACTURER'S CUTSHEETS OR NAMEPLATE DATA AND ADJUST OVERCURRENT PROTECTION AS NEEDED TO

PROTECT EQUIPMENT PER MANUFACTURER'S RECOMMENDATIONS AND TO COMPLY WITH NEC AND ALL LOCAL CODES. COORDINATION

SHALL BE DONE PRIOR TO BIDS AND ACCOUNTED FOR IN THE CONTRACTOR'S BID PRICE. 2. ALL DISCONNECTS SHALL BE HEAVY DUTY TYPE.

3. ALL FUSES SHALL BE SIZED PER NAMEPLATE DATA.

4. "NF" - NON-FUSED


5. "F" - FUSED 6. "TS" MANUAL MOTOR STARTER WITH THERMAL OVERLOAD ("W" - WEATHERPROOF) ("30-AMP" - 30-AMP RATED)

7. PROVIDE INTERCONNECTING RELAY SUCH THAT FAN IS CONTROLLED BY LIGHTING. 8. "WP" - WEATHERPROOF ENCLOSURE.

9. CONTRACTOR SHALL COORDINATE EXACT REQUIREMENTS AND LOCATIONS FOR ALL CIRCULATING PUMPS AND TIME CLOCKS WITH MECHANICAL CONTRACTOR PRIOR TO ROUGH-IN.


10. CONTRACTOR SHALL ADD (1) ONE NEW 70A/3P CIRCUIT BREAKER IN EXISING PANEL SE AS REQUIRED.

1. FOR DISTANCE GREATER THAN 48" CONDUIT TO BE ROUTED BELOW GRADE WITH 6" OF MECH. UNIT, STUB-UP W/ RIGID ELBOW THRU CONCRETE PAD. PROVIDE FLEXIBLE CONNECTION FROM ELBOW TO MECH. UNIT, W/ CONNECTION MADE AT UNIT AS SHOWN ABOVE.

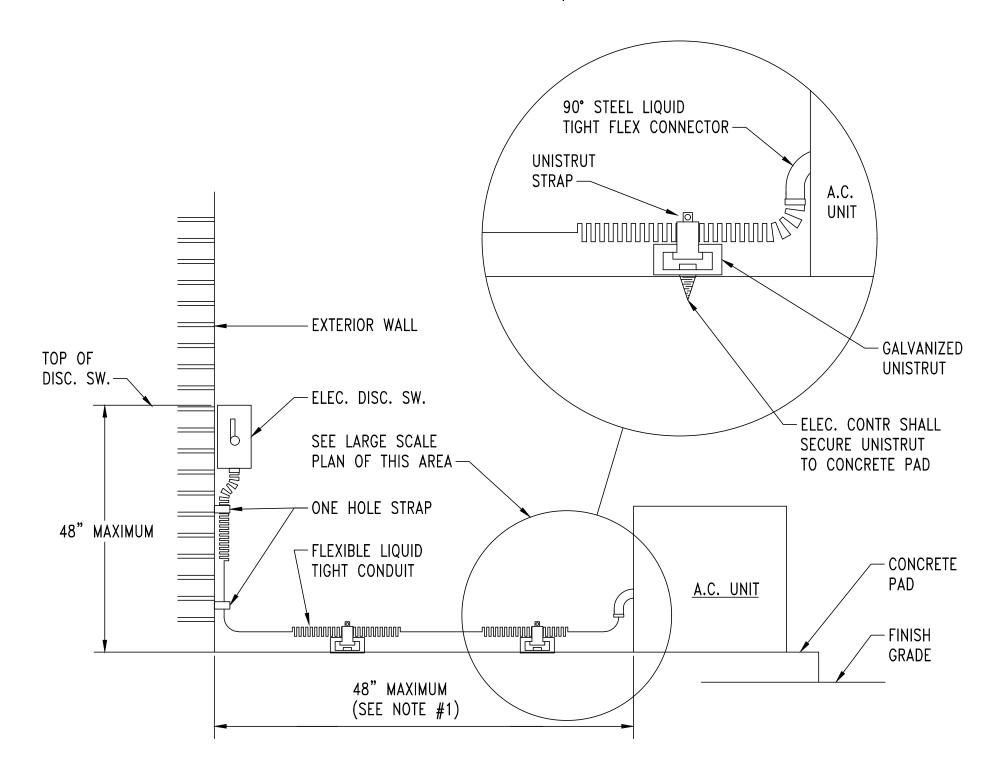

MECHANICAL UNIT CONNECTION DETIAL

NO SCALE

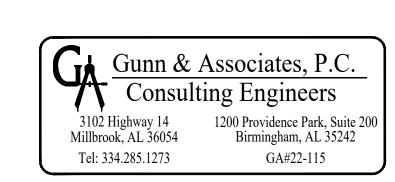

COUNTY BOARD of EDUCATION
ASHLAND, ALABAWA Y COUNTY CAREER ACADEMY
FOR THE OCIATES 0

SHEET TITLE: GENERAL EQUIPMENT SCHEDULE & DETAILS

MCKEE JOB #: 21.239


PSCA#:

J. TILLERY DRAWN BY: 05.18.2022

REVISED DATE: REVISED DATE:

REVISED DATE:

SHEET NO.: **E3.3**

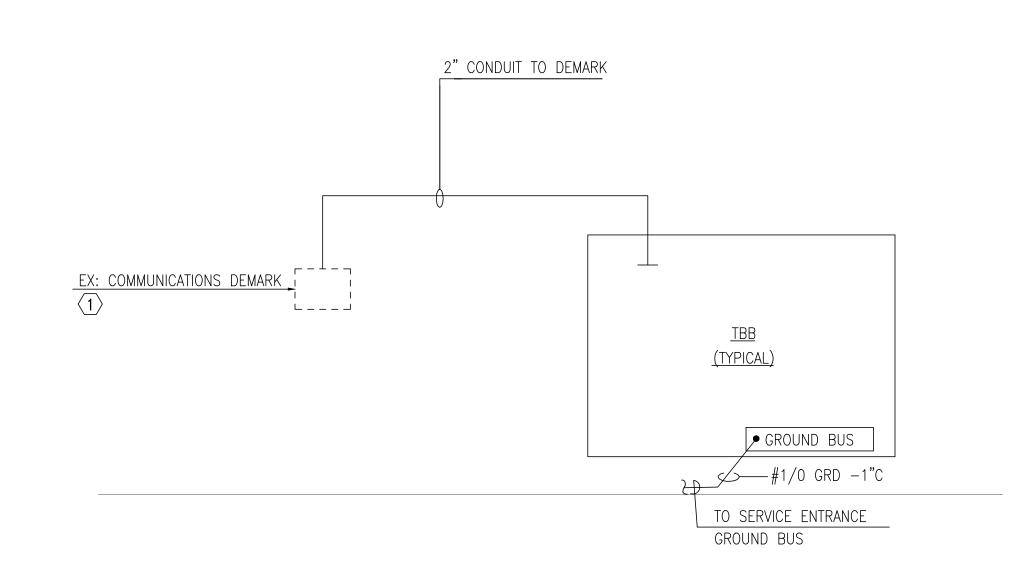

COMMUNICATIONS RISER DIAGRAM


NO SCALE

COMMUNICATION NOTES:

- 1. PROVIDE 5/8" STRUT ASSEMBLY AT TOP AND BOTTOM OF TBB TO SUPPORT ALL CONDUITS TERMINATING AT BACKBOARD.
- 2. TBB SHALL BE 3/4" PLYWOOD EXTERIOR RATED AND CUT TO COVER ALL WALLS OR AS INDICATED. PAINT WITH TWO COATS OF FIRE RETARDENT PAINT. MOUNT 2' AFF.
- 3. PROVIDE A PLASTIC BUSHING OR PROTECTIVE COLLAR AT EACH CONDUIT TERMINATION, INCLUDING
- TERMINATIONS ABOVE THE CEILING, AT CABLE TRAY, OR AT TBB.


 4. ALL CONDUIT TERMINATIONS SHOULD BE DONE EVENLY AT THE TOP AND BOTTOM OF TBB.
- TERMINATIONS SHALL BE MADE WITHIN THE FIRST FEW INCHES OF THE TBB.

 5. SEAL ALL CONDUITS FROM THE EXTERIOR WITH A SEALING COMPOUND, ONCE ALL CABLING HAS
- BEEN INSTALLED.
 6. PROVIDE GROUND BUS FOR EACH TBB. SEE GROUND BUS INSTALLATION DETAIL.
- 7. PROVIDE ALL CONDUITS WITH PULLWIRES. 8. STENCIL ALL JUNCTION BOX COVERS ABOVE THE CEILING WITH 2" LETTERS THAT READ "COMM".

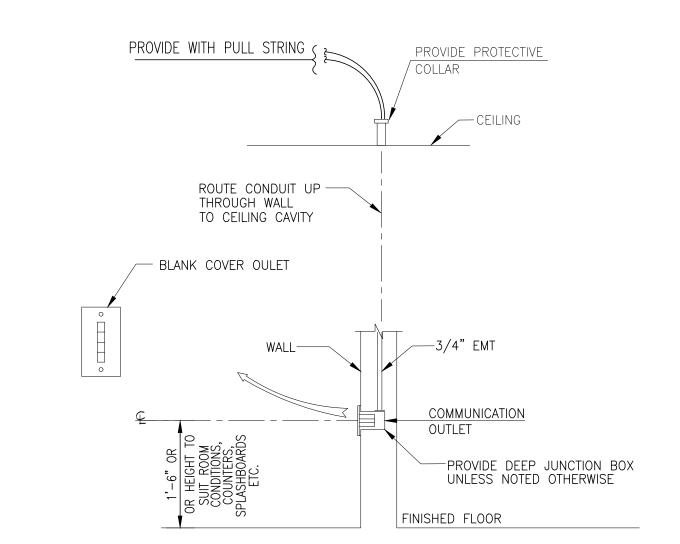

DETAIL - TYPICAL COMMUNICATION OUTLET " \(\nabla '' \)

NO SCALE

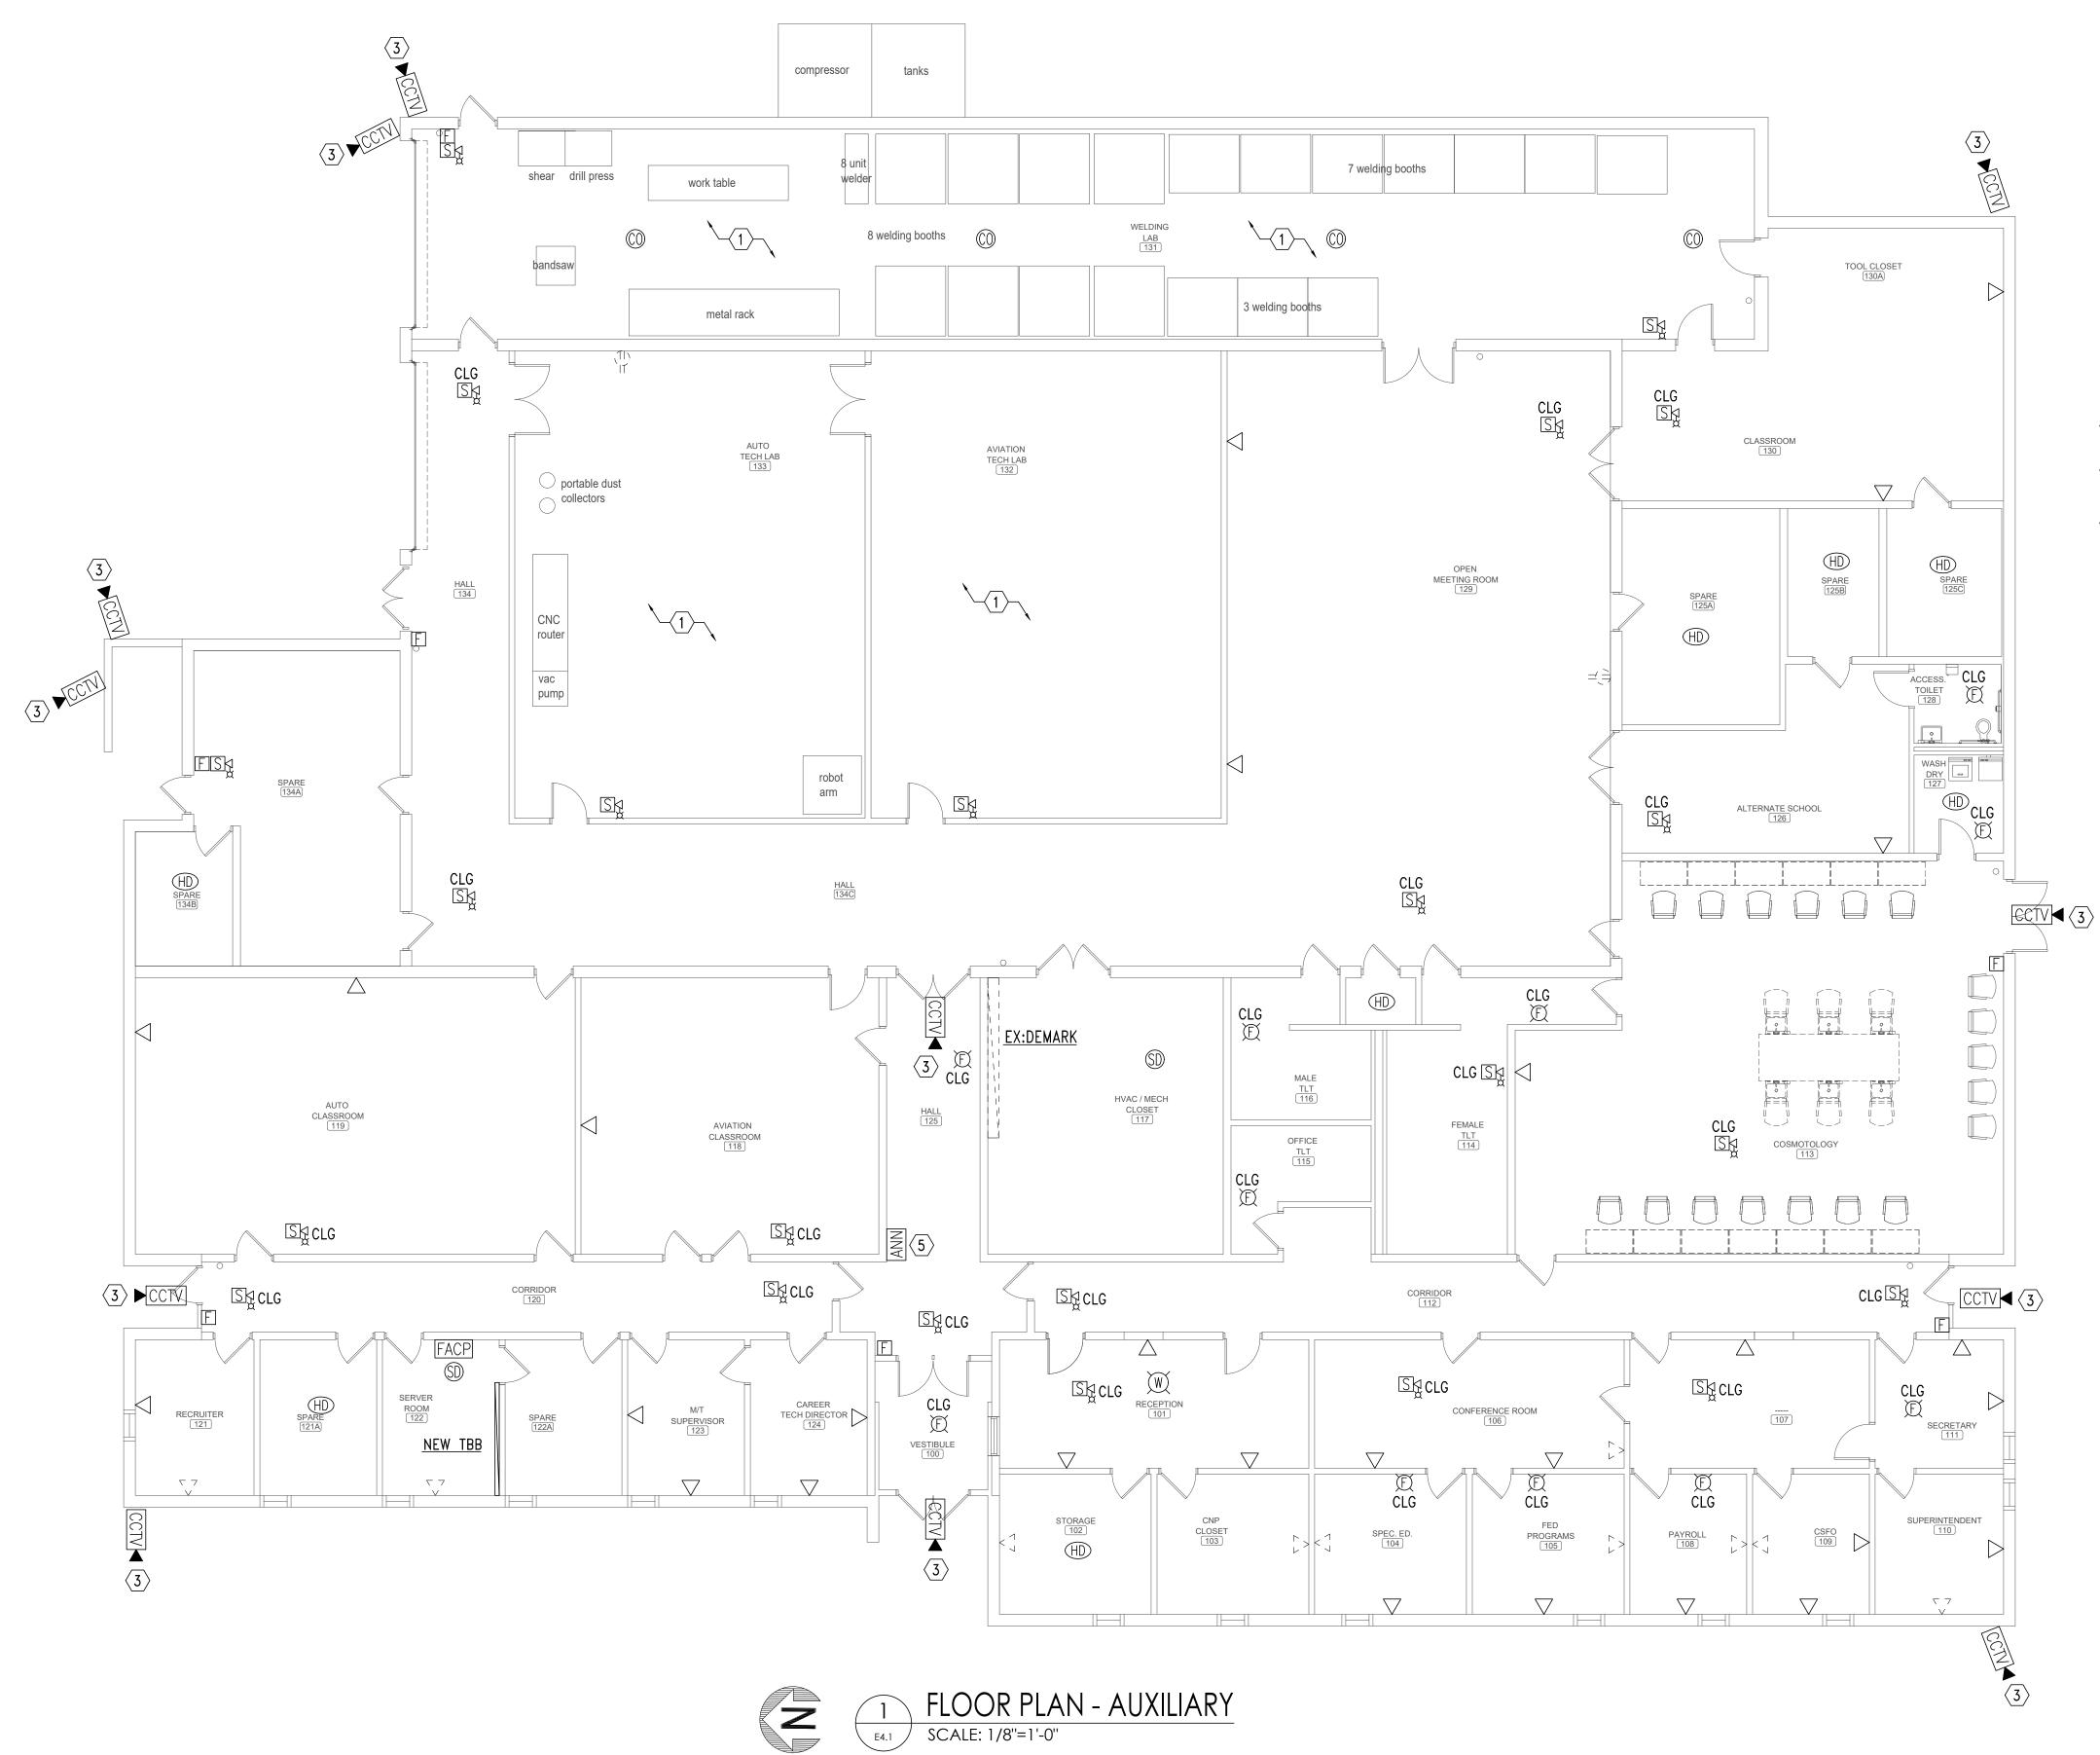

GENERAL NOTES:

- 1. ALL CONDUIT SHALL STUB ABOVE ACCESSIBLE CEILING. PROVIDE PROTECTIVE PLASTIC COLLAR AT STUB AND PULLSTRING.
- 2. COORDINATE AND MOUNT COMMUNICATIONS OUTLETS WITHIN 6" OF CORRESPONDING POWER RECEPTACLE.
- 3. COORDINATE ALL AUXILIARY SYSTEMS WITH THEIR CORRESPONDING RISER DIAGRAMS.

SHEET NOTES:

- 1 PROVIDE WIREGUARDS TO PROTECT ALL FIRE ALARM DEVICES IN THIS ROOM.
- COORDINATE WITH COMMUNICATIONS PROVIDER AND PROVIDE CONDUITS TO THE SERVICE PROVIDER AT THE ROAD RIGHT OF WAY.
- PROVIDE JUNCTION BOX WITH 1/2" CONDUIT STUBBED INTO BUILDING FOR OWNER PROVIDED

SHEET TITLE: FLOOR PLAN - AUXILIARY

O

MCKEE JOB #: 21.239

PSCA#:

1/8" = 1'-0

GRAPHIC SCALE

Gy Gunn & Associates, P.C.
Consulting Engineers

3102 Highway 14 Millbrook, AL 36054 Tel: 334.285.1273

1200 Providence Park, Suite 200 Birmingham, AL 35242

GA#22-115 DRAWN BY: J. TILLERY

DATE: 05.18.2022

REVISED DATE:

REVISED DATE:

SHEET NO.: E4.1

		LIGHTING	FIYTUR	F SCHI	FDIII F	
		LIGITING			LDOLL	
				LAMP	LAMP	
TYPE:	MANUFACTURER NUMBER AND EQUALS:	VOLTAGE:	MOUNTING:	TYPE:	QUANTITY:	DESCRIPTION:
D1	PRESCOLITE NO. LTR-6ED-H-ML-DM1-LV-EMR-XL-40K-8-WD OR PRIOR APPROVED EQUAL BY WILLIAMS OR COOPER	MVOLT	RECESSED	LED	3000 LUMEN	6 INCH 3000 LUMEN LED DOWNLIGHT 4000K TEMPETURE LAMPS AND FEATURE REMOTE PHOSPHOR TECHNOLOGY ENABLING A HIGH SYSTEM EFFICACY AND MINIMUM 80 CRI. 0-10V DIMMING
DS2	ZUMTOBEL NO. ONDA2M - AS - X - OL - HE - K940 - DR - BK - DU - EM	MVOLT	SURFACE	LED	3000 LUMEN	24 INCH 3000 LUMEN LED DOWNLIGHT 4000K TEMPETURE LAMPS AND FEATURE REMOTE PHOSPHOR
	OR PRIOR APPROVED EQUAL BY HUBBELL OR COOPER					TECHNOLOGY ENABLING A HIGH SYSTEM EFFICACY AND MINIMUM 80 CRI. WET LOCATION
LG48	HUBBELL NO. SRP24-40ML-EDU	MVOLT	RECESSED	LED	5000 LUMEN	2'X4' 4800-LUMEN FLAT PANEL FIXTURE.
	OR EQUALS BY WILLIAMS, PARKER, OR COOPER					PROVIDE 0-10 DIMMING.
LG60	HUBBELL NO. SRP24-40HL-EDU	MVOLT	RECESSED	LED	6000 LUMEN	2'X4' 6000-LUMEN FLAT PANEL FIXTURE.
	OR EQUALS BY WILLIAMS, PARKER, OR COOPER					PROVIDE 0-10 DIMMING.
LG72	HUBBELL NO. SRP24-40VL-EDU	MVOLT	RECESSED	LED	7200 LUMEN	2'X4' 7200-LUMEN FLAT PANEL FIXTURE.
	OR EQUALS BY WILLIAMS, PARKER, OR COOPER					PROVIDE 0-10 DIMMING.
LS1	HUBBELL NO. LCL-2-40K-ML-E-MVOLT-WIREGUARD	MVOLT	WALL	LED	2850 LUMEN	SURFACE MOUNTED 2'-0" LED STRIP WITH WIREGUARD.
	OR EQUALS BY WILLIAMS, PARKER, OR COOPER		WELDING BOOTH			CHAIN HANG WHEN SURFACE MOUNT IS NOT POSSIBLE. PROVIDE 0-10 DIMMMING.
LS2	HUBBELL NO. LCL-4'-4000K-ML-E-U	MVOLT	SURFACE OR	LED	5300 LUMEN	SURFACE MOUNTED 4'-0" LED STRIP.
	OR EQUALS BY WILLIAMS, PARKER, OR COOPER		CHAIN HUNG			CHAIN HANG WHEN SURFACE MOUNT IS NOT POSSIBLE. PROVIDE 0-10 DIMMMING.
LS3	HUBBELL NO. LCL-4-40K-HL-E-MVOLT-CSHC-WIREGUARDS IN SHOP	MVOLT	SURFACE OR	LED	6400 LUMEN	SURFACE MOUNTED 4'-0" LED STRIP. WIREGUARD IN SHOPS
	OR EQUALS BY WILLIAMS, PARKER, OR COOPER		CHAIN HUNG			CHAIN HANG WHEN SURFACE MOUNT IS NOT POSSIBLE. PROVIDE 0-10 DIMMMING
LS4	LITE PRO NO. RLB4-40LV-FAMED1U WITH CM48SLF3-KIT WIREGUARDS IN SHOP	MVOLT	SURFACE OR	LED	9507 LUMEN	SURFACE MOUNTED 4'-0" LED STRIP. WIREGUARD IN SHOPS
	OR EQUALS BY WILLIAMS, PARKER, OR COOPER		CHAIN HUNG			CHAIN HANG WHEN SURFACE MOUNT IS NOT POSSIBLE. PROVIDE 0-10 DIMMMING PROVIDE 4' AIRCTRAFT CABLE WITH 3 WIRES.
						FROUDL 4 AINCHAIT GABLE WITH 3 WIKES.
WP1	HUBBELL NO. QSP-30L-4000K-053-TYPE β-U-COLOR BY ARCH - SCP-20F OR EQUALS BY WILLIAMS, PARKER, OR COOPER	MVOLT	WALL	LED	5700 LUMEN	DARK BRONZE EXTERIOR LED LIGHT.
	OR EQUALS BY WILLIAMS, PARKER, OR COOPER					UL LISTED FOR WET LOCATIONS.
EM	LITHONIA NO. ELMLT - MVOLT - EHO - SD - WIREGUARDS IN SHOP	MVOLT	WALL	LED	WITH	1000 LUMEN LED EMERGENCY WALL PACK
WALL PACK	OR PRIOR APPROVED EQUAL BY EMERGI-LITE, MCPHILBEN, OR PRESCOLITE				UNIT	
FACK	EWEKOFETTE, WOTTHEBEN, OKT NEGOGETTE					
EXIT	LITHONIA NO. LQM - W - 120/277 - ELNSD - WIREGUARDS IN SHOPS	MVOLT	UNIVERSAL	LED	LED	THERMOPLASTIC 1,000-LUMEN COMBO LED EXIT SIGN EGRESS LIGHT. PROVIDE WITH NUMBER OF FACES AND DIRECTIONAL
SIGN	OR PRIOR APPROVED EQUAL BY EMERGI-LITE, MCPHILBEN, OR PRESCOLITE					ARROWS AS SHOWN ON DRAWINGS. COORDINATE COLOR OF SIGNAGE WITH LOCAL REQUIREMENTS. PROVIDE WITH EMERGENCY BATTERY.
						REGULERTO. HOVIDE WITH EMEROEIROT DATTERT.
EXIT	LITHONIA NO. LHQM-S-W-3-R-HO-LP06VS - WIREGUARDS IN SHOP	MVOLT	UNIVERSAL	LED	1000 LUMEN	THERMOPLASTIC 1000-LUMEN COMBO LED EXIT SIGN EGRESS LIGHT. PROVIDE WITH NUMBER OF FACES AND DIRECTIONAL
SIGN	OR PRIOR APPROVED EQUAL BY EMERGI-LITE, MCPHILBEN, OR PRESCOLITE					ARROWS AS SHOWN ON DRAWINGS. COORDINATE COLOR OF SIGNAGE WITH LOCAL REQUIREMENTS. PROVIDE WITH EMERGENCY BATTERY. PROVIDE WIREGUARDS IN GYM.
"XB"						

COMcheck Software Version 4.1.5.1 Interior Lighting Compliance Certificate Project Information 90.1 (2013) Standard **Energy Code:** RENOVATIONS TO THE CLAY COUNTRY CAREER TECH Project Title: Project Type: Construction Site: Owner/Agent: Designer/Contractor: MCKEE & ASSOCIATES GUNN & ASSOCIATES MILLBROOK, AL Allowed Interior Lighting Power Allowed Watts Area Category Floor Area Watts / ft2 (B X C) (ft2) 1-CAREER TECH (Common Space Types:Classroom/Lecture/Training) Proposed Interior Lighting Power Fixture ID : Description / Lamp / Wattage Per Lamp / Ballast Lamps/ # of Fixture (C X D) 1-CAREER TECH (Common Space Types:Classroom/Lecture/Training) LG48 & LS2: Other: LG60 & LS3: Other: 76 76 5776 LG72: Other: D1: Other: Interior Lighting Compliance Statement Compliance Statement: The proposed interior lighting design represented in this document is consistent with the building plans specifications, and other calculations submitted with this permit application. The proposed interior lighting systems have been designed to meet the 90.1 (2013) Standard requirements in COMPACK Version 4.1.5.1 and to comply with any applicable

LUMINAIRE NOTES:

COMPLETE UL LISTED INSTALLATION

ETC. DURING SHOP DRAWING REVIEW.

DIFFERENT TYPE BATTERY SEE SCHEDULE.

ARCHITECTURAL REFLECTED CEILING PLANS.

OR DIMMING CONTROL SYSTEM PROVIDED.

1. ALL LUMINAIRES AND INSTALLATION SHALL BE IN ACCORDANCE WITH NEC, NFPA AND LOCAL CODES. ALL

2. LUMINAIRES SHALL BE FURNISHED COMPLETE WITH THE PROPER LAMP BASE OR PIN RECEPTORS, WIRING COMPONENTS, LAMPS, SUPPORTING FRAMES AND DEVICES, ETC., FOR A COMPLETE INSTALLATION. 3. ALL LUMINAIRE DEVICES, COMPONENTS, FITTINGS, SUPPORTS, ETC., SHALL BE COORDINATED TO PROVIDE A

4. ALL LUMINAIRES BALLAST, DRIVERS, LAMPS, ETC SHALL BE COMPATIABLE WITH THE LIGHTING CONTROL SYSTEM

5. SECURE EACH LAY-IN LUMINAIRE AT TWO LOCATIONS TO THE CEILING GRID. PROVIDE BOLTS, SCREWS, RIVETS

7. ALL LED LUMINARIES SHALL BE PROVIDED WITH 4000K COLOR TEMPERATURE LAMPS, UNLESS NOTED OTHERWISE.

8. ARCHITECT RESERVES THE RIGHT TO SELECT ALL COLORS FOR LUMINAIRES, POLES, MOUNTING ACCESSORIES,

10. ALL EXIT SIGNS AND LUMINAIRES DESIGNATED AS EMERGENCY SHALL BE PROVIDED WITH A MINIMUM 1100 LUMEN EMERGENCY BATTERY BALLAST CAPABLE OF 90 MINUTES OF ILLUMINATION. X DESIGNATION MEANS

11. CONTRACTOR SHALL PROVIDE ALL SLOPE ADAPTERS, FLANGE KITS, TRIMS, AND ALL OTHER MOUNTING ACCESSORIES AS NEEDED TO MOUNT EACH LUMINAIRE IN CEILINGS AS SHOWN. COORDINATE WITH

6. ALL LUMINAIRES IN MECHANICAL AND ELECTRICAL ROOMS SHALL BE INSTALLED TO CLEAR ELECTRICAL

EQUIPMENT, DUCT, PIPING, ETC., SUSPEND BELOW OBSTRUCTION WHEN CONFLICTS OCCUR.


9. COORDINATE LUMINAIRE MOUNTING WITH ARCHITECTURAL ELEVATIONS PRIOR TO INSTALLATION.


LUMINAIRES SHALL BE UL LISTED AND INSTALLED IN ACCORDANCE WITH THE UL LISTING.

OR APPROVED CLIPS FOR USE WITH THE TYPE CEILING AND LUMINAIRE INSTALLED.

12. PROVIDE ALL EXIT SIGNS WITH DIRECTIONAL ARROWS AS SHOWN ON DRAWINGS.



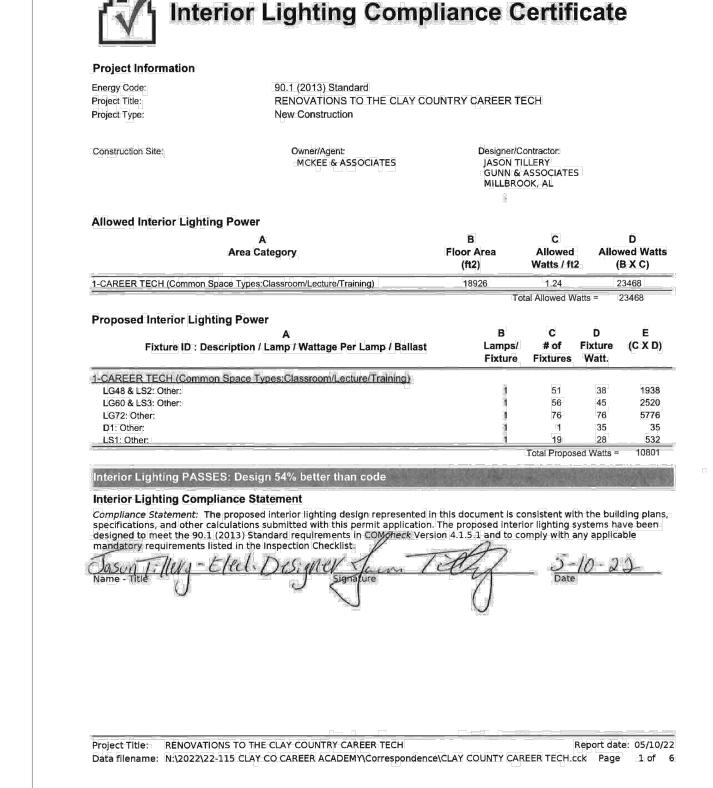

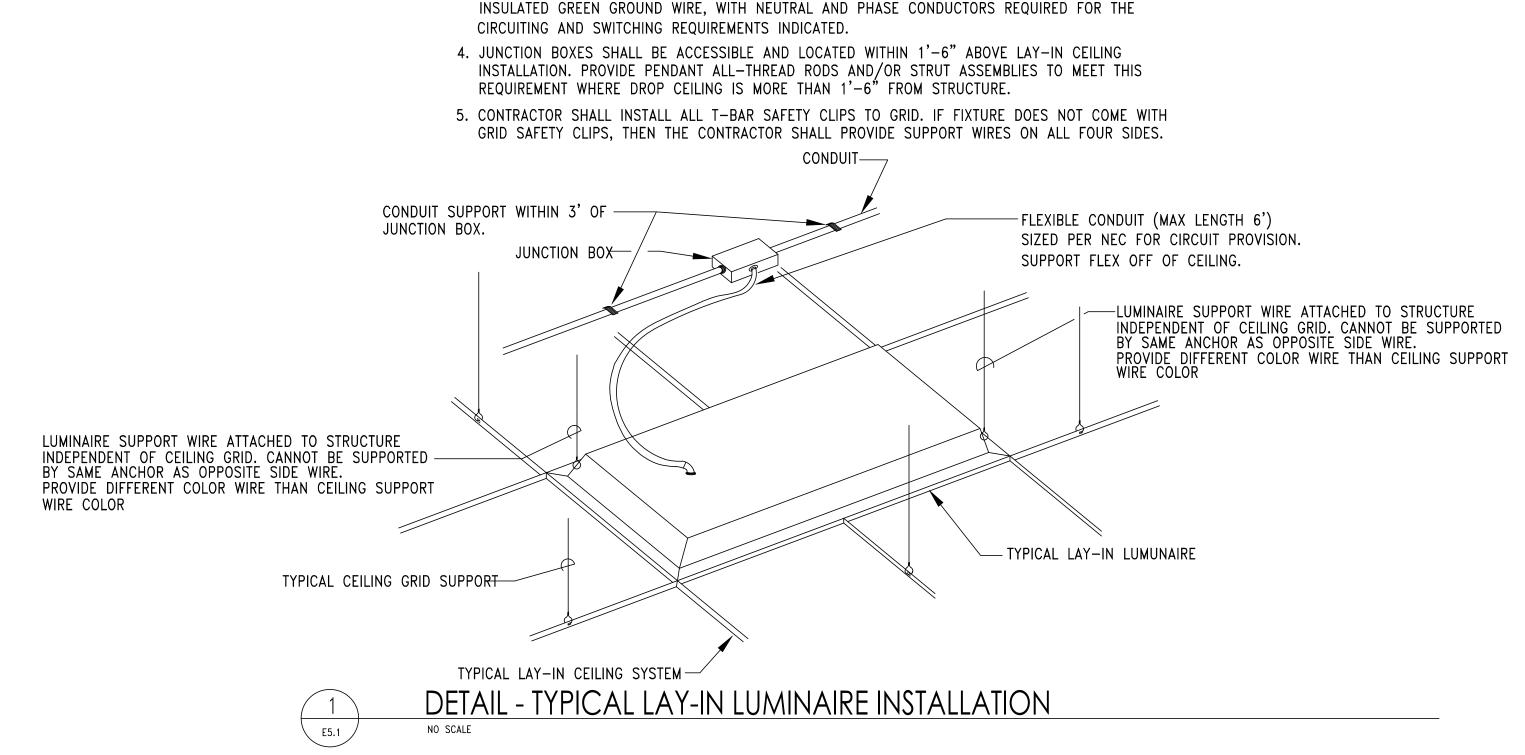

1. ALL RECESSED LUMINAIRES SHALL BE WIRED FROM A JUNCTION BOX AS SHOWN,

THAN TWO LUMINAIRES SHALL BE CIRCUITED TO ONE JUNCTION BOX.

OF THE CEILING GRID.

INCLUDING LUMINAIRES IN A CONTINUOUS ROW. NO WIRING THRU FIXTURES. NO MORE

2. LUMINAIRE SUPPORT WIRES TO BE A MINUMUM OF #14 GAGE PRE-STRAINED GALVINIZED WIRE

3. CONDUCTORS IN FLEXIBLE CONDUIT FROM JUNCTION BOX TO LUMINAIRE SHALL CONTAIN AN

ATTACHED AT OPPOSITE CORNERS. LUMINAIRE SHALL BE SUPPORTED TO THE STRUCTURE INDEPENDENT

1. ARCHITECT RESERVES THE RIGHT TO SELECT ALL COLORS OR MAKE CUSTOM COLOR DURING SHOP DRAWING REVIEW. BID ACCORDINGLY.

4. FOR WARRANTY AND LONG TERM SUPPORT FOR OWNER, ALL LIGHTING FIXTURES SHALL BE PURCHASED THROUGH MANUFACTURER REPRESENTATIVES

LOCATED IN THE STATE OF ALABAMA. SUBMITTALS RECEIVED THAT DO NOT COMPLY WITH THIS REQUIREMENT WILL BE REJECTED WITHOUT REVIEW. THE ELECTRICAL CONTRACTOR


3. PROVIDE EMERGENCY BATTERY BALLAST FOR ALL EMERGENCY TYPE FIXTURES CAPABLE OF 90-MINUTES. ALL EMERGENCY LIGHTS IN SAFE AREA SHALL BE CONNECTED TO THE BATTERY INVERTER FOR 180-MINUTES OF RUN TIME.

2. COORDINATE MOUNTING OF ALL LUMINAIRES WITH ARCHITECTURAL ELEVATIONS PRIOR TO INSTALLATION

SHALL BE RESPONSIABLE FOR ANY DELAYS CAUSED BY NON COMPLIANCE WITH THIS REQUIREMENT.

5. ALL INTERIOR LIGHTS SHALL HAVE 4000K TEMPERTURE LAMPS, UNLESS NOTED OTHERWISE.

6. ALL EXTERIOR LIGHTS SHALL HAVE 4000K TEMPERTURE LAMPS.

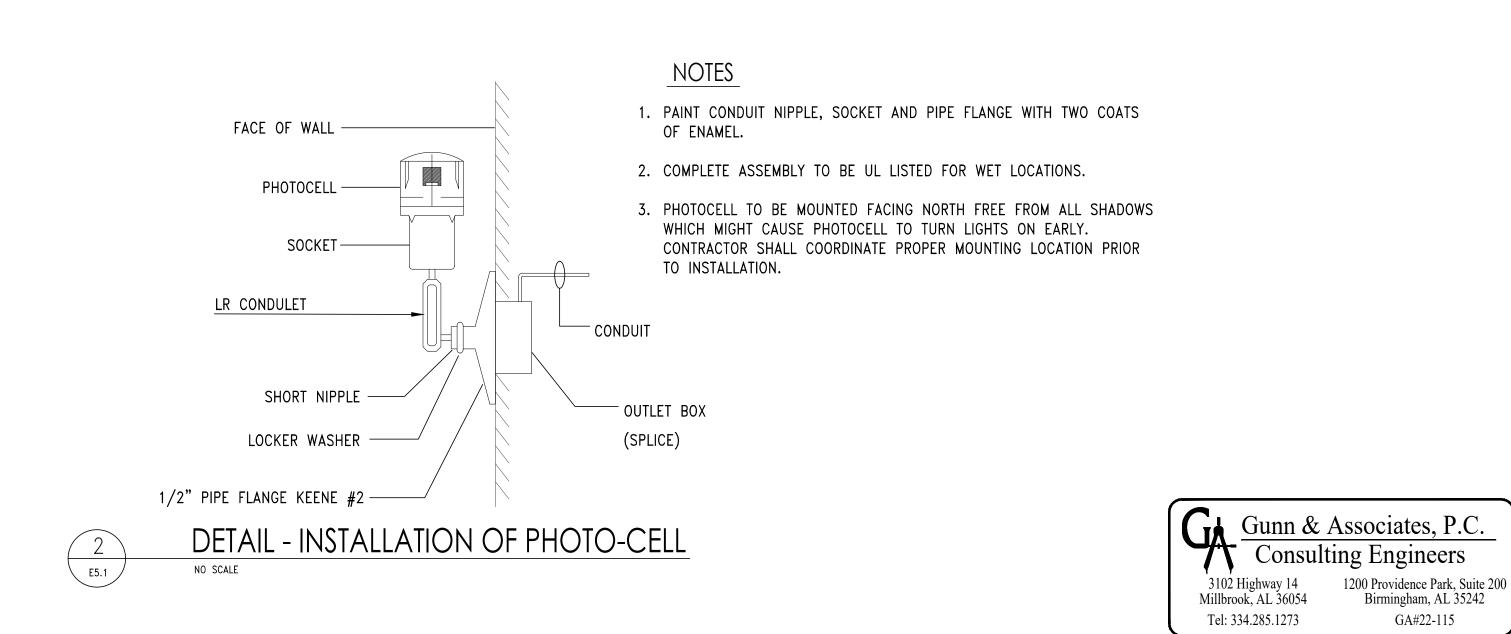

SHEET TITLE: LIGHTING SCHEDULE, **DETAILS & NOTES**

D

MCKEE JOB #: 21.239

PSCA#:

J. TILLERY DRAWN BY

05.18.2022 REVISED DATE:

REVISED DATE:

REVISED DATE:

SHEET NO.: **L5.**

				PAI	NEL	- M	SA							
TYPE: 1200 AMP MAIN CIRCUIT BREAK	ER	Ald	C: 65,000 AMPE	RES			MOUN	TED: SU	RFACE		VOLTAGE:120	/240 VOLTS, 3 PH	ASE, 4 WIRE (DELTA)	
CIRCUIT DIRECTORY		(VA) PER PHAS	E			CIRC	CUIT				(VA) PER PHAS	E	CIRCUIT DIRECTORY	
	PHASE A	PHASE B	PHASE C	AMP	POLE	NUM		AMP	POLE	PHASE A	PHASE B	PHASE C		
EXISTING PANEL "MPA"	14,000		1	800		1	2	250		9,000			* BIG WELDER (NOTE 8)	
		14,000				3	4				9,000		, , ,	
			14,000		3	5	6		3			9,000	SHUNT TRIP	
NEW PANEL RPW1	28,000			400		7	8	250		26,967			NEW PANEL RPAU	
		21,200				9	10				23,367			
			25,000		3	11	12		3			26,967		
PANEL PP1	39,897			400		13	14	400		31,461			NEW PANEL RP1	
		39,897				15	16						STINGER LEG (DON'T USE	
			40,157		3	17	18		2			27,316		
AC-1	3,043			50		19	20	20		1,328			GFMAU-1	
		3,043				21	22				1,328			
			3,043		3	23	24		3			1,328		
WEF-1	830			20		25	26	20		1,328			GFMAU-2	
		830				27	28				1,328			
			830		3	29	30		3			1,328		
WEF-2	830			20		31	32	225		18,667			PANEL RPAV	
		830				33	34				15,067			
			830		3	35	36		3			17,467		
SPARE				400		37	38	400					BUSSED SPACE	
						39	40							
					3	41	42		3					
SUB TOTAL (VA)	86,600	79,800	83,860							88,751	50,090	83,406	SUB TOTAL (VA)	
TOTAL LOAD PHASE A:		175,351					NOTES	:						
TOTAL LOAD PHASE B:		129,890	_(VA)				1. PANE	LBOARD	TO BE BO	OLT-ON TYPE, F	FULLY RATED, V	WITH COPPER BL	JSSING.	
TOTAL LOAD PHASE C:			167,266 (VA)			2. CONTRACTOR SHALL INSURE THAT THE STINGER LEG OF DELTA SERVICE IS								
TOTAL LOAD:		472,507	(VA) =	1136	AMPS	NOT CONNECTED TO THIS SINGLE PHASE CIRCUIT BREAKER.								
			3. NAMEPLATE FOR THIS PANEL SHALL CLEARLY INDICATE THE SERVICE IS "120/240 VOLT, 3PH, 4W, DELTA"							EIS				
							4. PRO	/IDE INTI	ERGRAL T	VSS UNIT.				
							5. PRO	/IDE PAN	IEL WITH I	NAME PLATE IN	IDICATING AIC	RATING.		
							6. PRO	/IDE ARC	FAULT LA	ABEL PER DET	AIL.			

TYPE: 400 MAIN LUG ONLY		Ald	C: 42,000 AMPE	RES			MOUN	TED: SUI	RFACE		VOLTAGE:120	/240 VOLTS, 3 PHA	SE, 4 WIRE (DELTA)
CIRCUIT DIRECTORY		(VA) PER PHASE				CIRC	UIT				(VA) PER PHASI	E	CIRCUIT DIRECTORY
	PHASE A	PHASE B	PHASE C	AMP	POLE	NUM	BER	AMP	POLE	PHASE A	PHASE B	PHASE C	
IHP-1	5,533			50		1	2	30		1,992			OHP-1
		5,533				3	4				1,992		
			5,533		3	5	6		3			1,992	
IHP-2	5,533			50		7	8	30		1,992			OHP-2
		5,533				9	10				1,992		
			5,533		3	11	12		3			1,992	
IHP-3	5,533			50		13	14	30		1,992			OHP-3
		5,533				15	16				1,992		
			5,533		3	17	18		3			1,992	
IHP-4	3,541			40		19	20	30		1,881			OHP-3
		3,541				21	22				1,881		
			3,541		3	23	24		3			1,881	
IHP-5	3,541			40		25	26	20		1,439			OHP-4
		3,541				27	28				1,439		
			3,541		3	29	30		3			1,439	
IHP-6	3,541			40		31	32	20		1,439			OHP-5
		3,541				33	34				1,439		
			3,541		3	35	36		3			1,439	
MD-1-2, 1A, 1B, 2A, 2B	1,200			20	1	37	38	20	1	740			DH-1 & DH-2
MD-3A, 3B, 4A, 4B, 5A, 5B		1,200		20	1	39	40	20	1		740		DH-3 & DH-4
MD-6A, 6B, MD-7A			1,200	20	1	41	42	20	1			1,000	DH-5
SUB TOTAL (VA)	28,422	28,422	28,422							11,475	11,475	11,735	SUB TOTAL (VA)
TOTAL LOAD PHASE A:		39,897	_ ` ′				NOTES						
OTAL LOAD PHASE B:		39,897	- ` ′				1. PANE	LBOARD	TO BE BO	OLT-ON TYPE V	VITH DOOR-IN-D	OOR CONSTRUC	ΓΙΟΝ.
OTAL LOAD PHASE C:		40,157			2. CON	TRACTO	R SHALL II	NSURE THAT T	HE STINGER LE	G OF DELTA SER\	/ICE IS		
OTAL LOAD:		119,951	(VA) =	288	AMPS		NOT	CONNEC	TED TO T	HIS SINGLE PI	HASE CIRCUIT E	BREAKER.	
							3. NAMI	EPLATE F	OR THIS	PANEL SHALL	CLEARLY INDIC	ATE THE SERVICE	IS
							"120/2	240 VOLT	, 3PH, 4W,	DELTA"			

7. MAIN BREAKER WILL BE ALLOWED TO BE 80% RATED

8. PROVIDE SHUNT TRIP CIRCUIT BREAKER.

				PAI	NEL	- R	PW ²	1					
TYPE: 400A MAIN LUG		Ald	C: 42,000 AMPE		<u></u>			TED: SU	RFACE		VOLTAGE:120		SE, 4 WIRE (DELTA)
		•											
CIRCUIT DIRECTORY		(VA) PER PHAS	T			CIRC					(VA) PER PHAS	_	CIRCUIT DIRECTORY
WEI DING DOOTH	PHASE A	PHASE B	PHASE C	AMP	POLE	NUM	1	AMP	POLE	PHASE A	PHASE B	PHASE C	DECEDTA OL EC
WELDING BOOTH	2,600	0.000		50		1	2	20	1	800			RECEPTACLES
		2,600	0.000		2	3	4						STINGER (DO NOT USE)
WELDING BOOTH	0.000		2,600	50	_	5	6	20	1			800	RECEPTACLES
	2,600	0.000			2	7	8	20	1	800			RECEPTACLES
WELDING BOOTH		2,600		50		9	10						STINGER (DO NOT USE)
			2,600		2	11	12	20	1			800	RECEPTACLES
WELDING BOOTH	2,600			50		13	14	20	1	800			RECEPTACLES
		2,600			2	15	16						STINGER (DO NOT USE)
WELDING BOOTH			2,600	50		17	18	20	1			800	RECEPTACLES
	2,600				2	19	20	20	1	800			RECEPTACLES
WELDING BOOTH		2,600		50		21	22						STINGER (DO NOT USE)
			2,600		2	23	24	20	1			800	RECEPTACLES
WELDING BOOTH	2,600			50		25	26	20	1	800			RECEPTACLES
		2,600			2	27	28						STINGER (DO NOT USE)
WELDING BOOTH			2,600	50		29	30	20	1			800	RECEPTACLES
	2,600				2	31	32	20	1	800			RECEPTACLES
WELDING BOOTH		2,600		50		33	34						STINGER (DO NOT USE)
			2,600		2	35	36	20	1			800	RECEPTACLES
WELDING BOOTH	2,600			50		37	38	20	1	800			RECEPTACLES
		2,600			2	39	40						STINGER (DO NOT USE)
RECEPTACLES		,	800	20	1	41	42	20	1			800	RECEPTACLES
AIR COMPRESSOR	3,000			60	<u> </u>	43	44	20	1	800			RECEPTACLES
7.11. COM 11.200011	,	3,000				45	46		<u> </u>	000			STINGER (DO NOT USE)
		2,222	3,000		3	47	48	20	1				SPARE
RECEPTACLES	400		0,000	20	1	49	50	20	1				SPARE
STINGER (DO NOT USE)	400				<u>'</u>	51	52	20	,				STINGER (DO NOT USE)
SPARE				20	1	53	54	20	1				SPARE
SPARE				20	1	55	56	20	1				SPARE
STINGER (DO NOT USE)				20	'	57	58	20	'				STINGER (DO NOT USE)
SPARE				20	1	59	60	20	1				SPARE
	21,600	21,200	19,400	ZU		1 28	00	20	'	6,400	0	5,600	
SUB TOTAL (VA)	21,000	28,000	i i	<u> </u>	<u> </u>	<u> </u>	NOTES	<u> </u>	<u> </u>	0,400	l 0	0,000	SUB TOTAL (VA)
OTAL LOAD PHASE A: OTAL LOAD PHASE B:		21,200					NOTES) TO DE DO				TION
												DOOR CONSTRUC	
TOTAL LOAD PHASE C:												EG OF DELTA SER'	VICE IS
TOTAL LOAD:		14,200	(VA) =	1/8	AMPS							CUIT BREAKER.	- 10
											CLEAKLY INDIC	CATE THE SERVICE	: 10
							"120/2	240 VOLT	, 3PH, 4W,			ATE THE SERVICE	- 10

TYPE: 250A MCB (SHUNT TRIP)		Al	C: 42,000 AMPE	RES			MOUN	ITED: SU	RFACE		VOLTAGE:120)/240 VOLTS, 3 PHA	SE, 4 WIRE (DELTA)
CIRCUIT DIRECTORY		(VA) PER PHAS	E			CIRC	UIT				(VA) PER PHAS	E	CIRCUIT DIRECTORY
	PHASE A	PHASE B	PHASE C	AMP	POLE	NUM	BER	AMP	POLE	PHASE A	PHASE B	PHASE C	
PORTABLE DUST COLL.	1,200			20	1	1	2	60		4,150			CNC ROUTER
STINGER (DO NOT USE)						3	4				4,150		
PORTABLE DUST COLL.			1,200	20	1	5	6		3			4,150	
RECEPTACLE	800			20	1	7	8	60		4,150			VACUUM PUMP
STINGER (DO NOT USE)						9	10				4,150		
RECEPTACLE			800	20	1	11	12		3			4,150	
RECEPTACLE	800			20	1	13	14	100		11,067			BUS DUCT
STINGER (DO NOT USE)						15	16				11,067		
RECEPTACLE			800	20	1	17	18		3			11,067	
RECEPTACLE	800			20	1	19	20	60		4,000			ROBOT ARM
STINGER (DO NOT USE)						21	22				4,000		
RECEPTACLE			800	20	1	23	24		3			4,000	
SPARE				20	1	25	26	30					SPARE
STINGER (DO NOT USE)		-				27	28						
SPARE				20	1	29	30		3				
SPARE				20	1	31	32						BUSSSED SPACE
STINGER (DO NOT USE)						33	34						BUSSSED SPACE
SPARE				20	1	35	36						BUSSSED SPACE
SPARE				20	1	37	38						BUSSSED SPACE
STINGER (DO NOT USE)						39	40						BUSSSED SPACE
SPARE				20	1	41	42						BUSSSED SPACE
SUB TOTAL (VA)	3,600	0	3,600							23,367	23,367	23,367	SUB TOTAL (VA)
OTAL LOAD PHASE A:		26,967	' (VA)				NOTES						
OTAL LOAD PHASE B:		23,367	(VA)				1. PANE	ELBOARD	TO BE BO	OLT-ON TYPE V	WITH DOOR-IN-I	DOOR CONSTRUCT	ΓΙΟΝ.
OTAL LOAD PHASE C:		26,967	(VA)				2. CON	TRACTO	R SHALL IN	ISURE THAT T	HE STINGER LE	EG OF DELTA SERV	/ICE IS
OTAL LOAD:			1 (VA) =	186	AMPS		NOT	CONNEC	TED TO TI	HIS SINGLE PI	HASE CIRCUIT I	BREAKER.	
			-		-	3. NAMEPLATE FOR THIS PANEL SHALL CLEARLY INDICATE THE SERVIC							IS
							"120/2	240 VOLT	, 3PH, 4W,	DELTA"			

		Ι	C: 42,000 AMPE	DEC			140111	TED OU	25405		VOLTA OF 400	(0.40.) (O) TO 0 D) (A)		
YPE: 225A MCB (SHUNT TRIP)	1	All	J. 42,000 AIVIPE	T			MOUN	ITED: SUI T	REACE		VOLTAGE:120/	/240 VOLTS, 3 PHAS	E, 4 WIRE (DELTA)	
CIRCUIT DIRECTORY		(VA) PER PHAS	E			CIRC	UIT				(VA) PER PHASE	<u>=</u>	CIRCUIT DIRECTORY	
	PHASE A	PHASE B	PHASE C	AMP	POLE	NUM	BER	AMP	POLE	PHASE A	PHASE B	PHASE C		
RECEPTACLE	1,200			20	1	1	2	60		4,000			DISCONNECT	
STINGER (DO NOT USE)						3	4				4,000		,	
RECEPTACLE			1,200	20	1	5	6		3			4,000		
RECEPTACLE	1,200			20	1	7	8	100		11,067			BUS DUCT	
STINGER (DO NOT USE)						9	10				11,067			
RECEPTACLE			1,200	20	1	11	12		3			11,067		
RECEPTACLE	1,200			20	1	13	14	60					SPARE	
STINGER (DO NOT USE)						15	16							
SPARE				20	1	17	18		3					
SPARE				20	1	19	20	30					SPARE	
STINGER (DO NOT USE)						21	22							
SPARE				20	1	23	24		3					
SPARE				20	1	25	26						BUSSED SPACE	
STINGER (DO NOT USE)						27	28						BUSSED SPACE	
SPARE				20	1	29	30						BUSSED SPACE	
SPARE				20	1	31	32						BUSSED SPACE	
STINGER (DO NOT USE)						33	34						BUSSED SPACE	
SPARE				20	1	35	36						BUSSED SPACE	
SPARE				20	1	37	38						BUSSED SPACE	
STINGER (DO NOT USE)						39	40						BUSSED SPACE	
SPARE				20	1	41	42						BUSSED SPACE	
SUB TOTAL (VA)	3,600	0	2,400							15,067	15,067	15,067	SUB TOTAL (VA)	
OTAL LOAD PHASE A:	-	18,667	(VA)				NOTES							
OTAL LOAD PHASE B:		15,067	(VA)				1. PANE	LBOARD	TO BE BO	OLT-ON TYPE V	VITH DOOR-IN-E	OOR CONSTRUCT	ION.	
OTAL LOAD PHASE C:		17,467	_ (VA)			2. CONTRACTOR SHALL INSURE THAT THE STINGER LEG OF DELTA SERVICE IS								
OTAL LOAD:		51,201	_(VA) =	123	AMPS		NOT	CONNEC	TED TO TI	HIS SINGLE PH	HASE CIRCUIT E	BREAKER.		
			=		_		3. NAM	EPLATE F	OR THIS I	PANEL SHALL (CLEARLY INDIC	ATE THE SERVICE	IS	
							"120/2	240 VOLT	, 3PH, 4W,	DELTA"				


YPE: 400 AMP MAIN LUG		AIC: 42,000 AMPE	RES		MOUN	NTED: S	URFACE			VOLTAGE: 120/240 VO	LTS, 1 PHASE, 3 WIRE
CIRCUIT DIRECTORY	(VA) PER PHA				CIRCI				(VA) PER PH		CIRCUIT DIRECTORY
	PHASE A	PHASE B	AMP	POLE	NUME	BER	†	POLE	PHASE A	PHASE B	
EXTERIOR LIGHTS	725		20	1	1	2	20	1	600		DOOR STRIKE
LIGHTING		900	20	1	3	4	20	1		1,200	RECEPTACLE
RECEPTACLE	1,200		20	1	5	6	20	1	1,200		RECEPTACLE
RECEPTACLE		1,200	20	1	7	8	20	1		1,200	RECEPTACLE
RECEPTACLE	1,200		20	1	9	10	20	1	1,200		RECEPTACLE
RECEPTACLE		1,200	20	1	11	12	20	1		1,200	RECEPTACLE
RECEPTACLE	1,200		20	1	13	14	20	1	1,200		RECEPTACLE
DRYER		2,880	30		15	16	20	1		1,200	RECEPTACLE
	2,880			2	17	18	20	1	1,200		RECEPTACLE
HAND DRYER		1,440	20	1	19	20	20	1		1,200	RECEPTACLE
RECEPTACLE	600		20	1	21	22	20	1	1,200		RECEPTACLE
RECEPTACLE		1,200	20	1	23	24	20	1		1,200	RECEPTACLE
RECEPTACLE	1,200		20	1	25	26	20	1	1,200		RECEPTACLE
RECEPTACLE		1,200	20	1	27	28	20	1		1,200	RECEPTACLE
RECEPTACLE	1,200		20	1	29	30	20	1	1,200		RECEPTACLE
RECEPTACLE		1,200	20	1	31	32	20	1		1,200	RECEPTACLE
RECEPTACLE	1,200		20	1	33	34	20	1	1,200		RECEPTACLE
RECEPTACLE		1,200	20	1	35	36	20	1		1,200	RECEPTACLE
RECEPTACLE	1,200		20	1	37	38	20	1	1,200		RECEPTACLE
EF-1		696	20	1	39	40	20	1		1,200	RECEPTACLE
EF-3	1,176		20	1	41	42	20	1	1,200		RECEPTACLE
GWH-1		600	20	1	43	44					SPARE
GWH-1	600		20	1	45	46					SPARE
RECEPTACLE		800	20	1	47	48					SPARE
RECEPTACLE	800		20	1	49	50					SPARE
RECEPTACLE		800	20	1	51	52					SPARE
RECEPTACLE	800		20	1	53	54					SPARE
BUSSED SPACE					55	56					SPARE
BUSSED SPACE					57	58					SPARE
BUSSED SPACE					59	60					SPARE
BUSSED SPACE					61	62					SPARE
BUSSED SPACE					63	64					SPARE
BUSSED SPACE					65	66					SPARE
BUSSED SPACE					67	68					SPARE
BUSSED SPACE					69	70					SPARE
BUSSED SPACE					71	72					SPARE
BUSSED SPACE					73	74					SPARE
BUSSED SPACE					75	76					SPARE
BUSSED SPACE					77	78					SPARE
BUSSED SPACE					79	80					SPARE
BUSSED SPACE					81	82	30	1	2,880		UPS TBB
BUSSED SPACE					83	84	20	1			TBB
SUB TOTAL (VA)	15,981	15,316							15,480	12,000	SUB TOTAL (VA)
OTAL LOAD PHASE A:			61 (VA)				NOTES				
OTAL LOAD PHASE B:		27,31	6 (VA)				1. PANE	I BOARD TO	O BE BOI T-ON TYPE W	/ITH DOOR-IN-DOOR CON	ISTRUCTION.

PANELBOARD NOTES:

- 1. PANELBOARDS SHALL BE INSTALLED AND ALL CLEARANCES MAINTAINED IN ACCORDANCE WITH THE NEC.
- ALL PANELBOARDS SHALL BE UL LISTED AND INSTALLED IN ACCORDANCE WITH THAT LISTING.
 PANELBOARDS SHALL BE FURNISHED COMPLETE WITH THE PROPERLY SIZED ENCLOSURE, INTERNAL HARDWARE,
- COMPONENTS, SUPPORTING STRUCTURES, ETC., FOR A COMPLETE INSTALLATION.
- FURNISH EACH PANELBOARD WITH A GROUND BAR BONDED TO THE PANEL ENCLOSURE.
 THE TERMINATION POINT OF THE FEEDER SERVING EACH ASSEMBLY SHALL BE AT THE NEAREST POINT OF FEEDER ENTRY INTO THE PANEL, SO AS TO MINIMIZE CONDUCTOR FILL IN THE ENCLOSURE. COORDINATE
- TOP/BOTTOM FEED PANELBOARD PROVISIONS WITH EACH FEEDER INSTALLATION.

 6. PROVIDE THE PROPER SIZE AND QUANTITY OF CONDUCTOR TERMINATION POINTS OR LUGS (MULTIPLE LUGS WHEN PARALLEL FEEDERS ARE USED) ON BUSES AND CIRCUIT BREAKERS FOR THE RESPECTIVE SIZE AND NUMBER OF CONDUCTORS INDICATED.
- 7. ALL FLUSH-MOUNTED PANELBOARDS SHALL BE PROVIDED WITH AT LEAST SIX (6) 3/4" SPARE CONDUITS
- STUBBED TO ABOVE THE NEAREST ACCESSIBLE CEILING.
 8. PANELBOARDS SHALL BE FULLY RATED. SERIES RATED PANELBOARDS WILL NOT BE ACCEPTED.
- 9. ALL PANELBOARDS SHALL BE CLEARLY MARKED TO COMPLY WITH NEC ARTICLE 110.16 WITH REGARD TO POTENTIAL HAZARDS OF ARC FLASH.
- 10. ALL PANELBOARDS SHALL BE "DOOR-IN-DOOR" OR "HINGED-FRONT-TRIM" CONSTRUCTION.
 11. COMPLY WITH NEC ARTICLE 408.4. PROVIDE A TYPED CIRCUIT DIRECTORY THAT INDICATES WHAT EACH CIRCUIT IS SERVING. FOR LIGHTING AND RECEPTACLE CIRCUITS, INCLUDE THE ROOM NUMBER IN THE CIRCUIT
- DESCRIPTION ON THE DIRECTORY.

 12 FACH PANELBOARD SHALL HAVE A NAMERIATE AS SHOWN IN DETAIL 1 ON THIS SHEET. ENGINEER WILL NOT
- 12. EACH PANELBOARD SHALL HAVE A NAMEPLATE AS SHOWN IN DETAIL 1 ON THIS SHEET. ENGINEER WILL NOT PROVIDE FINAL ACCEPTANCE UNTIL THESE NAMEPLATES ARE PROVIDED.
- 13. MANUFACTURER THAT WILL BE PROVIDING PANELBOARDS ON THIS PROJECT SHALL BE RESPONSIBLE FOR PERFORMING A SHORT CIRCUIT ANALYSIS AND TIME—CURRENT COORDINATION (TCC) STUDY, WHICH DEMONSTRATES THAT THE UPSTREAM OVERCURRENT PROTECTIVE DEVICE NEAREST TO THE FAULT LOCATION WILL OPERATE BEFORE OVERCURRENT PROTECTIVE DEVICES WHICH ARE FURTHER UPSTREAM (I.E. SELECTIVE COORDINATION). INCLUDE COORDINATION STUDY IN THE SHOP DRAWING PACKAGE FOR THE PANELBOARDS FOR REVIEW BY THE ENGINEER OF RECORD. AIC RATINGS MAY BE LOWERED BASED ON STUDY.

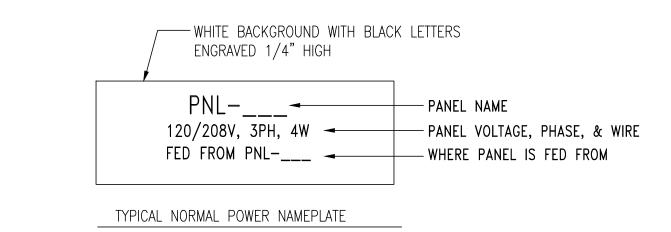



DETAIL - TYPICAL PANELBOARD NAMEPLATE



NOTES:

- PROVIDE SELF-ADHESIVE VINYL LABEL TO AFFIX TO ELECTRICAL EQUIPMENT TO WARN OF ARC FLASH HAZARDS.
- 2. THE LABEL FORMAT AND TEXT SHALL BE IN ACCORDANCE WITH THE FIGURE.
- 3. THE LABEL SHALL BE LOCATED ON THE EQUIPMENT TO BE CLEARLY VISIBLE TO QUALIFIED PERSONS BEFORE EXAMINATION, ADJUSTMENT, SERVICING, OR MAINTENANCE OF THE EQUIPMENT.
- 4. THE SIZE OF THE LABEL SHALL BE:

 EQUIPMENT TYPE HEIGHT WIDTH

 INDOOR 4" 6"

OUTDOOR 4" 6"

ARC FLASH WARNING LABELS

SHEET TITLE : PANELBOARD SCHEDU

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SHEET TITLE: PANELBOARD SCHEDULE,
DETAILS & NOTES

MCKEE JOB # : 21.239

PSCA#:

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DATE: 05.18.2022

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FIRE ALARM SYSTEM NOTES:

- 1. THE FIRE ALARM SYSTEM SHALL BE A COMPLETE SUPERVISED DETECTION AND ALARM SYSTEM, PROVIDE PRIMARY POWER CIRCUITS AND ALARM NOTIFICATION AND INITIATING CIRCUITS IN ACCORDANCE WITH MANUFACTURER'S RECOMMENDATIONS AND SPECIFICATIONS.
- 2. INSTALLATION SHALL COMPLY WITH THE ADA, NEC, NFPA, AND UL.
- 3. ALL SYSTEM COMPONENTS, ENCLOSURES, FRAMES, SURGE ARRESTORS, ETC., SHALL BE GROUNDED.
- 4. THE FIRE ALARM WIRING SYSTEM SHALL BE FURNISHED AND INSTALLED IN ACCORDANCE WITH THE MANUFACTURER'S REQUIREMENTS FOR CLASS "B" SYSTEM AND AS FOLLOWS: PRIMARY POWER - 120V AC NOTIFICATION APPLIANCE CIRCUITS (NAC) - 24V DC
- SIGNALING LINE CIRCUIT (SLC) 24V DC 5. ALL EQUIPMENT AND DEVICES SHALL BE INSTALLED IN ACCORDANCE WITH THE
- MANUFACTURER'S INSTRUCTIONS, APPLICABLE STANDARDS AND ACCESSIBLE FOR VISUAL INSPECTION AND MAINTENANCE. WIRING DIAGRAMS SHALL BE SECURED FROM THE SYSTEM MANUFACTURER AND INSTALLED ACCORDINGLY TO MEET THE SPECIFIED TYPES.
- 6. A "CERTIFICATE OF COMPLETION" IN ACCORDANCE WITH NFPA 72 SHALL BE FURNISHED PRIOR TO FINAL ACCEPTANCE.
- 7. CONTRACTOR IS RESPONSIBLE FOR VERIFYING AND PROVIDING ALL FIRE ALARM DEVICE QUANTITIES FROM AUXILIARY DRAWINGS. DO NOT USE THIS RISER FOR DEVICE COUNTS.
- 8. THE CONTRACTOR OR THEIR FIRE ALARM SYSTEM VENDOR SHALL PROVIDE AUDIBILITY CALCULATIONS INDICATING COMPLIANCE WITH ALL APPLICABLE PROVISIONS OF NFPA 72 AND THE IBC. THE CONTRACT DRAWINGS INDICATE A MINIMUM DESIGN REQUIRED TO COMPLY WITH APPLICABLE CODES. HOWEVER, SINCE DEVICES VARY FROM MANUFACTURER TO MANUFACTURER THE CONTRACTOR SHALL BE RESPONSIBLE FOR FURNISHING ANY/ALL ADDITIONAL DEVICES AS REQUIRED TO PROVIDE AUDIBILITY AND VISIBILITY LEVELS THAT COMPLY WITH APPLICABLE SECTIONS OF NFPA 72 AND IBC.


- 9. PROVIDE ADDITIONAL 100% SPARE CAPACITY IN FIRE ALARM CONTROL PANEL FOR FUTURE USE.
- 10. PROVIDE EMERGENCY BATTERIES CAPABLE OF RUNNING THE COMPLETE FIRE ALARM SYSTEM IN ALARM
- 11. THE FIRE ALARM SYSTEM SHALL BE MONITORED BY AN APPROVED SUPERVISING STATION IN ACCORDANCE WITH
- 12. ALL WIRING TO BE IN CONDUIT SIZED IN ACCORDANCE WITH NEC WITH A MINIMUM SIZE OF 3/4". PROVIDE ALL FIRE ALARM CONDUIT WITH 3" WIDE RED STRIPE EVERY 10' FOR LENGTH OF RUN.
- 13. PROVIDE ALL FIRE ALARM JUNCTION BOXES WITH RED COVER, STENCIL THE LETTERS "FA" IN 2" HIGH LETTERS ON EACH BOX COVER.
- 14. FIRE ALARM SYSTEM PROVIDER IS RESPONSIBLE FOR PROVIDING SIGNAL LINE BOOSTERS AS REQUIRED FOR SYSTEM TO FUNCTION PROPERLY.
- 15. IN ADDITION TO THE DEVICES INDICATED ON THE PLANS THE CONTRACTOR SHALL PROVIDE A SMOKE DETECTOR LOCATED WITHIN 5 FEET OF EACH FIRE ALARM NOTIFICATION APPLIANCE PANEL.
- 16. CONTRACTOR SHALL PROVIDE ALL ADDITIONAL 120 VOLT CIRCUITS NEEDED TO MAKE THE FIRE ALARM SYSTEM A COMPLETE FUNCTIONAL SYSTEM.
- 17. PROVIDE VOICE EVACUATION PER IBC SECTION 907 AND ALL SECTIONS OF THE INTERNATIONAL FIRE CODE.
- 18. "CLG" DENOTES A CEILING MOUNTED DEVICE AND "WP' DENOTES WEATHERPROOF DEVICE...
- 19. SEE STANDARD MOUNTING HEIGHT INSTRUCTIONS ON DETAILS (2) THIS SHEET
- 20. CONTRACTOR OR THEIR FIRE ALARM SYSTEM VENDOR SHALL PROVIDE SMOKE DETECTOR REPORTS AT THE FINAL TESTING OF THE FIRE ALARM SYSTEM TO SHOW THAT ALL SMOKE DETECTORS ARE LESS THAN 10% DIRTY. ANY SMOKE DETECTOR GREATER THAN 10% DIRTY SHALL BE CLEANED OR REPLACED UNTIL VALUE IS LESS THAN 10%.

EMERGENCY RADIO SYSTEM NOTES:

THE TWO-WAY RADIO SYSTEM IS NOT REQUIRED BY THE LOCAL FIRE DEPARTMENT AND WILL NOT BE REQUIRED ON THIS

SHEET NOTES:

- 1 PROVIDE A UL LISTED CELLULAR COMMUNICATOR IN THE NEW FIRE ALARM PANEL. PROVIDE TWO YEARS OF CELLULAR MONITORING FROM THE DATE OF FINAL ACCEPTANCE.
- $\langle 2 \rangle$ PROVIDE SURGE SUPPRESSION ON ON ALL INCOMING AND OUTGOING CABLES WHERE THEY ENTER OR EXIT THE FACILITY. SURGE SUPPRESSION WILL BE REQUIRED FOR EACH CABLE.
- 3 PROVIDE TVSS PROTECTION ON ALL INCOMING POWER FEEDS.

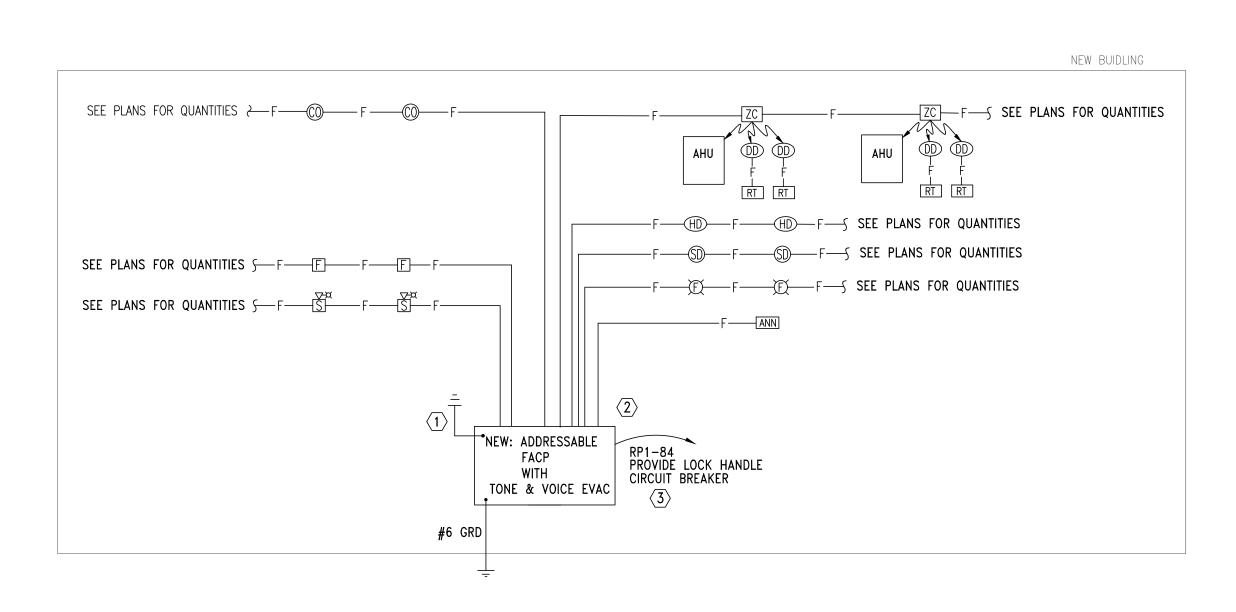

FIRE ALARM RISER DIAGRAM

- MODE, PER NFPA GUIDELINES AT A MINUMUM. BATTERIES SHALL BE SIZED TO HANDLE THE FUTURE CAPACITY.
- FLOOR OR CENTER OF THE PANEL AT 63", WHICHEVER IS LOWER. FLUSH MOUNT ANNUNCIATOR UNLESS OTHERWISE NOTED. NFPA 72. PROVIDE IP DIALER FOR MONITORING OF THE FIRE ALARM SYSTEM.
 - $\langle 3
 angle$ REMOTE POWER SUPPLIES AND AUXILIARY FIRE ALARM PANELS. LOCATE THE PANEL OR CABINET WITH THE TOP OF THE PANEL 72" ABOVE THE FINISHED FLOOR OR CENTER THE PANEL AT 63". WHICHEVER IS LOWER. DO NOT LOCATE THESE PANELS ABOVE CEILINGS OR WHERE INACCESSIBLE BY A PERSON STANDING ON THE FINISHED FLOOR OF THE SPACE.


 $\langle 1
angle$ MOUNT FIRE ALARM ENCLOSURE WITH THE TOP OF THE CABINET 72" ABOVE THE

FINISHED FLOOR OR CENTER THE CABINET AT 63", WHICHEVER IS LOWER.

 $\langle 2 \rangle$ MOUNT ANNUNCIATOR WITH THE TOP OF THE PANEL 72" ABOVE THE FINISHED

FIRE ALARM MOUNTING HEIGHTS/INSTRUCTIONS NOTES:

- $\langle 4 \rangle$ MOUNT STATIONS SO THAT THEIR OPERATING HANDLES ARE BETWEEN 42" AND 48" ABOVE THE FINISHED FLOOR. DO NOT USE BRICK OR BLOCK COURSES AS YOUR ONLY GUIDE. CUT BRICK OR BLOCK TO ACHIEVE PROPER HANDLE HEIGHT.
- $\overline{\langle 5 \rangle}$ ALL WALL MOUNTED AUDIO/VISUAL DEVICES SHALL BE MOUNTED SO THE ENTIRE LENS IS BETWEEN 80" AND 96" ABOVE THE FINISHED FLOOR. WHERE LOW CEILING HEIGHTS DO NOT PERMIT MOUNTING AT A MINIMUM OF 80" AFF, VISIBLE APPLIANCES SHALL BE MOUNTED WITHIN 6" OF THE CEILING. DO NOT USE BRICK OR BLOCK COURSES AS YOUR ONLY GUIDE. CUT BRICK OR BLOCK TO ACHIEVE PROPER LENS HEIGHT.
- (6) WEATHER PROOF APPLIANCES INSTALLED OUTDOORS SHALL BE UL LISTED FOR OUTDOOR USE. MOUNT SO THE ENTIRE LENS IS BETWEEN 80" AND 96" ABOVE FINISHED FLOOR. FOR WEATHERPROOF APPLIANCES MOUNTED AT FIRE DEPARTMENT CONNECTION (FDC), COORDINATE WITH LOCAL AUTHORITY HAVING JURISDICTION PRIOR TO ROUGH-IN FOR MOUNTING HEIGHT.
- $\langle 7 \rangle$ SMOKE AND HEAT DETECTOR HEADS SHALL NOT BE INSTALLED UNTIL AFTER CONSTRUCTION CLEAN-UP IS COMPLETED. IF DETECTOR HEADS ARE INSTALLED PRIOR TO CONSTRUCTION CLEAN-UP. PROTECTIVE COVERS MUST BE IN PLACE TO PROTECT DETECTOR HEADS FROM PARTICULATE DAMAGE. DETECTORS LOCATED ON THE WALL SHALL HAVE THE TOP OF THE DETECTOR AT LEAST 4" AND NOT MORE THAN 12" BELOW THE CEILING. INSTALL SMOKE DETECTORS NO CLOSER THAN 3 FEET FROM AIR HANDLING SUPPLY AIR DIFFUSERS OR RETURN AIR OPENINGS. LOCATE DETECTORS NO CLOSER THAN 12" FROM ANY PART OF A LIGHTING FIXTURE.
- (8) DUCT SMOKE DETECTOR HEADS SHALL NOT BE INSTALLED UNTIL AFTER CONSTRUCTION CLEAN-UP IS COMPLETED. DETECTOR HEADS INSTALLED PRIOR TO CONSTRUCTION CLEAN-UP SHALL BE REPLACED. DUCT DETECTORS ARE TO BE PROVIDED BY THE FIRE ALARM CONTRACTOR AND INSTALLED BY THE MECHANICAL CONTRACTOR.
- ADDRESSABLE MODULES SHALL BE INSTALLED LESS THAN 3-FEET FROM THE DEVICE BEING CONTROLLED OR MONITORED. ORIENT THE DEVICE MOUNTING FOR BEST MAINTENANCE ACCESS. LABEL ALL ADDRESSABLE MODULES AS TO THEIR FUNCTION. ⟨1○⟩ MOUNT WITHIN 5'-0" OF FURNACE DISCHARGE REGISTER.

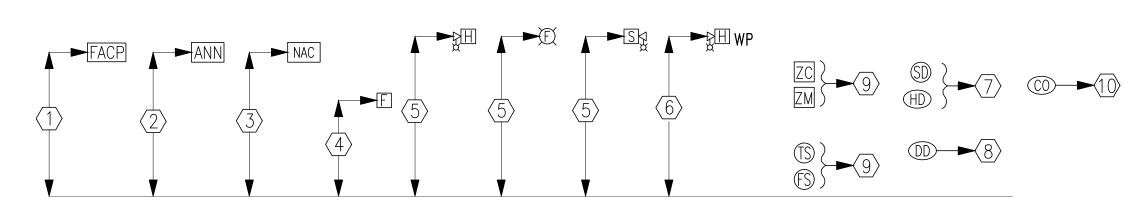

STANDARD MOUNTING HEIGHTS/INSTRUCTIONS

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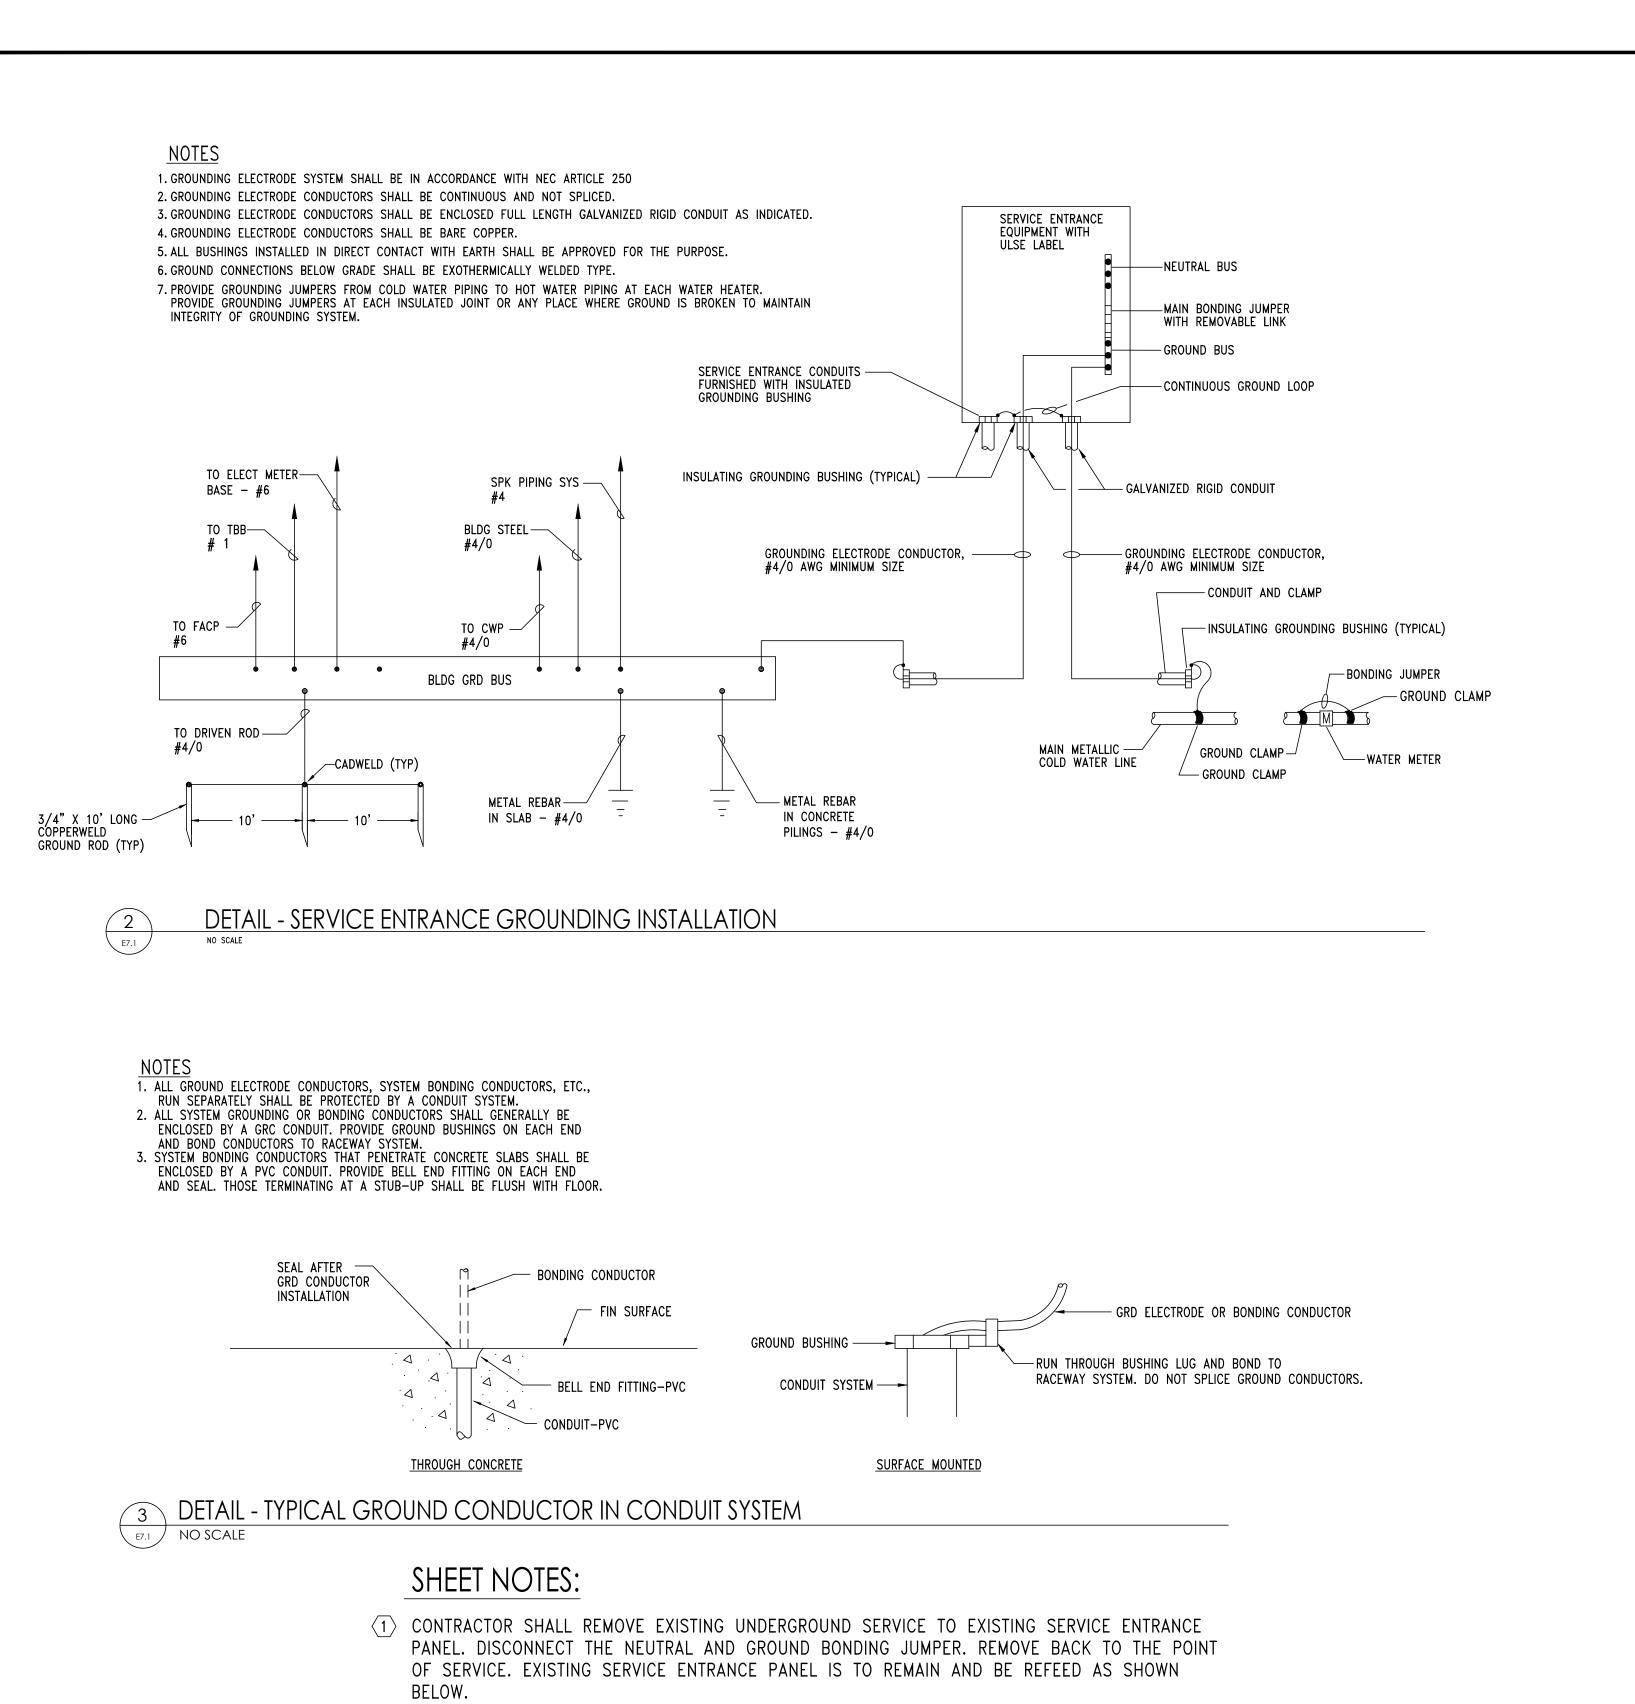
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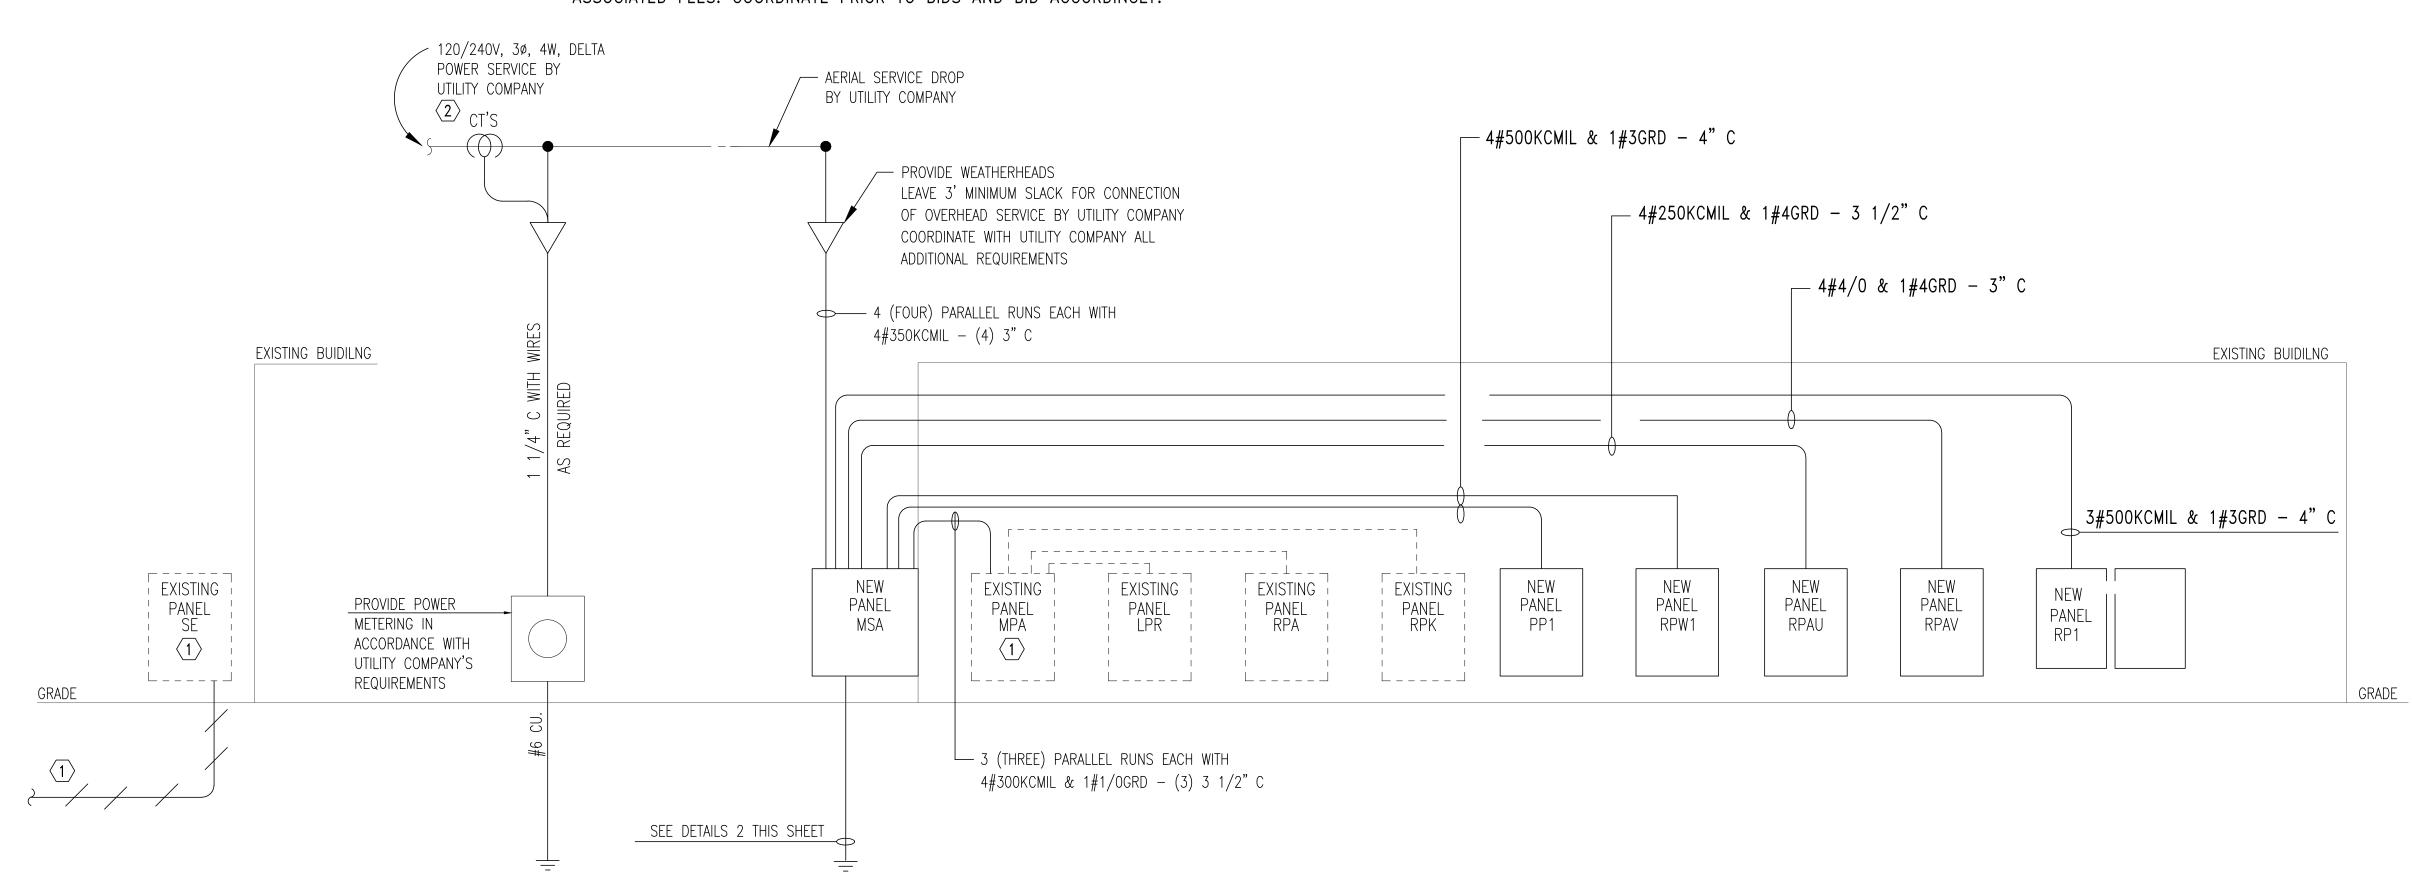
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(2) COORDINATE WITH LOCAL UTILITY COMPANY FOR OVERHEAD SECONDARY TO BE BROUGHT TO BUILDING AND PAY ALL ASSOCIATED FEES. COORDINATE PRIOR TO BIDS AND PAY ALL ASSOCIATED FEES. COORDINATE PRIOR TO BIDS AND BID ACCORDINGLY.



GROUNDING AND BONDING INSTALLATION NOTES


- 1. ALL GROUNDING AND BONDING SHALL BE IN ACCORDANCE WITH THE NEC, NESC, IEEE, ANSI AND UL STANDARDS. 2. ALL DIMENSIONING INDICATED IN THESE DOCUMENTS ARE FOR REFERENCE AND COORDINATION PURPOSES ONLY.
- THE CONTRACTOR IS RESPONSIBLE FOR VERIFYING ALL DIMENSIONS IN THE FIELD.
- 3. THE PURPOSE OF THE GROUNDING AND BONDING SYSTEM IS TO ESTABLISH ALL EQUIPMENT ENCLOSURES, NON-CURRENT CARRYING METALLIC PORTIONS OF THE ELECTRICAL DISTRIBUTION SYSTEM, METAL PIPING, METAL BUILDING FRAME, ETC., AT A ZERO POTENTIAL RELATIVE TO THE EARTH GROUND AND PROVIDE FOR A SAFE, LOW IMPEDANCE RETURN PATH FOR GROUND-FAULT CURRENT. THIS SHALL BE ACCOMPLISHED IN THE FOLLOWING MANNER: a. PROVIDE A SOLIDLY GROUNDED SECONDARY SYSTEM.
- b. INTER-CONNECT ALL GROUND BUSES AND POINTS IN THE SYSTEM WITH A COPPER GRD CONDUCTOR (BUS) SYSTEM. c. ALL METALLIC RACEWAYS SHALL BE UL APPROVED AND MADE-UP TIGHT AT ALL COUPLINGS AND TERMINATIONS. d. ALL GROUND CONDUCTORS IN CIRCUITS SHALL BE CONTAINED WITHIN THE SAME RACEWAY AS CURRENT CARRYING
- e. ALL SPLICES AND TERMINATIONS SHALL BE MADE TIGHT AND AS SUCH TO PROVIDE LOW IMPEDANCE AND SHALL HAVE THE SAME SHORT-TIME CURRENT-CARRYING CAPABILITY AS THE CONDUCTOR IT IS CONNECTED TO. f. ALL GRD ELECTRODES OR BONDING CONDUCTORS INSTALLED ALONE WITHIN A RACEWAY SHALL UTILIZE GRC WITH GROUNDING BUSHINGS AT EACH END. THIS GROUND CONDUCTOR SHALL LOOP THROUGH THE BUSHING LUG PRIOR



GROUND BUS NOTES

1. GROUND BUS INSTALLATION SHALL BE IN ACCORDANCE

WITH THIS DETAIL AND AS INDICATED ON THE DRAWINGS.

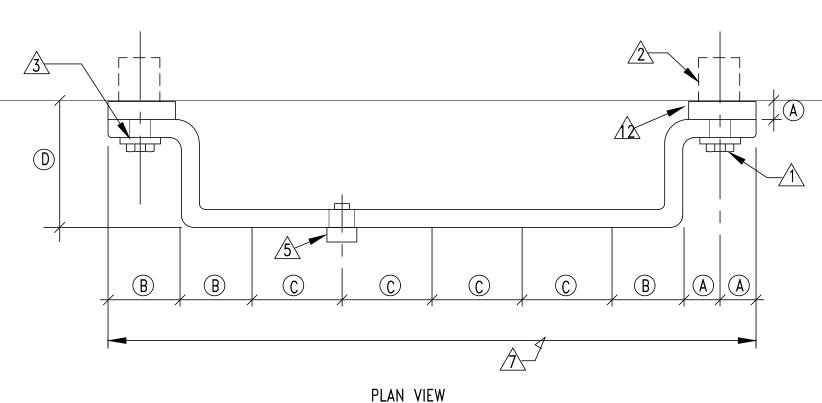

KEYED NOTES

- 1/2" (12.7mm) X 1 1/2" (38.1mm) SILICON-BRONZE MACHINE BOLT & SILICON-BRONZE WASHER
- 1/2" (12.7mm) EXPANSION ANCHOR

/3\ 9/16"ø (14.2875mm) HOLE IN BAR

- ✓4\ DRILLED DOUBLE CONNECTOR HOLES
- FLAT, TWO-HOLE CU CABLE CONNECTOR #6 TO #2 (DOUBLE LUGS)
- 4" (101.6mm) WIDE, 1/4" (6.35mm) DEEP COPPER BUS BAR.

#1 TO #4/O (SINGLE LUGS ONLY)

- $\overline{/7}$ LENGTH AS REQUIRED BY NUMBER OF CONDUCTOR CONNECTIONS OR AS SPECIFICALLY INDICATED. PROVIDE INTERMEDIATE WALL SUPPORTS
- TYP CU GRD CONDUCTOR CONNECTION
- ✓9
 DESCRIPTION TAG. STATE SIZE OF CONDUCTOR AND TO WHAT IT IS CONNECTED TO.

AS REQUIRED.

- TYP GRD CONNECTION FROM BELOW. SEE APPLICABLE DETAILS FOR SLAB PENETRATIONS.
- $\Delta \Delta$ TYP GRD CONNECTION FROM ABOVE. SEE APPLICABLE DETAILS FOR GRC INSTALLATIONS.
- 12 INSULATED NON-CONDUCTIVE SPACER

DETAIL - TYPICAL GROUND BUS INSTALLATION

ELEVATION

POWER RISER DIAGRAM NOTES:

1. INSTALLATION AND CONNECTION OF ALL DEVICES SHALL BE IN ACCORDANCE WITH NEC, MANUFACTURER'S RECOMMENDATIONS, AND STATE AND LOCAL CODES.

(E) AFF

- 2. CONTRACTOR IS RESPONSIBLE FOR THE CONNECTING, INSTALLATION, AND MARKING OF ALL POWER FEEDER CONDUCTORS FOR THE PROPER PHASE SEQUENCE AND LOADING . CONTRACTOR SHALL TEST EACH FEEDER AND EQUIPMENT FEEDERS WITH A PHASE METER PRIOR TO CONNECTING LOADS.
- 3. THE CONTRACTOR IS RESPONSIBLE FOR COORDINATING AND VERIFYING WITH ALL DIVISIONS THE ACTUAL NAMEPLATE DATA OF ALL EQUIPMENT AND DEVICES SUPPLIED ON THIS PROJECT PRIOR TO BID. CONTRACTOR SHALL THEN PROVIDE THE PROPERLY SIZED OVERCURRENT DEVICES (CIRCUIT BREAKERS, CONDUCTORS, DISCONNECTS, FUSES, ETC.) TO PROPERLY PROTECT THE EQUIPMENT PER THE NEC. ENGINEER'S DESIGN BASED ON DATA GIVEN TO HIM BY DESIGNERS OF OTHER DIVISIONS, ACTUAL NAMEPLATE DATA COULD DIFFER.
- 4. SEAL ALL CONDUITS FROM THE EXTERIOR WITH A SEALING COMPOUND, ONCE ALL CABLING HAS BEEN INSTALLED.
- 5. ALABAMA POWER COMPANY WILL BE FURNISHING THE OVERHEAD SECONDARY TO THE WEATHERHEADS COORDINATE WITH ALABAMA POWER ALL REQUIREMENTS SET FORTH BY THE UTILITY COMPANY AND PAY FOR ALL FEES TO GET POWER CONNECTED TO BUILDING. COORDINATE PRIOR TO BID AND BID ACCORDINGLY.
- 6. PROVIDE UNISTRUT SUPPORT ACROSS STRUCTURE WITH ANCHOR BOLT TO SUPPORT THE MOUNTING OF WEATHERHEADS TO THE SIDE OF THE BUILDING.

1. CONTRACTOR SHALL CALCULATE AND PROVIDE NAMEPLATE ON THE SERVICE ENTRANCE EQUIPMENT THAT INDICATES THE MAXIMUM AVAILABLE FAULT CURRENT AND THE DATE THE CALCUALTION WAS PERFORMED. SEE NAMEPLATE REQUIREMENTS BELOW.

--- WHITE BACKGROUND WITH BLACK LETTERS ENGRAVED 1/4" HIGH

PNL-___ PANEL NAME _____ AMP MAXIMUM AIC - CALCULATE AND PROVIDE MAXIMUM AVAILABLE FAULT CURRENT DATE OF CALCULATION:__/___ PROVIDE DATE CALCULATION WAS PERFORMED

TYPICAL SERVICE ENTRANCE FAULT CURRENT NAMEPLATE

DETAIL - SERVICE ENTRANCE FAULT CURRENT NAMEPLATE



SHEET TITLE: POWER RISER, DETAILS & NOTES

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OVERHEAD POWER RISER DIAGRAM