
FMTC RUNNING TRACK LIGHTING

ANNISTON, AL

JMR+H
Architecture, PC
445 Dexter Avenue

445 Dexter Avenue Suite 5050 Montgomery, Al 36104

Phone: (334) 420-5672 Fax: (334) 420-5692

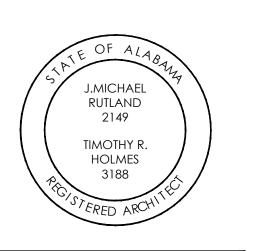

FMTC RUNNING TRACK LIGHTING ANNISTON, ALABAMA

IFB#: AC-22-B-0024-S

ABBREVIATIONS	VICINITY MAP	GENERAL NOTES			INDEX OF DRAWINGS	
A.B. ANCHOR BOLT ABV ABOVE A/C AIR CONDITIONING ACC ACCESS AC.T. ACOUSTICAL TILE (CLG) AFF ABOVE FINISH FLOOR A.D. AREA DRAIN ADD ADDENDUM ADD ADDENDUM ADH ADHESIVE ADJ ADJUSTABLE AGG AGGREGATE A.H.U. AIR HANDLING UNIT ALT ALT ALT ALT ALT ALT ALT ALT ALT AL	ATE Petham Sherman Re Heights Heights Heights Heights Re Heights Heig	1. DRAWINGS AND SPECIFICATIONS OF ALL DISCIPLINES INCLUDED HEREIN ARE GRAPHIC AND TEXT REPRESENTATIONS INTENDED TO ESTABLISH THE FULL SCOPE OF THIS PROJECT AND THE FULL CONTRACTUAL OBLIGATION OF THE GENERAL CONTRACTOR TO COMPLETE THE WORK SHOWN, IMPLIED, AND SPECIFIED. IT SHALL BE THE GENERAL CONTRACTOR'S ULTIMATE RESPONSIBILITY TO COORDINATE THE PROPOSALS AND WORK OF ALL TRADES TO ENSURE ALL MATERIALS AND WORK REQUIRED BY THE CONTRACT DOCUMENTS ARE INCLUDED IN THE GENERAL CONTRACTOR'S PROPOSAL AND ARE ULTIMATELY FURNISHED AND INSTALLED IN THE FINISHED PRODUCT, WHETHER EXPLICIT OR IMPLIED BY THESE DOCUMENTS.	NO. 1 2 3	E1.1	SHEET TITLE COVER, INDEX, LEGENDS & NOTES SYMBOLS, NOTES, AND LIGHTING FIXTURE SCHEDULE SINGLE LINE DIAGRAM, SCHEDULES, SITE PLAN, AND DETAILS	
ALUM ALUMINUM FND FOUNDATION A.P. ACCESS PANEL F.O. FACE OF APX APPROXIMATE FP FIRE PROOF ARCH. ARCHITECT(URAL) FPHB FIRE PROOF HOSE BIBB ASPH ASPHALT FILE FR FRAME AUTO. AUTOMATIC FS FULL SIZE AVG AVERAGE FTG FOOTING AWNIG AWNING FUR FURRED(ING) FUR FURRED(ING) F.V. FIELD VERIFY PREFAB PREFABRICATEI PREFAB PREFABRICATEI PSF POUNDS PER SO PSI POUNDS PER SO PTN PARTITION PARTITION PREFAB PREFABRICATEI PSF POUNDS PER SO PSI POUNDS PER SO PTN PARTITION PREFAB PREFABRICATEI PSI POUNDS PER SO POUNDS PER SO PSI POUNDS PER SO POUNDS PER SO PSI POUNDS PER SO POUNDS PER SO PSI POUNDS PER SO PSI POUNDS PER SO PSI POUNDS PER SO POUNDS PER SO PSI POUND	QUARE FOOT QUARE INCH EATED VING Will Lentack Ltt. Lent	 THE FOLLOWING PRIORITIES ARE ESTABLISHED WITH REFERENCE TO DISCIPLINE COORDINATION A. ALL STRUCTURAL DESIGN & DETAILING SHALL GOVERN OVER ARCHITECTURAL GRAPHIC REPRESENTATION WHERE APPLICABLE. B. ALL CIVIL DESIGN & DETAILING SHALL GOVERN OVER ARCHITECTURAL REPRESENTATION WHERE APPLICABLE. IT SHALL BE THE RESPONSIBILITY OF THE CONTRACTOR TO BECOME 				
BD BOARD BF BI-FOLD (DOOR) BIT. BITUMINOUS BLKG BLOCKING BLK BLOCK (CMUs) BLK BLOCK (CMUs) BLKG BLOCKING BLKG BLOCKING BLK BLOCK (CMUs) BLK BLOCK (CMUs) BLK BLOCK (CMUs) BLK BLOCK (BLOCK (CMUs) BLK BLOCK (CMUs)	Gullion Park St. Marsh 200 Annual St. Marsh 200 An	FAMILIAR WITH THE CONTRACT DOCUMENTS APPLICABLE TO THIS PROJECT PRIOR TO CONSTRUCTION. THE DRAWINGS AND SPECIFICATIONS ARE COMPLIMENTARY AND BOTH DOCUMENTS SHALL BE BINDING. 4. THE CONTRACTOR IS TO MAINTAIN A COMPLETE SET OF AS-BUILT DRAWINGS AT THE JOB SITE. AS-BUILTS SHALL BE AVAILABLE FOR FIELD OBSERVATION BY THE ARCHITECT OR ENGINEER.				
BRK BRICK B.S. BOTH SIDES BSMT BASEMENT BOT BOTTOM BTWN BETWEEN BVL BEVELED B.W. BOTH WAYS CAB CABINET H HIGH HOSE BIBB HOSE BIBB HC. HOLLOW CORE H.C. HOLLOW CORE H.D. HEAD OR HARD HEAD OR HEAVY DUTY HEAT DETECTOR OR HEAVY DUTY HARDWARE HT HEIGHT REINFORCED (IN RFG ROOFING R.J.B. REINFORCED JU RLG RAILING RAM RANGE W/ MICF RWL ROOF WATER L R.O. ROUGH OPENIN R.O.W. RIGHT OF WAY R.O.W. RIGHT OF WAY	UNCTION BOX ROWAVE LEADER NG F(S) W 42nd \$1 Saks W 47st \$1 Old Gardsden Huy W 38th \$1 PROJECT INFORMATION	5. THESE DRAWINGS ARE SCHEMATIC IN NATURE AND NOT INTENDED TO SHOW ALL POSSIBLE CONDITIONS, PROCEDURES, OR METHODS OF CONSTRUCTION. IT IS INTENDED THAT A COMPLETE BUILDING RENOVATION BE PROVIDED WITH ALL NECESSARY EQUIPMENT APPURTENANCES, AND CONTROLS, COMPLETELY COORDINATED WITH ALL DISCIPLINES. ALL PARAMETERS GIVEN IN THESE DOCUMENTS SHALL BE STRICTLY CONFORMED WITH ANY ITEMS AND LABOR REQUIRED FOR A COMPLETE CONSTRUCTION PROJECT IN ACCORDANCE WITH ALL APPLICABLE CODES, STANDARDS, AND THESE CONTRACT DOCUMENTS. ALL ITEMS, SYSTEMS,				
CEM CEMENT CER CERAMIC CF CUBIC FOOT CHAM CHAMFER C.I. CAST IRON C.I. CAST IRON CIR CIRCLE CIRC CIRCUMFERENCE CIRC CIRCUMFERENCE C.J. CONTROL JOINT HR HOUR H.R. HALF ROUND H.R. HALF ROUND H.R. HALF ROUND SCH SCHEDULE SD SMOKE DETECT SEC SECTION SEC SECTION S.F. SQUARE FEET SF.GL. SAFETY GLASS S.G.D. SLIDING GLASS SH SINGLE HUNG COND. SHOW HARDWOOD S	MONTGOMERY, ALABAMA B DOOR OR SHELF DESIGN TEAM CONTACTS	ETC. OUTLINED HEREIN SHALL BE FURNISHED WITHOUT INCURRING ANY ADDITIONAL COST TO THE CONTRACT. CAREFULLY REVIEW ALL CONTRACT DOCUMENTS AND THE DESIGN OF OTHER TRADES BEFORE PREPARING SHOP DRAWINGS. 6. COORDINATE PIPING, CONDUIT, ETC. WITH STRUCTURAL ITEMS. MAKE OFFSETS AND TRANSITIONS TO COORDINATE WITH OTHER TRADES WITHOUT ADDITIONAL EXPENSE TO THE OWNER.				CONSTRUCTIO
CK CALK(ING) CAULK(ING) CL CLOSET OR CENTER LINE CLG CEILING CLR CLEAR(ANCE) CLS CLOSURE OR CLOSER CMU CONCRETE MASONRY UNIT C.O. CASED OPENING COL COLUMN CONC CONCRETE COMB COMBINATION CONC CONCRETE COND (AC) CONDENSER COND (AC) CONDENSER CONT CONTINUOUS ILLO. IN LIEU OF I.M. INSULATED METAL INS / INSUL INSULATED (TION) INT INTERIOR INT INTERIOR INT INTERIOR INT INTERIOR SHTHG SHEATHING SHEATHING SHEATHING SHILLO. IN LIEU OF I.M. INSULATED METAL INS / INSUL INSULATED METAL INS / INSUL INSULATED METAL INS / INSULATED	SUITE 5050 ANNISTON, ALABAMA 36207 MONTGOMERY, AL 36104 T: (334) 420-5672	 COORDINATE ALL REVIEWS OF WORK IN PLACE PRIOR TO CONCEALMENT OF ALL INTERIOR AND EXTERIOR WORK. CONTRACTOR SHALL CHECK AND COORDINATE ALL DIMENSIONS PRIOR TO PROJECT LAYOUT. CONFIRM EXISTING CONDITIONS WILL ACCOMMODATE DIMENSIONAL CRITERIA SHOWN FOR NEW WORK, CONSTRUCTION, AND INSTALLATION. THIS CONFIRMATION WILL BE THE RESPONSIBILITY OF THE GENERAL CONTRACTOR. 				Project Number: 21-11 Date: 20 JULY 20 Revisions:
CONT CONTINUOUS CONTR CONTRACTOR CORR CORRUGATED CORR COPPER COPPER COPPER CORS COURSE(S) CSMT CASEMENT C.ST. CAST STONE C.T. CERAMIC TILE C.T. CERAMIC TILE C.T. CERAMIC TILE C.T. CERAMIC TILE C.T. CENTER OR COUNTER CY CUBIC YARD CY CUBIC YARD CONTRACTOR LAM. LAMINATE(D) SQ SQUARE SUS SUSPENDED S.W. SHEAR WALL COCATION BY OTHERS LIV LIVING T. T. TREAD T.B. TOWEL BAR T.B.D. TO BE DETERM T.C. T. T.C. T.C. T.C. T.C. T.C. T.C. T	NTROL JOINT ASS)	9. EXISTING RUNNING TRACK WILL REMAIN IN USE BY OWNER DURING CONSTRUCTION. CONTRACTOR SHALL NOT INTERFERE WITH OWNER'S OPERATIONS, ETC.				
D 12"D 12" DEEP M M METER(S) THR THRESHOLD DD DRYER, OR DRAIN MAX MAXIMUM T.O.C. TOP OF CONCR DBL DOUBLE MAS MASONRY T.O.F. TOP OF FOUND DECO DECORATIVE MATL MATERIAL T.O.M. TOP OF MASON DEM DEMOLISH, DEMOLITION MC MEDICINE CABINET T.O.W. TOP OF WINDO' DEP DEPRESSED MECH MECHANICAL TR TRANSOM DET DETAIL MFR. MANUFACTURER	RETE DATION NRY W	DAOE DID				Sheet Description
D.F. DRINKING FOUNTAIN DH DOUBLE HUNG MIN MINIMUM DIAMETER MIR MIRROR DIM DIMENSION D.L. DEAD LOAD DN DOWN MM MILLIMETER MIN MINIMUM DIMENSION MISC MISCELLANEOUS MISC UNDERCUT UNFINISHED UNF. UNFINISHED U.N.O. UNLESS NOTED U.N.O. UNLESS NOTED U.N.O. UNLESS NOTED U.N.O. WASONRY OPENING WMB MMB MEMBRANE DRY DRYER MACHINE DS DOWNSPOUT MRB MARBLE D/S DRAWER STACK MTL METAL UNNOUNTED(ING) VB VANITY BASE VAPOR BARRIE VB# VANITY BASE WORLD VB# VANITY BASE WORLD VIN VINYL(SHEET) VS. VEGETABLE SIN	DOOR MARK O OTHERWISE RR WIDTH DOOR MARK WINDOW MARK ROOM FINISH MARK DETAIL NO. DWG. NO.	1. BASE BID FOR THIS PROJECT INCLUDES THE INSTALLATION OF ALL NEW LIGHTING FIXTURES, POLES, POLE MOUNT BASES, CONDUITS, WIRING, CONTROLS, ETC. AS PART OF A COMPLETE LIGHTING SYSTEM AS SHOWN ON DRAWINGS AND SPECIFIED HEREIN.				COVER, INDEX LEGENDS, & NOTES
DW DISH WASHER DWG DRAWING DWR DRAWER N/A NOT APPLICABLE NI.C. NOT IN CONTRACT NL NAILABLE NOM NOMINAL EB EYEBROW E.F. EACH FACE E.J. EXPANSION JOINT NOL MOLLION OR MOLLED V.C.T. VINYL COMPOS VIDE OR WASH N.I.C. NOT IN CONTRACT NOT IN C	BRACKET MOUNTED FIRE EXTINGUISHER FIRE EXTINGUISHER CABINET SECT. NO.					Sheet Number
ELE ELEVATION ELEC ELECTRIC(AL) O.C. ON CENTER WIN WINDOW WITH OR WITHO E.P. ELECTRICAL PANEL OHC OVERHEAD CABINET WP WATERPROOF EQ EQUAL O.D. OUTSIDE DIAMETER WR. WATER RESIST, EST ESTIMATE O.G.D. OVERHEAD GARAGE DOOR W.S. WATER SOFTEN E.W.C. ELECTRIC WATER COOLER OH OVERHEAD EXG EXISTING OPNG OPENING WT.W. WALL TO WALL EXT EXTERIOR OSB ORIENTED STRAND BOARD	MARKER OWG. NO. TELL FINISH FLOOR					T1.1
						1 OF 3

ELECTRICAL SYMBOLS

	ELLOTTIOAL OTVIDOLO
머	LED POLE LIGHT.
=	WALL OUTLET — GFCI DUPLEX OUTLET, 20A, 125V, GROUNDED, WEATHERPROOF, HUBBELL #GF-5362-GY — GREY WITH #S-26 PLATE. ("WP" DENOTES WEATHERPROOF)
(CEILING OUTLET - JUNCTION BOX.
J	WALL OUTLET - JUNCTION BOX WITH FLEXIBLE CONNECTION TO EQUIPMENT.
\$ ^{TS}	SWITCH OUTLET/TIMER — TIME SWITCH WITH ON/OFF BUTTON. HUBBELL DT 2000W OR EQUAL WITH 0-120 MINUTE TIMER. ENSURE TIME SWITCH IS INSTALLED IN WEATHERPROOF LOCKABLE ENCLOSURE.
	LIGHTING PANEL - SEE SPECIFICATIONS AND SCHEDULE.
	POWER PANELS - SEE SPECIFICATIONS AND SCHEDULE.
	BRANCH CIRCUIT CONCEALED IN WALL OR CEILING.
	BRANCH CIRCUIT CONCEALED IN FLOOR OR GROUND.
_	HOMERUN TO PANELBOARD — ANY CIRCUIT WITHOUT FURTHER DESIGNATION 2 # 12 & 1 # 12(G) — 1/2" CONDUIT. $3 \# 12 \& 1 \# 12$ (G) — 3/4" CONDUIT. $4 \# 12 \& 1 \# 12$ (G) — 3/4" CONDUIT.
£ 0	EMPTY CONDUIT - 3/4".
	BRANCH CIRCUIT EXPOSED.
<u>(5)</u>	MOTOR SHOWN 5hp (TYPICAL) OR $\overline{40}$ 40 AMPS (TYPICAL).
(f)	EXHAUST FAN MOTOR - FRACTIONAL HORSEPOWER.
\bowtie	MAGNETIC MOTOR STARTER.
	NON-FUSED DISCONNECT SWITCH. (RT - RAINTIGHT).
	FUSED DISCONNECT SWITCH. (RT - RAINTIGHT).
EX.	EXISTING ELECTRICAL EQUIPMENT TO REMAIN UNLESS OTHERWISE NOTED.
A.F.F.	ABOVE FINISHED FLOOR.
A.F.G.	ABOVE FINISHED GRADE.

BELOW FINISHED CEILING.

NATIONAL ELECTRICAL CODE.

VERIFY LOCATION.

VER.

LIGHTING FIXTURE SCHEDULE

			LAMPS		MOUNTING HEIGHT	TYPE	RECESS	
MARK	MANUFACTURER	CATALOG NO.	NO. WATTS	TYPE	WICONTING REIGHT	MOUNTING	DEPTH	REMARKS
Р3	LITHONIA	RAD1 LED-P1-50K-PATH-240-RPA-DF-DDBXD	FURNISHED WITH	FIXTURE	+14' A.F.F.	POLE		SEE NOTES 1, 2 & 3
P4	LITHONIA	RAD1 LED-P1-50K-PATH-240-RPA-DF-DDBXD(QTY OF 2)	FURNISHED WITH	FIXTURE	+14' A.F.F.	POLE		SEE NOTES 1, 2 & 4
NOTES								

1. VERIFY FINISH WITH ARCHITECT.

2. EQUAL FIXTURES BY COLUMBIA OR DAY-BRITE WILL BE ACCEPTABLE.

3. PROVIDE WITH RSA-14-4C-DM19RAD-DDBXD-BC POLE 4. PROVIDE WITH RSA-14-4C-DM28RAD-DDBXD-BC POLE


GENERAL NOTES

- 1. ALL ELECTRICAL WORK SHALL BE DONE IN ACCORDANCE WITH THE NATIONAL ELECTRICAL CODE AND LOCAL ORDINANCES. CONTRACTOR SHALL OBTAIN AND PAY FOR ALL NECESSARY PERMITS.
- 2. CONTRACTOR SHALL VISIT THE SITE AND FAMILIARIZE HIMSELF WITH ALL DETAILS OF THE WORK AND ALL EXISTING FIELD
- 3. CONTRACTOR SHALL PROVIDE A COMPLETE ELECTRICAL INSTALLATION INCLUDING ALL WORK CUSTOMARILY INCLUDED EVEN IF
- 4. THE CONTRACTOR SHALL CAREFULLY COORDINATE HIS WORK WITH OTHER CONTRACTORS THROUGH THE GENERAL CONTRACTOR FOR SPACE REQUIREMENTS, ETC.
- 5. SHOULD THE CONTRACTOR FIND DISCREPANCIES OR OMISSIONS IN THE CONTRACT DOCUMENTS OR BE IN DOUBT AS TO INTENT, HE SHALL IMMEDIATELY OBTAIN CLARIFICATION FROM THE ARCHITECT.
- 6. THE ELECTRICAL DRAWINGS ARE SCHEMATIC AND ARE NOT INTENDED TO SHOW THE EXACT LOCATION OF CONDUIT, OUTLETS, ETC.. THE CONTRACTOR SHALL REFER TO ARCHITECTURAL, MECHANICAL AND PLUMBING DRAWINGS AND SHALL FIT HIS WORK TO CONFORM WITH THE BUILDING CONSTRUCTION AND WITH THE OTHER TRADES.
- 7. MOUNTING HEIGHTS OF ALL WALL OUTLETS SHALL BE AS FOLLOWS UNLESS OTHERWISE INDICATED: WALL SWITCHES......4'-0" RECEPTACLES......1'-6"
- 8. CONTRACTOR SHALL CHECK ALL LIGHT FIXTURES FOR EXACT MOUNTING TYPE AND SPACE REQUIRED PRIOR TO ROUGH-IN.
- 9. BRANCH CIRCUITS SHALL BE #12 AWG AND 1/2" CONDUIT MINIMUM. CONDUCTORS SHALL BE 98% CONDUCTIVITY COPPER. SEE SPECIFICATIONS FOR INSULATION TYPE.
- 10. ALL CONDUITS CROSSING EXPANSION JOINTS SHALL HAVE EXPANSION TYPE FITTINGS.
- 11. VERIFY EXACT LOCATION OF ALL EQUIPMENT BEFORE ROUGHING IN.
- 12. SUPPORT OF ALL LIGHTING FIXTURES SHALL BE THE RESPONSIBILITY OF THIS CONTRACTOR. SEE SPECIFICATIONS FOR SUPPORTING METHODS.
- 13. COORDINATE SERVICES WITH POWER AND COMMUNICATION COMPANIES. REMOVE OR RELOCATE ALL POWER AND COMMUNICATIONS CIRCUITS ABOVE OR BELOW GRADE THAT WOULD OBSTRUCT CONSTRUCTION OF THE PROJECT OR CONFLICT IN ANY MANNER WITH COMPLETION OF THE PROJECT OR ANY CODE PERTAINING THERETO. IF UTILITY COMPANY REQUIREMENTS ARE AT A VARIANCE WITH THESE DRAWINGS AND SPECIFICATIONS, THE CONTRACT PRICE SHALL INCLUDE THE ADDITIONAL COST.
- 14. THIS CONTRACTOR SHALL INSTALL EQUIPMENT GROUNDS THROUGHOUT THIS PROJECT, USING GREEN INSULATED CONDUCTORS. USE OF CONDUIT AS THE ONLY GROUND CONDUCTOR WILL NOT BE ALLOWED. SIZE GROUND CONDUCTORS PER
- 15. CONTRACTOR SHALL FIELD MARK ALL ELECTRICAL EQUIPMENT WITH ARC-FLASH WARNING LABELS PER NEC 110.16.
- 16. CONTRACTOR SHALL PROVIDE RECORD DRAWINGS AND MANUALS THAT PROVIDE INSTRUCTION ABOUT OPERATION AND MAINTENANCE OF THE BUILDING ELECTRICAL DISTRIBUTION SYSTEM TO THE OWNER WITHIN 30 DAYS AFTER THE DATE OF SYSTEM ACCEPTANCE.
- 17. CONTRACTOR SHALL COORDINATE VOLTAGE AND PHASE OF EACH PIECE OF ELECTRICAL EQUIPMENT WITH THE ELECTRICAL CONTRACTOR PRIOR TO SUBMITTING AND ORDERING EQUIPMENT.
- 18. VERIFY EXACT LOCATION AND EXACT MOUNTING HEIGHT OF ALL ELECTRICAL EQUIPMENT AND ELECTRICAL CONNECTIONS WITH THE ARCHITECT THE OWNER PRIOR TO ROUGH-IN.
- 19. ANY SOILS REQUIRING DISPOSAL SHALL BE APPROVED FOR DISPOSAL IN A QUALIFIED LANDFILL AND THE RECORDS OF DISPOSAL PROVIDED TO THE OWNER'S REPRESENTATIVE.
- 20. IF CULTURAL RESOURCES ARE INADVERTENTLY DISCOVERED DURING THE COURSE OF THE PROJECT, WORK SHALL HALT IMMEDIATELY AND THE ARCHITECT AND OWNER'S REPRESENTATIVE SHALL BE IMMEDIATELY NOTIFIED. WORK WILL NOT RESUME UNTIL DIRECTED BY THE OWNER'S REPRESENTATIVE.
- 21. CONTRACTOR SHALL RESTORE ANY DISRUPTED AREAS OR DAMAGE TO THE EXISTING GRAVEL RUNNING TRACK TO THE SAME STATE IT WAS IN PRIOR TO THE BEGINNING OF THE WORK. FINAL ACCEPTANCE WILL BE BY THE OWNER'S REPRESENTATIVE.
- 22. REPAIR ADJACENT CONSTRUCTION AND FINISHES DAMAGED DURING DEMOLITION AND EXTENSION WORK.

Architecture, PC

445 Dexter Avenue Suite 5050 Montgomery, Al 36104

Phone: (334) 420-5672 Fax: (334) 420-5692

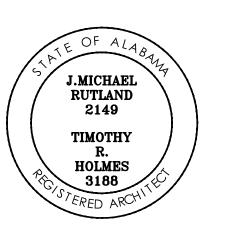

FMTC TRACK

ANNISTON, ALABAMA IFB#: AC-22-B-0024-S

CONSTRUCTION **DOCUMENTS**

Project Number: 21-1142 20 JULY 2022


Sheet Description

SYMBOLS, NOTES, FIXTURE SCHEDULE


Sheet Number



2 OF 3

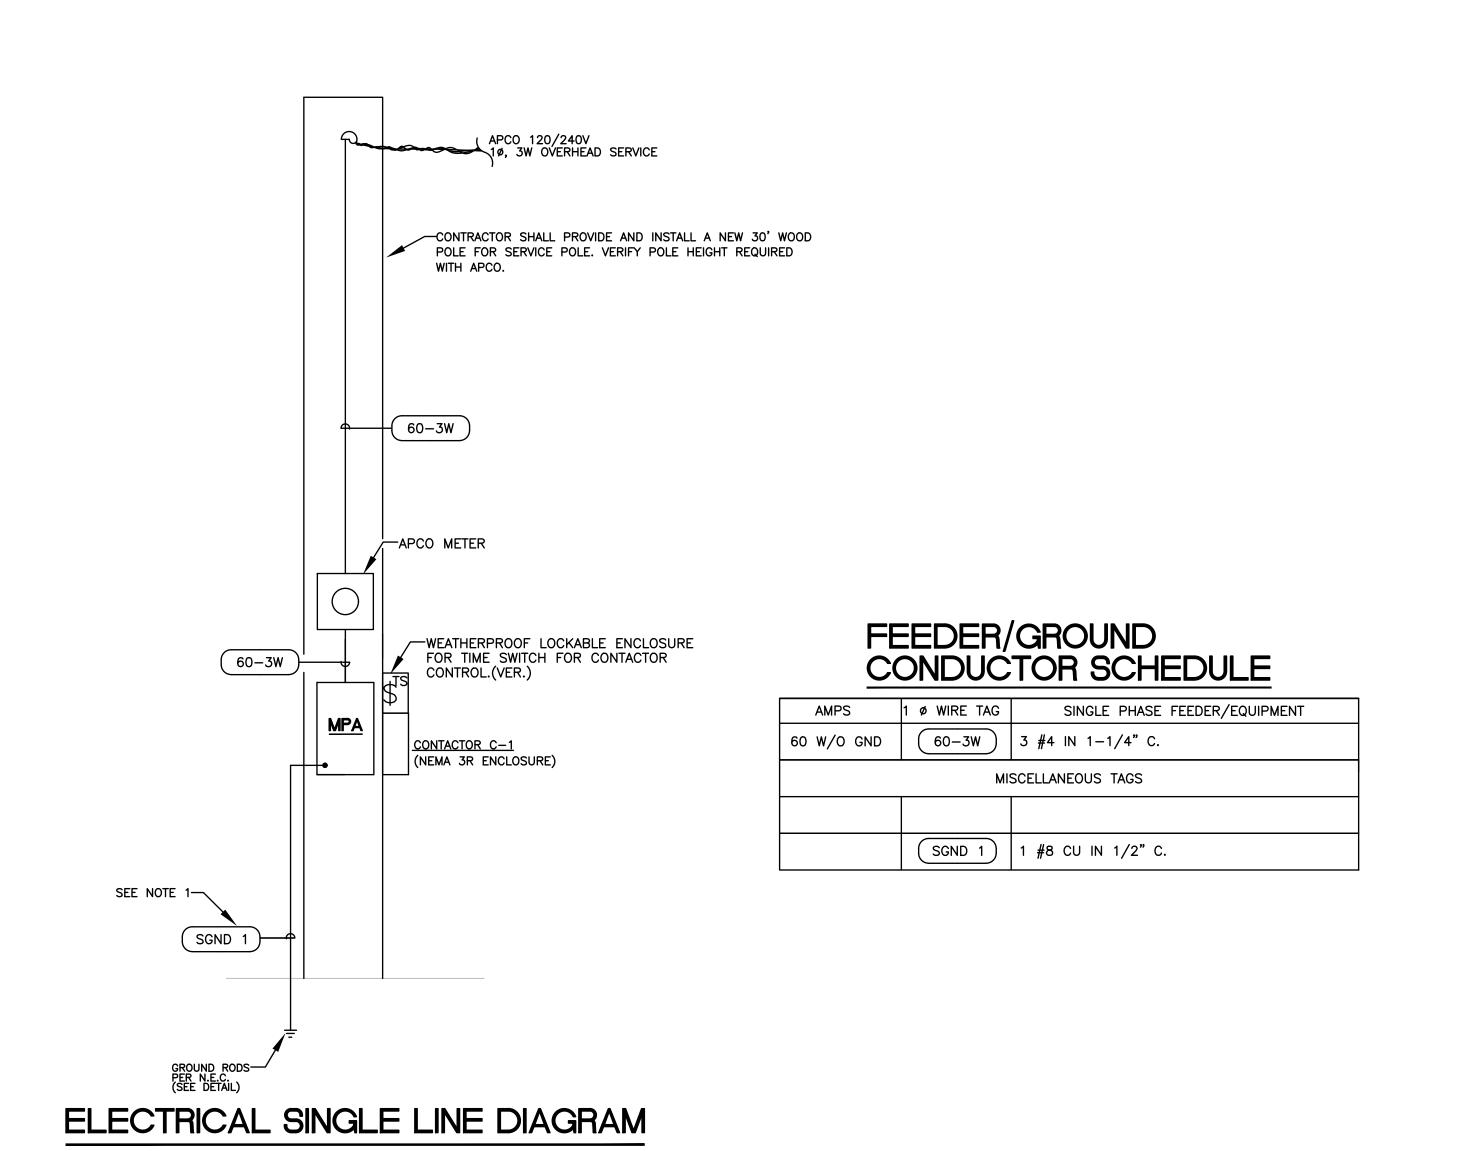


NOTES:
1. SEE SCHEDULE ON THIS SHEET FOR WIRE SIZE. (TYP)

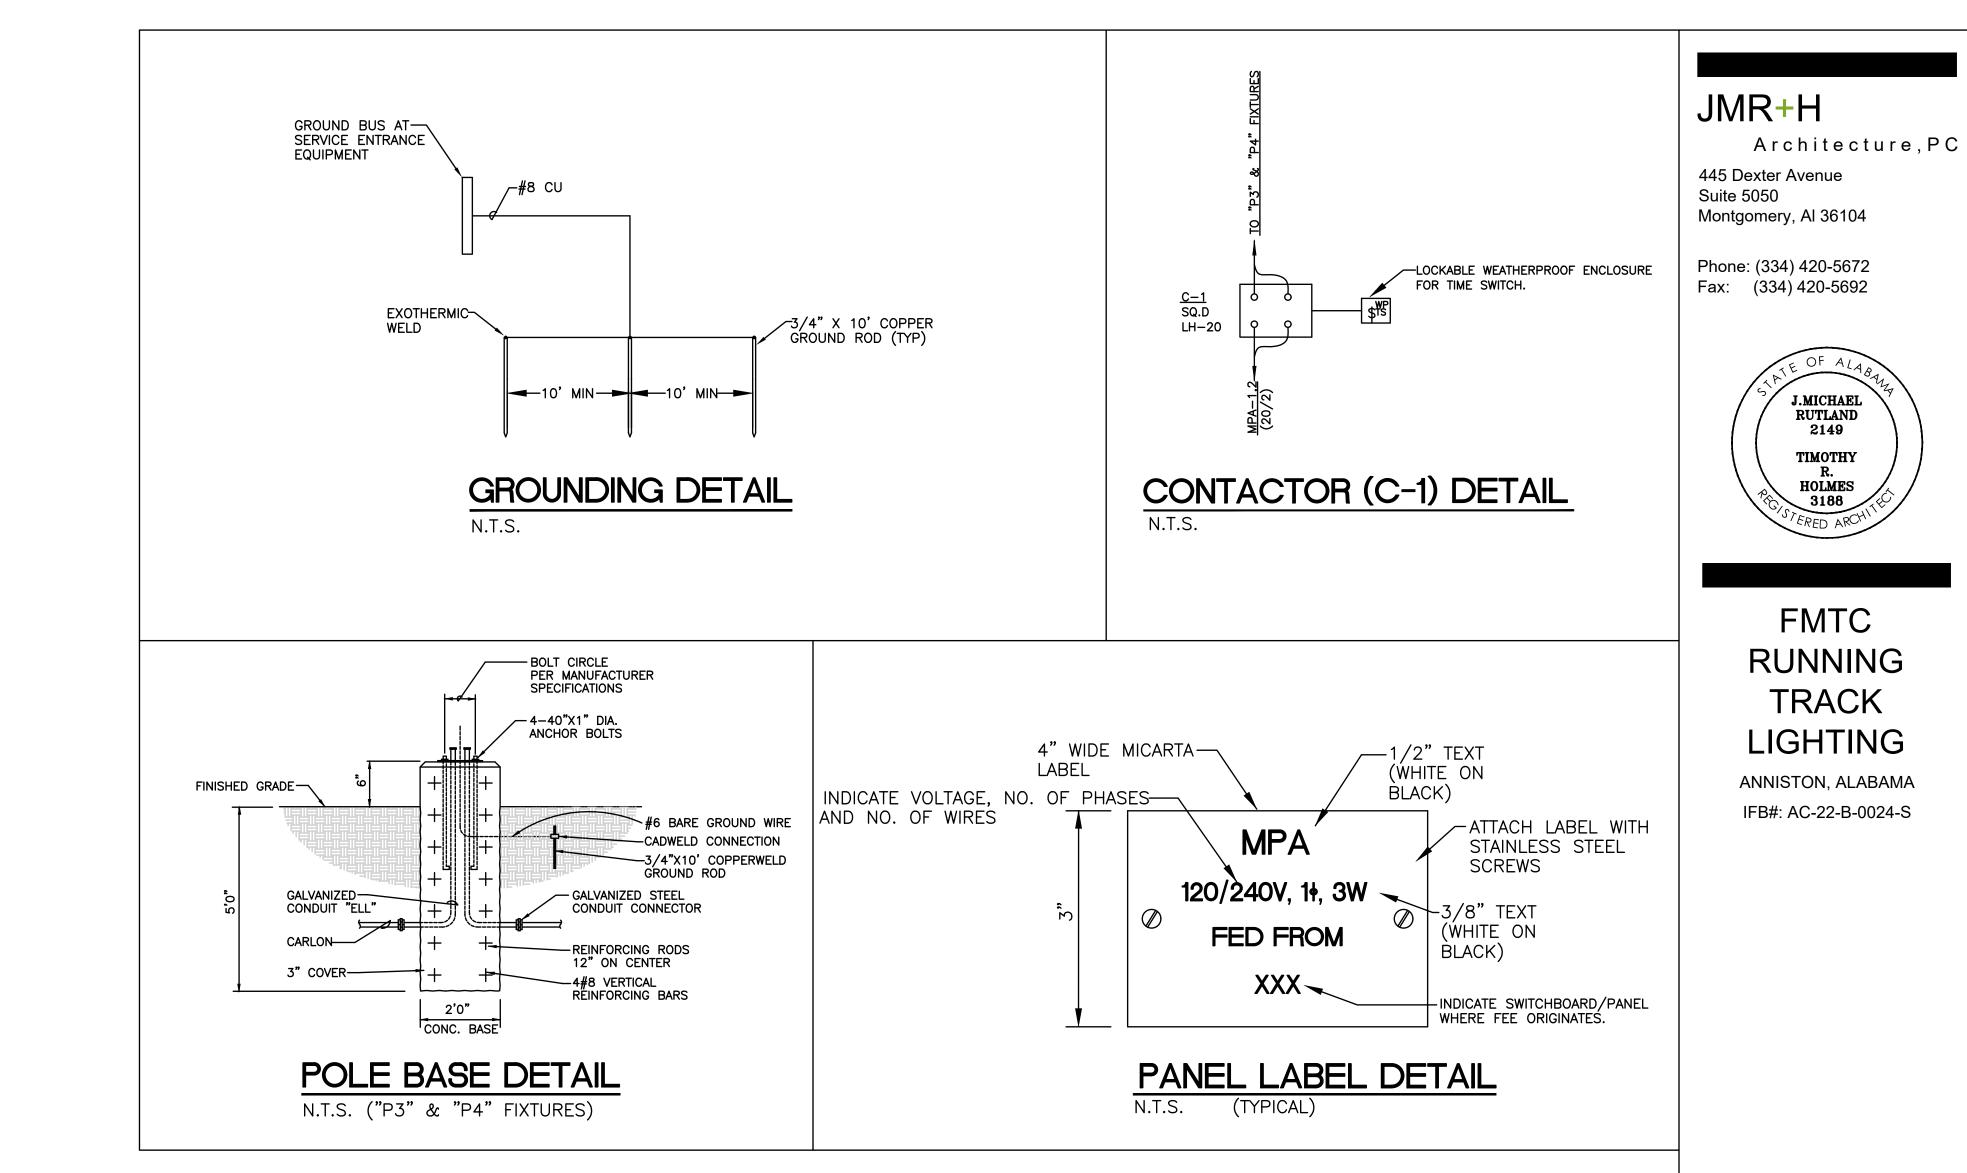

PANELBOARD SCHEDULE

MARK TYPE	TYPE	MAINS		BRANCHES				LUG	TYPE	MINIMUM AIC	REMARKS			
IVIA		IIIE	TYPE	AMPS	SERVICE	1 POLE	2 POLE	3 POLE	SPARES	SPACES	LOCATION	MOUNTING	RATING	NEMANKS
MP	4	NQOD	МВ	60	120/240V 1ø, 3W		1-20		6-20/1	10-1PS	TOP	SURFACE	VERIFY WITH APCO	SEE NOTES 1, 2 & 3

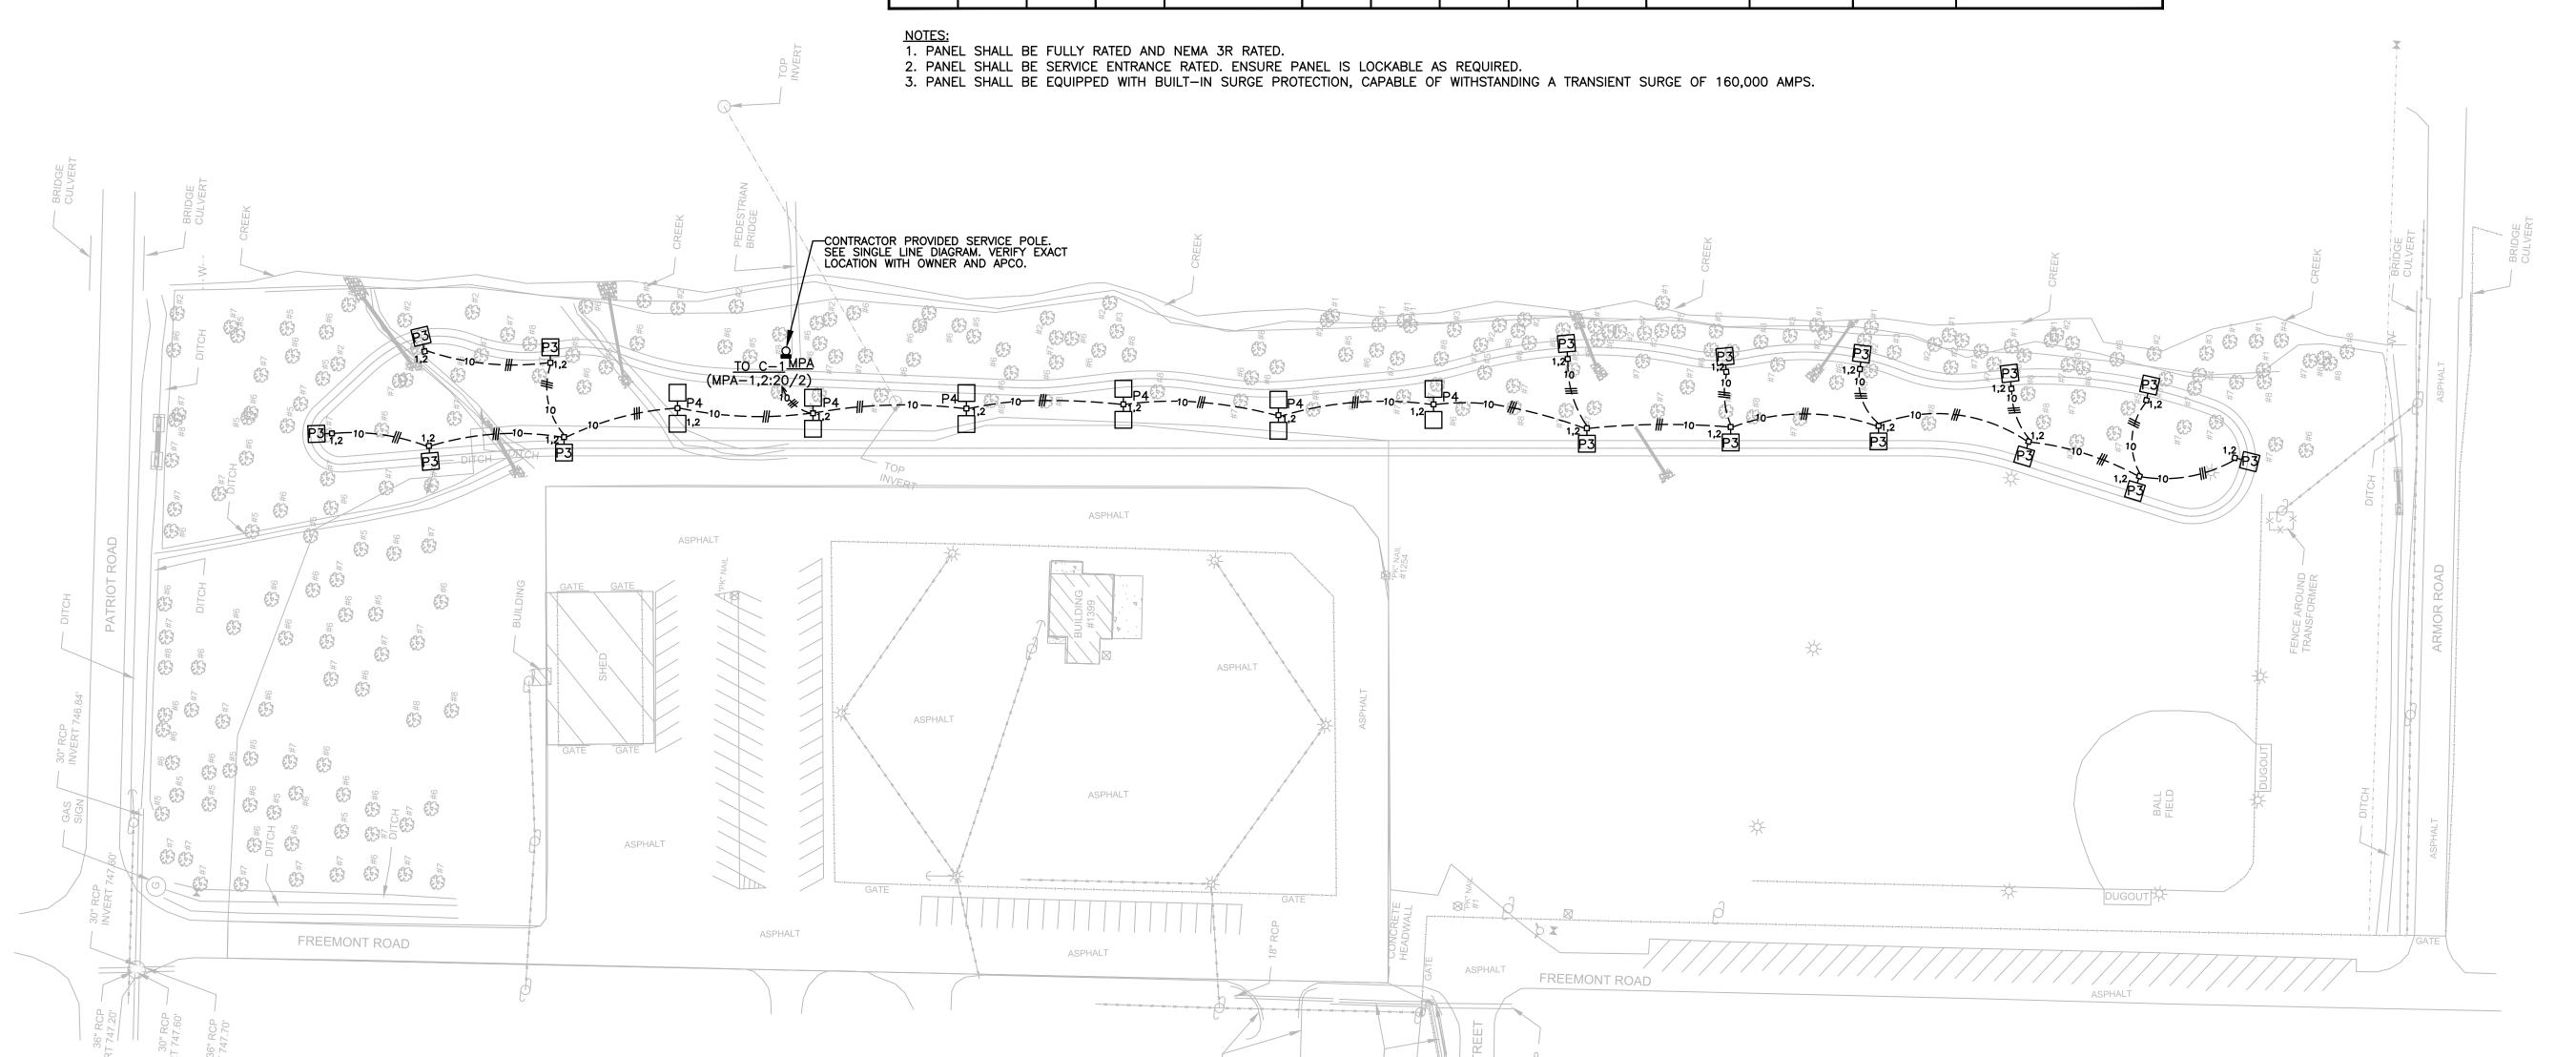

NOTE: ALL 120 VOLT CIRCUIT WIRE SIZES SHALL BE BASED UPO

NOTE:
ALL 120 VOLT CIRCUIT WIRE SIZES SHALL BE BASED UPON DISTANCE FROM PANELBOARD FEEDING THE CIRCUITS AS FOLLOWS AND THE CIRCUITS SHALL HAVE A 3% VOLTAGE DROP OR LESS:
LESS THAN 75 FEET......#12 AWG
BETWEEN 76' AND 125'.....#10 AWG
BETWEEN 126' AND 190'....#8 AWG

FOOTCANDLE CALCULATIONS

AVG FC | MAX FC | MIN. FC

1.7 FC

0.20 FC

0.60 FC





PLAN AND DETAILS

Sheet Number

Sheet Description

SINGLE LINE

DIAGRAM,

SCHEDULES,

ELECTRICAL SITE

CONSTRUCTION

DOCUMENTS

Project Number: 21-1142

20 JULY 2022

E2.1

3 OF 3

ELECTRICAL SITE PLAN

SCALE: 1" = 60'-0"

NOTES:

1. THE CONTRACTOR SHALL CLOSELY COORDINATE ALL POLE LOCATIONS WITH THE OWNER PRIOR TO INSTALLING FOR DESIGN COMPLIANCE AND TO AVOID ANY TREE REMOVAL.