




Rocket Center


BID SET FOR CONSCTUCTION FEBRUARY 05, 2024

CODE-REQUIRRED SIGNAGE

PANEL SIGN - SEE SPECIFICATIONS. BACKGROUND COLOR AND LETTER COLORS TO BE DETERMINED. SEE DOOR SCHEDULE FOR DOOR LOCATIONS AND ROOMS ASSOCIATED WITH SIGNAGE. SIGNS TO BE MOUNTED ON WALLS NEAR DOOR LATCH SIDE (T.O. SIGNS AT 5'-0" AFF). COORD. EXACT LOCATIONS W/ ARCH. ALL SIGNAGE SHALL COMPLY WITH ADA 703, INCLUDING SANS SERIF TYPESTYLE, CHARACTER DEPTH/CASE/PROPORTIONS/HEIGHT/SPACING, STROKE THICKNESS, LINE SPACING, BRAILLE, DIMENSIONS, CAPITALIZATION, INSTALLATION HEIGHT

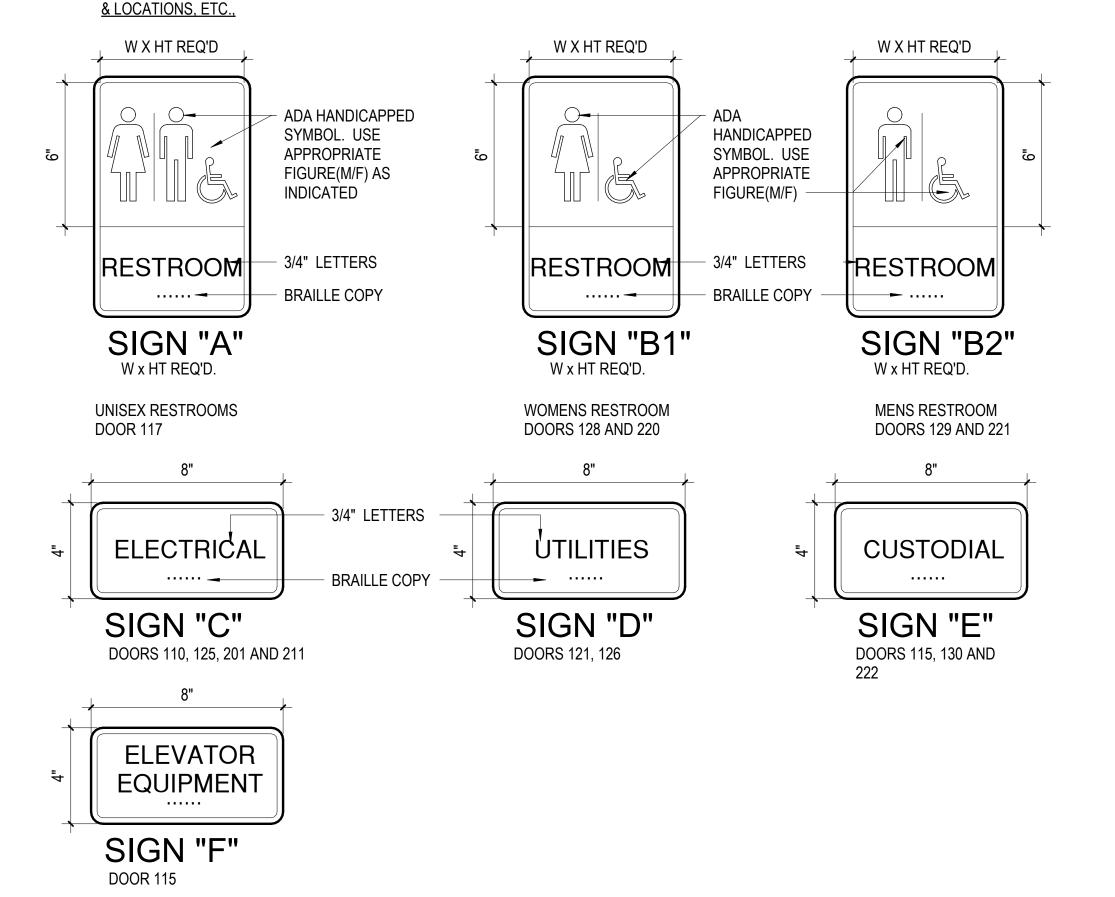

ACCESSIBILITY STANDARDS - TOILET INSTALLATION

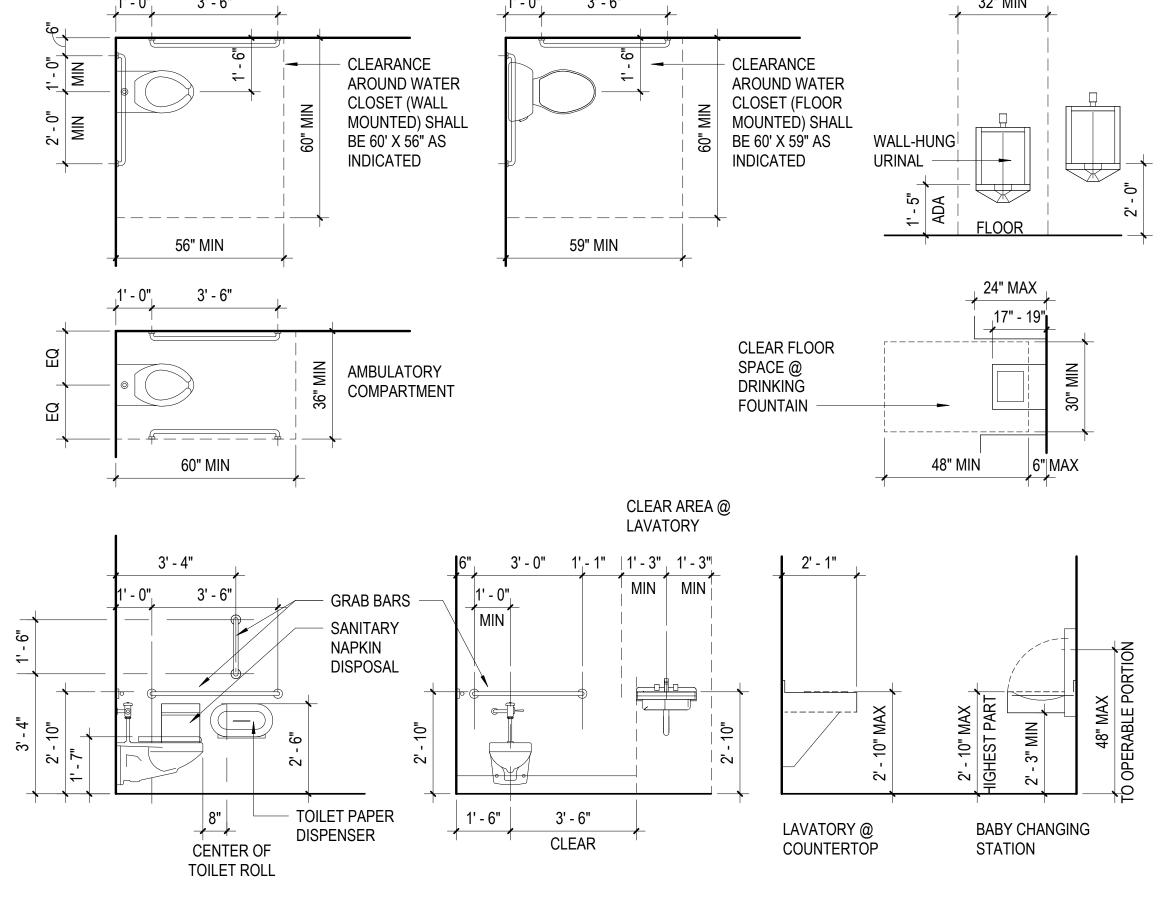

MATERIAL NOTES - PAINT AND WALLCOVERING

- 1. PRIOR TO THE APPLICATION OF PAINT AND WALL COVERING, THE CONTRACTOR SHALL REPAIR NEW SURFACES BY PATCHING, SMOOTHING, AND SANDING AS NEEDED TO ACHIEVE A SURFACE ACCEPTABLE FOR THE APPLICATION OF NEW FINISH. PREPARE DOOR FRAMES OR METAL SURFACES BY SANDING CHIPS/BURRS, FILLING DENTS AND CAULKING CRACKS AT CORNERS AS REQUIRED.
- 2. UNLESS OTHERWISE STATED IN THE SPECIFICATIONS, ALL PAINTED SURFACES ARE TO RECEIVE ONE PRIME AND A MINIMUM OF TWO FINISH COATS. PRIME ALL SURFACES ACCORDING TO MANUFACTURERS SPECIFICATIONS PRIOR TO APPLICATION OF PAINT. THE NUMBER OF COATS SPECIFIED IS THE MINIMUM NUMBER REQUIRED. APPLY ADDITIONAL COATS WHEN UNDERCOATS, STAINS, OR OTHER CONDITIONS SHOW THROUGH FINAL COAT OF PAINT AND UNTIL PAINT FILM IS OF UNIFORM FINISH, COLOR, AND APPEARANCE.
- 3. CAULK ALL DOOR FRAMES, MILLWORK AND VIEW WINDOW FRAMES AFTER WALLCOVERING INSTALLATION IS COMPLETE. COLOR OF CAULK TO MATCH ADJACENT FINISH, UNLESS OTHERWISE NOTED.
- MISCELLANEOUS METAL (RETURN AND AIR SUPPLY GRILLES, EXPANSION JOINTS, ETC.) LOCATED ON WALL SURFACES IS TO BE PAINTED TO MATCH

ADJACENT WALL COLOR.

- ALL EXISTING GYPSUM BOARD SOFFITS AND BULKHEADS WITHIN SCOPE OF WORK SHALL BE PAINTED CEILING WHITE UNLESS OTHERWISE NOTED.
- CABINETS SHALL BE PAINTED THE SAME COLOR AS THE ADJACENT WALL UNLESS OTHERWISE NOTED.

WHERE PAINT IS SPECIFIED, GYPSUM BOARD SOFFITS ABOVE WALL

- WHEN WALL COVERING IS SPECIFIED, PROVIDE A MINIMUM OF 1 COAT OF WALL COVERING PRIMER AS RECOMMENDED BY WALL COVERING MANUFACTURER TO WALL SURFACES NOT PREVIOUSLY PAINTED.
- DO NOT PAINT ITEMS REQUIRED BY CODE TO BE A CERTAIN COLOR SUCH AS FIRE ALARM PULLS, ETC.
- 9. ALL PAINT GRADE ARCHITECTURAL MILLWORK (WOOD TRIM, ETC., IF APPLICABLE TO BE SEMI-GLOSS FINISH. REFER TO ELEVATIONS, SECTIONS, AND DETAILS FOR COLORS.
- 10. ALL HOLLOW METAL DOOR FRAMES AND INTERIOR HOLLOW METAL WINDOW FRAMES TO BE PAINTED AS INDICATED IN THE FINISH MATERIAL LEGEND UNLESS OTHERWISE NOTED.

MATERIAL NOTES - FLOORING

- WHEN CARPET TILES ARE SPECIFIED, ALWAYS REFER TO THE MANUFACTURERS RECOMMENDED INSTALLATION PROCEDURES BEFORE INSTALLING THE PRODUCT. INSTALL CARPET TILES WITH ADHESIVES RECOMMENDED BY THE MANUFACTURER. SNAP A CHALK LINE TO FORM FOUR QUADRANTS AT 90 DEGREE ANGLES TO INSURE THE TILES ARE LAID STRAIGHT. START INSTALLATION OF CARPET TILES AT THE CENTER OF THE ROOM AND LAY-OUT IN A MANNER SO THAT CUT TILE DIMENSIONS ARE MAXIMIZED AT THE PERIMETER UNLESS NOTED OTHERWISE.
- CARPET TILES WILL HAVE ARROWS EMBOSSED ON THE BACK SHOWING PILE DIRECTION. REFER TO FINISH MATERIAL LEGEND FOR INSTALLATION METHOD. (1/4 TURN, MONOLITHIC, ETC.)
- 3. WHERE FLOORING AND/OR BASE IS SPECIFIED, THE SAME FLOOR COVERING AND/OR BASE SHALL EXTEND INTO ANY CLOSETS, STORAGE AREA, ETC. ADJACENT TO THE SPACE UNLESS OTHERWISE NOTED.
- REFER TO FINISH MATERIAL LEGEND AND INTERIOR DETAILS FOR TRANSITIONS BETWEEN FLOORING MATERIAL TYPES. CONTACT THE INTERIOR DESIGNER ON ANY TRANSITION NOT SPECIFIED OR INDICATED.
- WHERE SIMILAR MATERIALS (SUCH AS VCT) ARE USED IN ADJACENT SPACES, TRANSITION MATERIALS AT THE CENTERLINE OF DOOR IN CLOSED POSITION WITH A TRANSITION CUT ONLY. DO NOT INSTALL FEATURE STRIPS OR OTHER TRANSITION MATERIALS AT VCT TO VCT OR OTHER (SIMILAR FLOORING MATERIAL) BETWEEN ROOMS AND SPACES UNLESS OTHERWISE NOTED.
- . WHERE FLOOR PATTERNS TERMINATE AT A DOOR OPENING, EXTEND PATTERN INTO DOORWAY AND TERMINATE BELOW DOOR PANEL IN CLOSED POSITION.
- AT ALL FLOORING TRANSITIONS BETWEEN PORCELAIN/ CERAMIC TILE AND CARPET OR VINYL TILE USE "SCHEINE" EXTENDED ALUMINUM TRANSITION BY SCHLUTER SYSTEMS, UNLESS OTHERWISE NOTED. REFER TO FLOORING TRANSITION DETAILS.

MATERIAL NOTES - MILLWORK

- 1. CAULK ALL LAMINATE TO LAMINATE SEAMS WITH CAULK THAT MATCHES LAMINATE. DO NOT USE CLEAR CAULK.
- CAULK ALL LAMINATE/MILLWORK TO WALL WITH CAULK THAT MATCHES THE WALL COLOR.
- ALL SIDES AND EDGES OF INTERIOR SHELVING MUST BE LAMINATED. EDGES SHOULD BE COVERED IN 3MM PVC EDGE BANDING AS NOTED IN FINISH MATERIAL LEGEND.

GENERAL FINISH NOTES

- 1. ALL FINISH MATERIALS SHALL BE SUPPLIED AS INDICATED IN THE FINISH MATERIAL LEGEND. NO SUBSTITUTIONS WILL BE ALLOWED UNLESS APPROVED IN WRITING BY THE ARCHITECT / DESIGNER.
- 2. FOR CLARIFICATION OF MULTIPLE FINISH LOCATIONS, MILLWORK /
 CASEWORK OR OTHER SPECIAL TREATMENT AREAS, REFER TO THE
 ELEVATIONS, SECTIONS AND DETAILS. IF QUESTIONS ARISE, CONTACT THE
 ARCHITECT / DESIGNER.
- 3. REFER TO FINISH PLANS, FLOOR PATTERN PLANS, ELEVATIONS, DETAILS AND FINISH MATERIAL LEGEND FOR ADDITIONAL CLARIFICATION OF WORK TO BE PERFORMED.
- 4. ALL FINISH APPLICATIONS SHALL BE FREE OF IMPERFECTIONS.
- 5. ALL SURFACES TO RECEIVE A FINISH APPLICATIONS SHALL BE COMPLETELY SMOOTH. IF SURFACES ARE NOT ACCEPTABLE TO RECEIVE FINISHES, NOTIFY THE GENERAL CONTRACTOR AND HAVE SURFACES CORRECTED PRIOR TO BEGINNING FINISH WORK.
- CONTRACTOR SHALL PROVIDE SUBMITTALS TO THE ARCHITECT /
 DESIGNER PRIOR TO FABRICATING OR PURCHASING MATERIALS. ALL
 SUBMITTALS SHALL BE CLEARLY MARKED WITH MANUFACTURER, STYLE,
 COLOR AND FINISH MATERIAL LEGEND CODE. PAINT SUBMITTALS SHALL
 INCLUDE STORE LOCATION AND PAINT COLOR FORMULA. ALL ITEMS SHALL
 BE SUBMITTED WITH ADEQUATE TIME FOR REVIEW AND RESUBMITTING IF
 NEEDED. WHERE FEASIBLE, ACTUAL PRODUCT SAMPLES SHALL BE
 SUBMITTED.
- 7. CAULK ALL PLUMBING FIXTURES, MILLWORK, AND TRIM TO ADJACENT SURFACES. COLOR OF CAULK TO MATCH ADJACENT FINISH, UNLESS OTHERWISE NOTED. REFER TO MILLWORK NOTES FOR CAULKING MILLWORK.
- 8. SHOULD ANY QUESTIONS ARISE REGARDING THE FINISH DRAWINGS OR SPECIFICATIONS WHICH REQUIRE CLARIFICATION, THE ARCHITECT / DESIGNER IS TO BE CONSULTED BEFORE PROCEEDING. THE ARCHITECT / DESIGNER IS NOT RESPONSIBLE FOR DISCREPANCIES THAT ARISE DUE TO CHANGES BY CONTRACTORS, CONSULTANTS, LANDLORDS, OR OWNERS AFTER THE DATE OF ISSUING OF THESE DRAWINGS.
- 9. ITEMS REQUIRING FINISH SELECTIONS WHICH DO NOT APPEAR IN THE FINISH SCHEDULE SHALL BE SELECTED FROM SAMPLE SUBMITTALS MADE TO THE ARCHITECT / DESIGNER. REFER TO SPECIFICATION SECTIONS FOR ADDITIONAL SUBMITTAL REQUIREMENTS IN ADDITION TO MATERIAL SAMPLE SUBMITTALS INDICATED IN THE FINISH MATERIAL LEGEND.
- 10. ALL PARTIES RESPONSIBLE FOR DELIVERING FINISHES TO THE SITE SHALL CHECK AVAILABILITY OF QUANTITIES AND DELIVERY DATES AS SOON AS CONTRACT IS AWARDED TO AVOID RE-SELECTION OF MATERIAL. SOME ITEMS MAY HAVE LONG LEAD TIMES.
- 11. REFER TO SPECIFICATIONS FOR ADDITIONAL PRODUCT INFORMATION NOT INCLUDED IN THE FINISH LEGEND, NOTES OR PLANS.
- 12. CONTRACTOR TO PROVIDE SURPLUS STOCK AS INDICATED IN THE SPECIFICATIONS. SURPLUS STOCK SHALL BE PROVIDED ON EACH DIFFERENT PRODUCT MANUFACTURER, STYLE, COLOR AND FINISH SPECIFIED. REFER TO SPECIFICATIONS SECTION (IF APPLICABLE) FOR ADDITIONAL INFORMATION. FINAL PAYMENT SHALL NOT BE MADE UNTIL STOCK IS DELIVERED.
- 13. LAY-OUT ALL WALL, FLOOR OR OTHER PATTERNS BASED UPON DIMENSIONS INDICATED. IF THE PATTERN PLACEMENT IS UNCLEAR DO NOT SCALE DRAWINGS. CONTACT THE ARCHITECT / DESIGNER FOR DIRECTION.

G R O U

104 Jefferson St. S. Suite 200,
Huntsville, AL 35801

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U.S. Space & Rocket Center

ISSUED: FOR CONSCTUCTION

ISSUE DATE: FEBRUARY 05, 2024

REVISIONS

No. Description Date

DRAWING TITLE

FINISHES NOTES &

GENERAL

ROJECT STATUS:


SCHEDULES

CHECKED BY:
PROJECT NUMBER
225029-00

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ACCESSIBILITY DIAGRAM - MOUNTING HEIGHT STANDARDS


NOTE: ALL HEIGHTS SHOWN REPRESENT MAXIMUM ALLOWABLE HEIGHTS IN ACCORDANCE WITH THE ADA GUIDELINES.

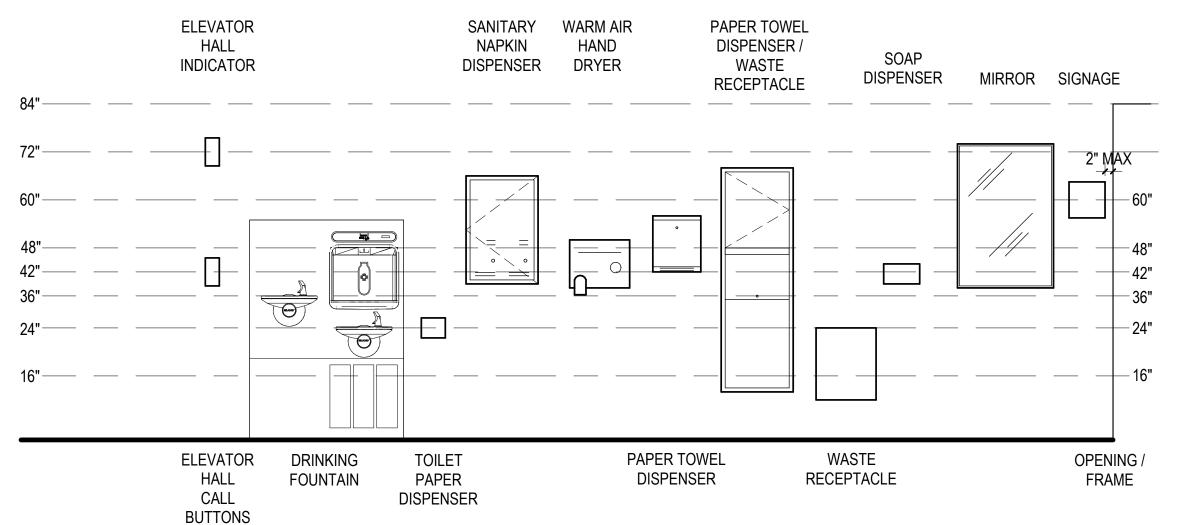

MARK	WIDTH	DESCRIPTION	SUFFIX
A2	7 1/4"	2 1/2" MTL STUDS W/ 1" GAP	g - GLASS-MATT
A3	9 1/2"	3 5/8" MTL STUDS W/ 1" GAP	I - LEAD LINED w - WATER-RESISTANT
A4	10 1/4"	4" MTL STUDS W/ 1" GAP	
A6	1'-2 1/4"	6" MTL STUDS W/ 1" GAP	


FINISHED FLOOR, RE.: FINISH SCHEDULE

TYPE 'S' - STEEL STUDS, NON-BEARING GWB

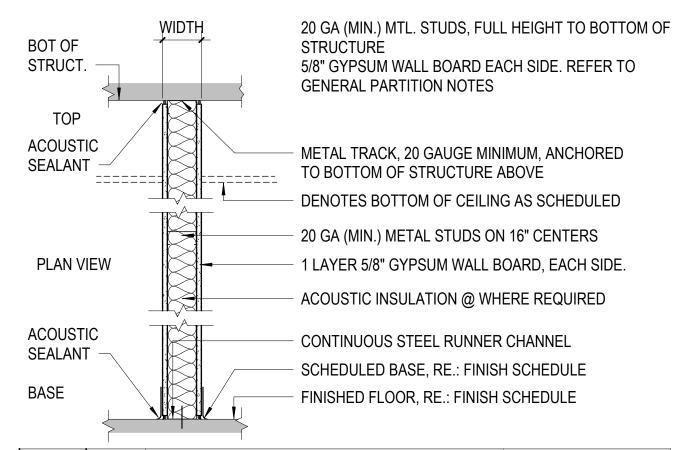


		·	
MARK	WIDTH	DESCRIPTION	SUFFIX
S2	3 1/4"	2-1/2" MTL STUDS	a - SOUND
S3	4 7/8"	3-5/8" MTL STUDS	g - GLASS-MATT I - LEAD LINED
S6	7 1/4"	6" MTL STUDS	w - WATER-RESISTAN
S8	9 1/4"	8" MTL STUDS	s - SMOKE BARRIER

TYPE 'C' - PLUMBING CHASE

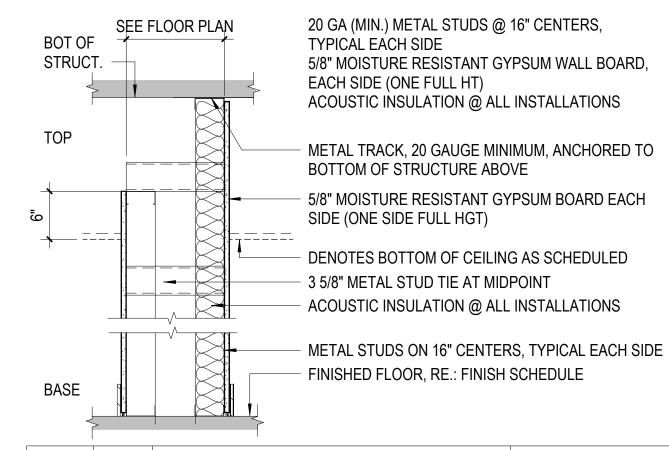


<u>'</u>			
MARK	WIDTH	DESCRIPTION	SUFFIX
C3		3 5/8" MTL STUDS	g - GLASS-MATT
C4		4" MTL STUDS	I - LEAD LINED
C6		6" MTL STUDS	
C8		8" MTL STUDS	

TYPE 'SH' - FIRE RATED SHAFT (CHASE) WALL

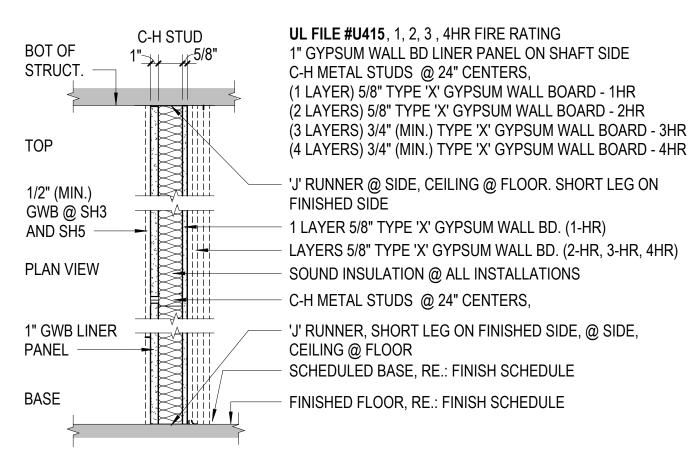


	'		
MARK	WIDTH	DESCRIPTION	SUFFIX
SH2/		2 1/2" MTL C-H STUDS, TYPE 'X' GWB FINISHED SIDE	, J
SH4/		4" MTL C-H STUDS, TYPE 'X' GWB FINISHED SIDE	I - LEAD LINED w - WATER-RESISTANT
SH3/		2 1/2" MTL. C-H STUDS, TYPE 'X' GWB EA. SIDE	
SH5/		4" MTL C-H STUDS, TYPE 'X' GWB EA. SIDE	

TYPE 'F' - WALL FURRING

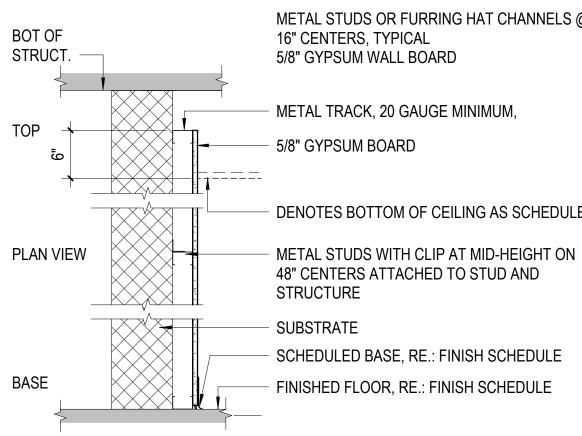


<	>	* * * * * * * * * * * * * * * * * * * 	
MARK	WIDTH	DESCRIPTION	SUFFIX
F1	2 1/4"	1 5/8" MTL STUDS	g - GLASS-MATT
F2	3 1/8"	2 1/2" MTL STUDS	I - LEAD LINED w - WATER-RESISTAN
F3	4 1/4"	3 5/8" MTL STUDS	
FH	1 1/2"	7/8" MTL HAT CHANNELS	

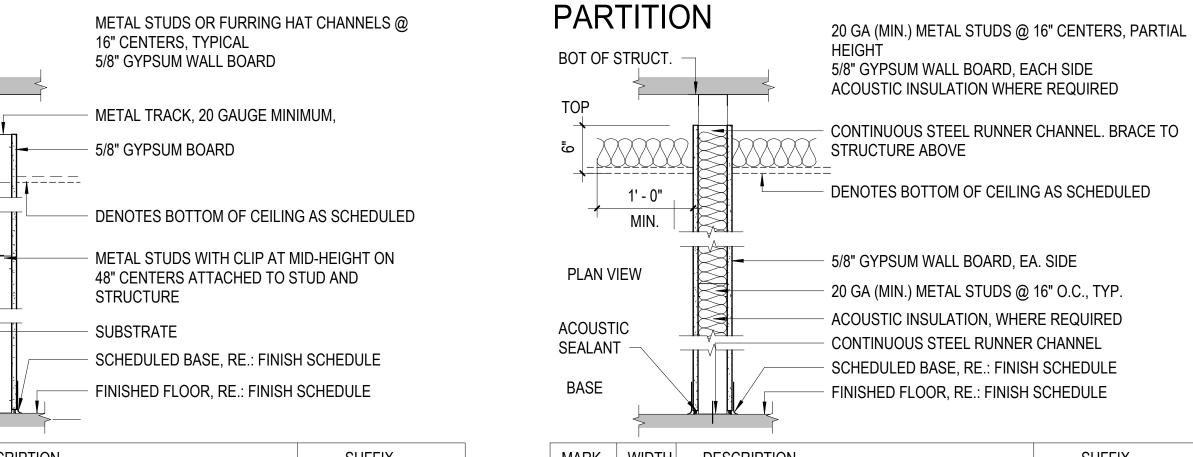

MARK	WIDTH	DESCRIPTION	SUFFIX
H2	3 1/4"	2-1/2" MTL STUDS	a - SOUND
H3	4 7/8"	3-5/8" MTL STUDS	g - GLASS-MATT I - LEAD LINED
H6	7 1/4"	6" MTL STUDS	w - WATER-RESISTANT
H8	9 1/4"	8" MTL STUDS	

TYPE 'H' - PARTIAL HEIGHT STEEL STUD

TYPE 'U' - FIRE RATED STEEL STUD PARTITION

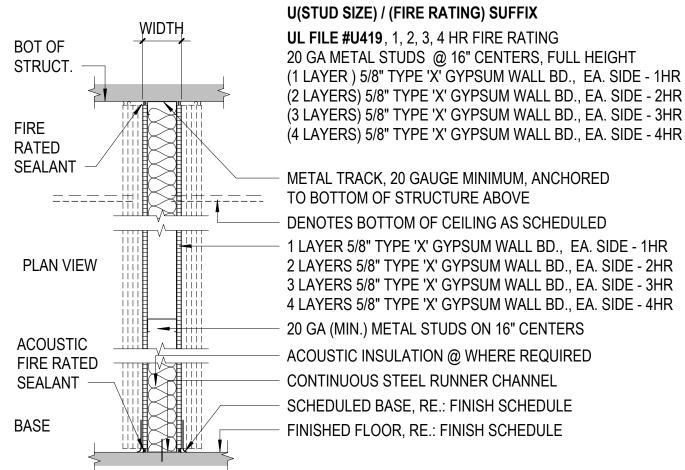

MARK	WIDTH	DESCRIPTION	SUFFIX
U1/		1 5/8" MTL STUDS - U1/1, U1/2, U1/3, U1/4	a - SOUND
U2/		2 1/2" MTL STUDS - U2/1, U2/2, U2/3, U2/4	g - GLASS-MATT I - LEAD LINED
U3/		3 5/8" MTL STUDS - U3/1, U3/2, U3/3, U3/4	w - WATER-RESISTANT
U6/		6" MTL STUDS - U4/1, U4/2, U4/3, U4/4	
U8/		8" MTL STUDS	

GENERAL MTL. STUD REQUIREMENTS:

REQUIREMENTS FOR GAUGES OF METAL STUDS EVEN WHEN STUD GAUGES ARE NOTED, THESE GAUGES SHALL BE CONSIDERED MINIMUM. THE CONTRACTOR SHALL PROVIDE AND INSTALL STUDS OF GAUGES AND CONFIGURATIONS AS RECOMMENDED BY THE STUD MANUFACTURER (EXCEPT WHERE REQUIREMENTS EXCEEDING THESE REQUIREMENTS ARE LISTED BELOW) TO MEET CONDITIONS INDICATED IN THESE DRAWINGS

DEPTHS OF STUDS SHALL NOT BE CHANGED FROM THAT INDICATED ON THE

BRACING SHALL BE INSTALLED USING MATERIALS AND AT LOCATIONS AS RECOMMENDED BY THE STUD MANUFACTURER TO COMPLY WITH THE INDICATED CONDITIONS, BUT IN NO CASE SHALL THIS BRACING:

BE LOCATED SO AS TO INTERFERE WITH ANY OTHER CONSTRUCTION. PROJECT BEYOND THE FINISH PLANES OF THE SPECIFIC CONSTRUCTION.

GAUGES OF EXTERIOR STUDS SHALL PROVIDE ASSEMBLIES WHICH DO NOT **EXCEED THE FOLLOWING DEFLECTION CRITERIA:**

BRICK OR CMU VENEER: L/600 2. EIFS: L/360

GAUGES OF INTERIOR STUDS SHALL PROVIDE ASSEMBLIES THAT DO NOT EXCEED THE DEFLECTION CRITERIA OF L/240.

GENERAL PARTITION NOTES:

- FOR EXTERIOR WALLS SEE BUILDING AND WALL SECTIONS FOR CONSTRUCTION REQUIREMENTS.
- PARTITIONS SCHEDULED TO RECEIVE STONE VENEER ARE TO HAVE 16 GA. MIN. STUDS.
- ROOF DECK DEFLECTION: ALL PARTITIONS TERMINATING AT ROOF DECKS SHALL NOT BE ATTACHED TO ROOF DECKING AND SHOULD ACCOMMODATE 1/2" MINIMUM MOVEMENTS OF ROOF SYSTEM. SEE PARTITION DETAIL SHEET FOR TYPE OF JOINTS.
- PROVIDE MINIMUM TWO STUDS AT ALL DOOR AND WINDOW JAMBS FULL HEIGHT OF WALL AT ALL INTERIOR STUD PARTITIONS. REFER TO TYP. DETAILS ON THIS SHEET.
- TYPICAL IN PARTITION CAVITIES AT ALL WALL MOUNTED MILLWORK, CASEWORK, EQUIPMENT, GRAB BARS, ACCESSORIES ETC. PROVIDE FIRE RETARDANT WOOD BLOCKING AS REQUIRED TO SUIT THE INSTALLATION OF THE ITEM ANCHORED TO METAL STUDS ON 24 INCH CENTERS MAXIMUM. PROVIDE BLOCKING FULL WIDTH PLUS 12 INCHES PAST EACH END OF

CASEWORK OR EQUIPMENT THAT IS TO BE WALL MOUNTED OR ANCHORED PROVIDE ONE STUD AT EACH END OF THE BLOCKING TO SECURE ITEM TO THE PARTITION. COORDINATE EXACT LOCATIONS OF WALL MOUNTED EQUIPMENT WITH

PARTITIONS SCHEDULED TO HAVE INSULATION ARE TO HAVE FULL ACOUSTICAL BATTS AND ARE TO BE SEALED WITH ACOUSTICAL SEALANT AT

OWNER OR EQUIPMENT PROVIDER.

TOP, BOTTOM, AND AT PENETRATIONS. SEE PARTITION SCHEDULE. 7. ALL INSULATION EXPOSED TO HVAC RETURN AIR PLENUMS SHALL COMPLY

WITH BUILDING CODE FLAME SPREAD REQUIREMENTS.

- ALL WALLS REQUIRED TO BE FIRE RATED SHALL HAVE THE APPROPRIATE FIRE RATED GYPSUM BOARD INSTALLED IN ACCORDANCE WITH THE UL RATING CONSTRUCTION OF FIRE RATED WALLS SHALL BE IN STRICT ACCORDANCE WITH UL OR OTHER TEST LAB REQUIREMENTS.
- FIRE RATED DETAILS AND OTHER WALL RELATED DETAILS SHOWN ON THESE DOCUMENTS FOR THROUGH WALL PENETRATIONS IN FIRE RATED ASSEMBLIES PROVIDE BASIC REQUIREMENTS FOR VARIOUS PENETRATIONS. OBTAIN COMPLETE DETAIL INFORMATION FROM THE PRODUCT MANUFACTURER AND/OR THE LATEST EDITION OF THE UL DIRECTORY
- PROVIDE 'MOISTURE RESISTANT' GYPSUM BOARD AT ALL LOCATIONS SUBJECT TO MOISTURE SUCH AS TOILETS, JANITOR CLOSETS, LOCKER ROOMS, ETC. SHOWER AREAS SHALL HAVE GLASS MATT WATER RESISTANT BACKING BOARD IN LIEU OF MOISTURE RESISTANT GYPSUM BOARD.
- 11. PARTITIONS SCHEDULED TO RECEIVE TILE OR STONE FINISHES ARE TO HAVE
- 12. INSTALL GYPSUM WALLBOARD 1/2" MINIMUM ABOVE FINISHED FLOOR.

CEMENTITIOUS BACKERBOARD IN LIEU OF GYPSUM WALL BOARD.

- 13. CONTROL JOINTS SHALL BE PROVIDED IN ALL GYPSUM WALL BOARD PARTITIONS AND SHALL NOT EXCEED 30' CENTERS.CEILING JOINTS SHALL ALSO NOT EXCEED 30' CENTERS AND NO MORE THAN 900 SQUARE FEET IN
- 14. SEAL AROUND PERIMETER OF ALL FIRE AND SOUND RATED WALLS AND PARTITIONS IN ACCORDANCE WITH ALL FIRE AND STC RATINGS AND AS REQUIRED BY ALL APPLICABLE BUILDING CODES.
- 15. REFER TO ROOM FINISH SCHEDULE FOR WALL FINISHES

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BID SET

FOR CONSCTUCTION SUED: SSUE DATE: FEBRUARY 05, 2024 EVISIONS No. Description

ROJECT STATUS:

RAWING TITLE

INTERIOR

DETAILS

PARTITIONS -

TYPES, NOTES &.

S2/al

PARTITION CLASSIFICATIONS & KEYS


NOTES - PARTITION CLASSIFICATION PARTITION TYPE CLASSIFICATION A ACOUSTICAL PARTITION C PLUMBING (CHASE) WALL SUFFIX F FURRED M MASONRY S STEEL FRAMED PARTITION KEY SH SHAFT (CHASE) W WOOD

WALL TYPES SUFFIX KEY


MINIMUM 20 GAUGE STEEL STUDS AT 16" OC

-	а	ADD SOUND ATTENUATION BLANKET OR AS OTHERWISE NOTED
	f	FIRE RATED
	g	SUBSTITUTE GLASS-MATT WATER RESISTANT BACKING BOARD (EACH SIDE) ON MINIMUM 20 GAUGE STEEL STUDS 16" OC
	I	LINED WITH LEAD (EACH SIDE)
	W	SUBSTITUTE WATER RESISTANT GYPSUM BACKING BOARD (EACH SIDE) ON

HECKED BY: ROJECT NUMBER 225029-00

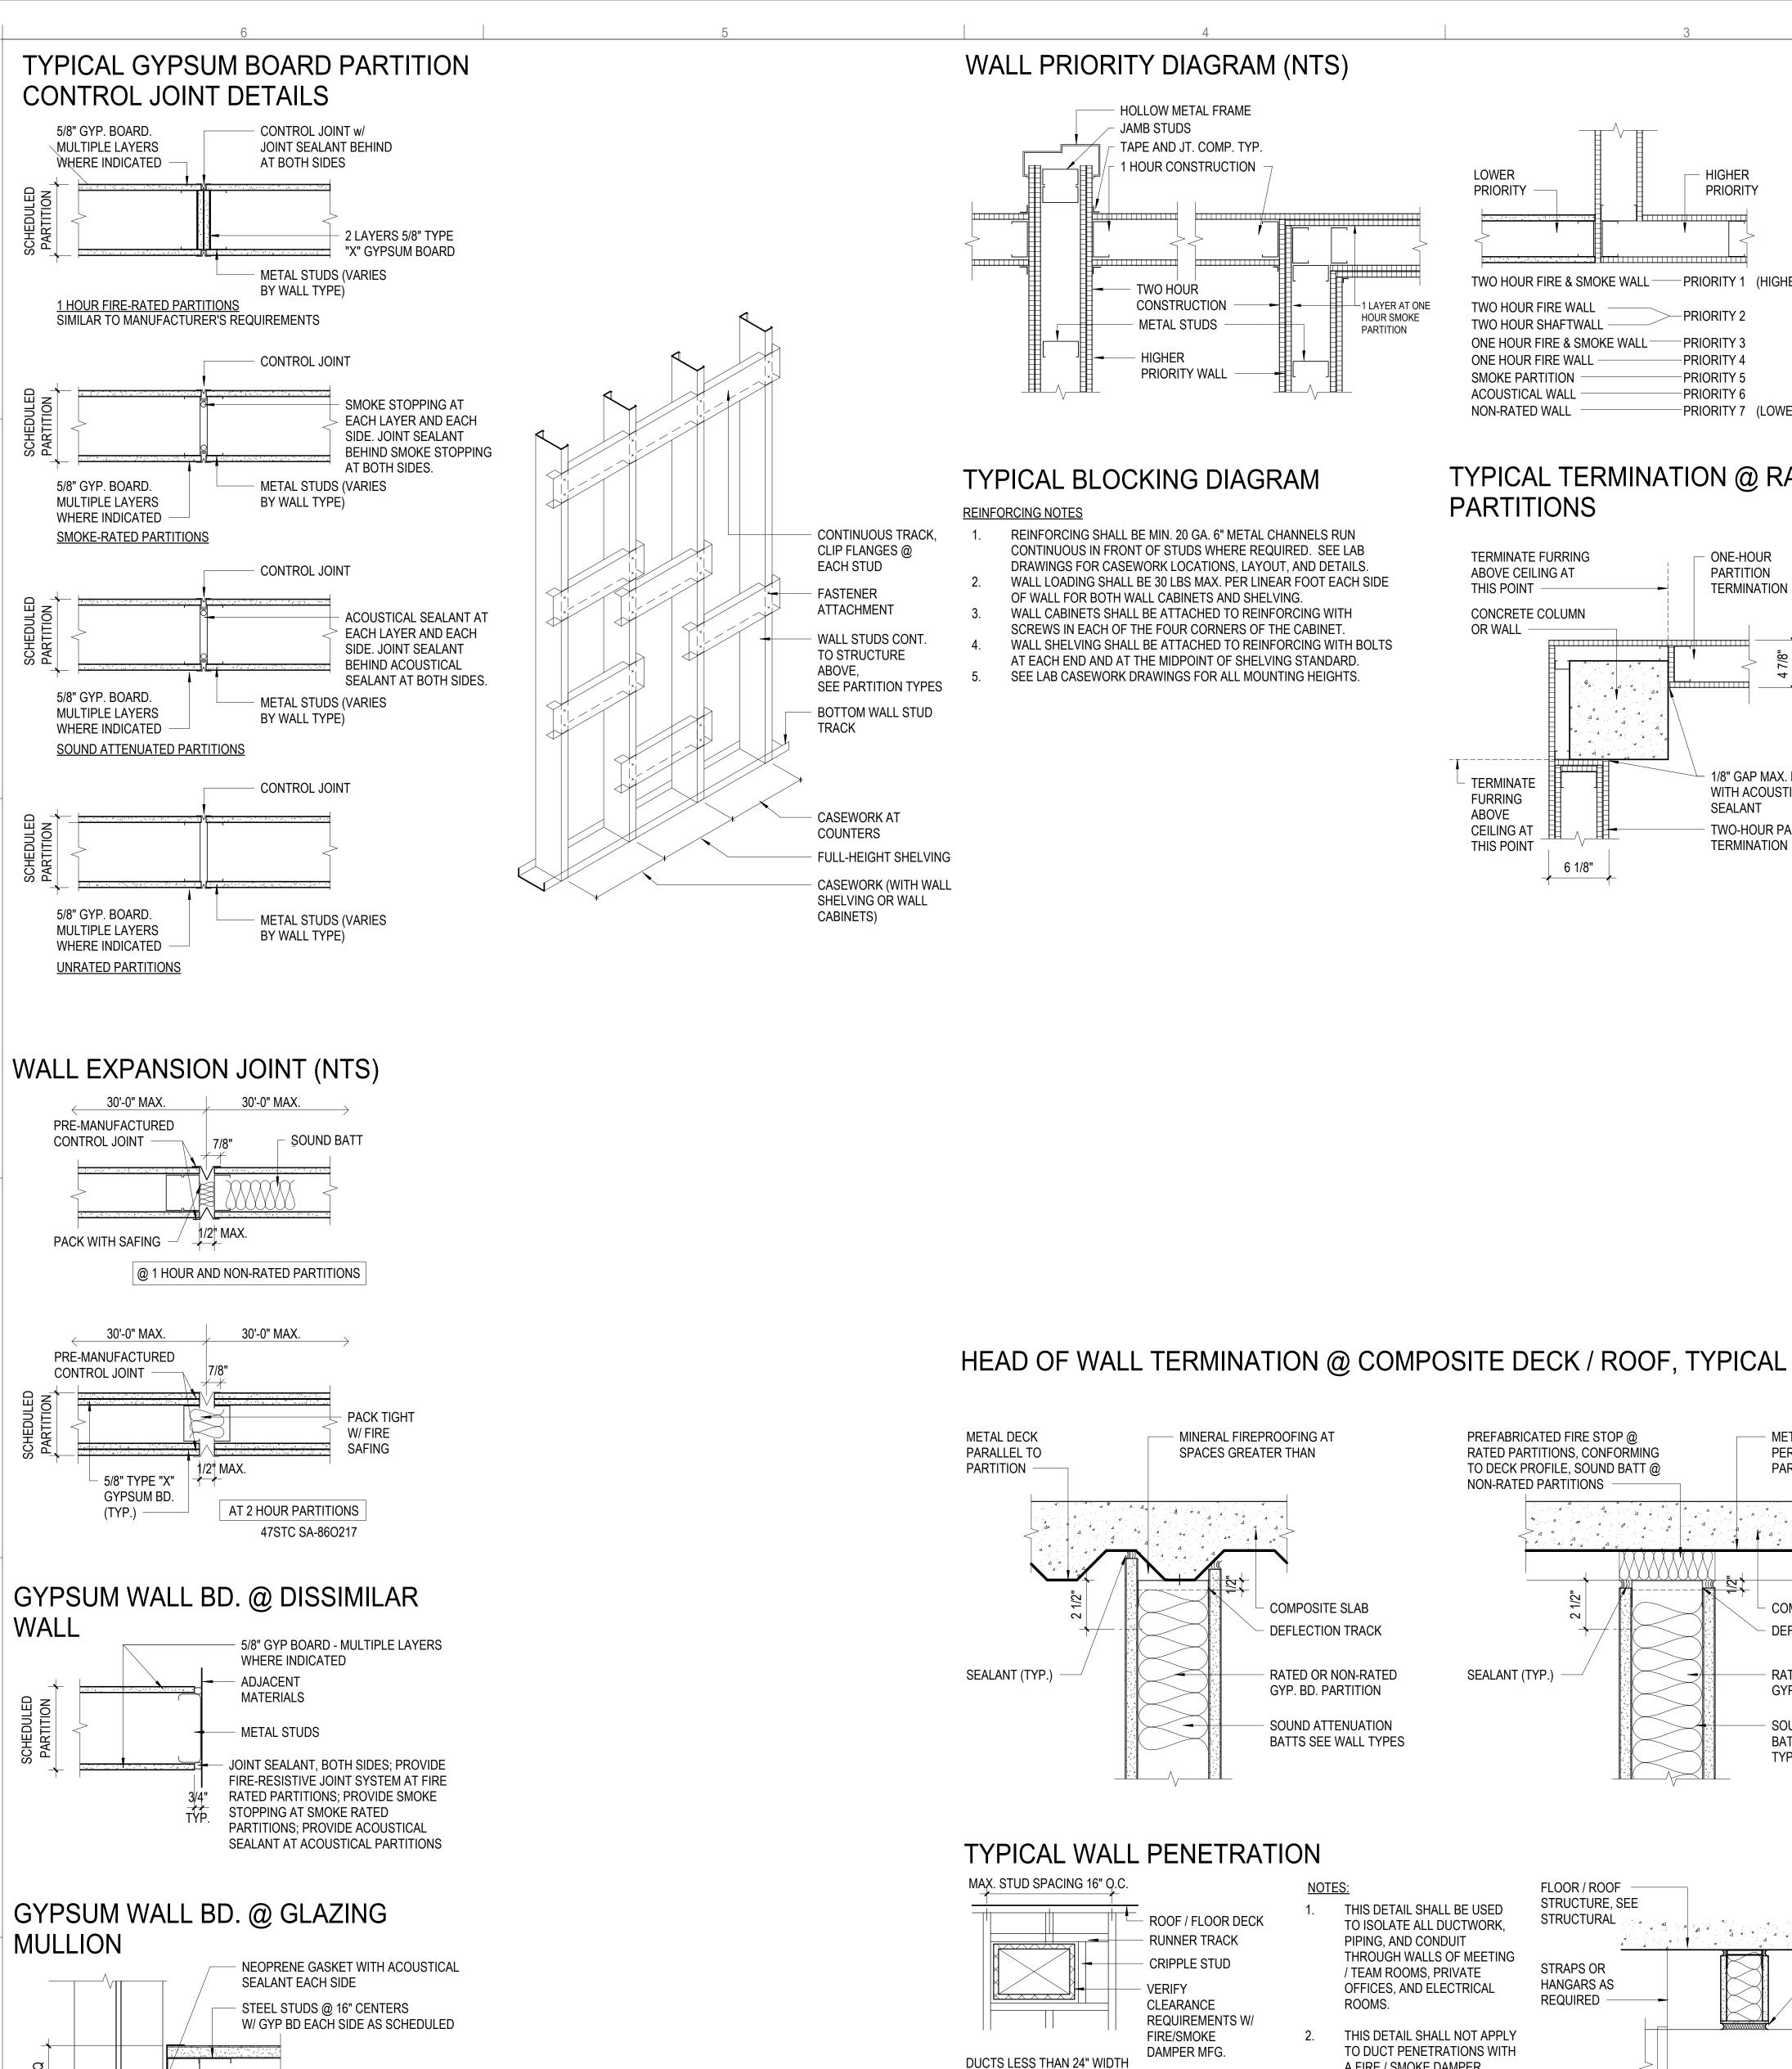

WALL PRIORITY DIAGRAM (NTS)

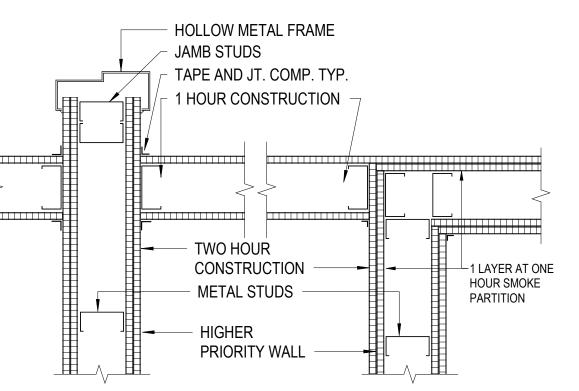

MINERAL FIREPROOFING AT

COMPOSITE SLAB

DEFLECTION TRACK

RATED OR NON-RATED

SOUND ATTENUATION

BATTS SEE WALL TYPES

ROOF / FLOOR DECK

VERIFY CLEARANCE

REQUIREMENTS W/

FIRE/SMOKE DAMPER

RUNNER TRACK

CRIPPLE STUD

THIS DETAIL SHALL BE USED

PIPING, AND CONDUIT

/ TEAM ROOMS, PRIVATE

A FIRE / SMOKE DAMPER.

OFFICES, AND ELECTRICAL

THIS DETAIL SHALL NOT APPLY

TO DUCT PENETRATIONS WITH

TO ISOLATE ALL DUCTWORK,

THROUGH WALLS OF MEETING

GYP. BD. PARTITION

SPACES GREATER THAN

ROOF / FLOOR DECK

REQUIREMENTS W/

RUNNER TRACK

CLEARANCE

FIRE/SMOKE

MAX. STUD SPACING 16" O.C.

DUCTS OVER 24" WIDTH

DAMPER MFG.

LOWER HIGHER PRIORITY -PRIORITY TWO HOUR FIRE & SMOKE WALL-PRIORITY 1 (HIGHEST) TWO HOUR FIRE WALL -PRIORITY 2 TWO HOUR SHAFTWALL ONE HOUR FIRE & SMOKE WALL-PRIORITY 3 ONE HOUR FIRE WALL -PRIORITY 4 PRIORITY 5 SMOKE PARTITION PRIORITY 6 **ACOUSTICAL WALL** PRIORITY 7 (LOWEST) NON-RATED WALL

TYPICAL TERMINATION @ RATED

ONE-HOUR

PARTITION

TERMINATION

1/8" GAP MAX. FILL

WITH ACOUSTICAL

TWO-HOUR PARTITION

METAL DECK

PARTITION

PERPENDICULAR TO

COMPOSITE SLAB

DEFLECTION TRACK

RATED OR NON-RATED

GYP. BD. PARTITION

SOUND ATTENUATION

BATTS SEE WALL

TYPES

SEALANT

TERMINATION

PARTITIONS

TERMINATE FURRING

ABOVE CEILING AT

CONCRETE COLUMN

THIS POINT -

OR WALL

TERMINATE

FURRING

CEILING AT

THIS POINT

6 1/8"

PREFABRICATED FIRE STOP @

NON-RATED PARTITIONS

SEALANT (TYP.)

RATED PARTITIONS, CONFORMING

FLOOR / ROOF

HANGARS AS

METAL SLEEVES 1/2" TO

OUTSIDE DIAMETER OF

SHALL BE CAULKED AT

WALL SURFACE TO

ENSURE AIRTIGHT

SEAL.

CONDUIT. SLEEVES _____

3/4" LARGER THAN


DUCT, PIPE, OR

REQUIRED

STRUCTURE, SEE

ABOVE

RATED PARTITION AT EXTERIOR WALL

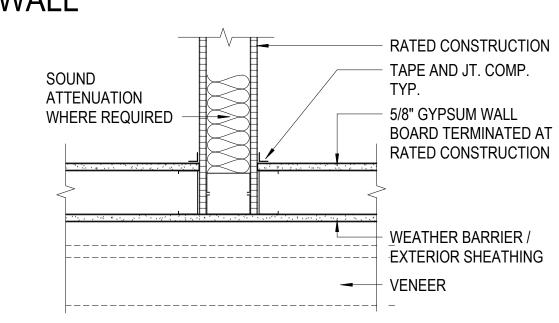

SHEET NOTES:

- 1. NOT ALL DETAILS ON THIS SHEET ILLUSTRATE CONDITIONS IN THE PROJEC
- DO NOT SCALE DRAWINGS. DIMENSIONS ARE NOT ADJUSTABLE WITHOUT ARCHITECT'S APPROVAL, UNLESS NOTED OTHERWISE. REFER TO ARCHITECTURAL DRAFTING CONVENTIONS NOTES ON SHEET A0.01 FOR
 - ADDITIONAL CLARIFICATIONS. IF ANY ITEM OF WORK CANNOT BE LOCATED, DO NOT PROCEED WITH THE WORK BEFORE CLARIFYING WITH ARCHITECT.
 - REFER TO SHEET A0.04 FOR TYPICAL STUD, SHEATHING AND GENERAL PARTITION REQUIREMENTS AND WALL TYPES.


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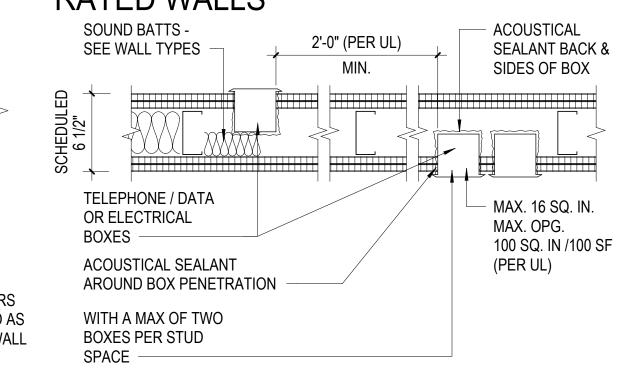
The Architect shall not have control or charge of, and shall not be responsible for construction Means and Methods, deviations, techniques, sequences, or procedures, or for safety programs and precautions in connection with the Work, for the acts or omissions of the Contractor, Subcontractors or any other persons performing any of the Work in accordance with the Contract




TYPICAL GYP. BOARD @ RECESSED WALL CABINETS / PANELS



ADJACENT ELECTRICAL BOXES IN

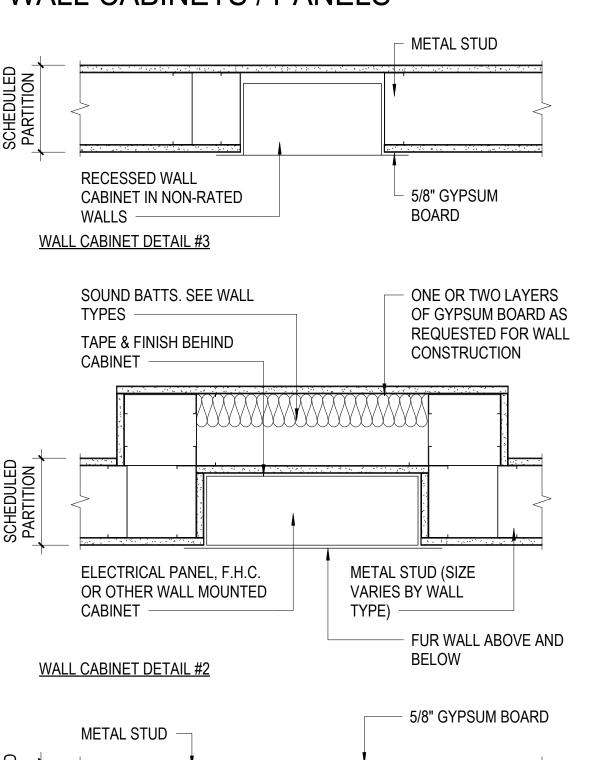

RATED WALLS

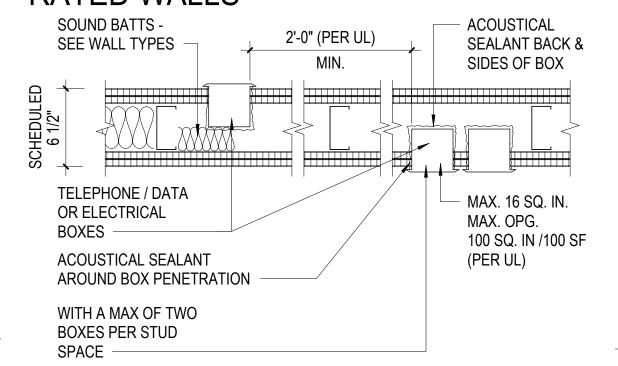

HEAD OF PARTITION @ HORIZONTAL MEMBRANE

NOTE: USE THIS DETAIL WHERE

FACE OF BOX 16 SQ. IN.

WALL CABINET DETAIL #1

LAMINATE BACK PIECE

TO WALL BOARD

FULLY SEAL WITH

STOP AS REQUIRED

COMPRESSIBLE

FILLER OR FIRE

BY RATING

PARTITION


FURRING


PARTITION

TYPE 'M' OR 'MF'

- FULLY SEAL ALL

PENETRATIONS

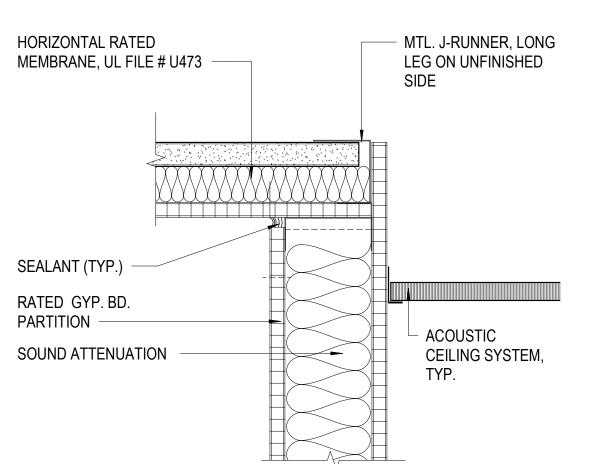

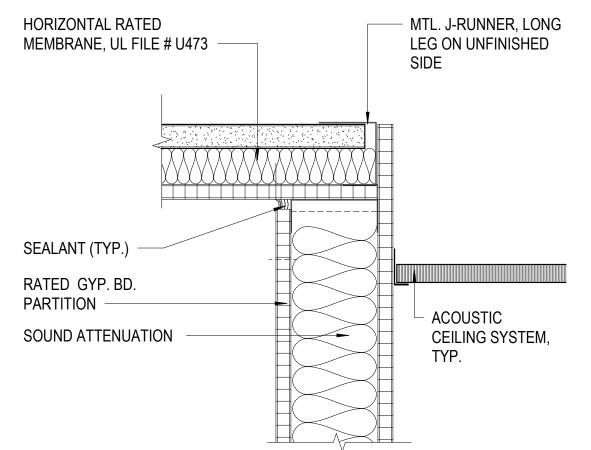

STRUCTURE ABOVE

BRACES, SEE

STRUCTURAL

GROUT SOLID

AS REQUIRED

PIPE /

CONDUIT

CAULK OPENINGS FROM

DUCT OR PIPING WITH

ACOUSTICAL SEALANT

ON BOTH SIDES OF THE

WALL. USE FIRE-RATED

WALL SURFACE TO

NON-HARDENING

SEALANT WHERE

FILL ANNULAR SPACE

COMPLETELY WITH

MINERAL FIBER OR

REQUIRED FOR FIRE

SLEEVE MIN. 1/2" OR AS

REQUIRED FOR SEALANT

FIBROUS MATERIAL INTO SCHEDULE


RATING. RECESS


THICKNESS.

FIBERGLASS AS

REQUIRED.

PARTITION BRACING @ DOOR HEAD,

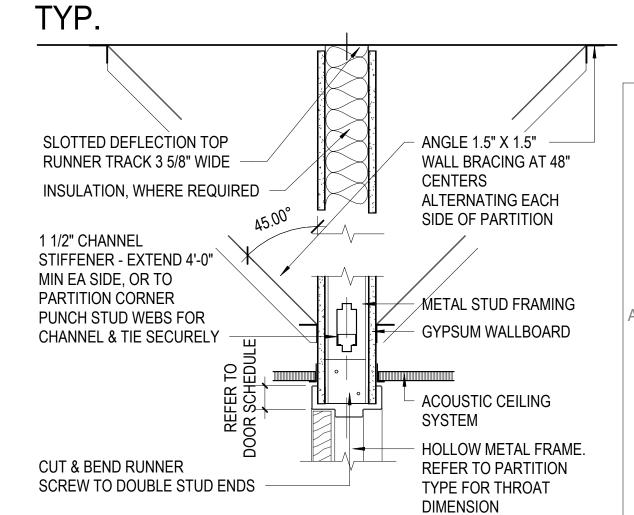

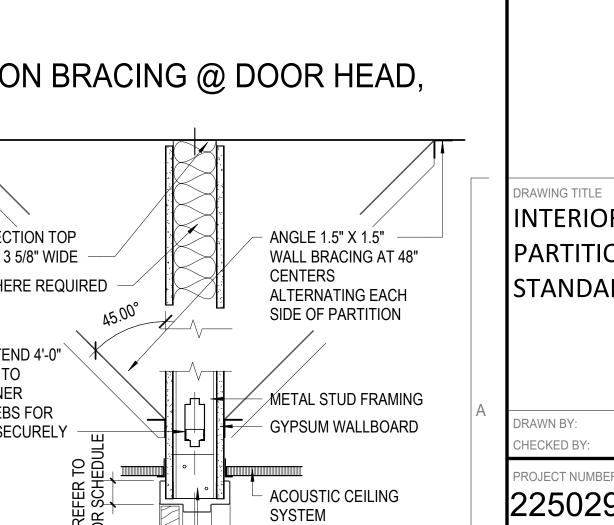

INTERIOR PARTITIONS -STANDARD DETAILS ROJECT NUMBER 225029-00

SUE DATE:

VISIONS

No. Description


FEBRUARY 05, 2024

BREAK METAL FLASHING, PAINT TO


MATCH WALL. BOTH SIDES.


WINDOW SILL BELOW


ALUMINUM WINDOW MULLION

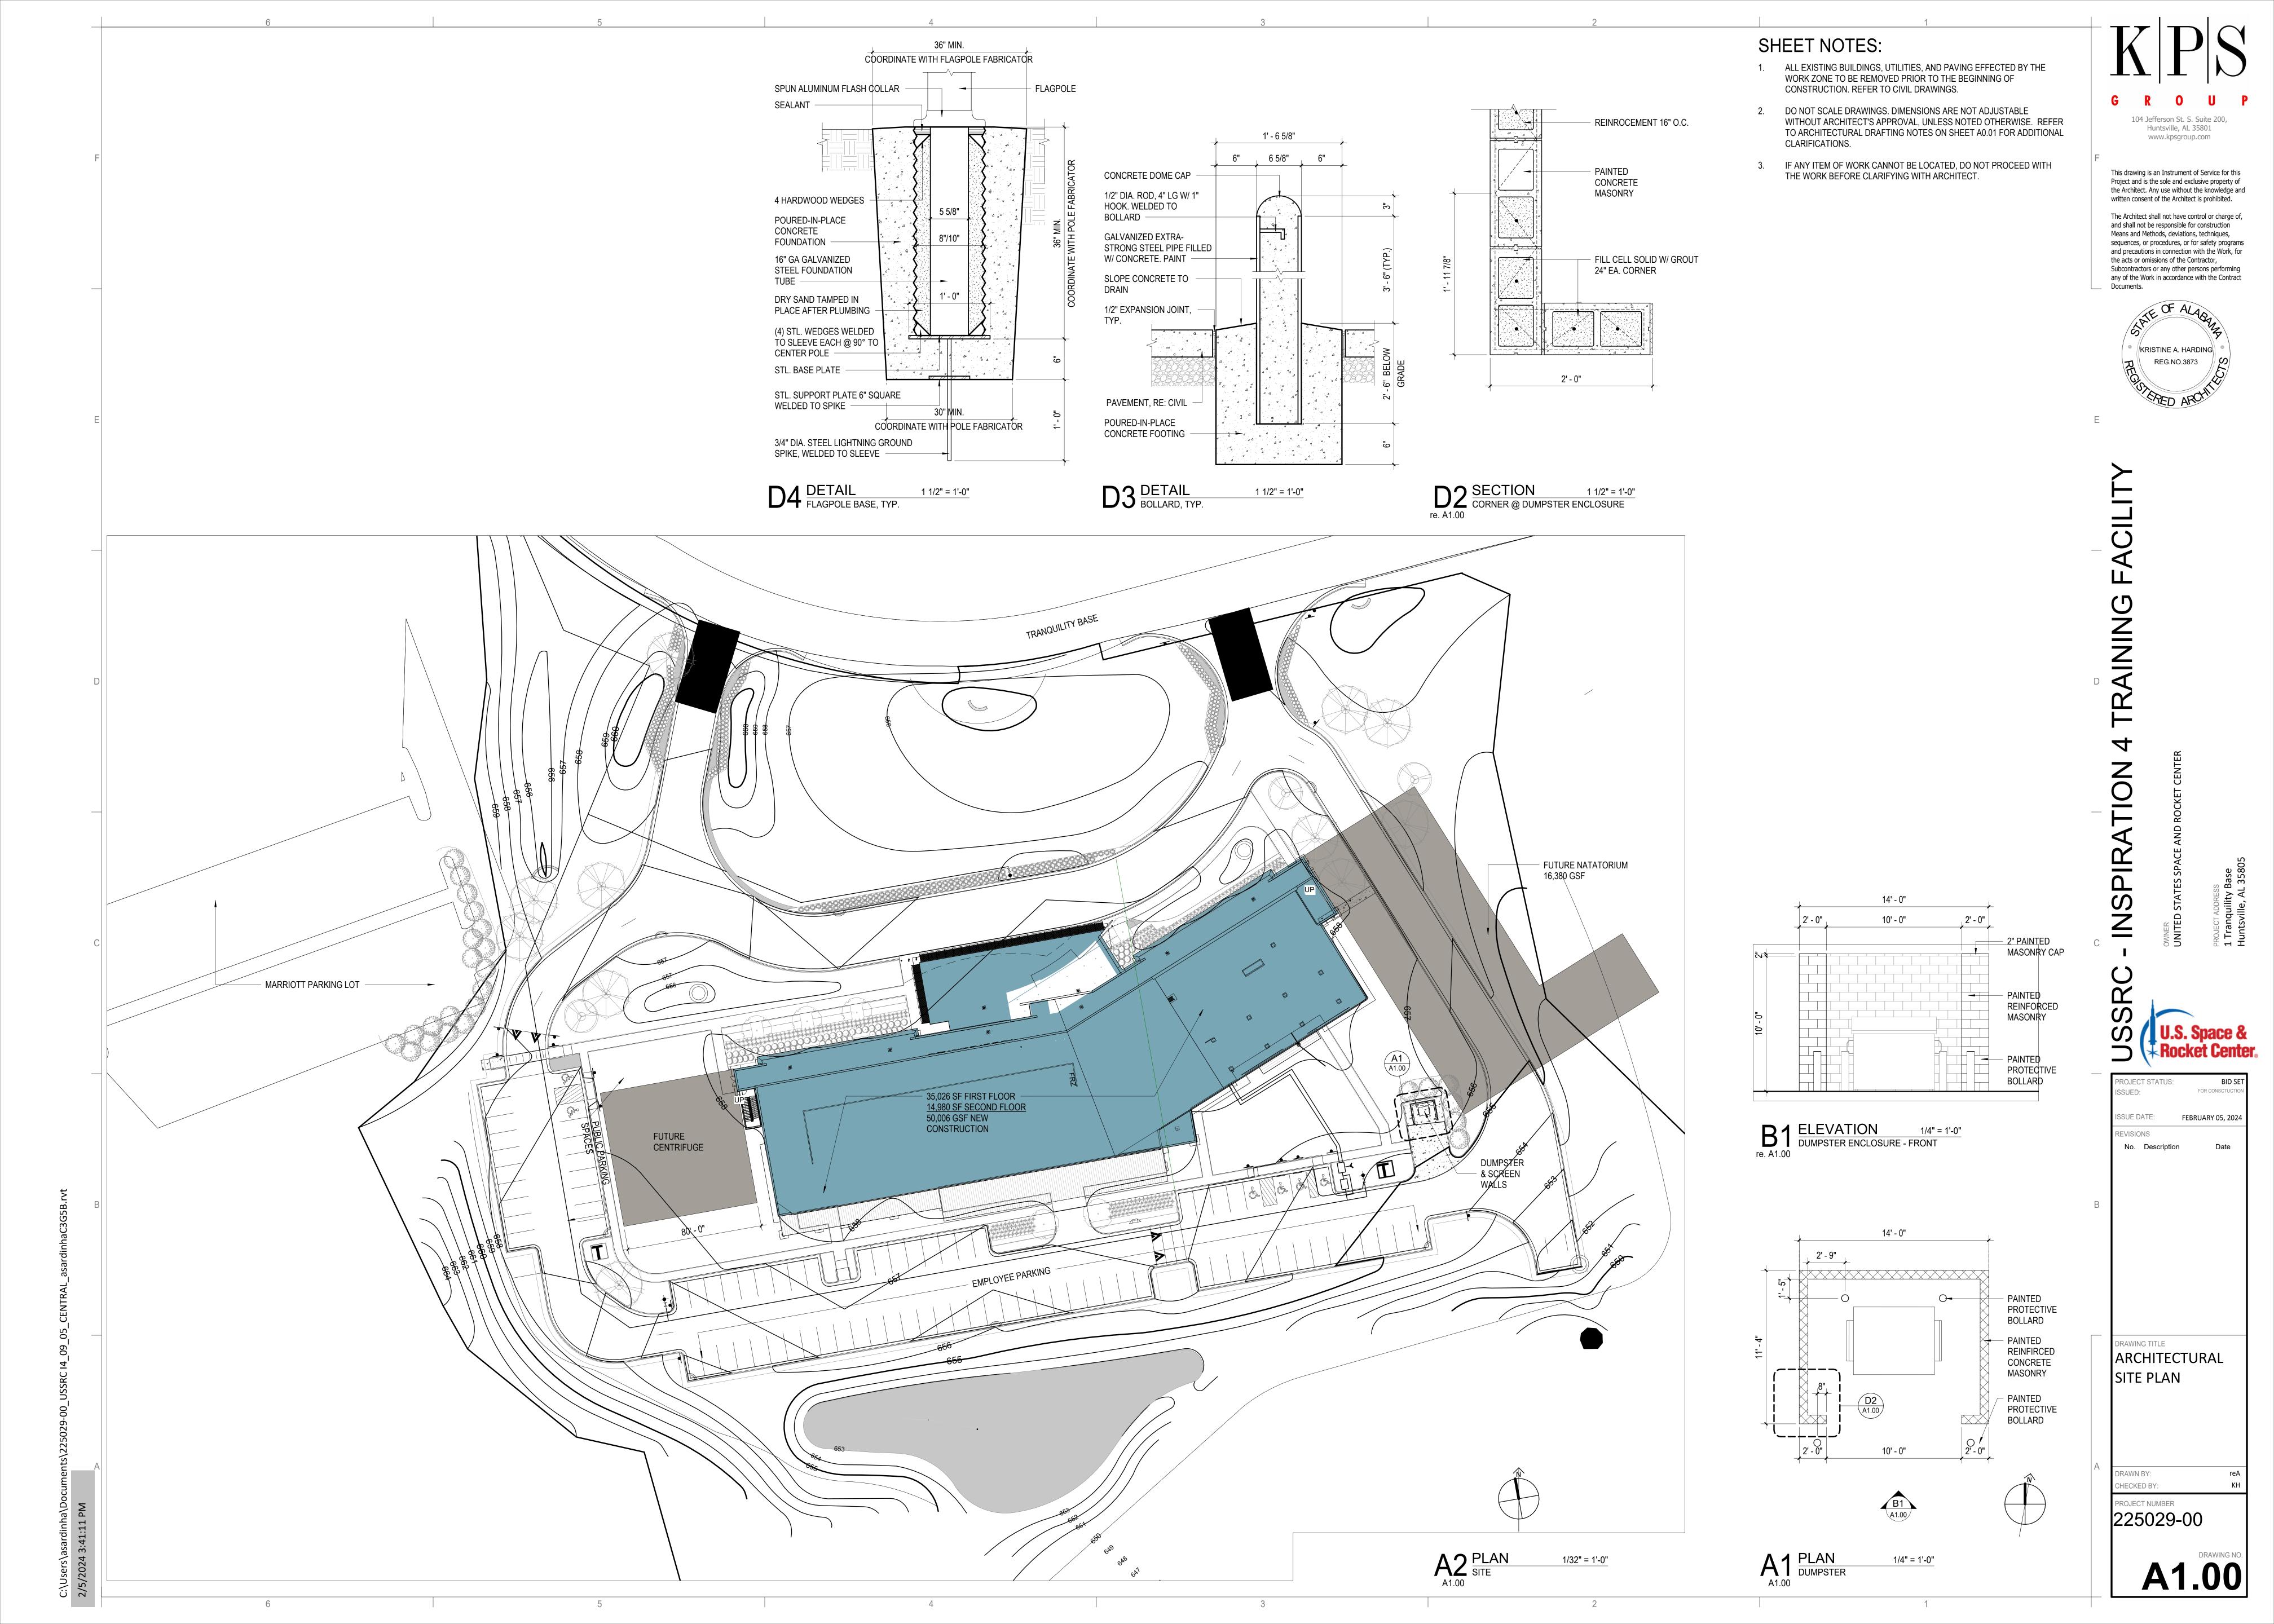



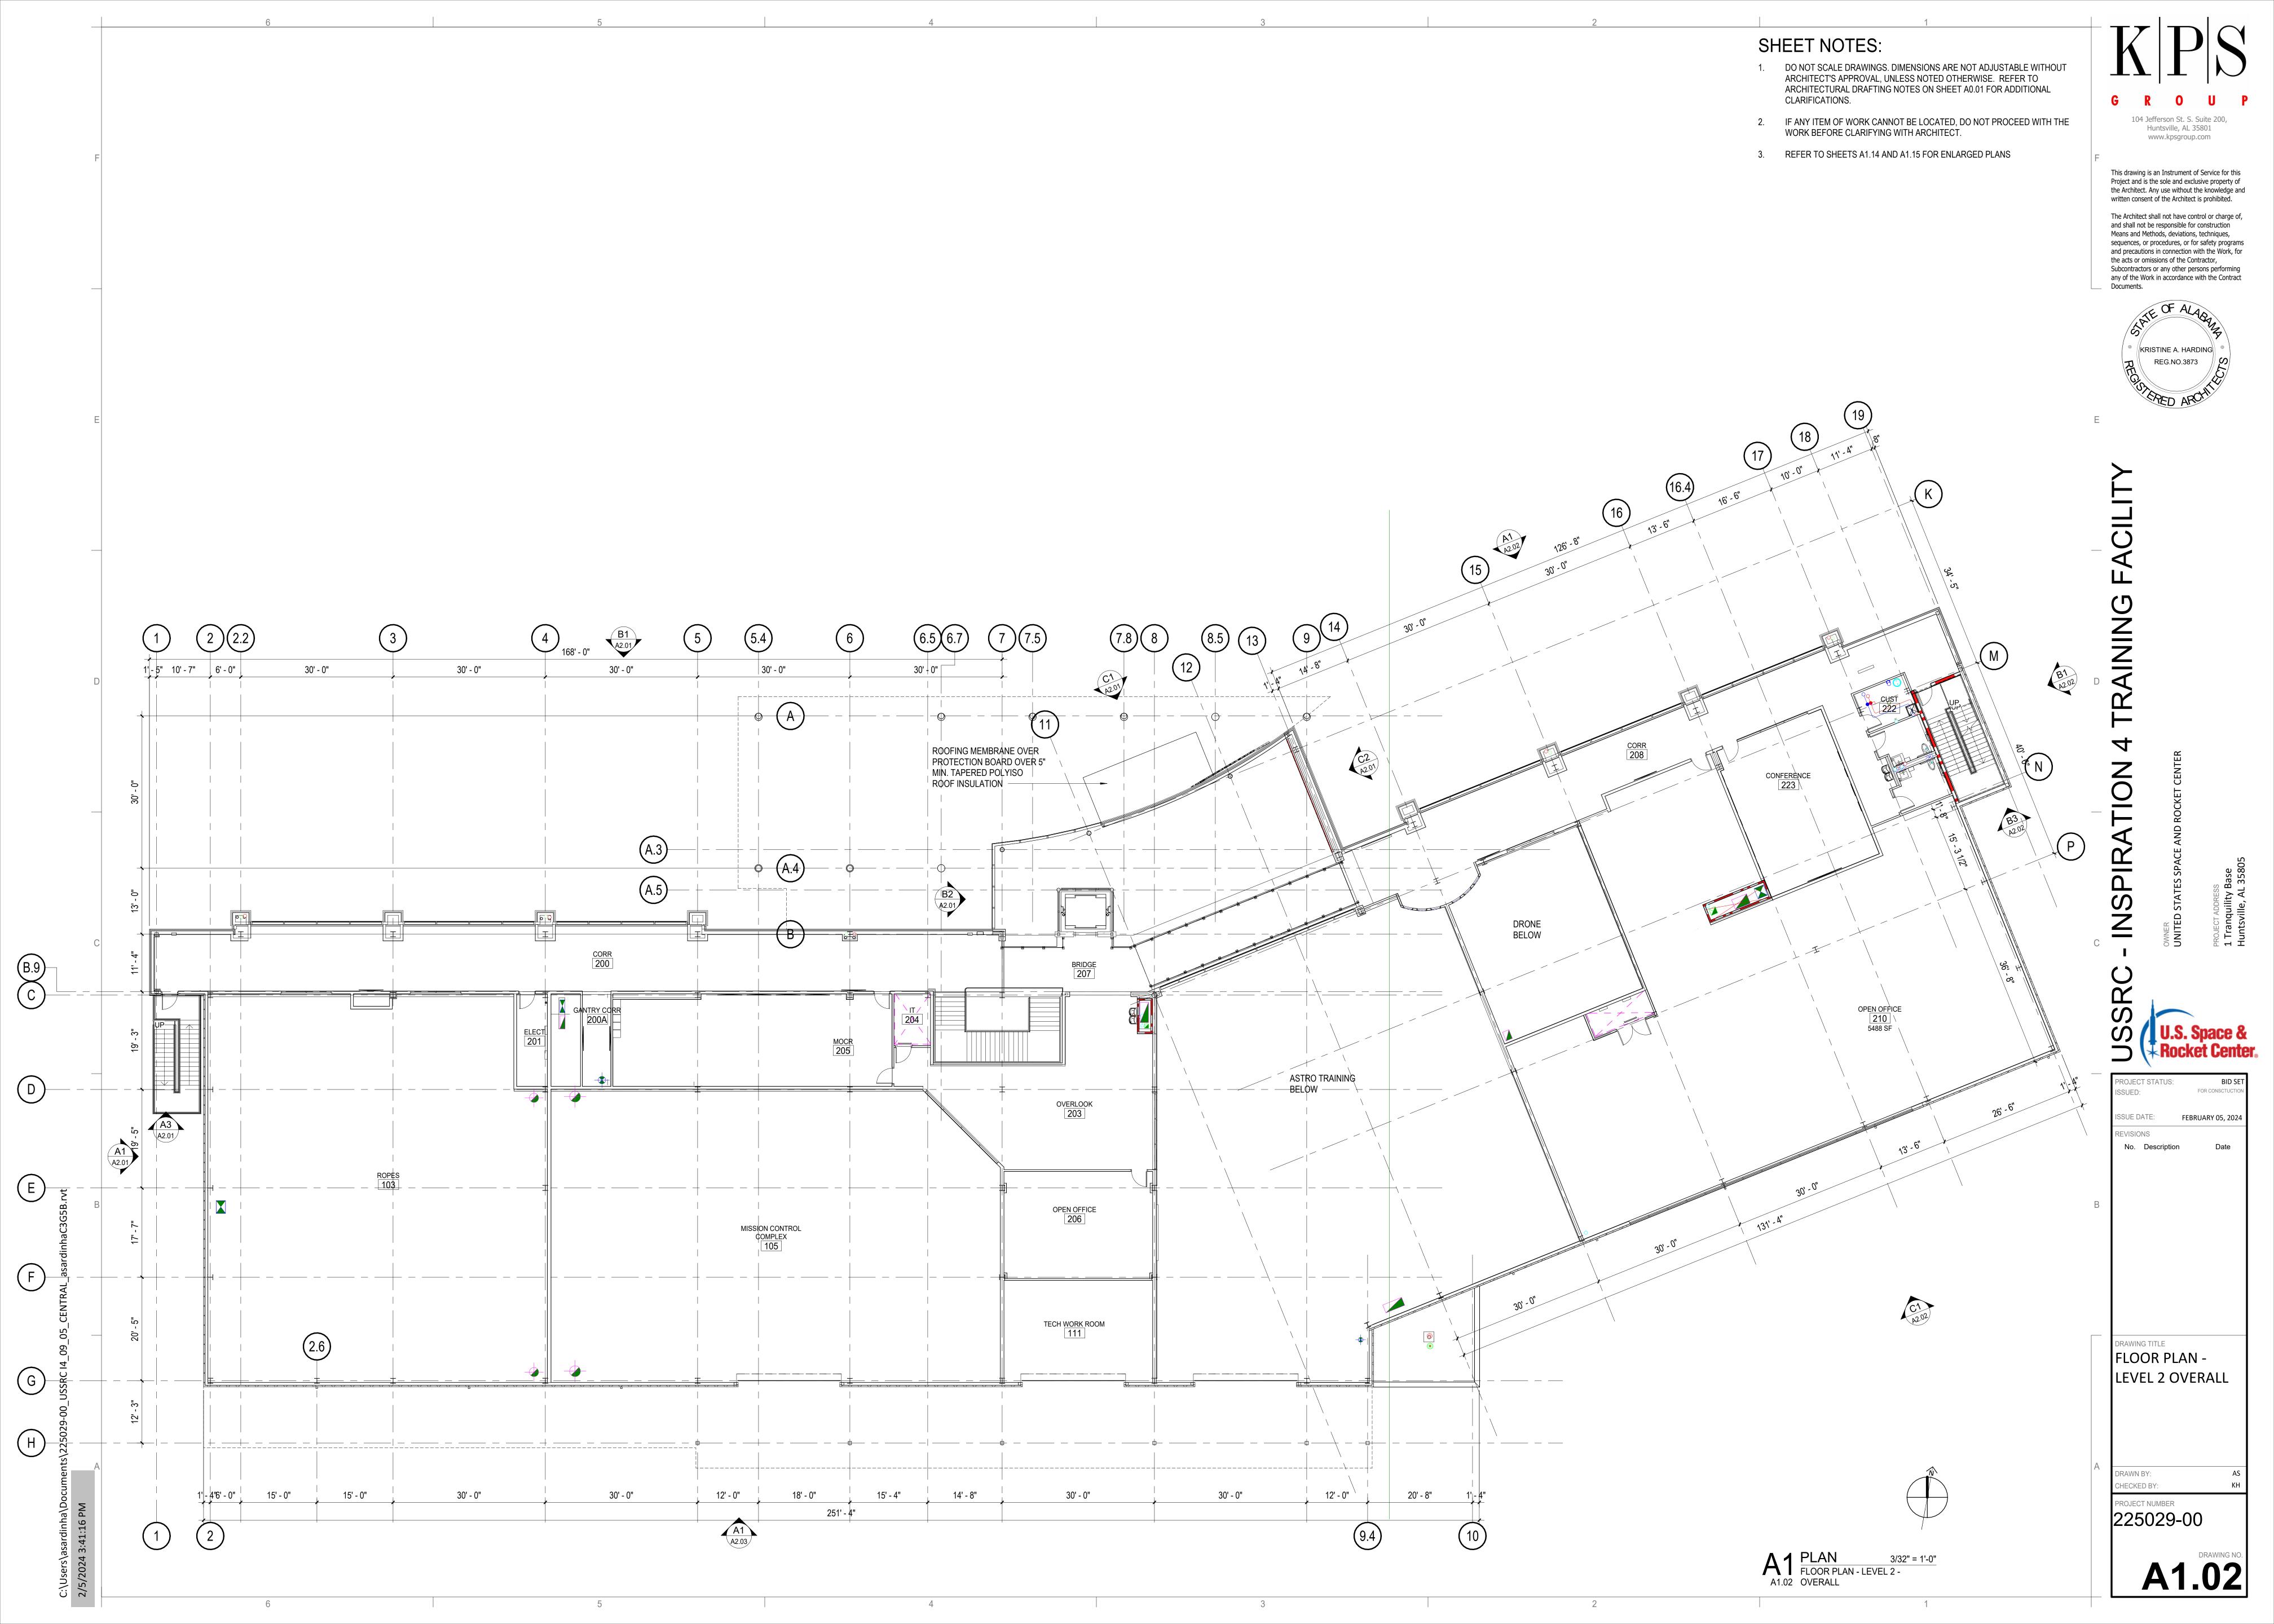


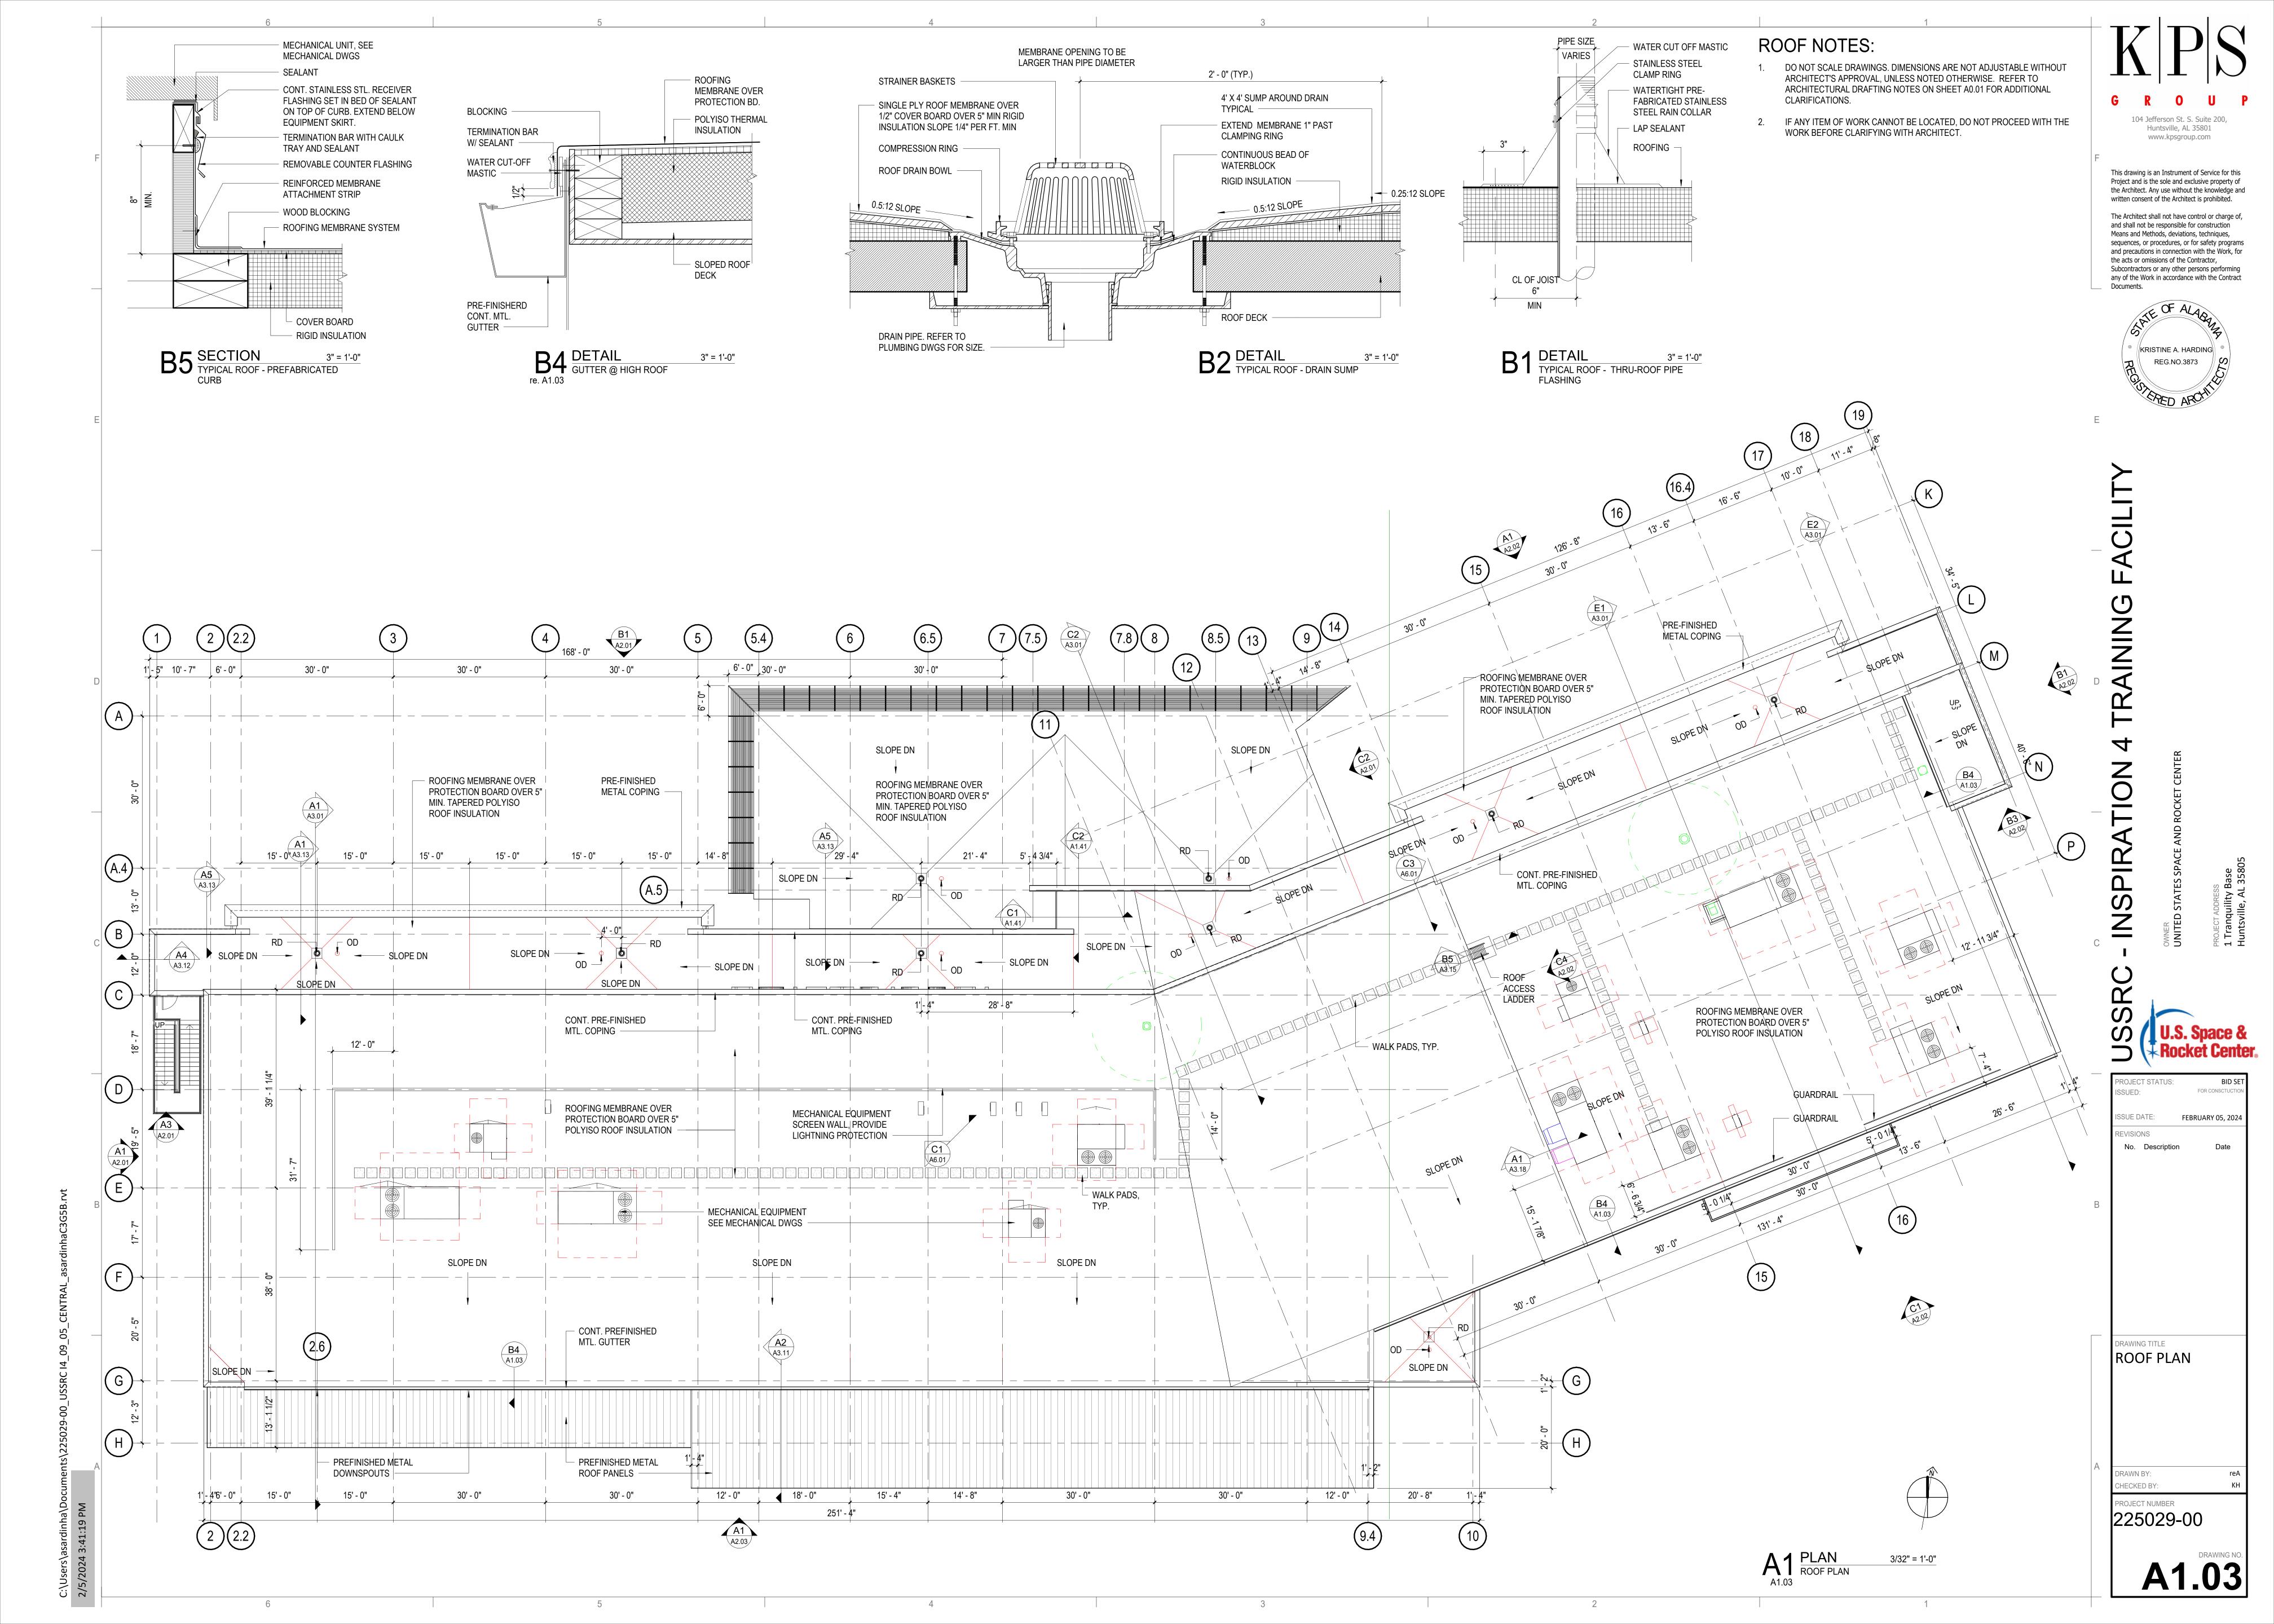

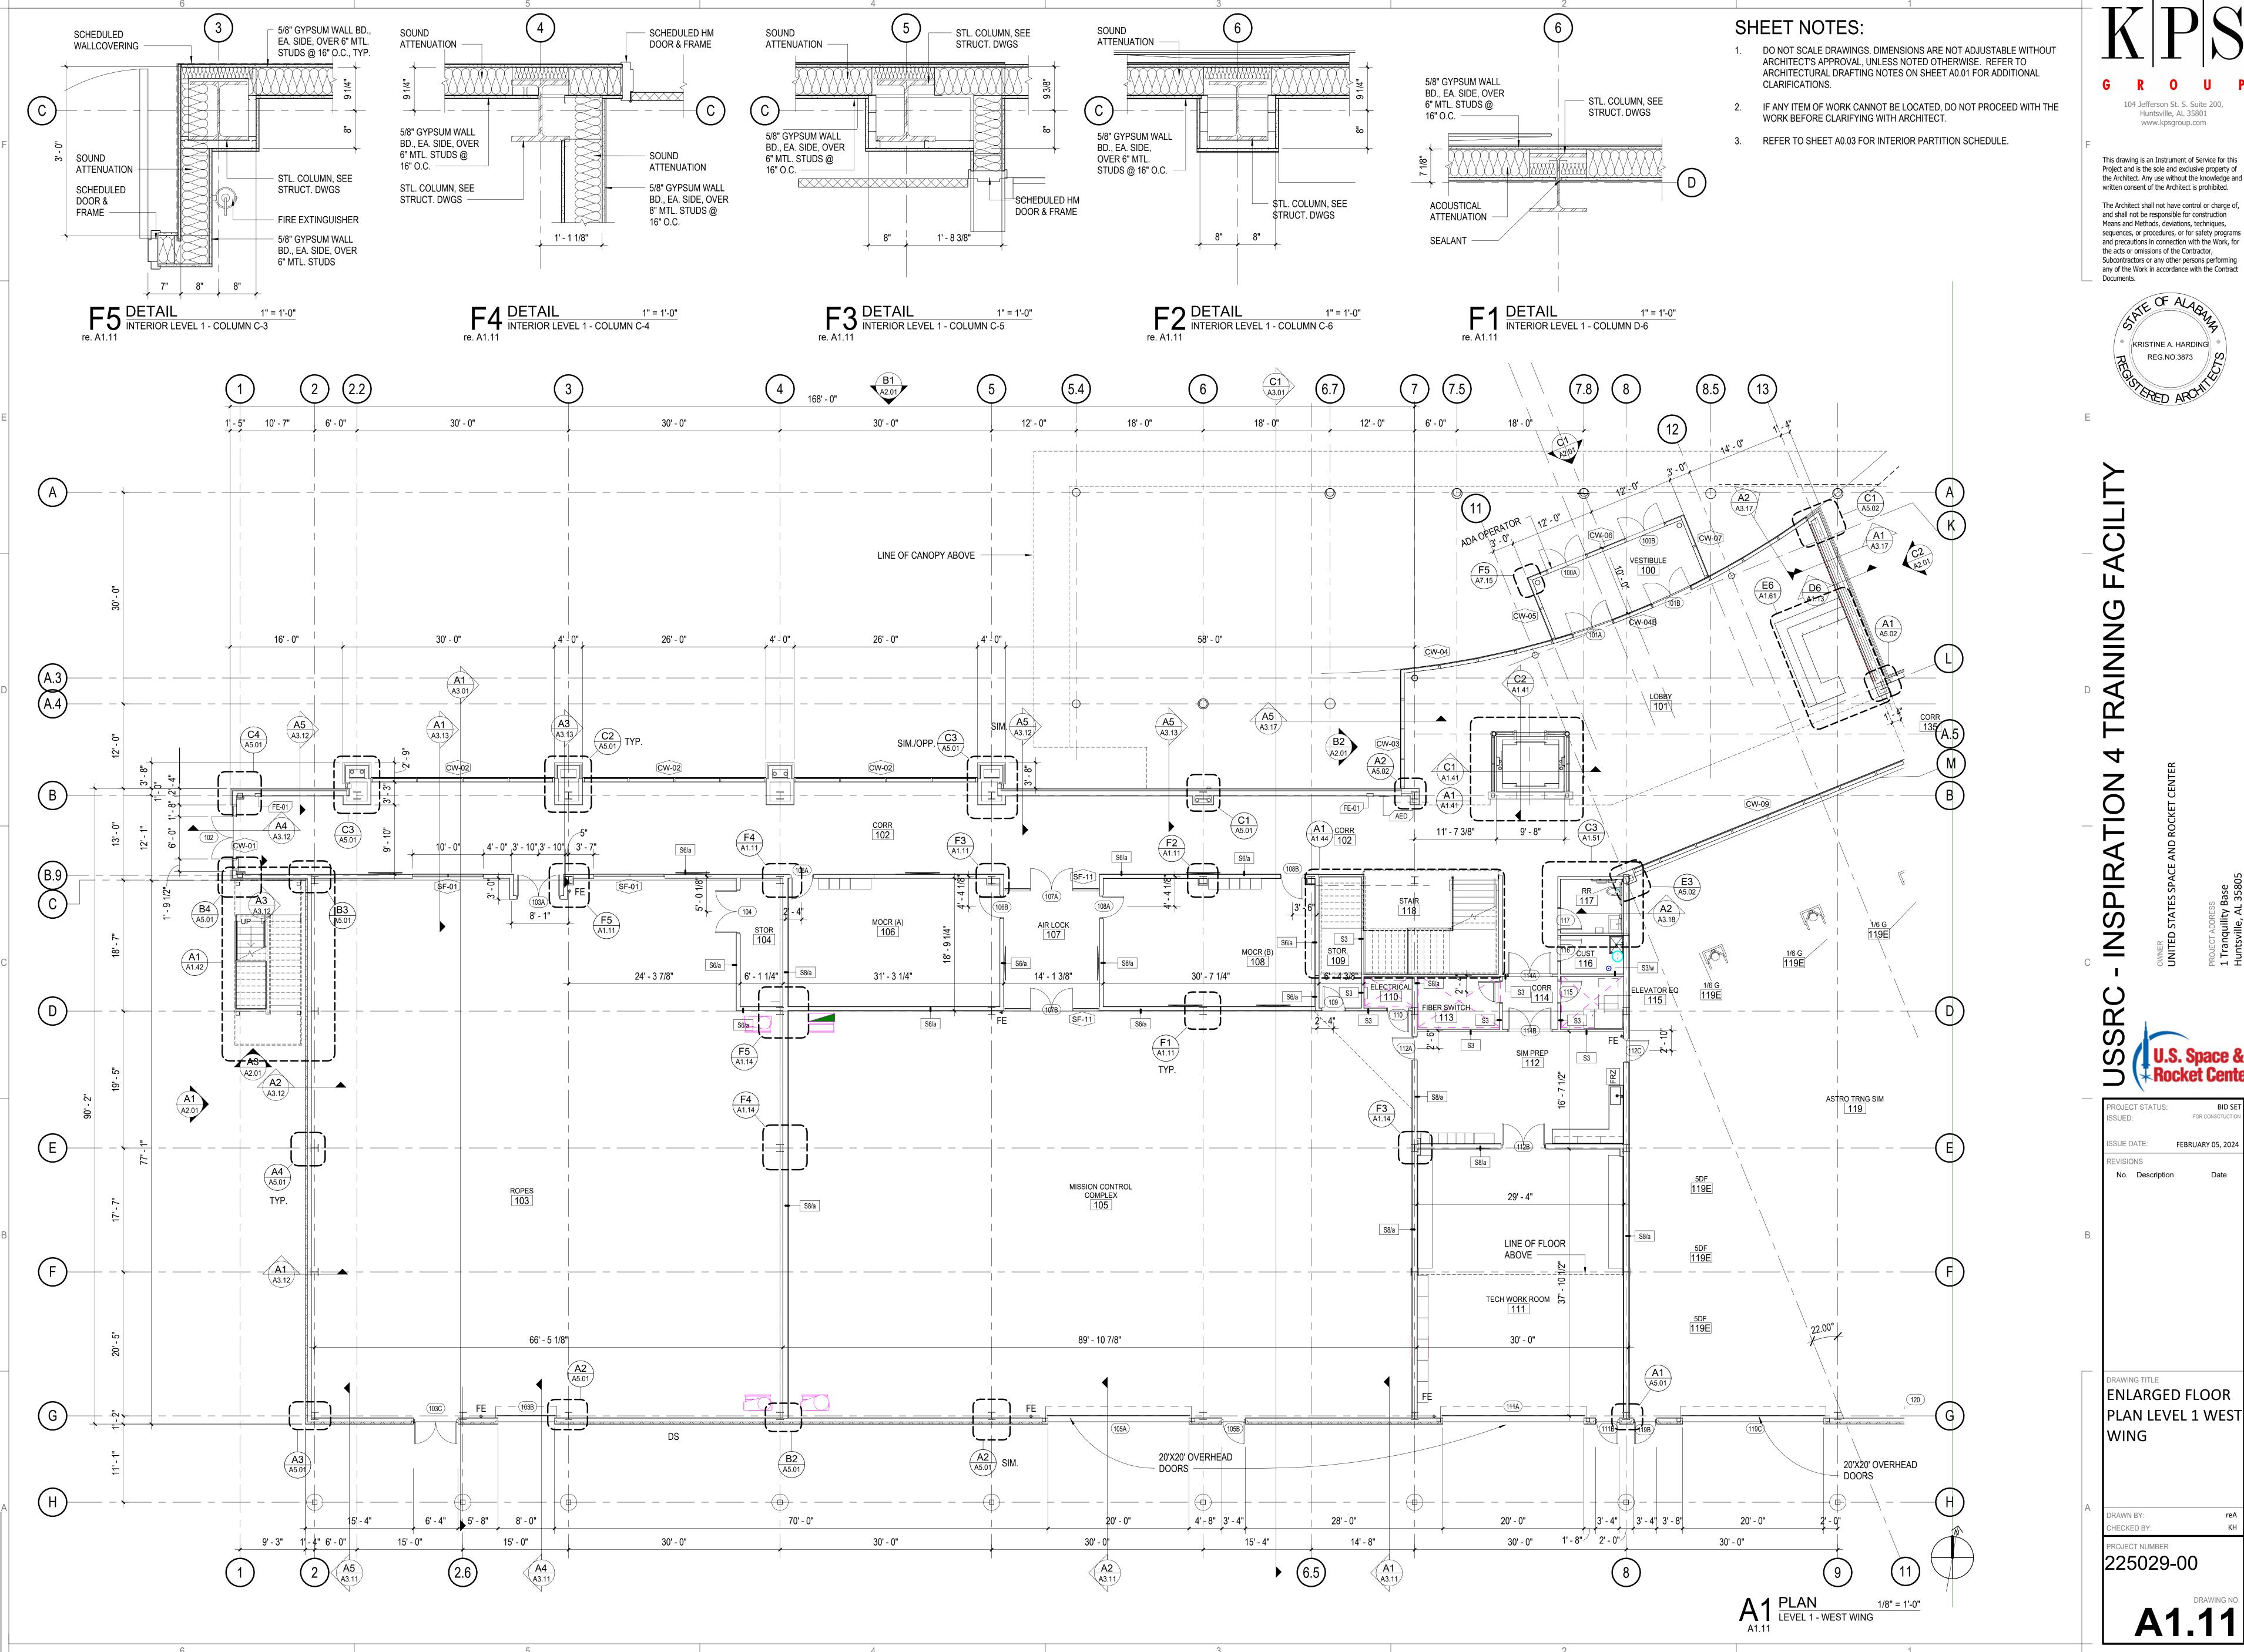

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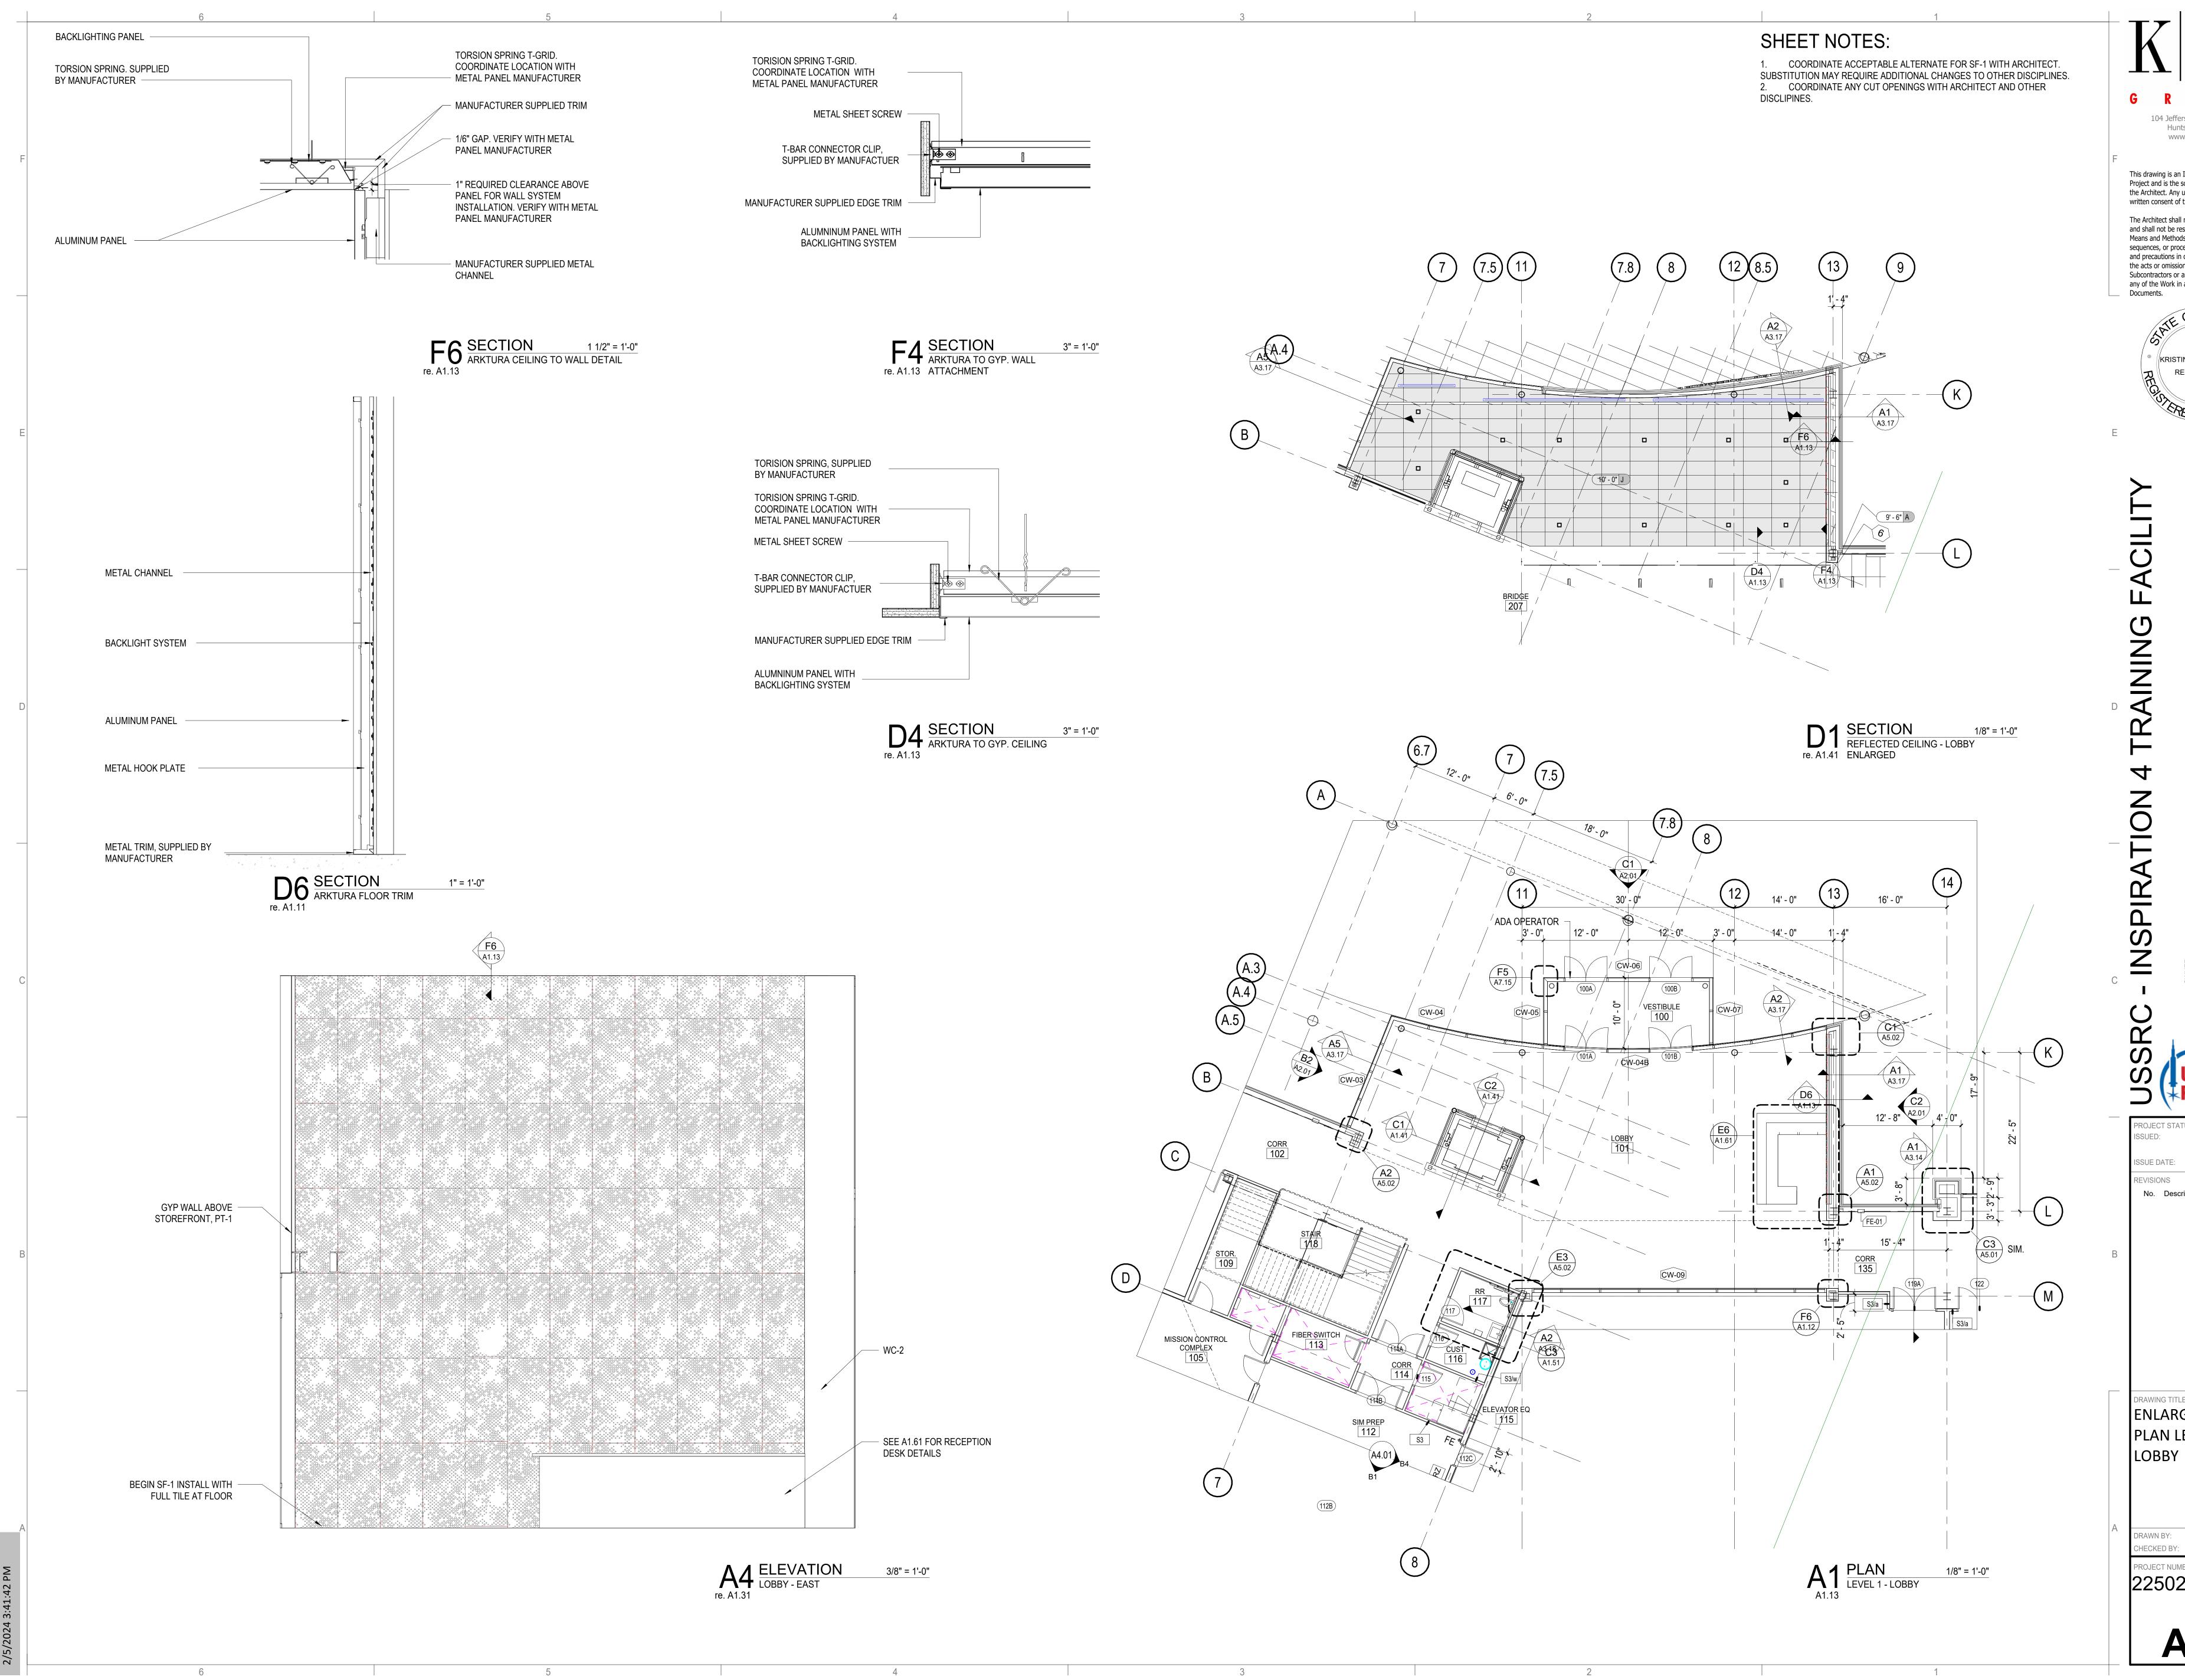
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FEBRUARY 05, 2024 No. Description

ENLARGED FLOOR PLAN LEVEL 1 EAST

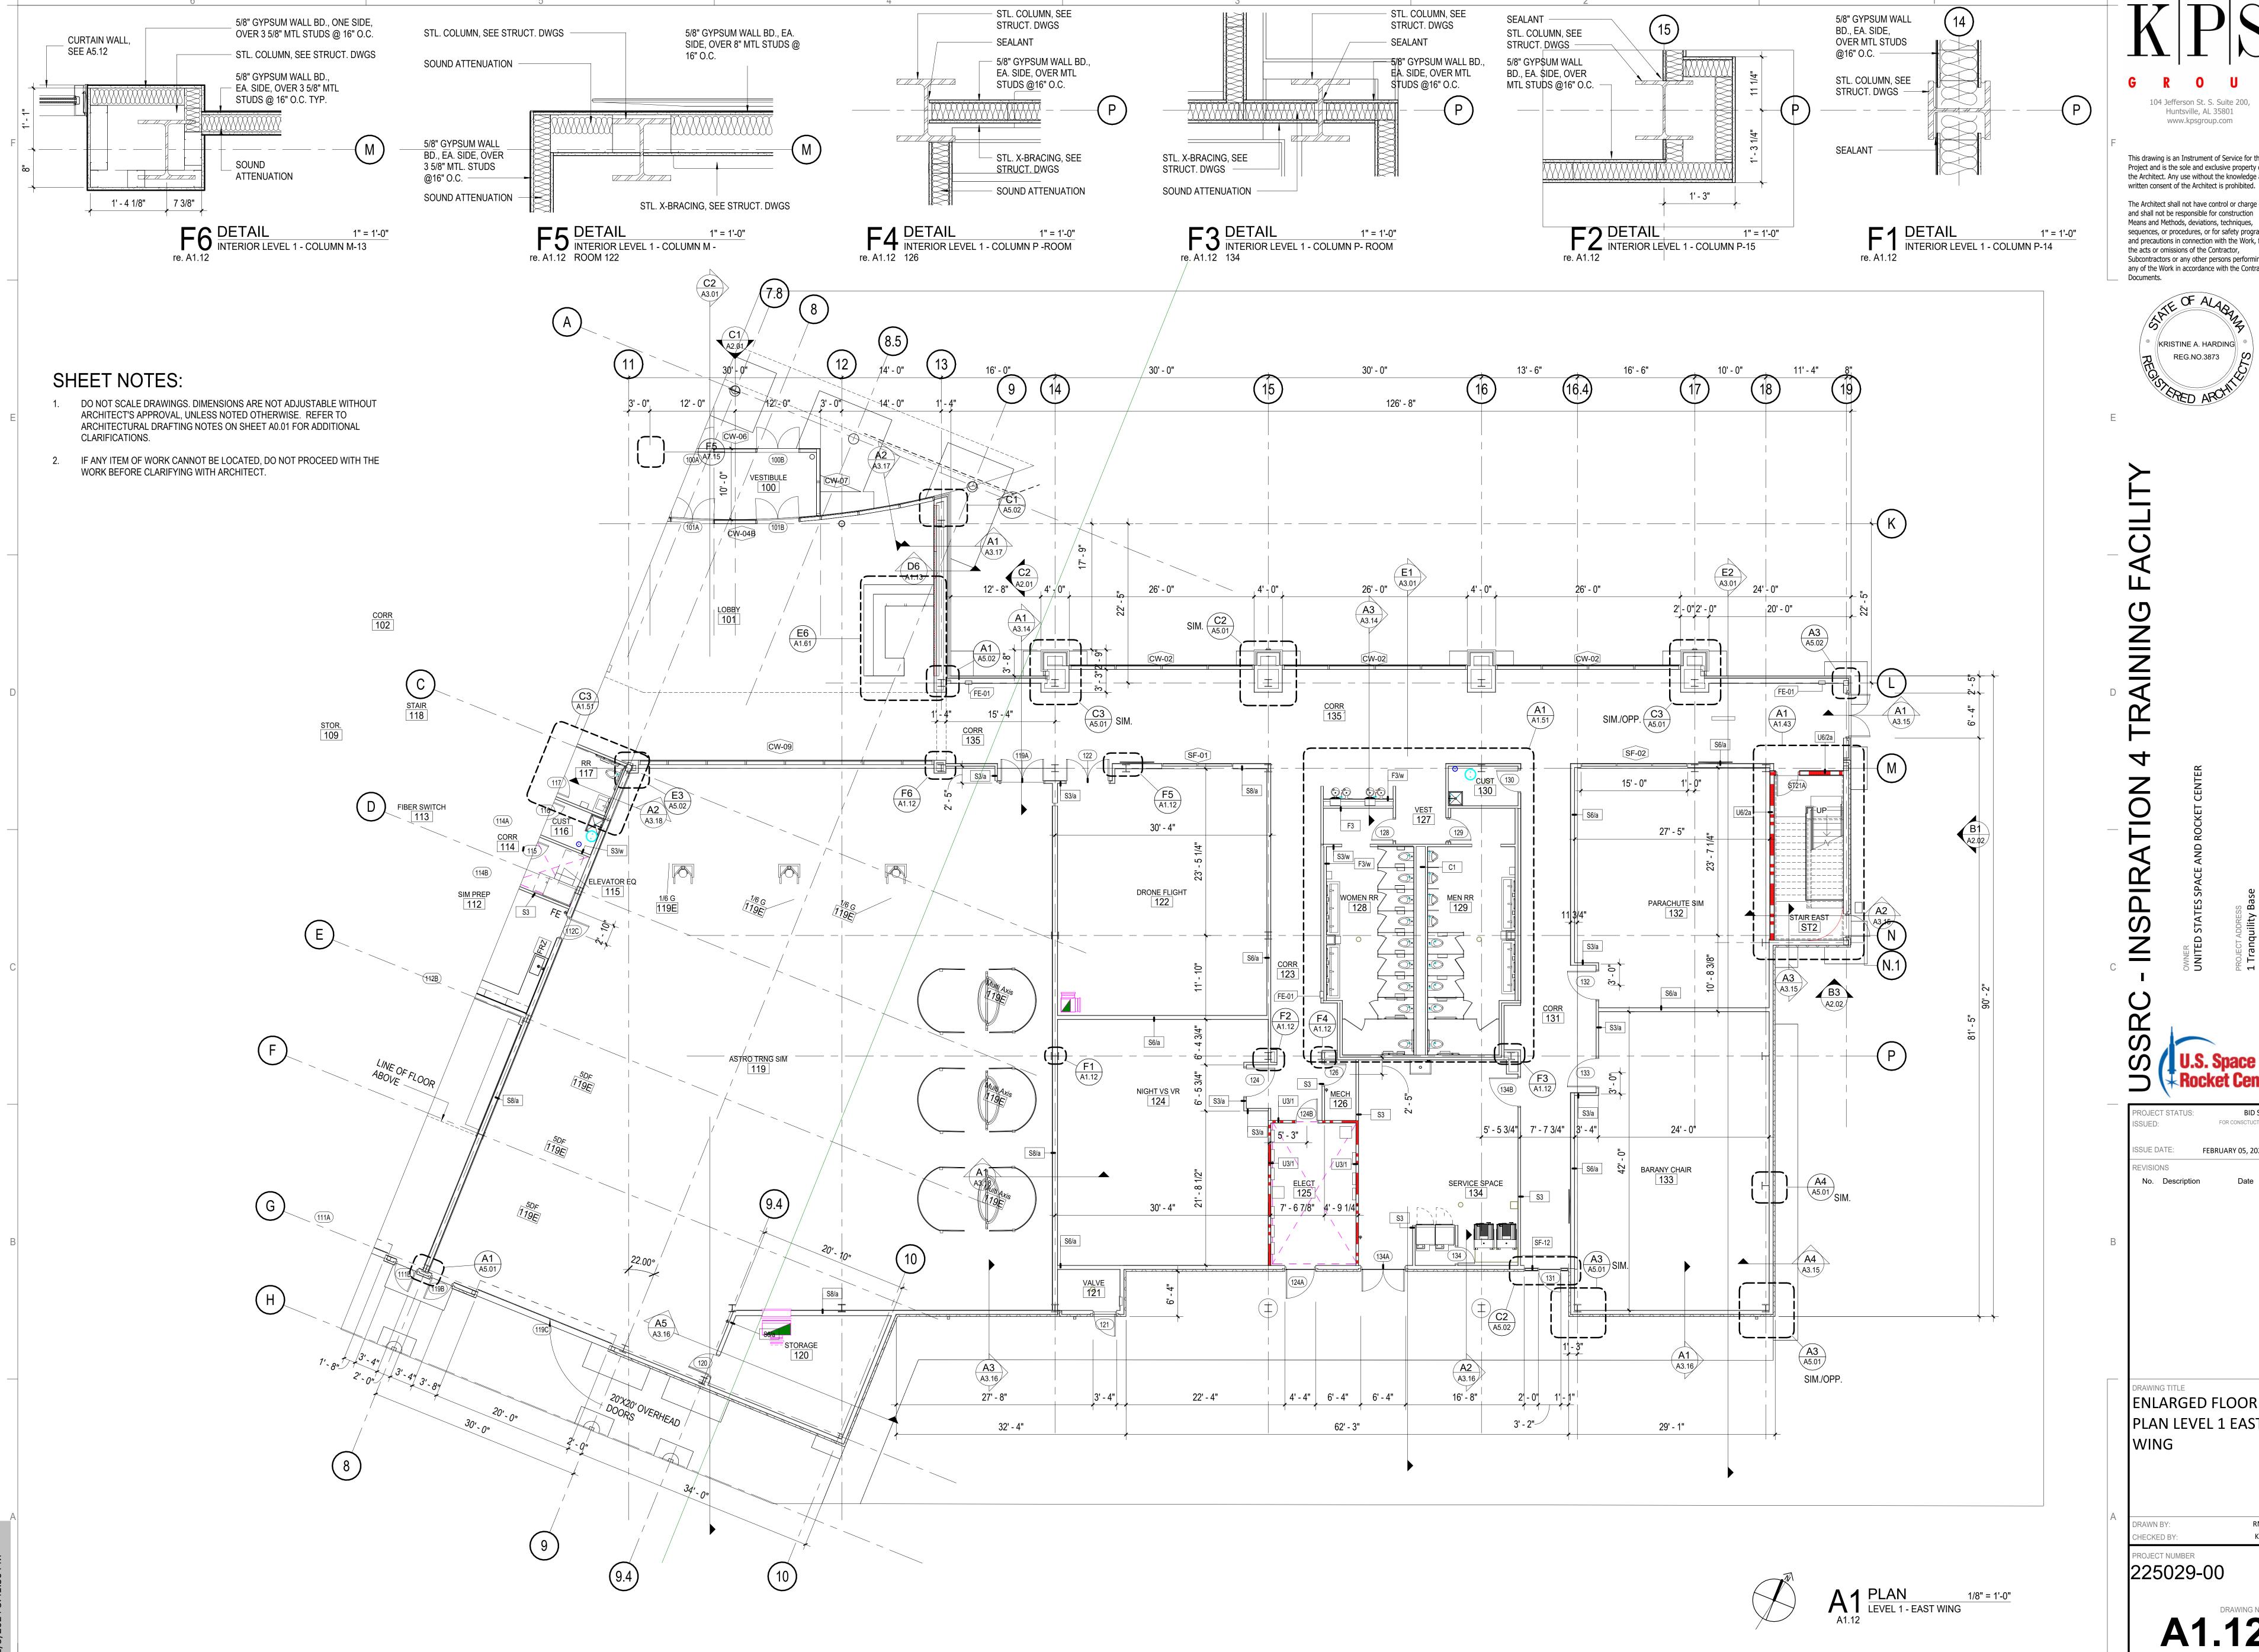225029-00



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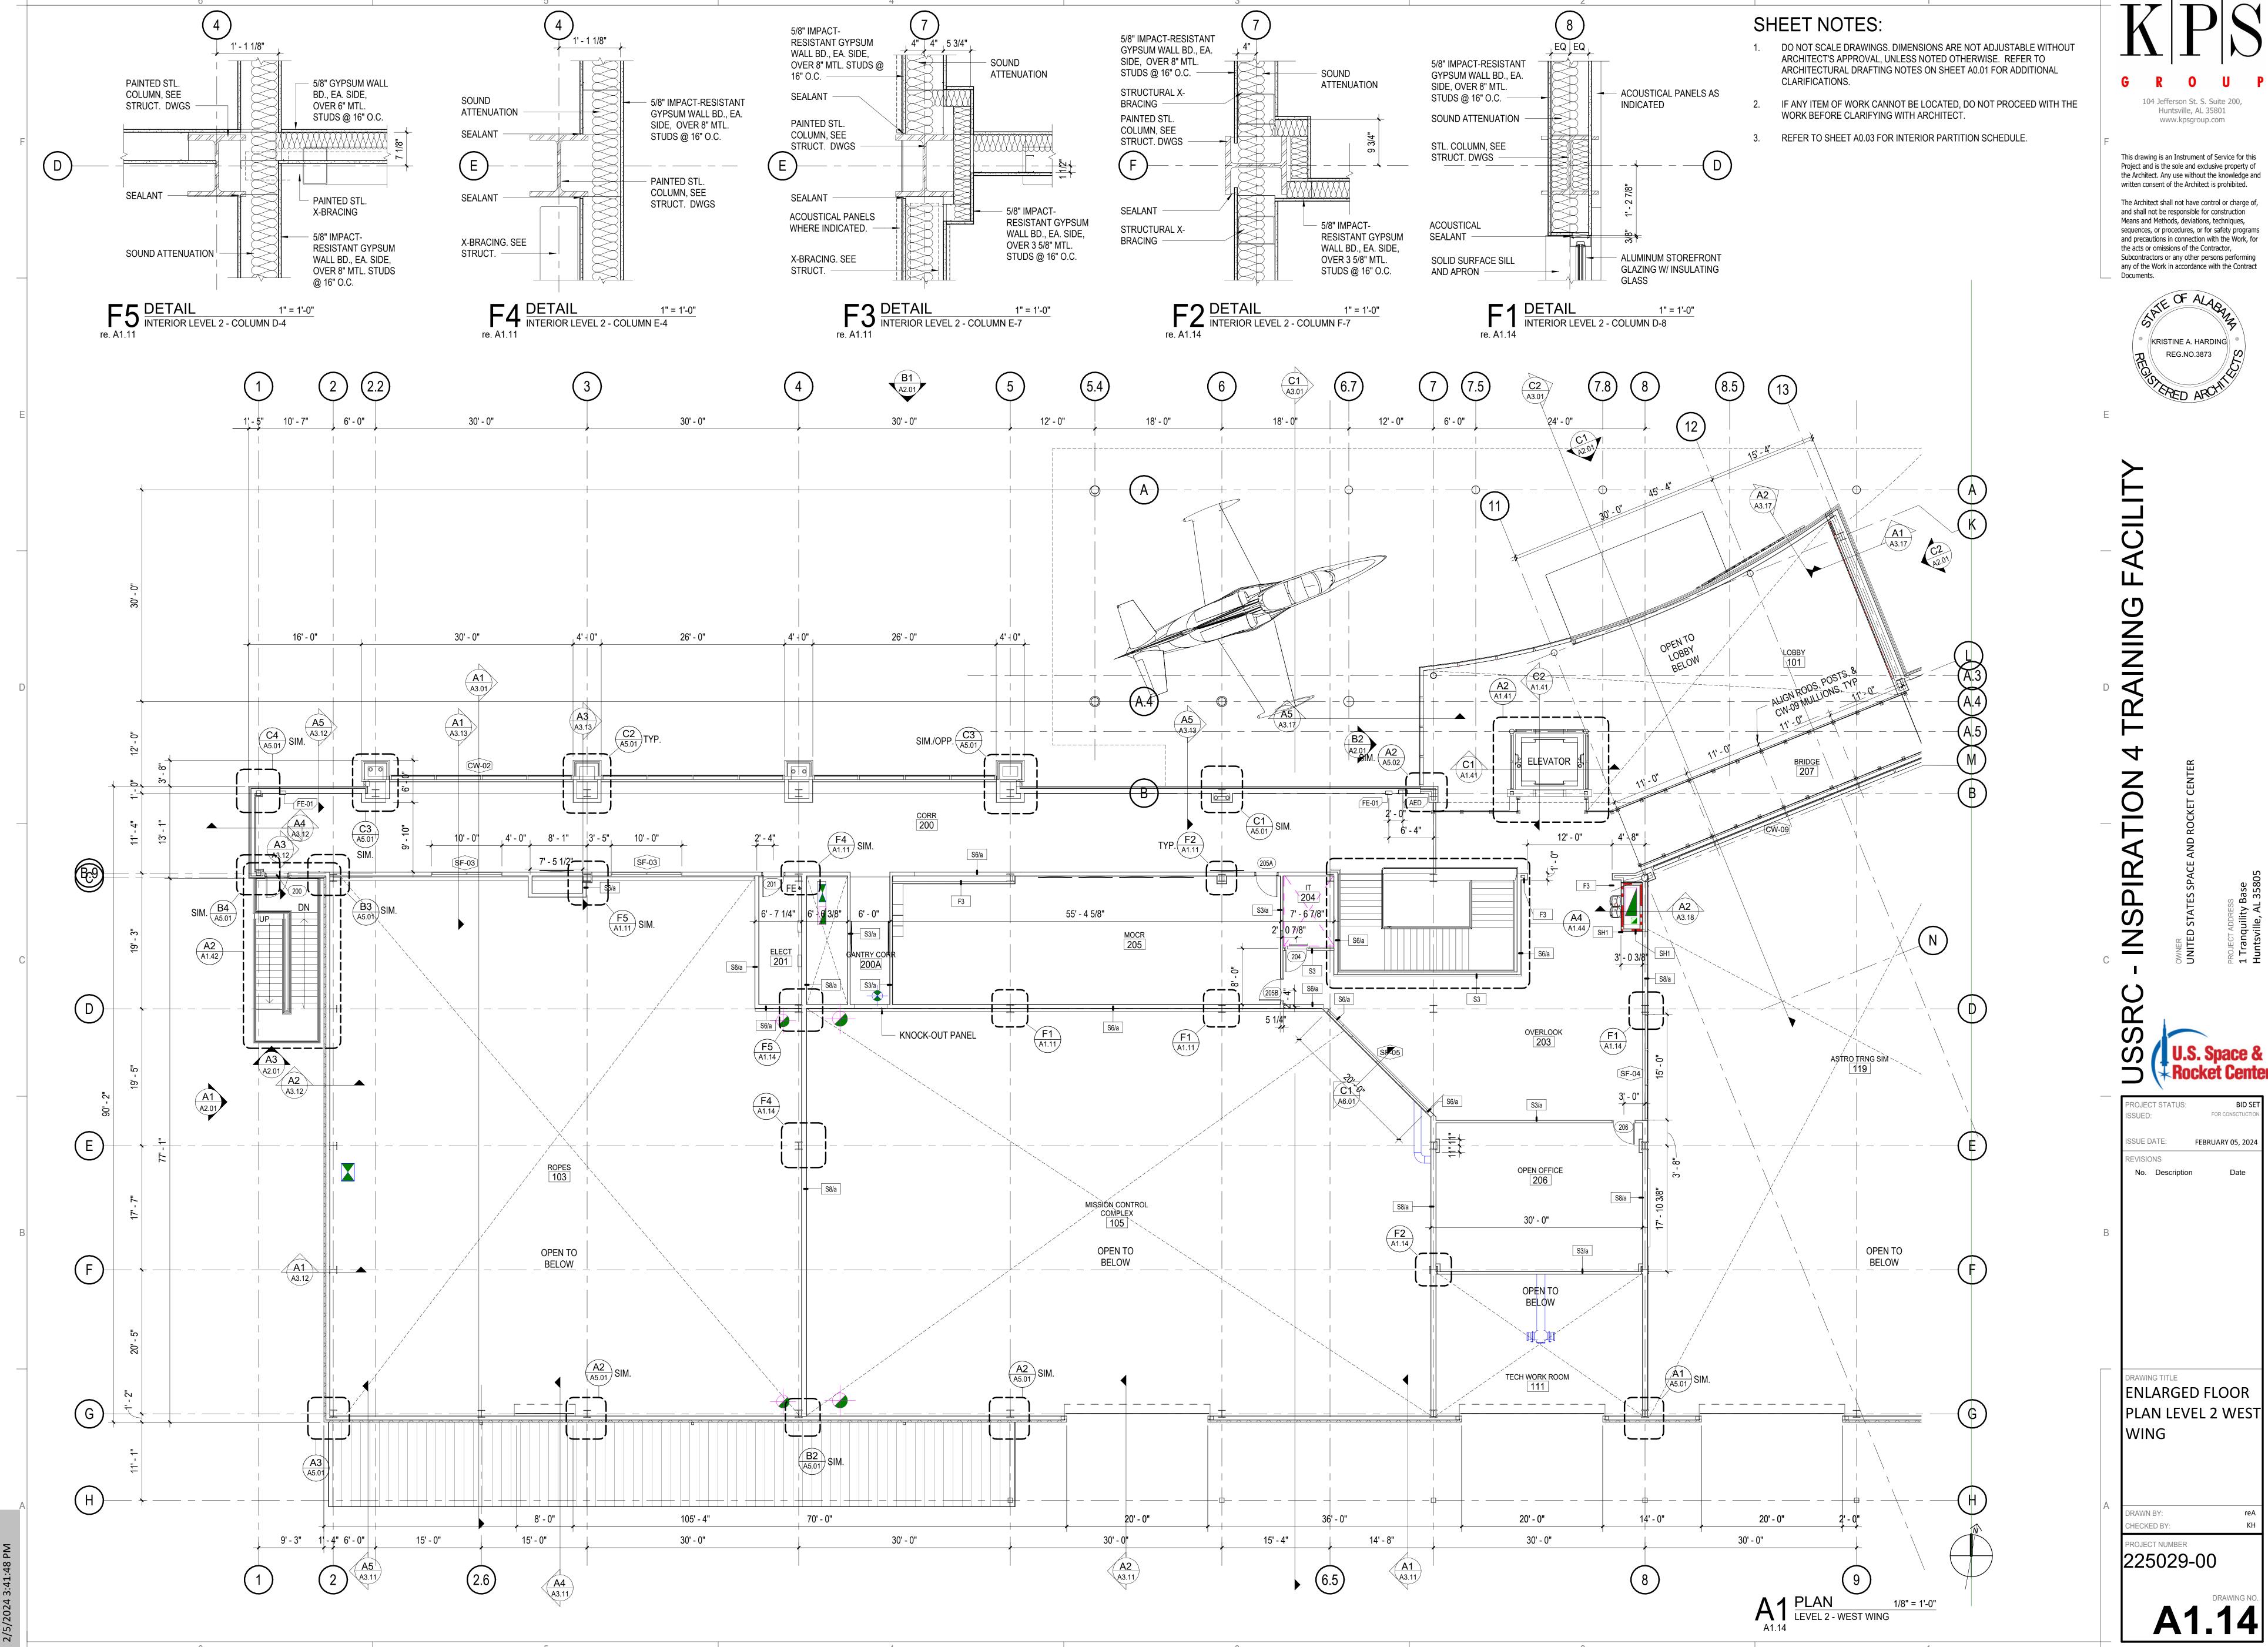
The Architect shall not have control or charge of, and shall not be responsible for construction Means and Methods, deviations, techniques, sequences, or procedures, or for safety programs and precautions in connection with the Work, for the acts or omissions of the Contractor, Subcontractors or any other persons performing any of the Work in accordance with the Contract


> KRISTINE A. HARDING REG.NO.3873

FEBRUARY 05, 2024 No. Description

ENLARGED FLOOR PLAN LEVEL 1 -

ROJECT NUMBER 225029-00



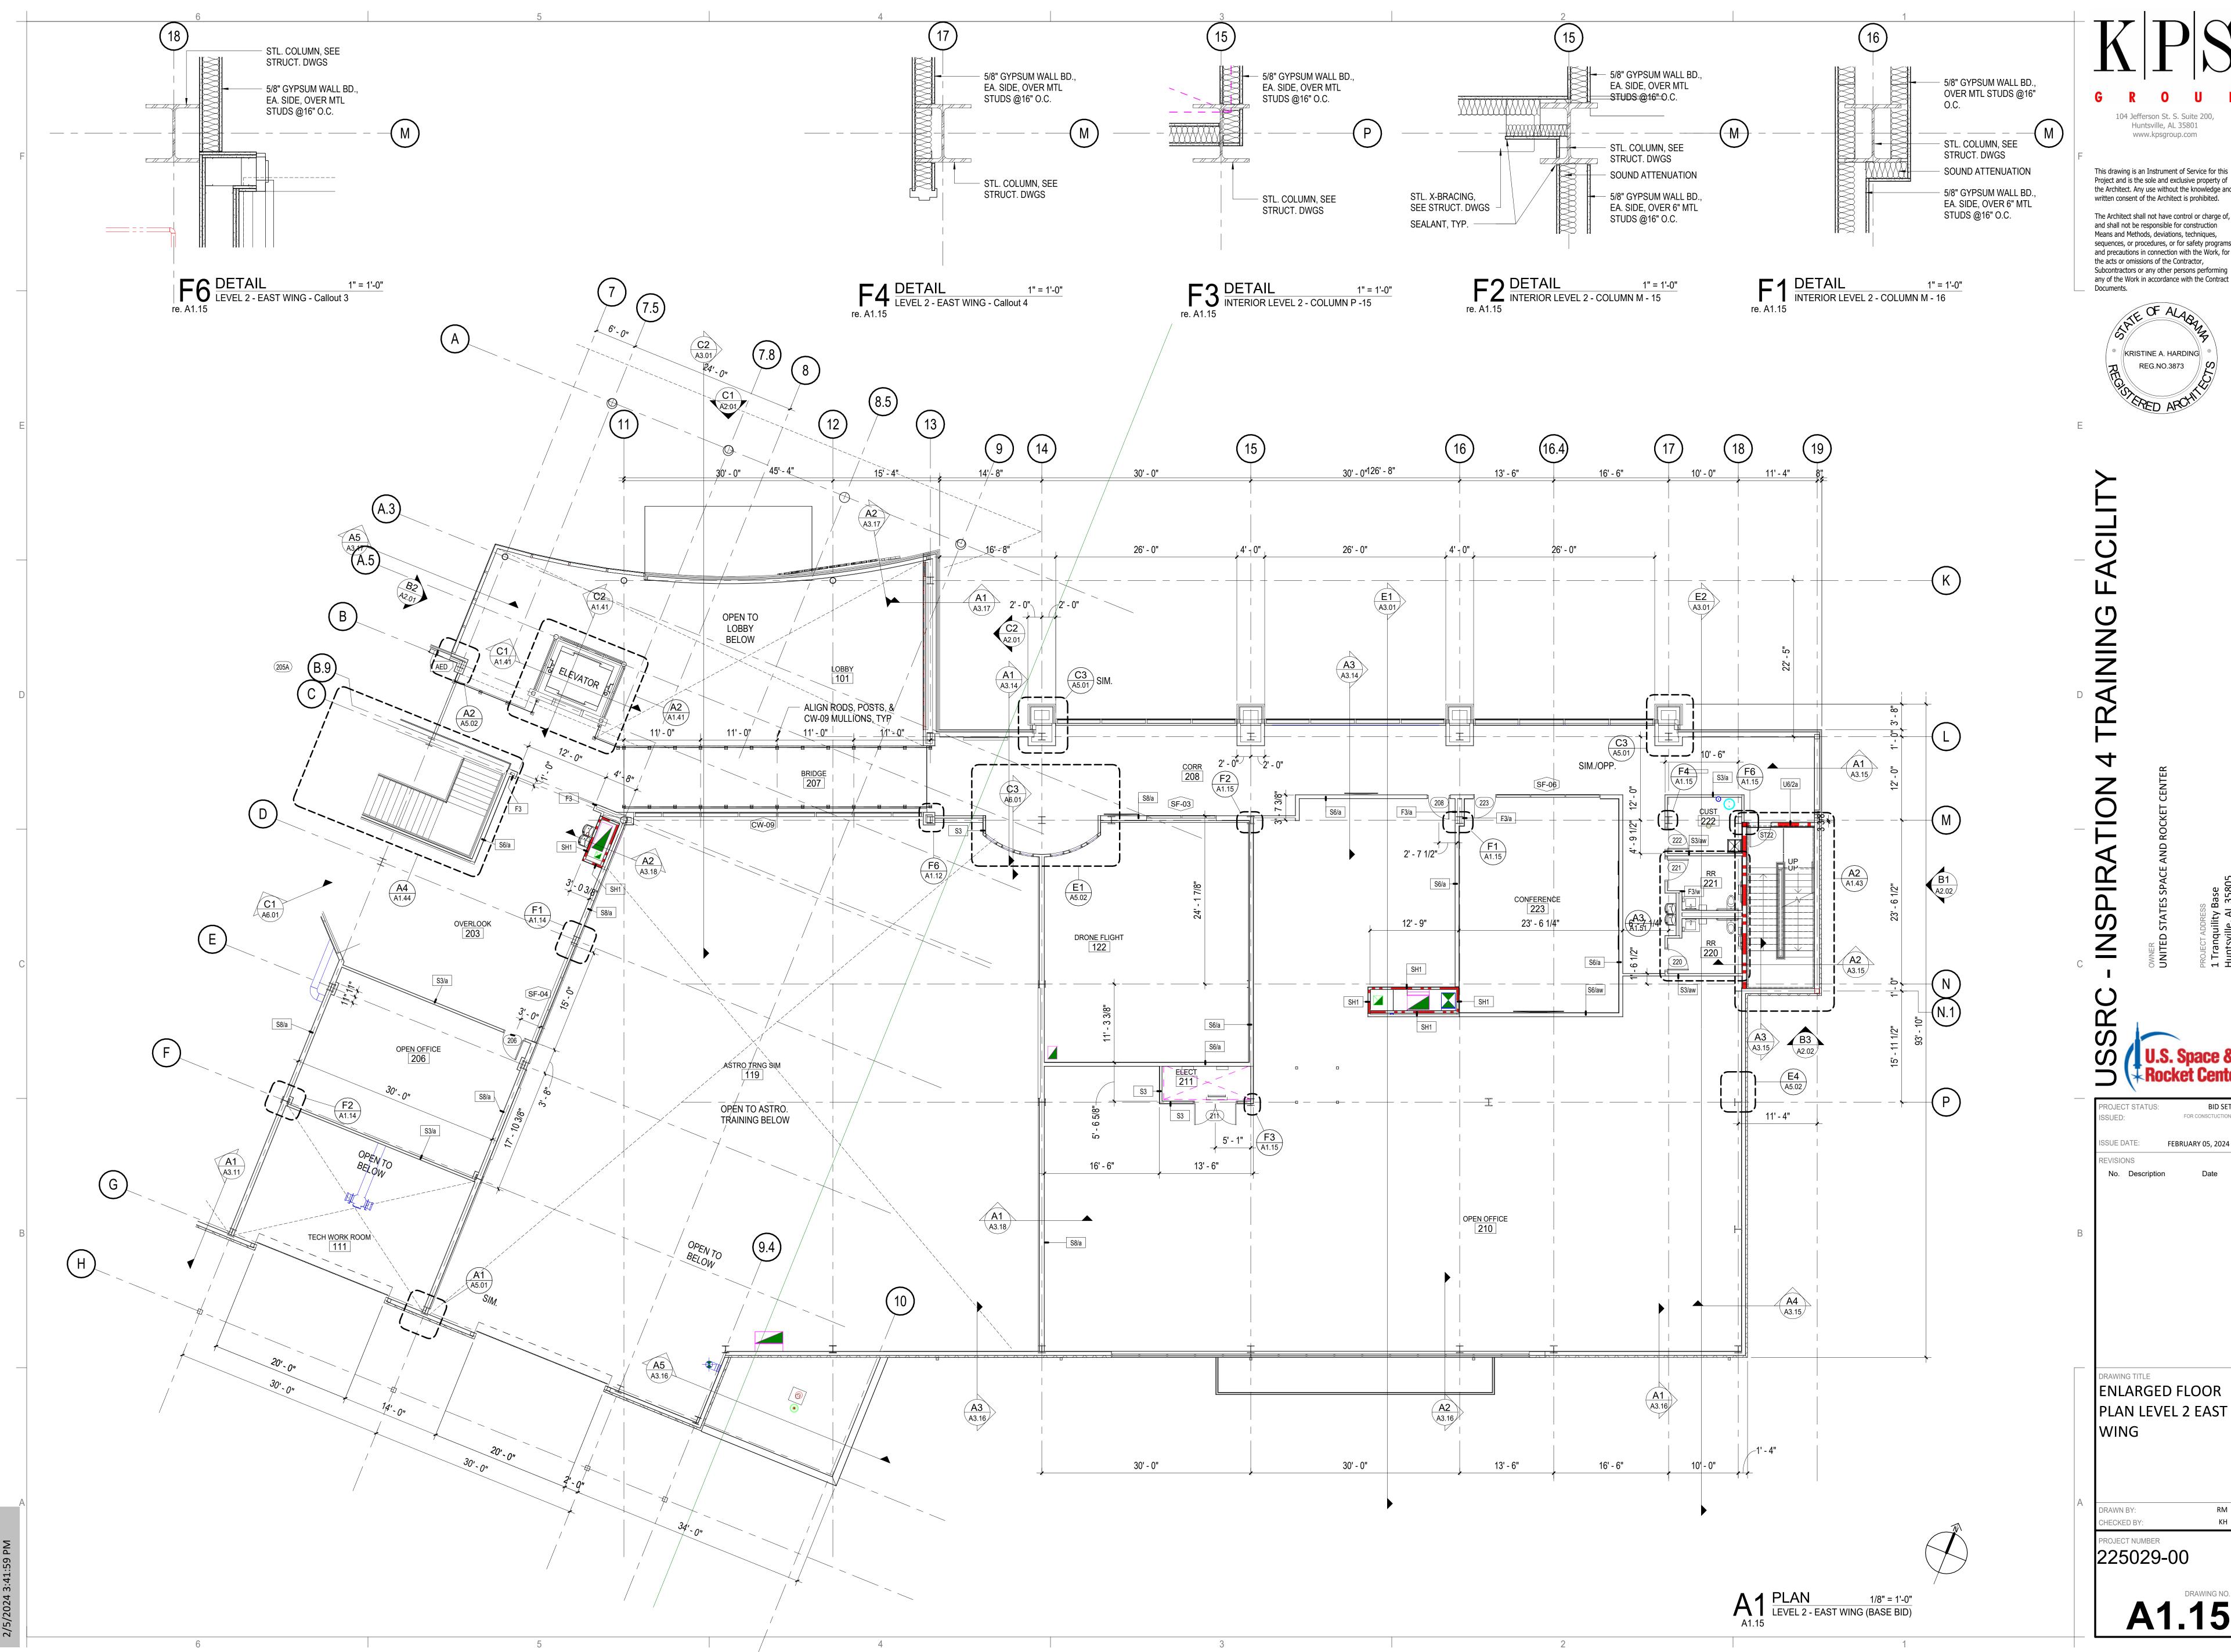

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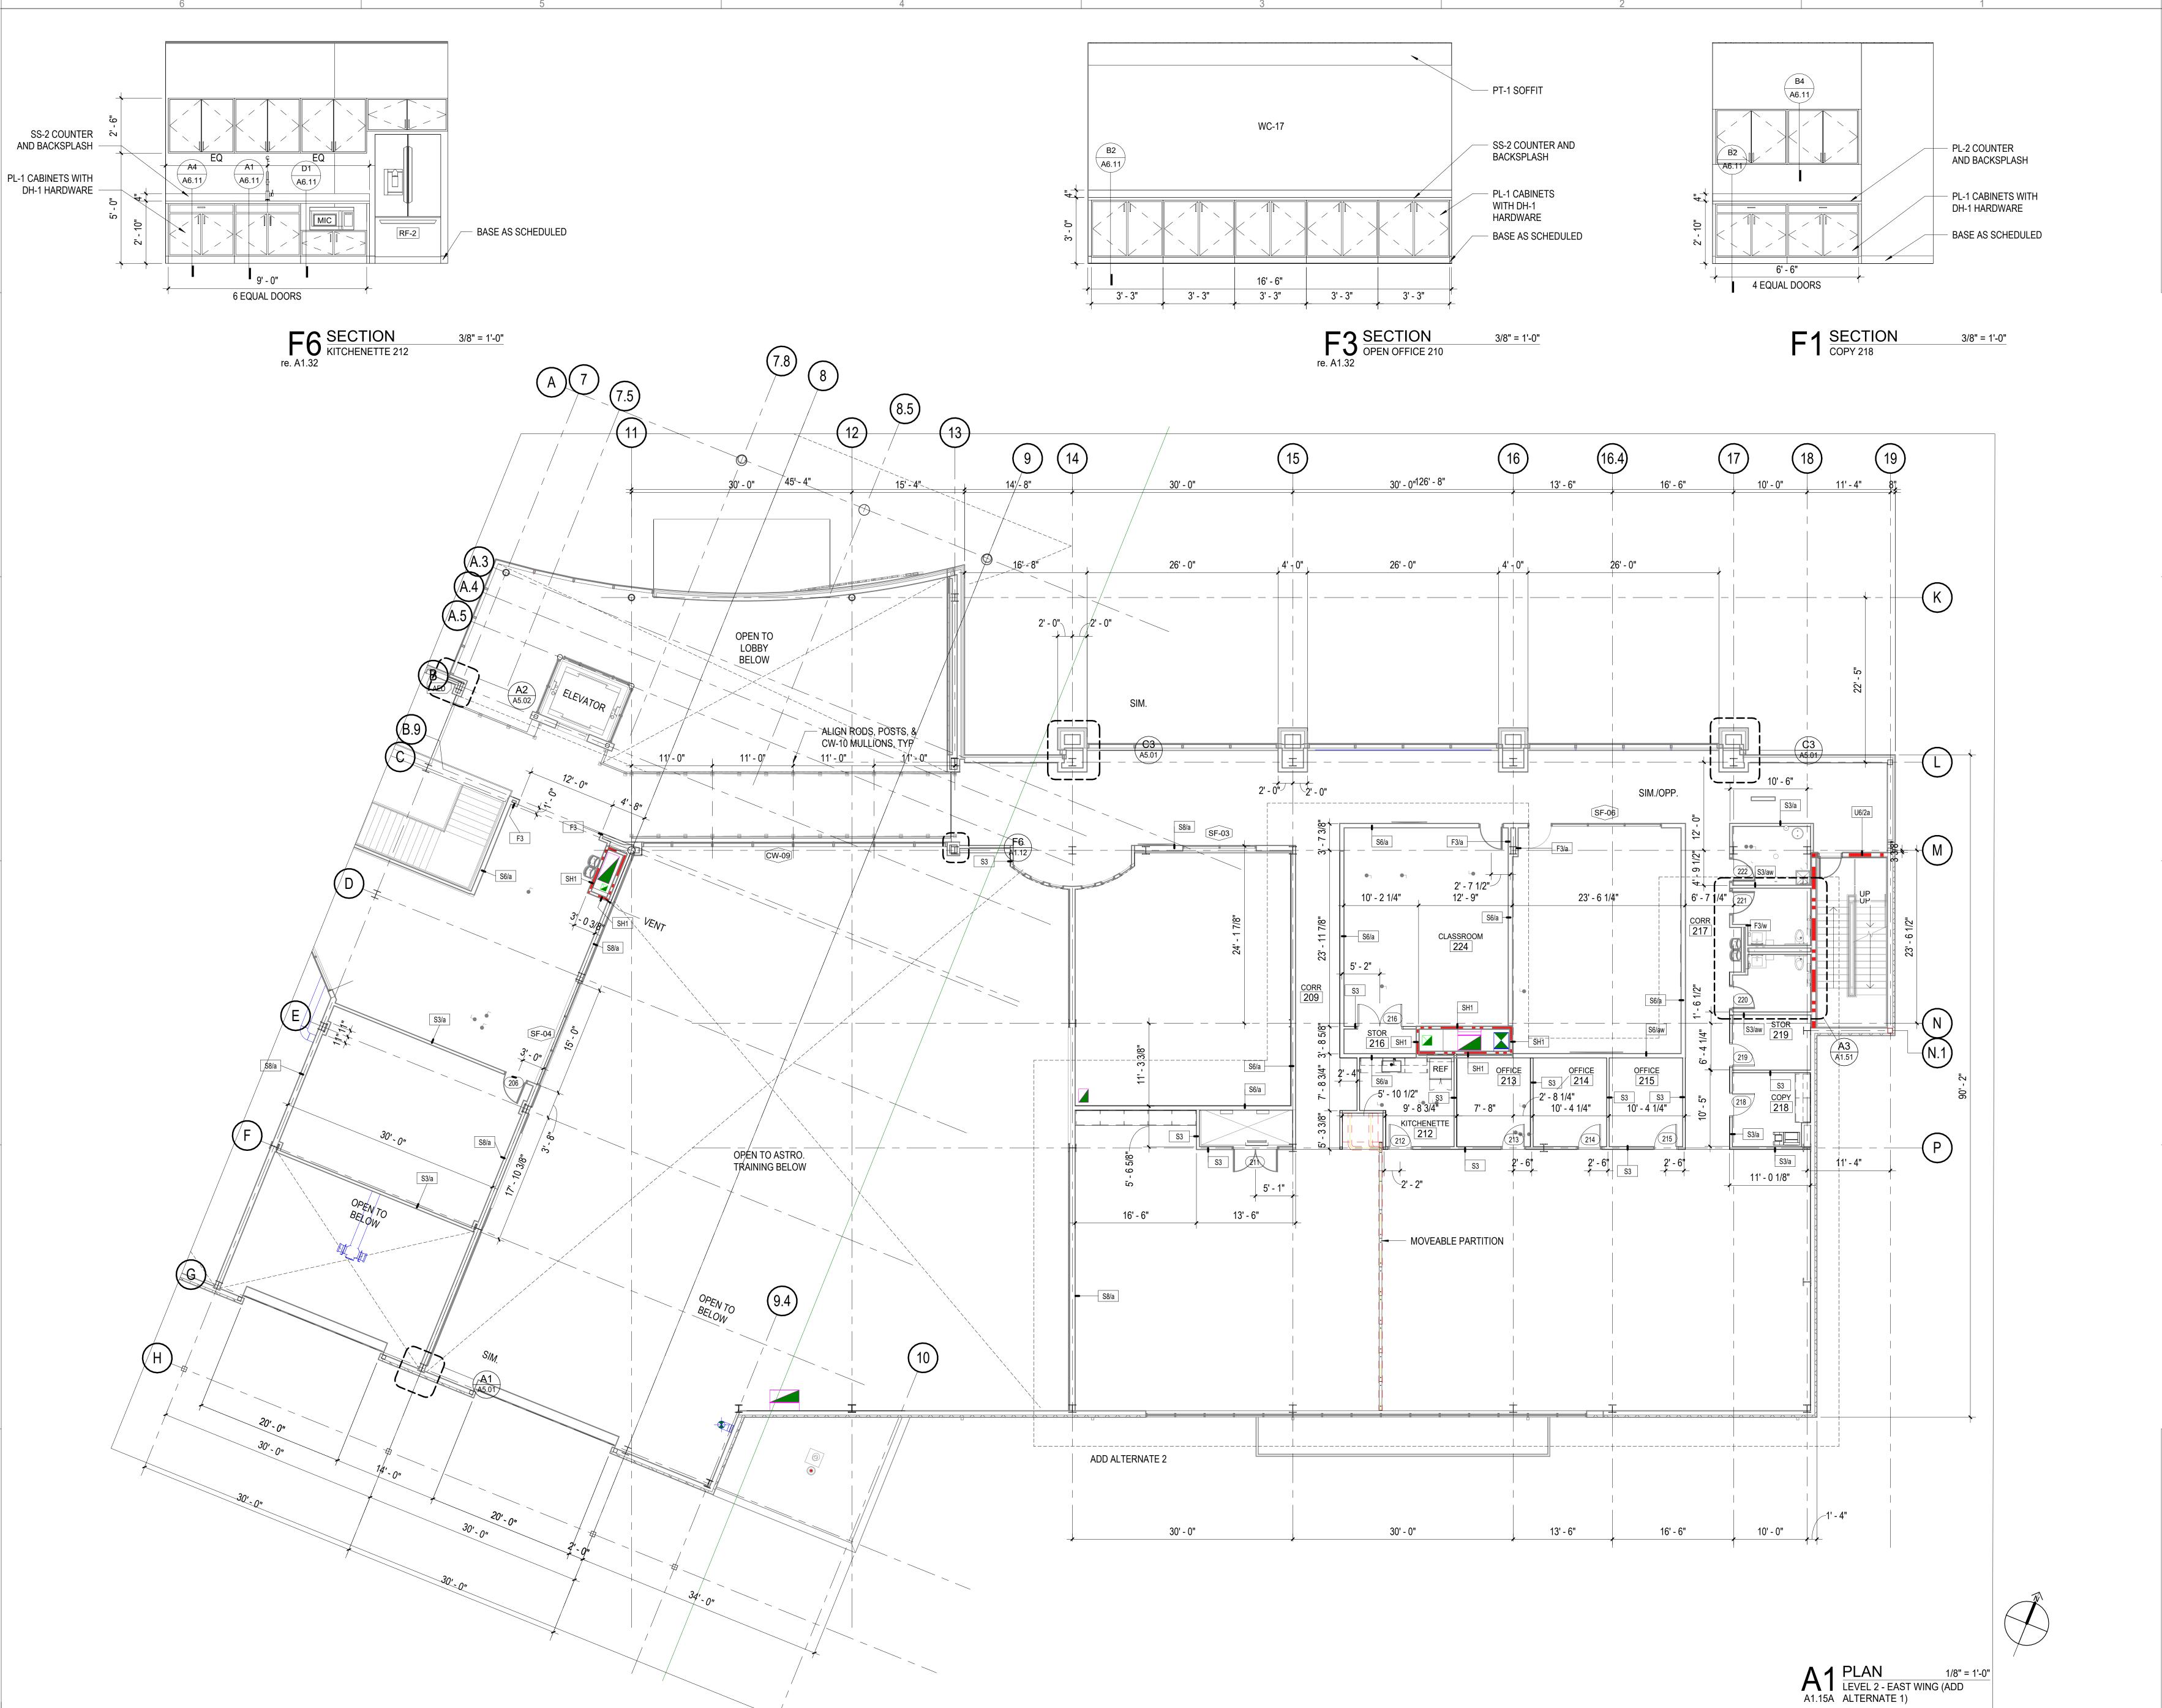
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ENLARGED FLOOR PLAN LEVEL 2 EAST

A1.15



GROUP

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F

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Subcontractors or any other persons performing any of the Work in accordance with the Contract Documents.

OF ALABARA KRISTINE A. HARDING REG.NO.3873

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sequences, or procedures, or for safety programs and precautions in connection with the Work, for

Means and Methods, deviations, techniques,

the acts or omissions of the Contractor,

SRC - INSPIRATION 4 TRAINING FACILIT

U.S. Space & Rocket Center

PROJECT STATUS:

ISSUED:

FOR CONSCTUCTION

ISSUE DATE:

FEBRUARY 05, 2024

REVISIONS

No. Description


Date


DRAWING TITLE
ENLARGED FLOOR
PLAN LEVEL 2 EAST
WING ADD
ALTERNATE 1


DRAWN BY:
CHECKED BY:
PROJECT NUMBER


PROJECT NUMBER 225029-00


A1.15A

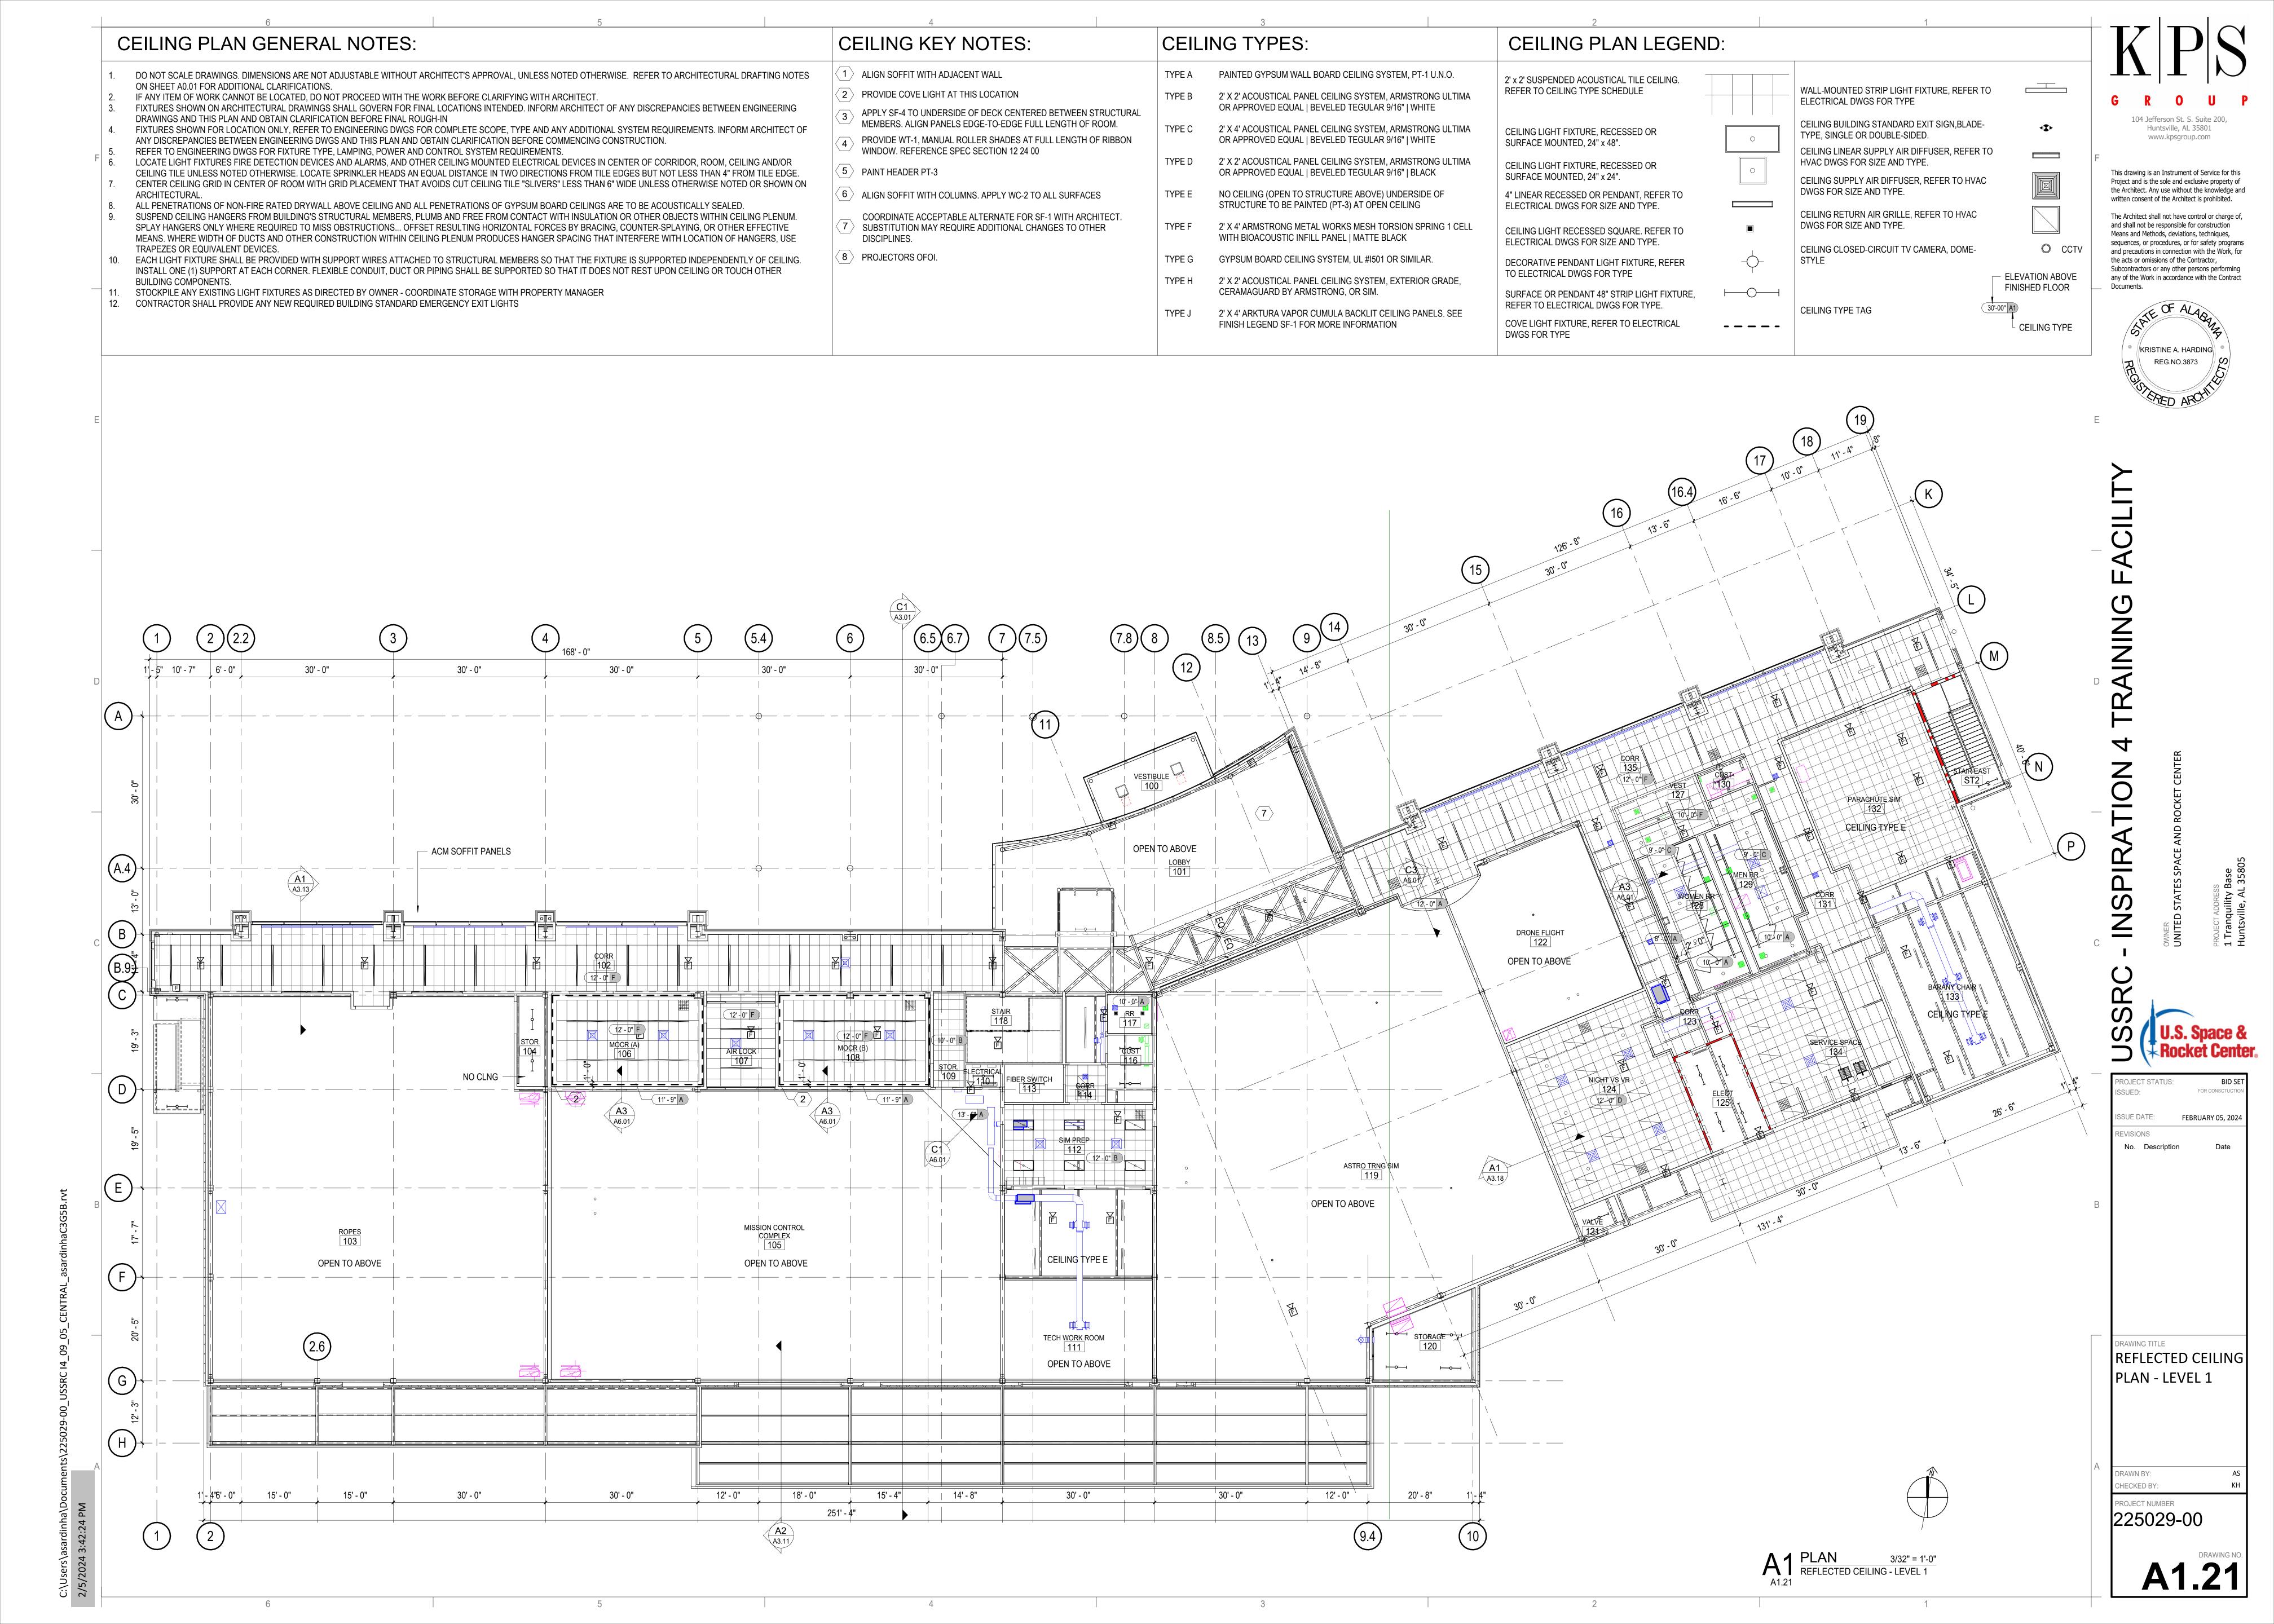


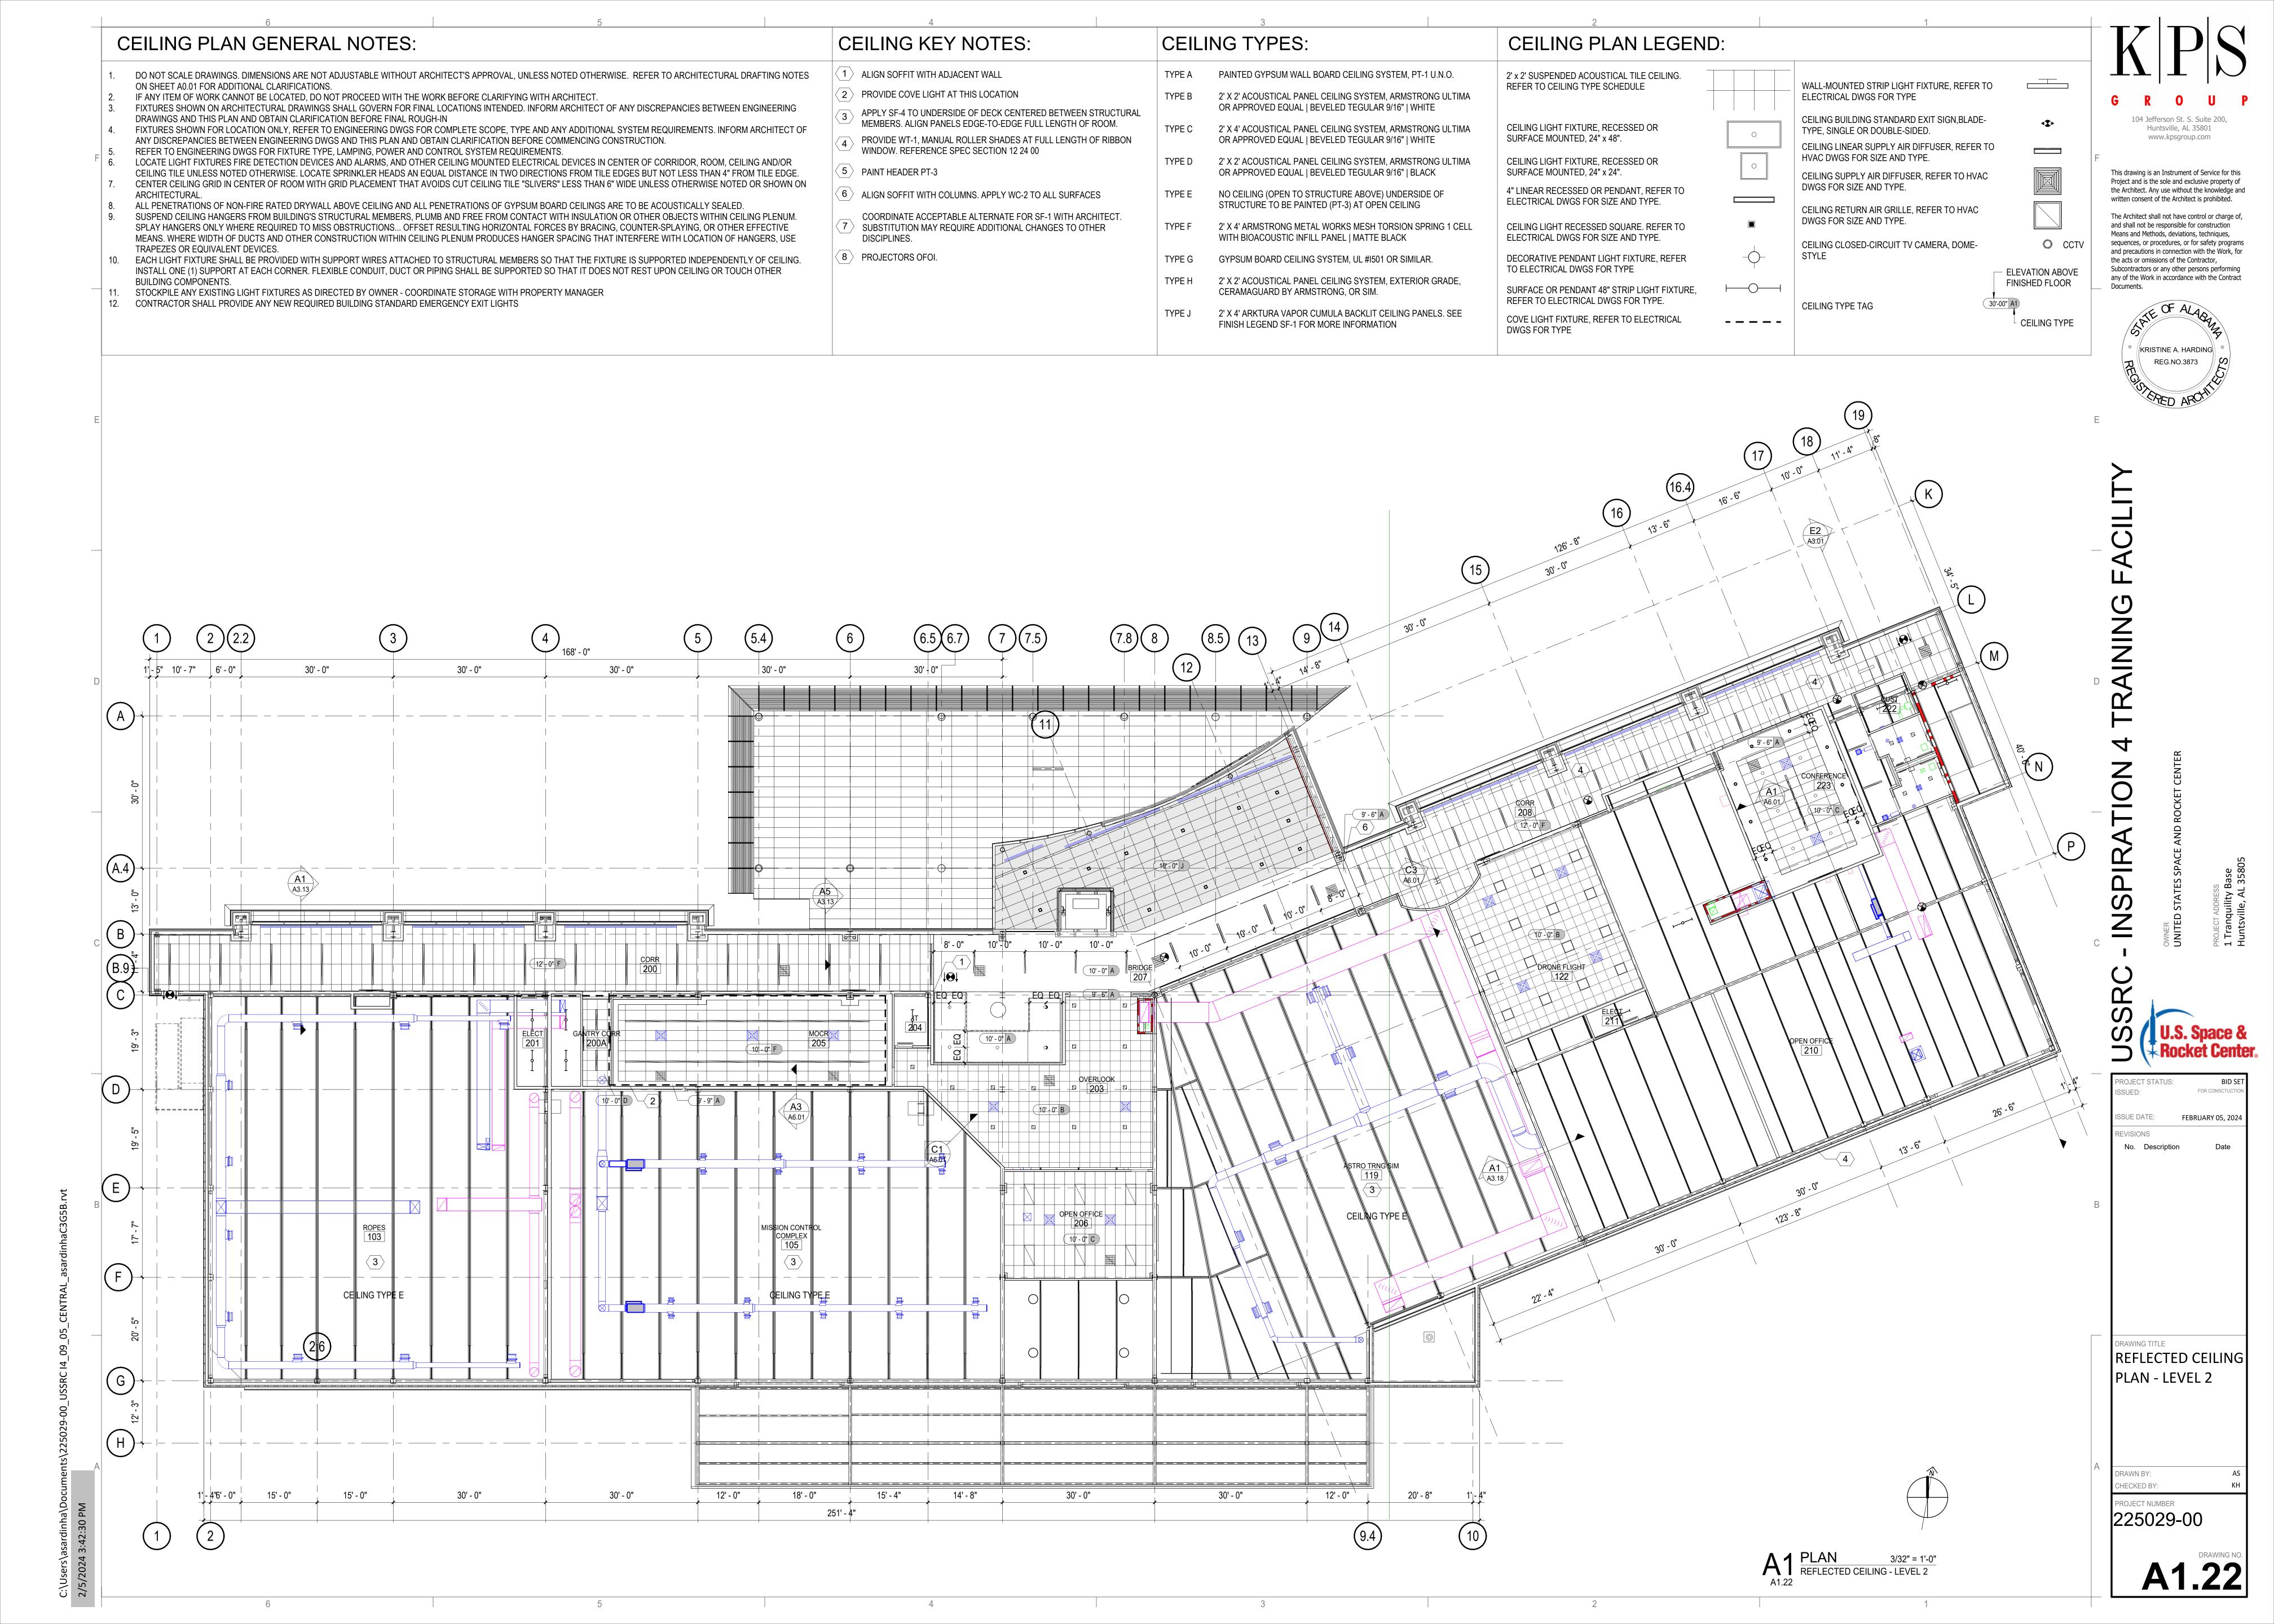


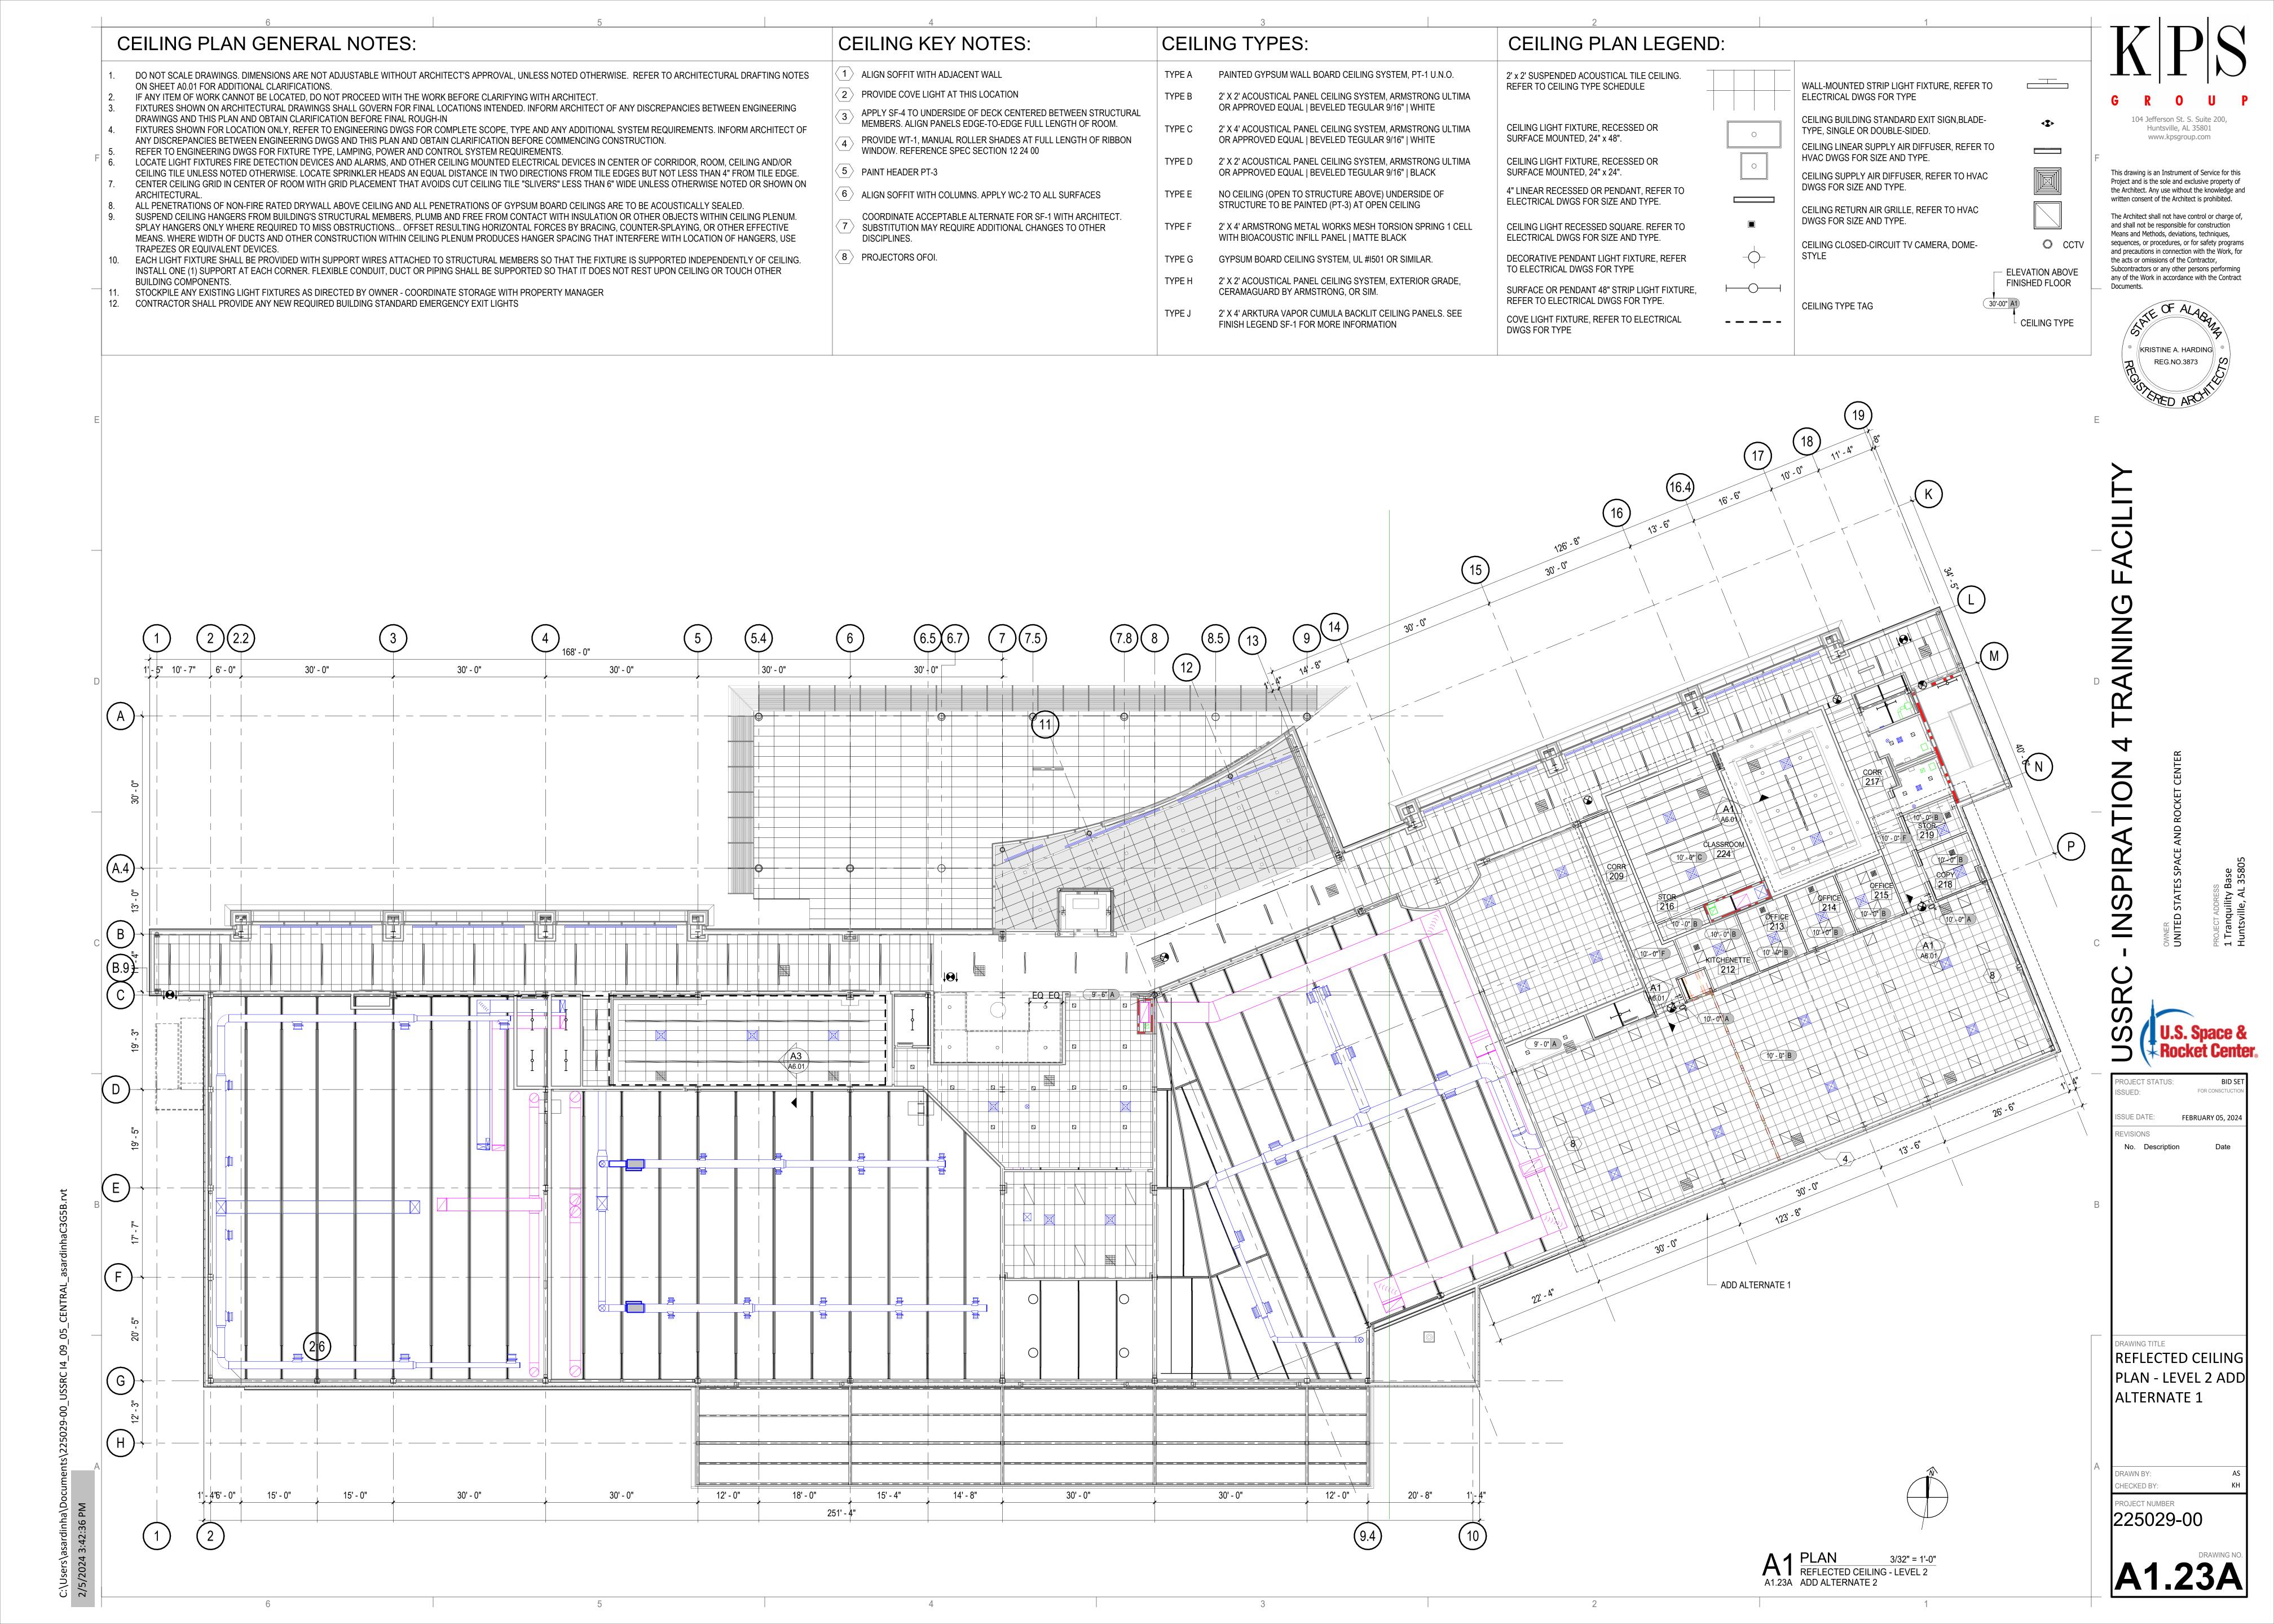


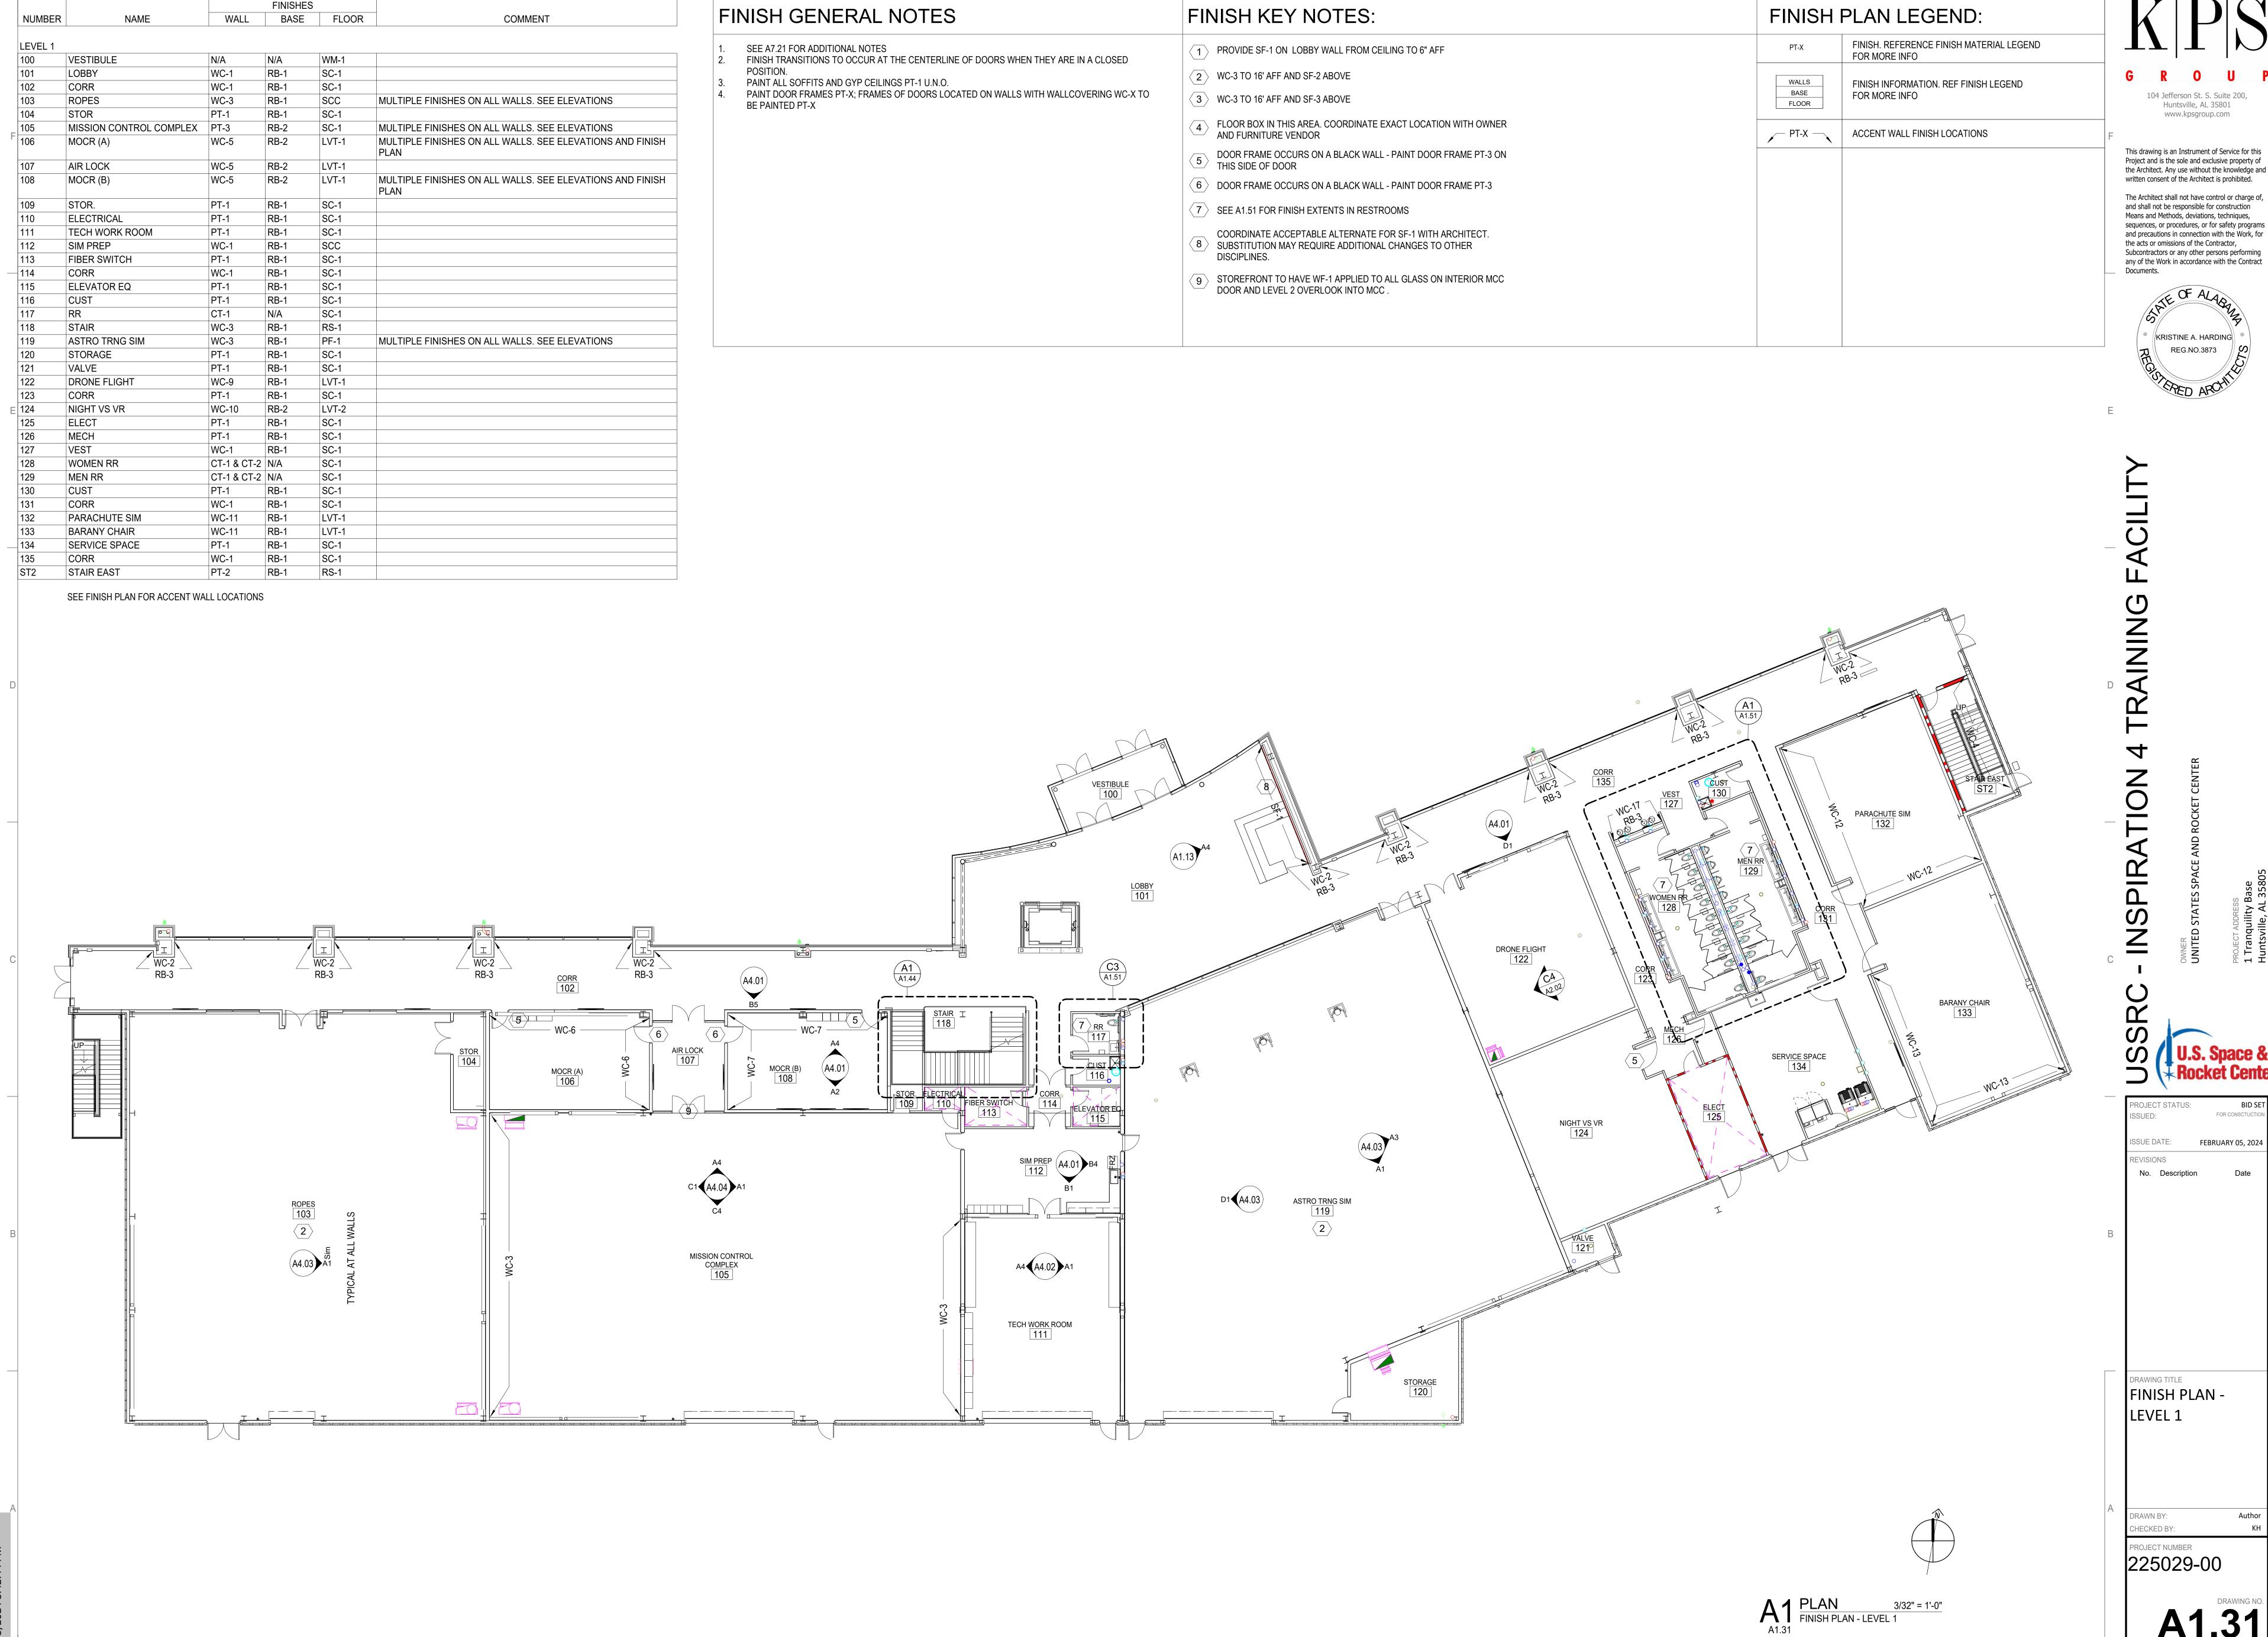


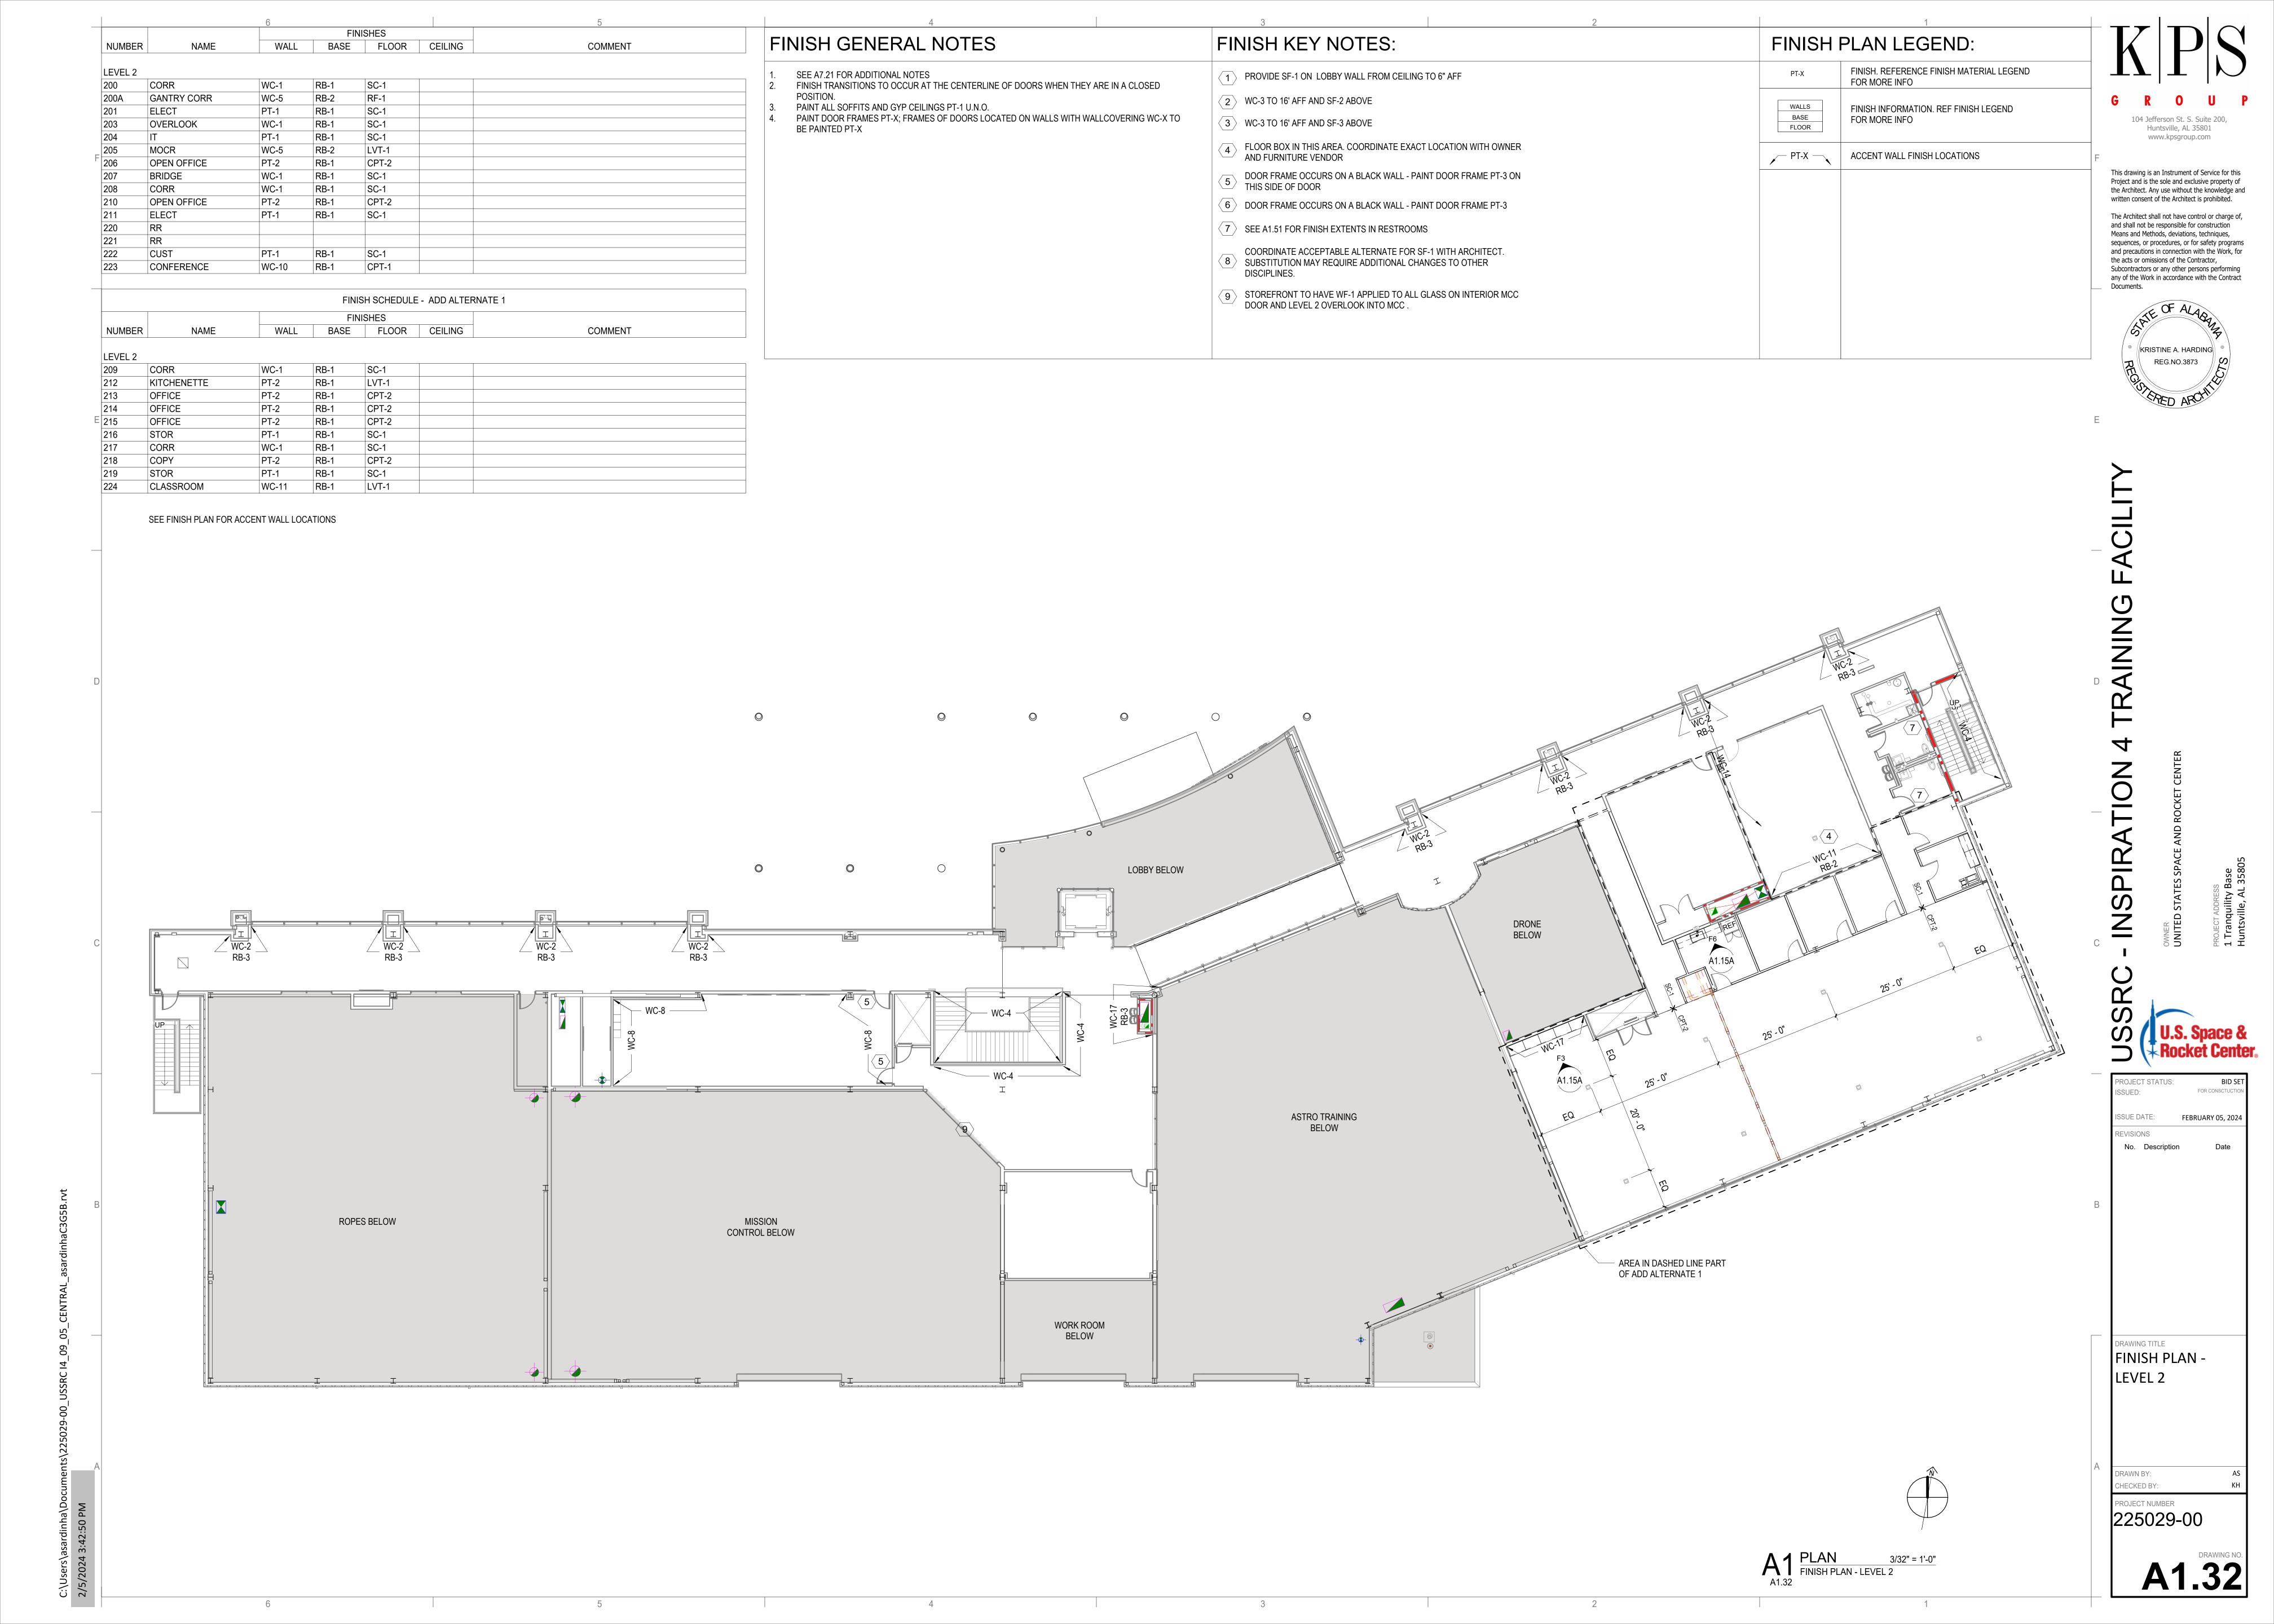

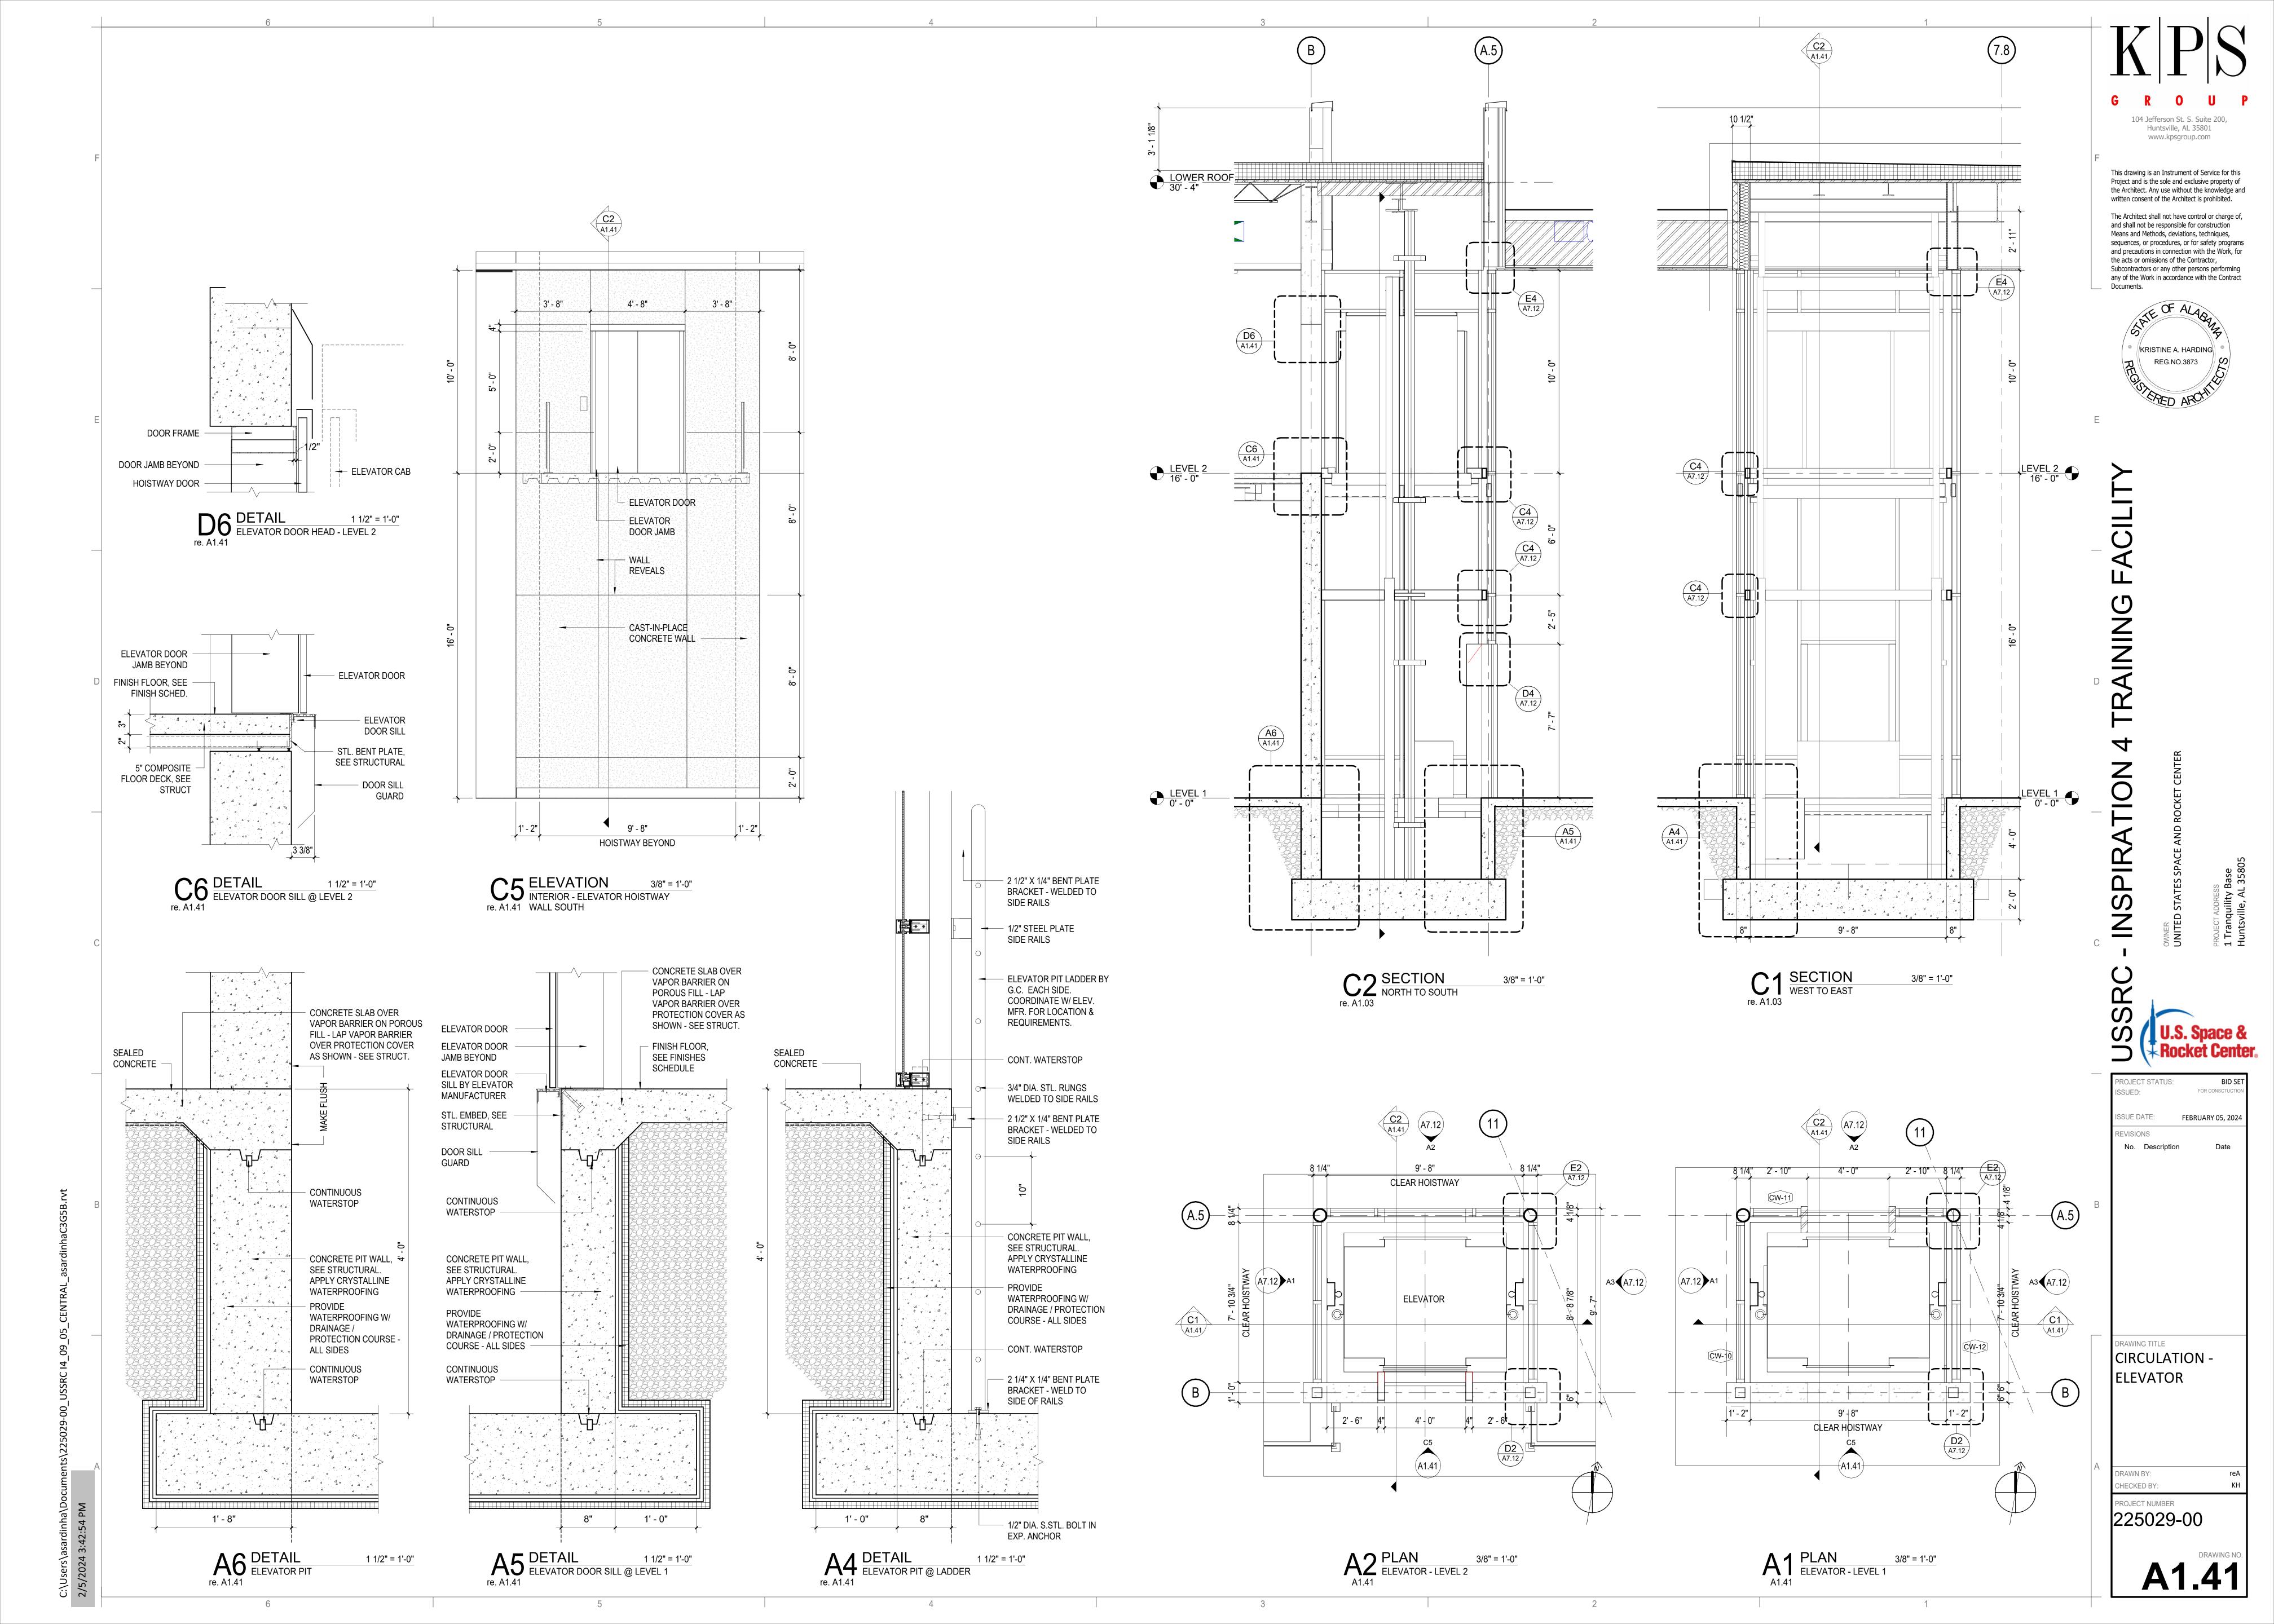

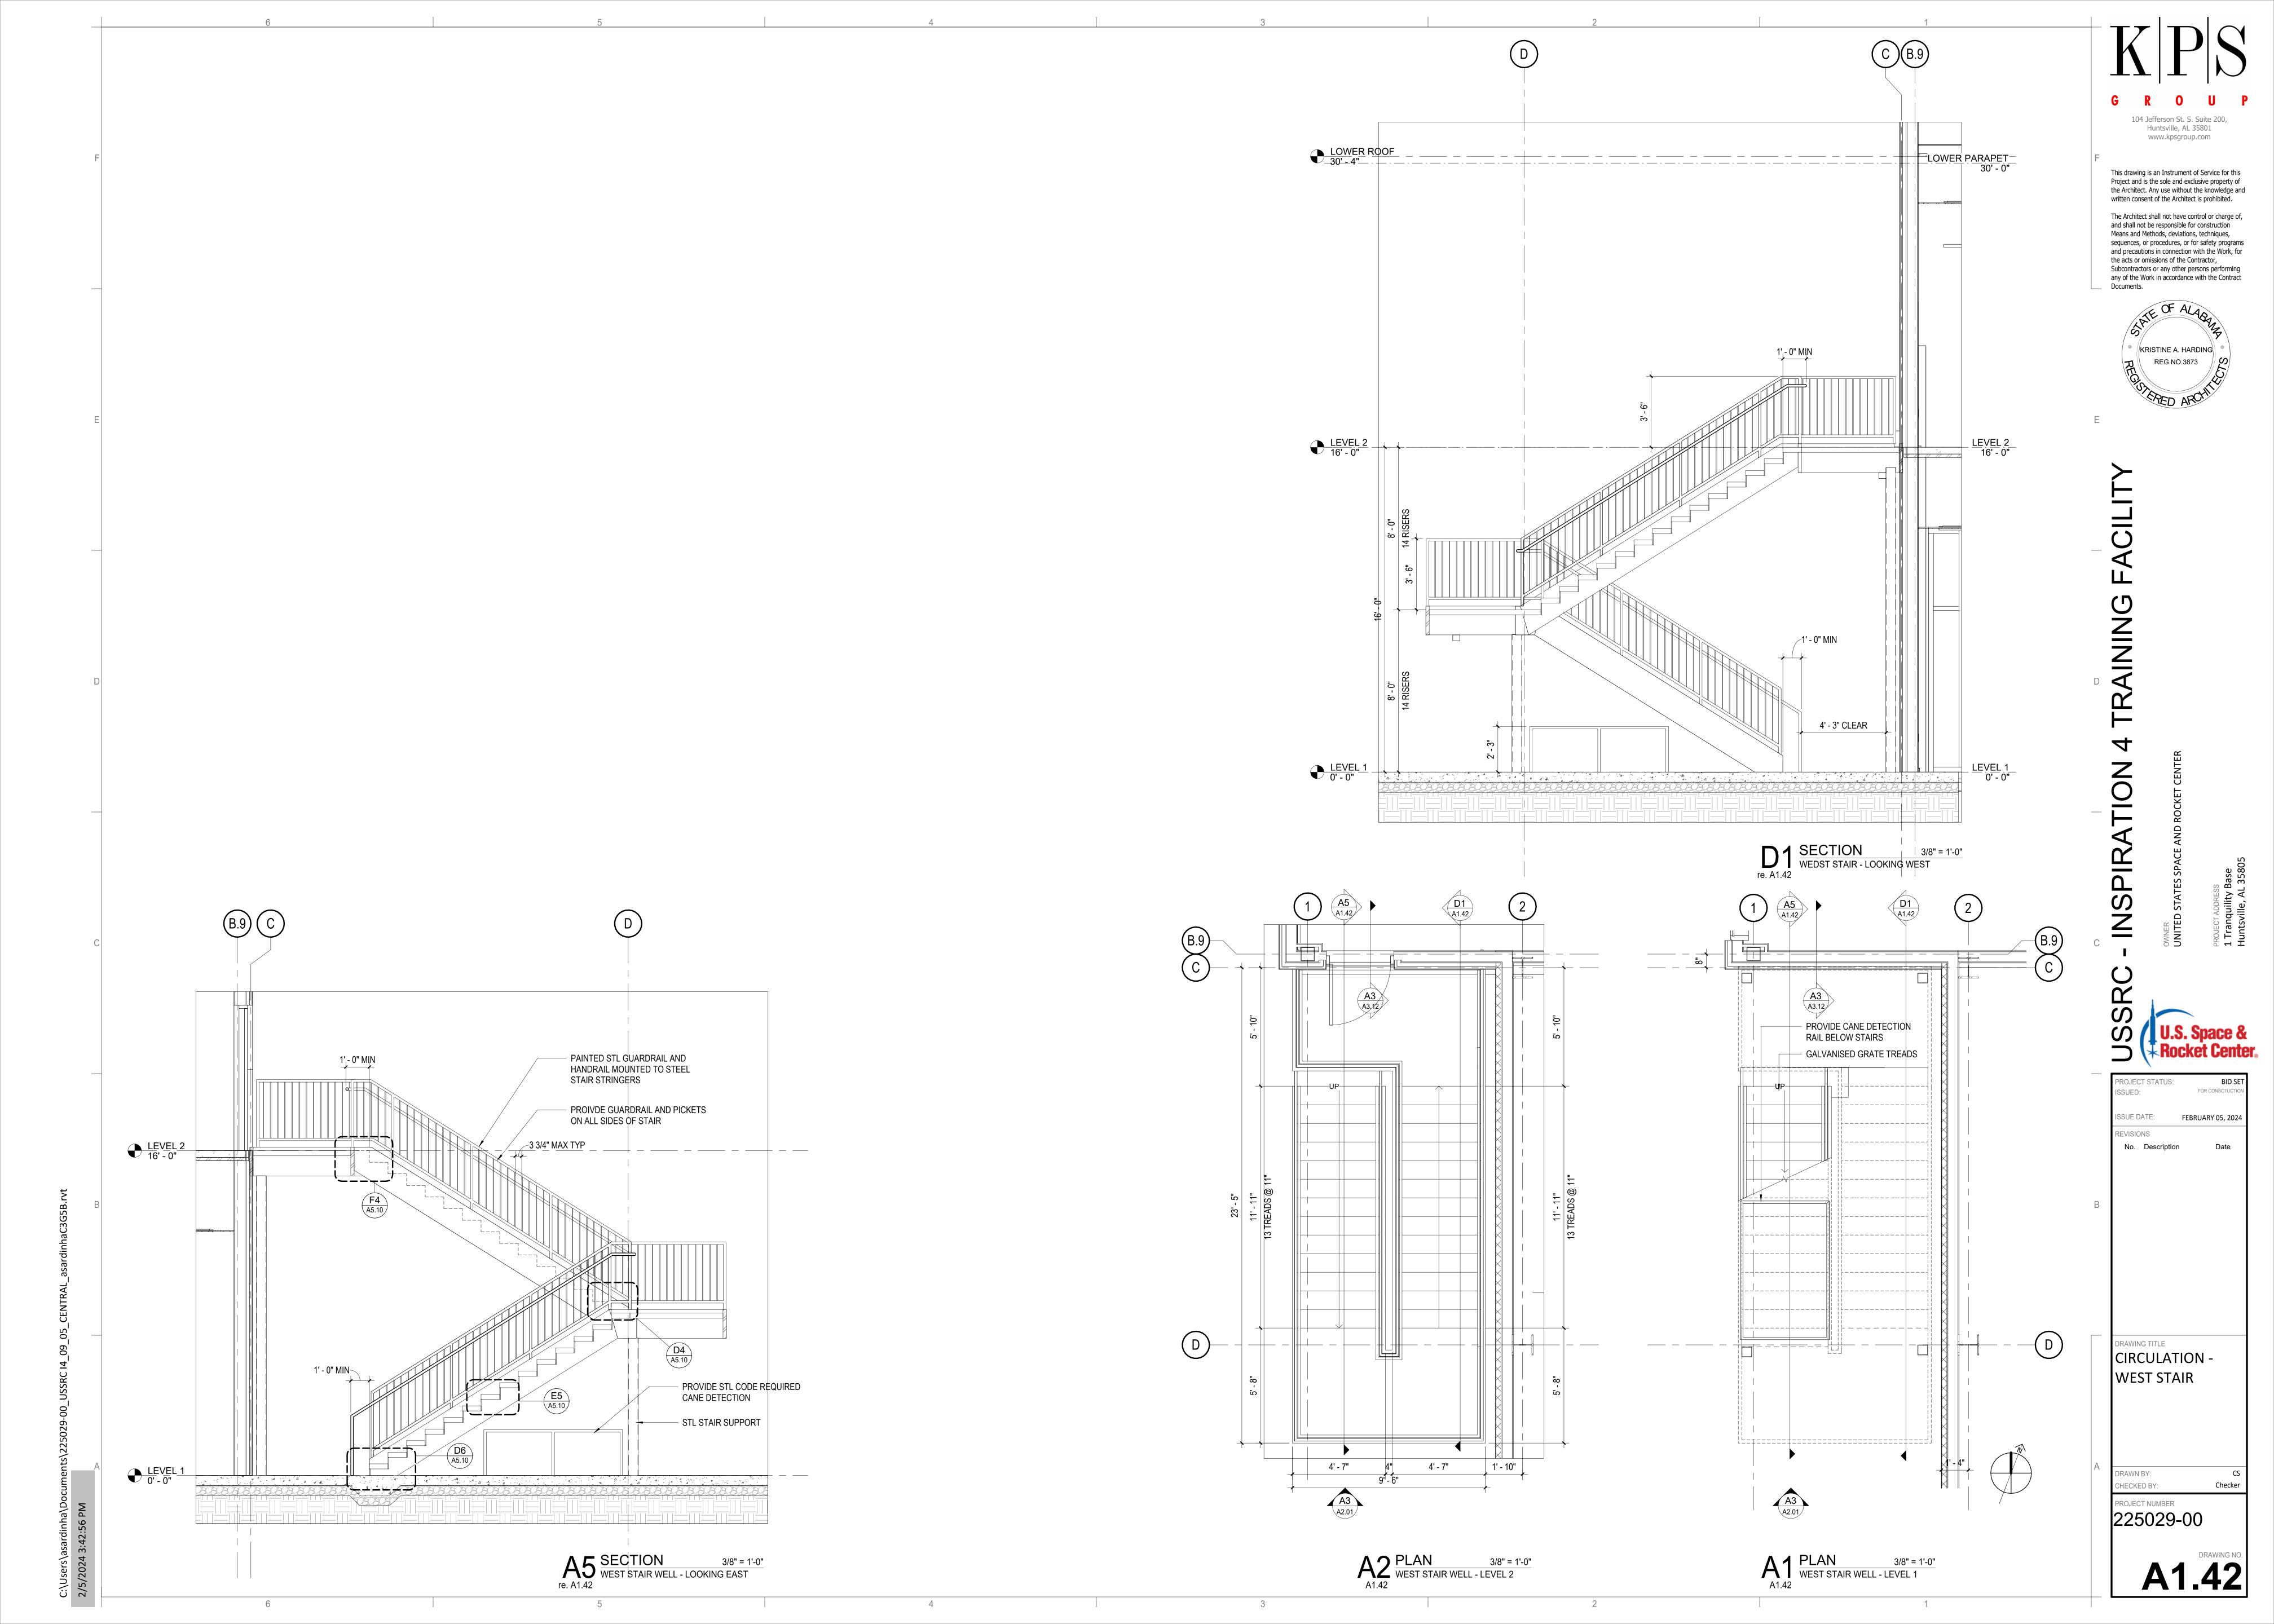

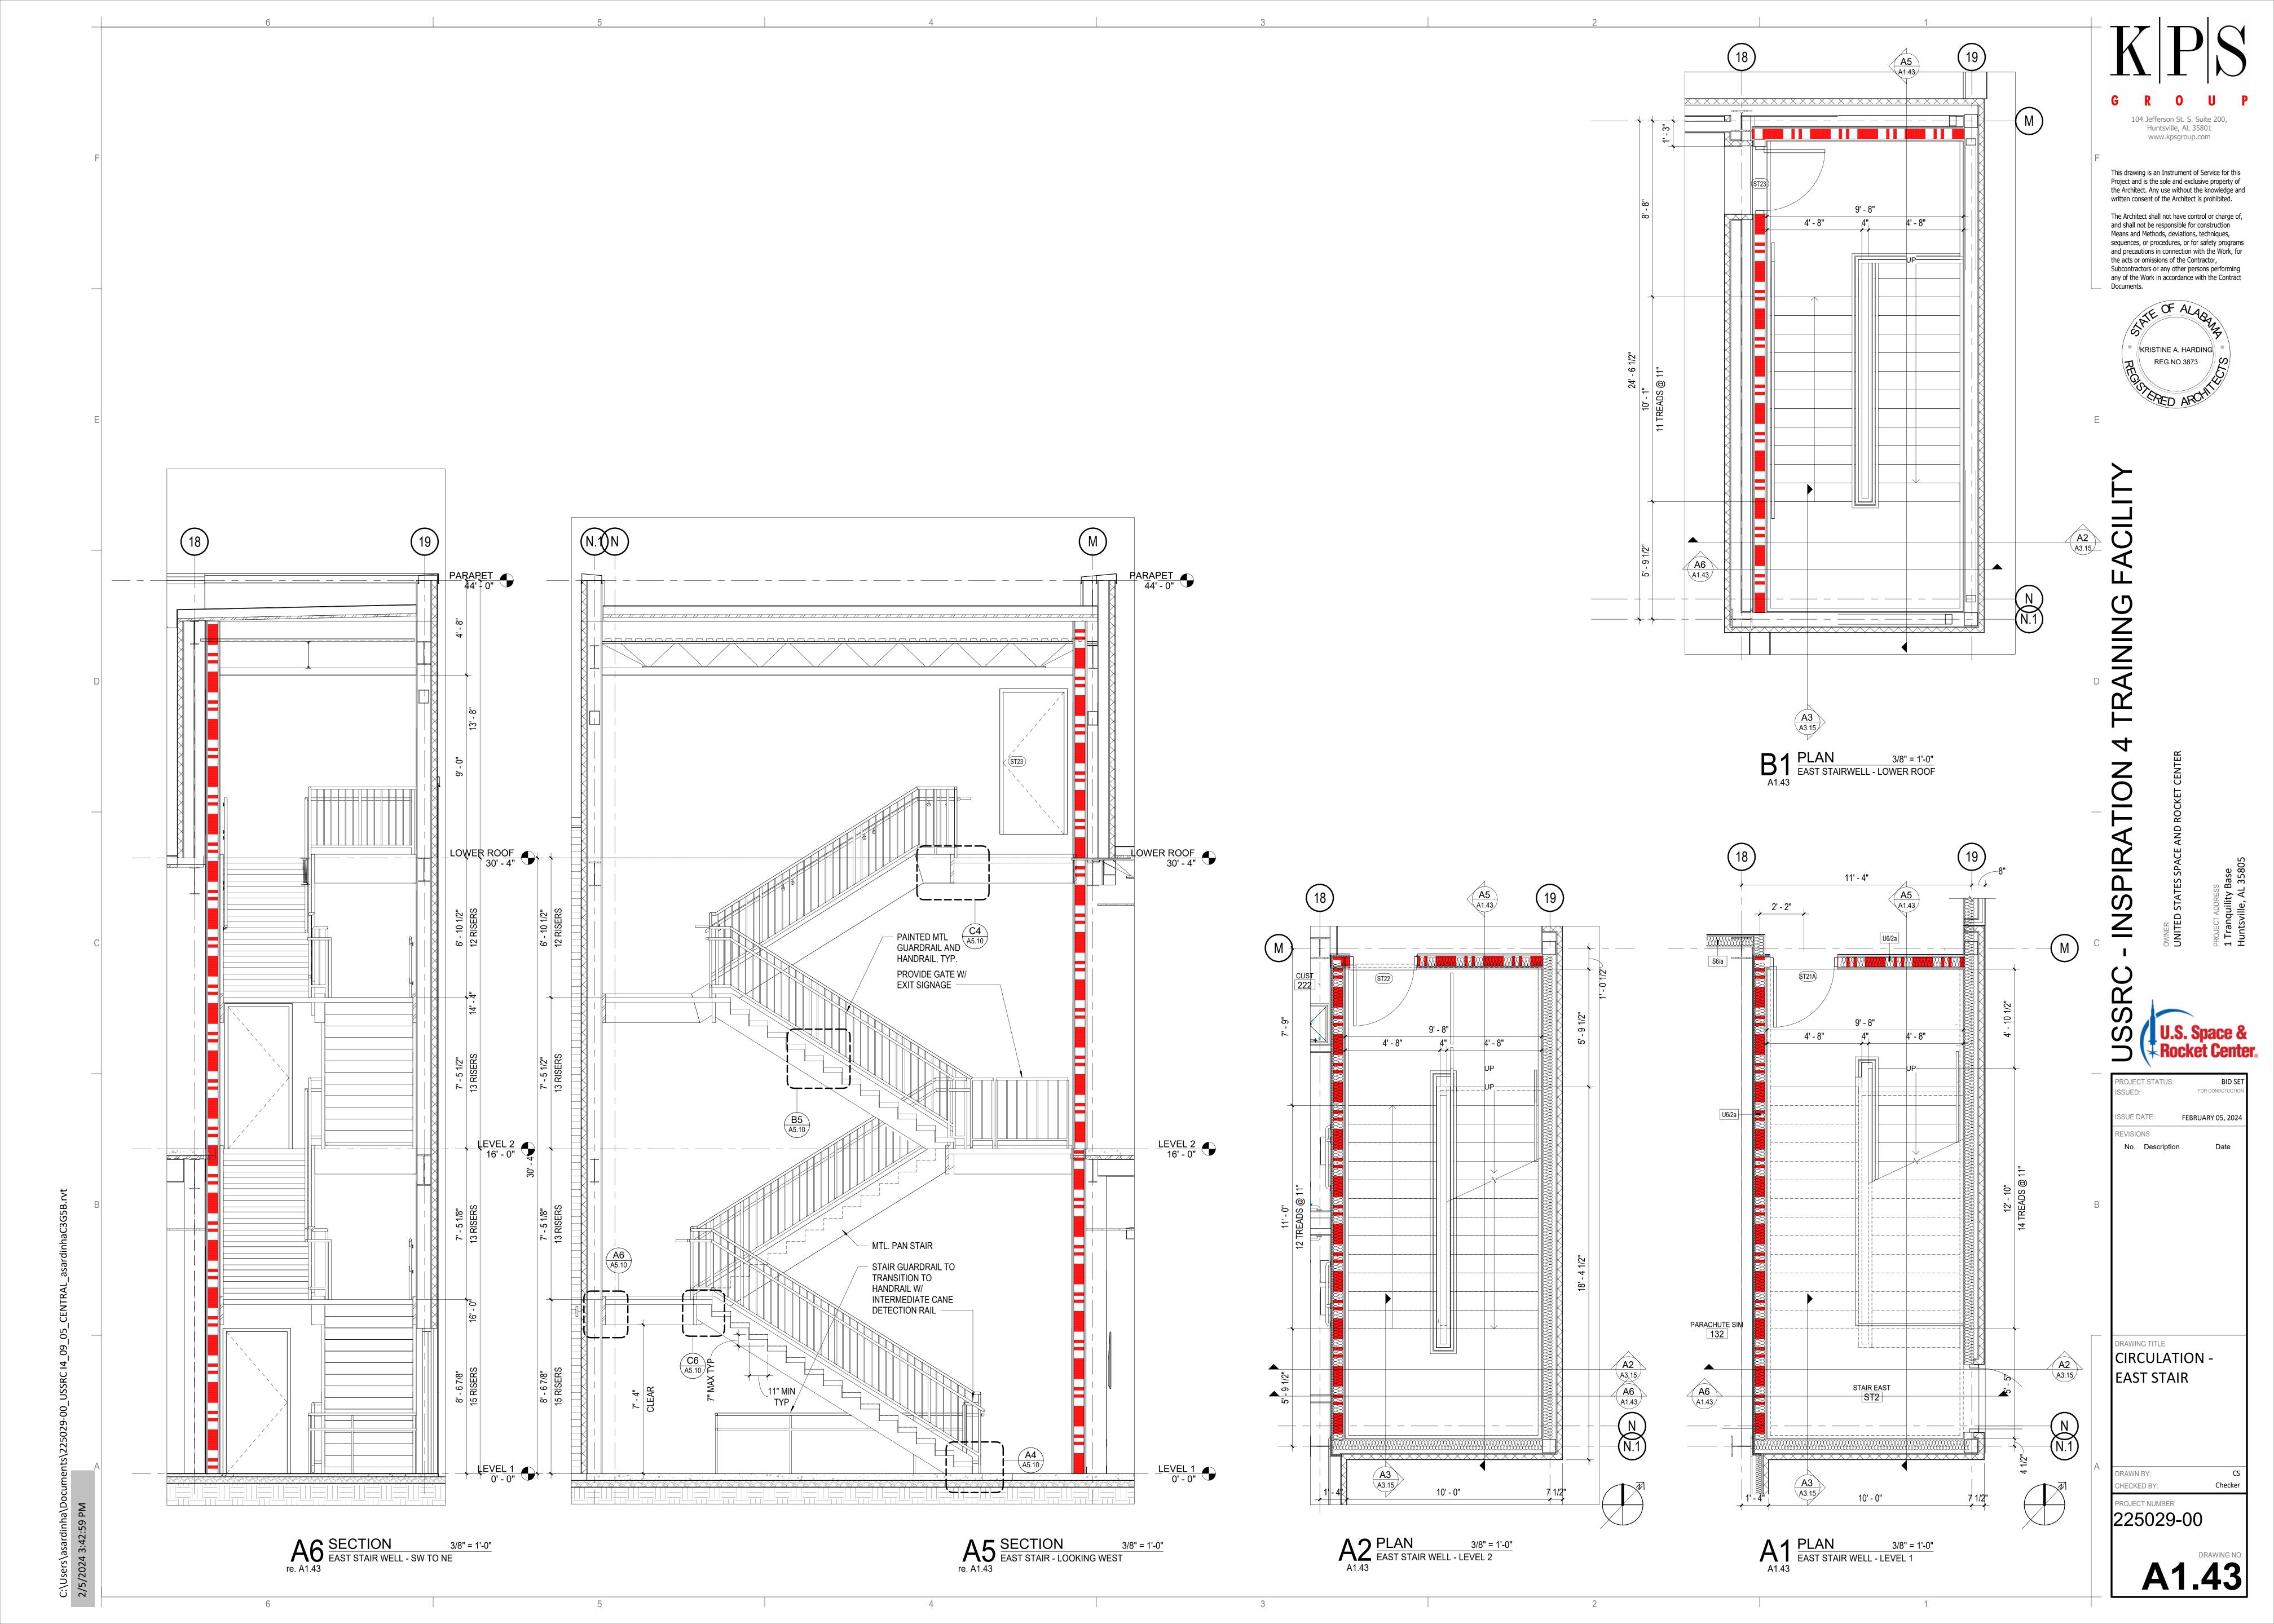

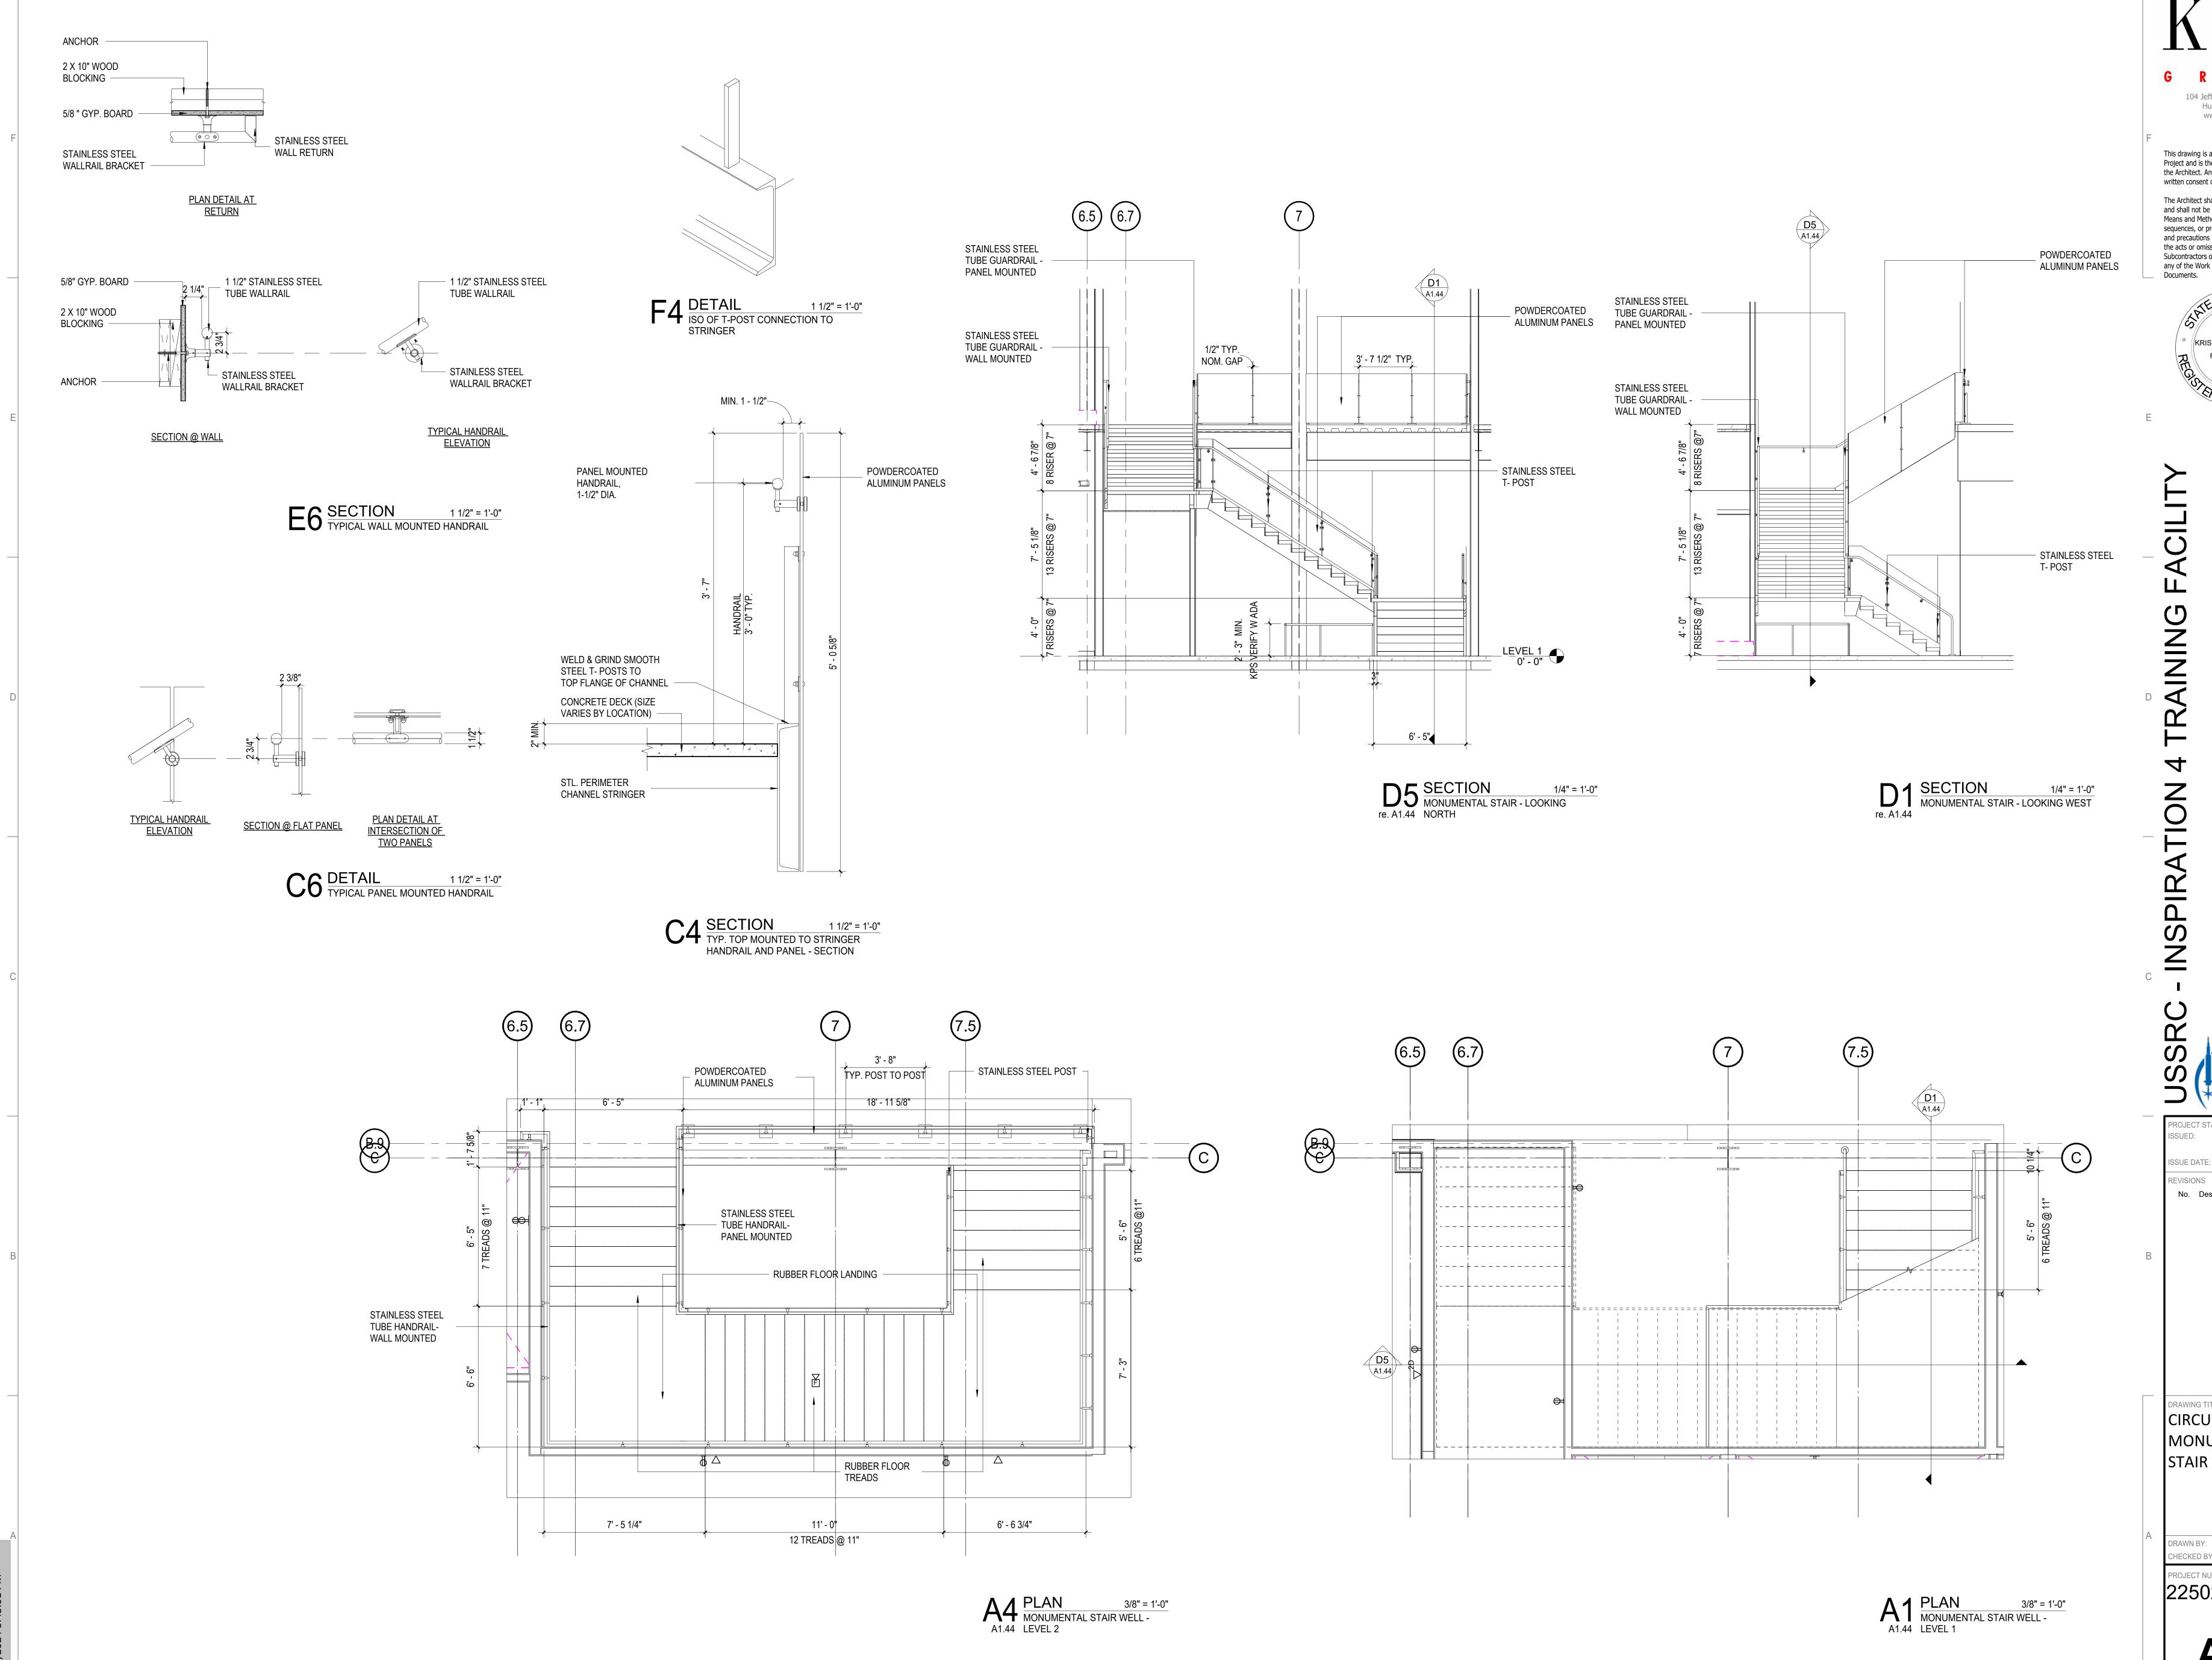

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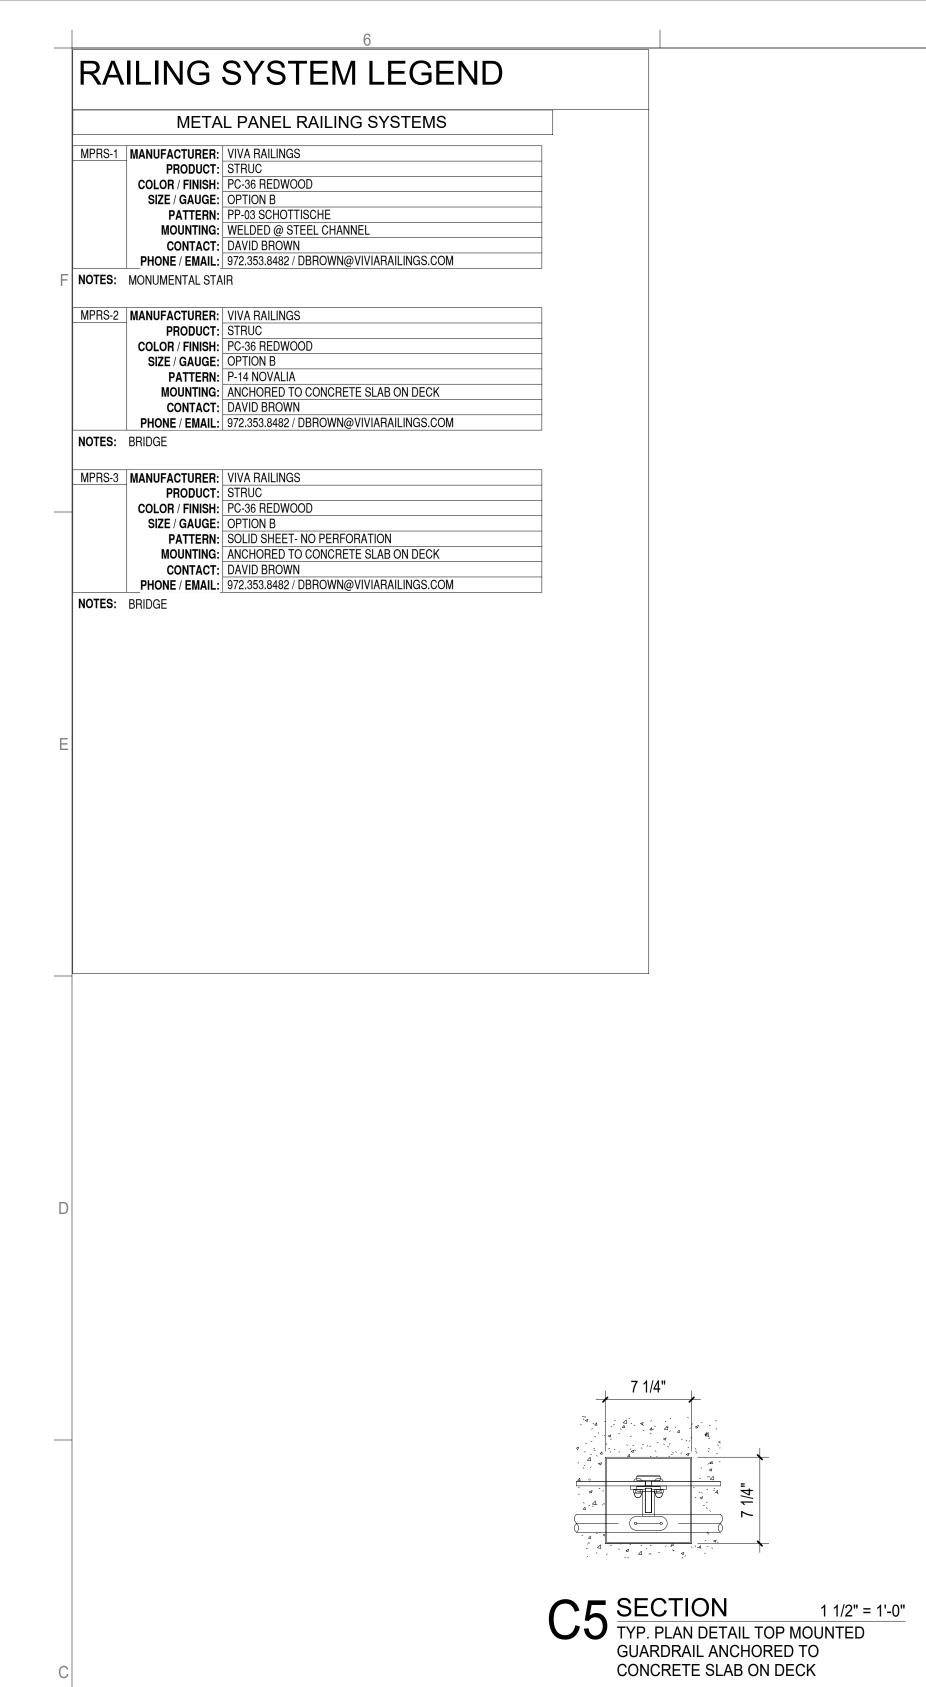



FOR CONSCTUCTION SSUE DATE: FEBRUARY 05, 2024 REVISIONS No. Description

CIRCULATION -MONUMENTAL


CHECKED BY:

PROJECT NUMBER 225029-00



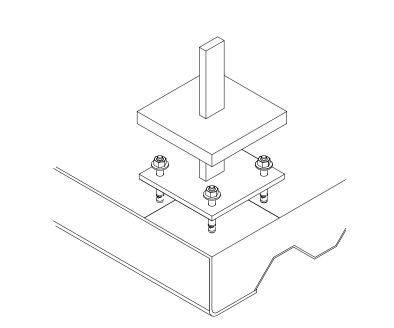

C4 SECTION 1 1/2" = 1'-0" ISO OF BASE AND POST CONNECTION TO CONCRETE DECK

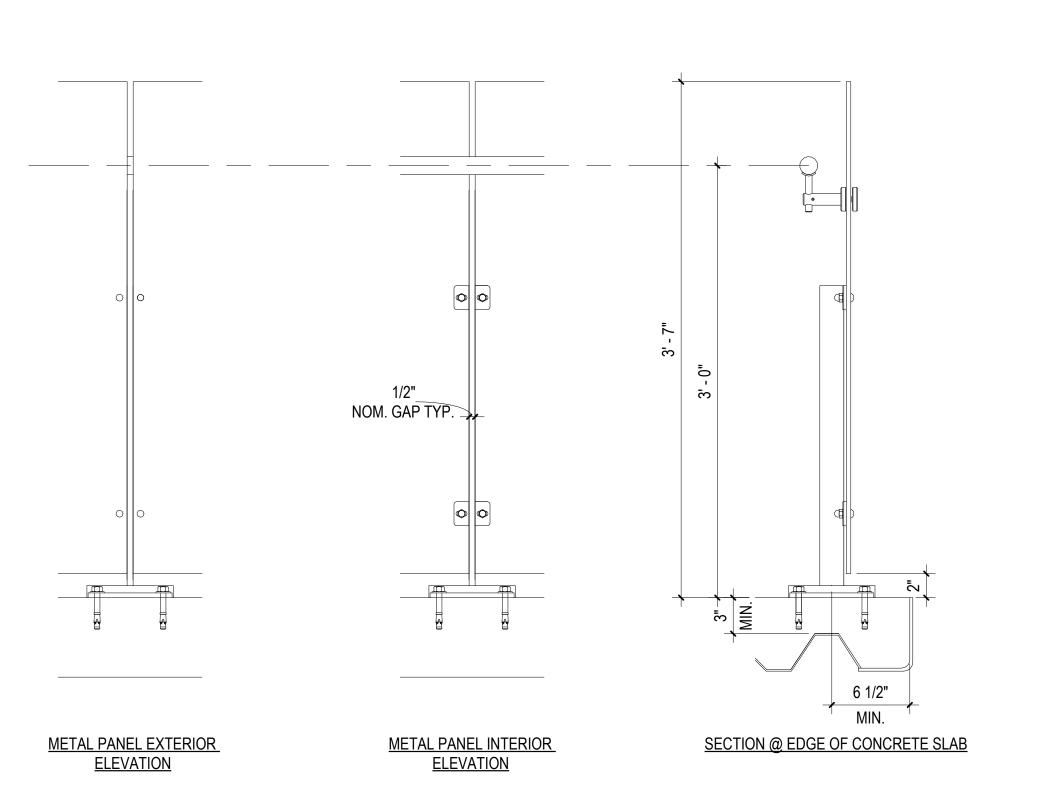

A4 DETAIL 1 1/2" = 1
TYP. TOP MOUNTED GUARDRAIL
ANCHORED TO CONCRETE SLAB ON
DECK

SHEET NOTES:

1. COORDINATE ACCEPTABLE ALTERNATE FOR SF-1 WITH ARCHITECT. SUBSTITUTION MAY REQUIRE ADDITIONAL CHANGES TO OTHER DISCIPLINES. 2. COORDINATE ANY CUT OPENINGS WITH ARCHITECT AND OTHER DISCLIPINES.



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FACILIT


SSUE DATE: FEBRUARY 05, 2024 REVISIONS No. Description


CIRCULATION-LEVEL 2 - LOBBY & BRIDGE


HECKED BY:


1/8" = 1'-0"


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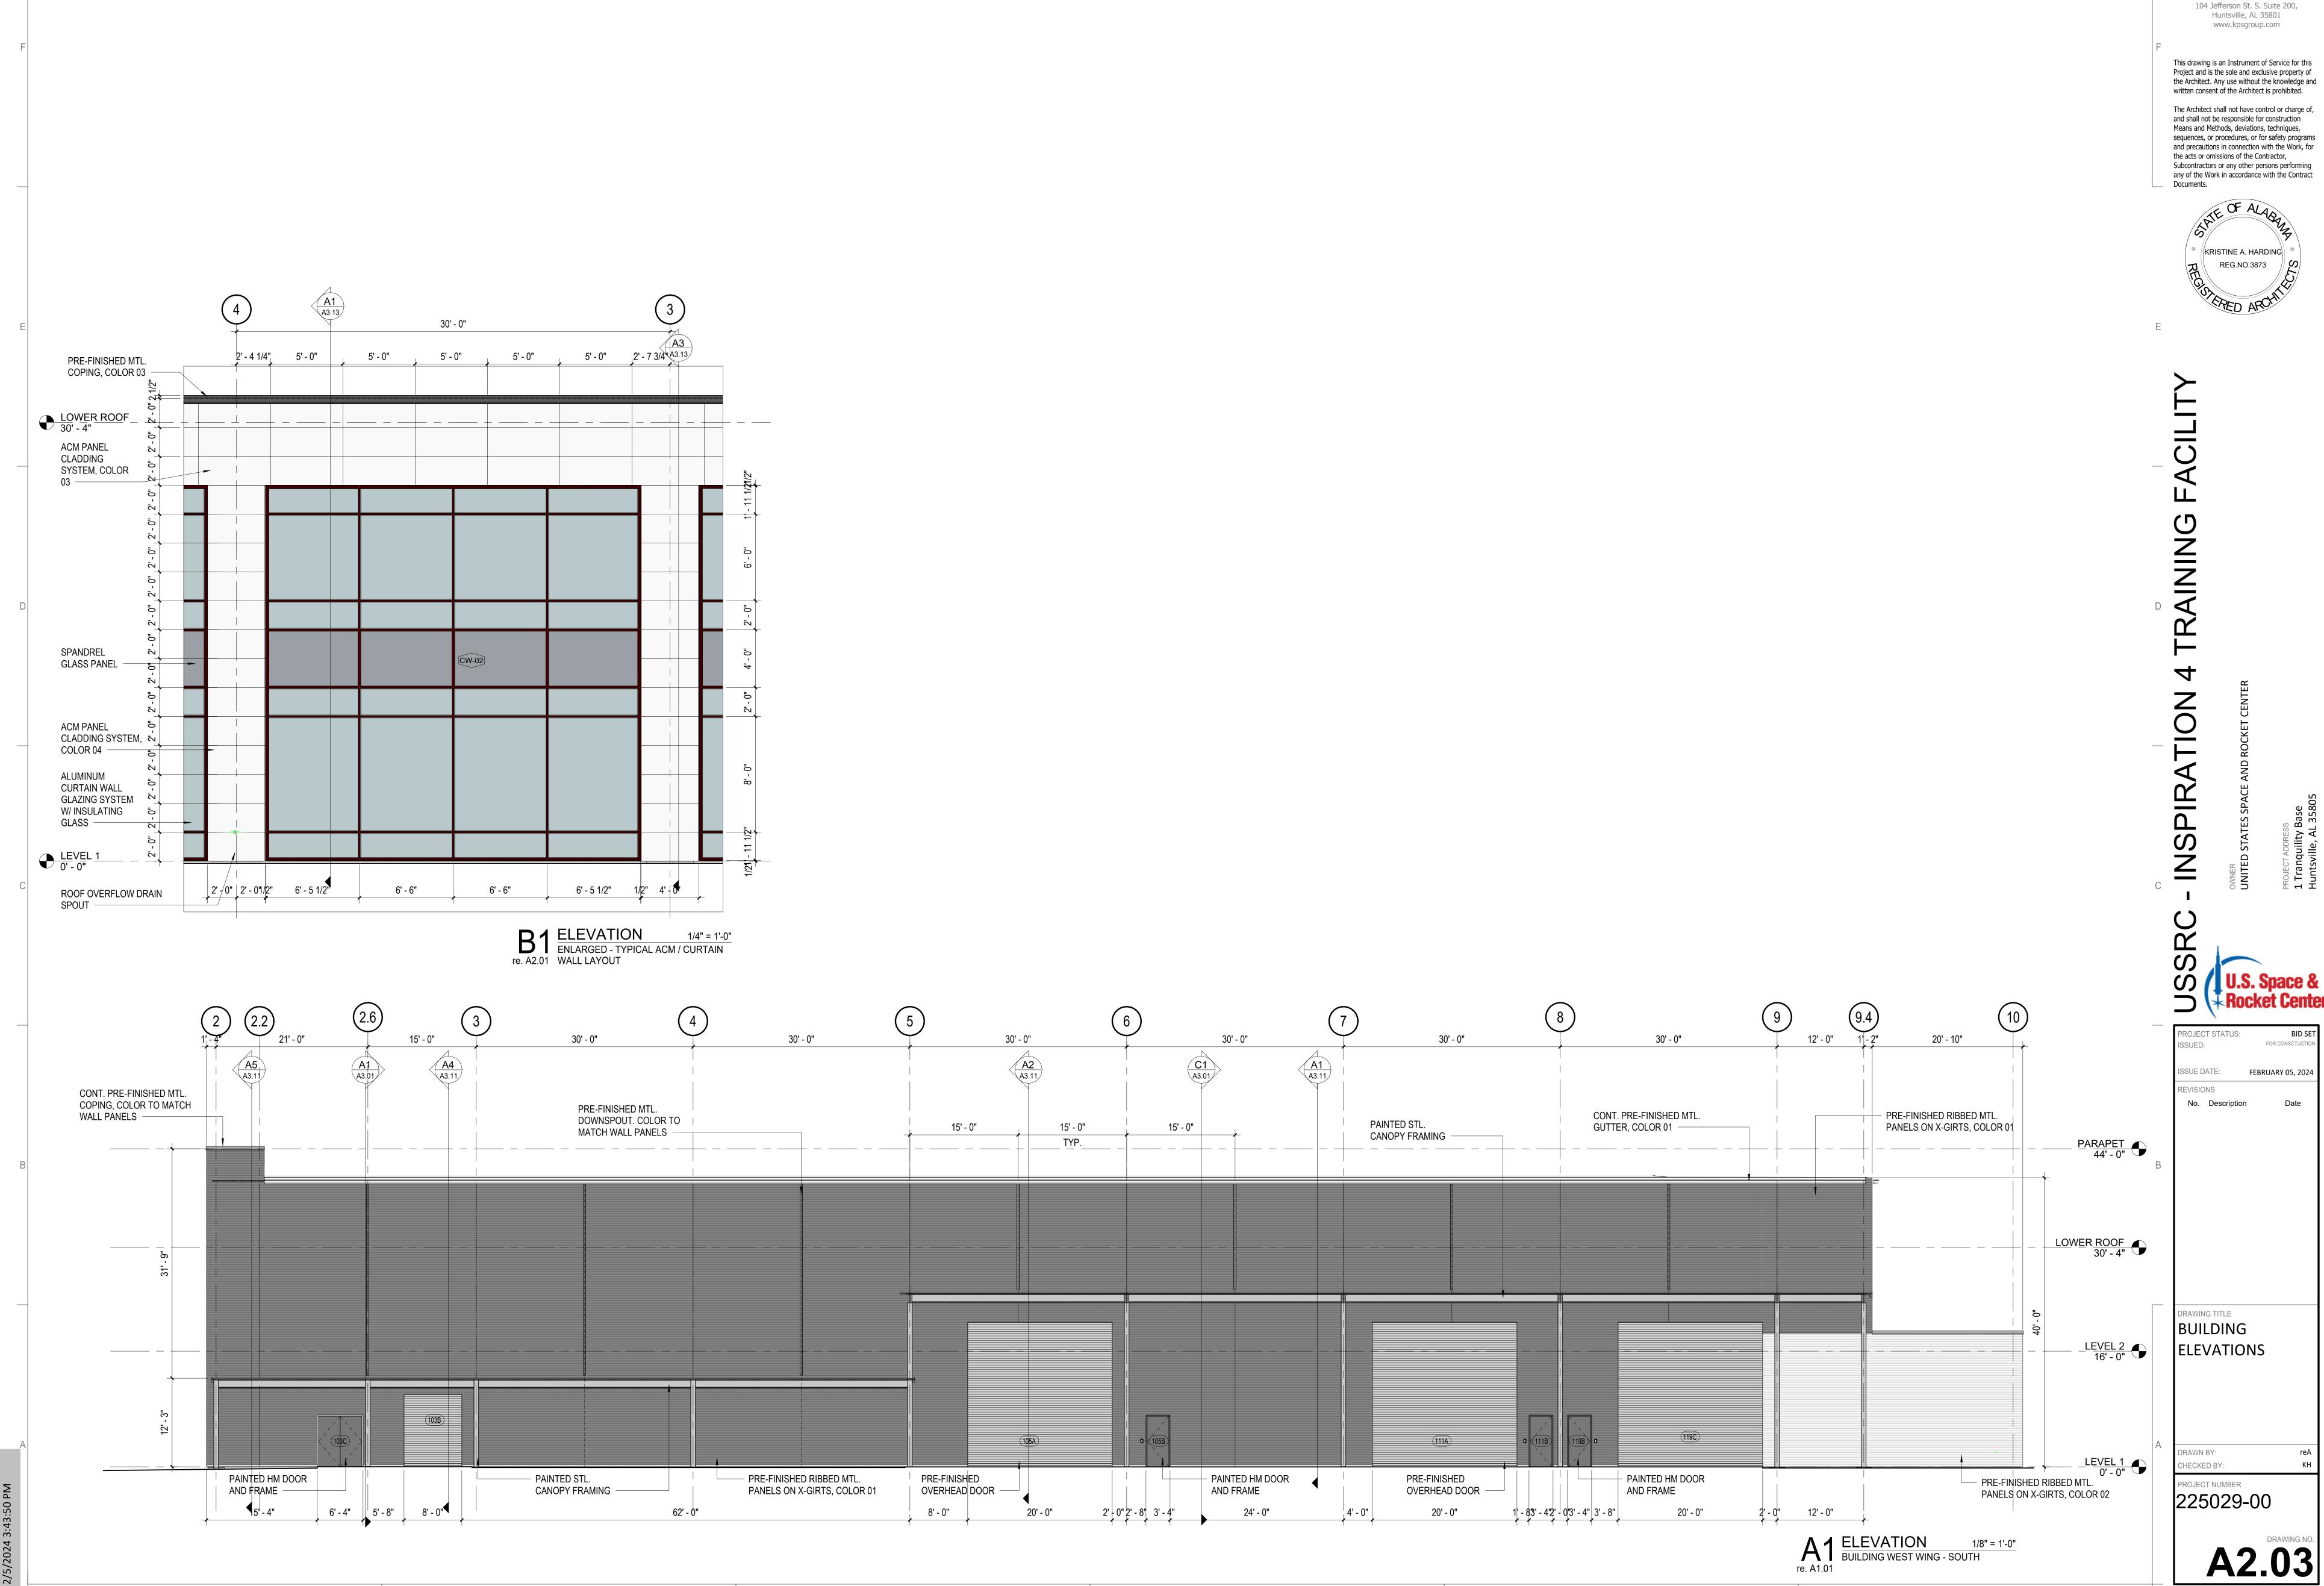


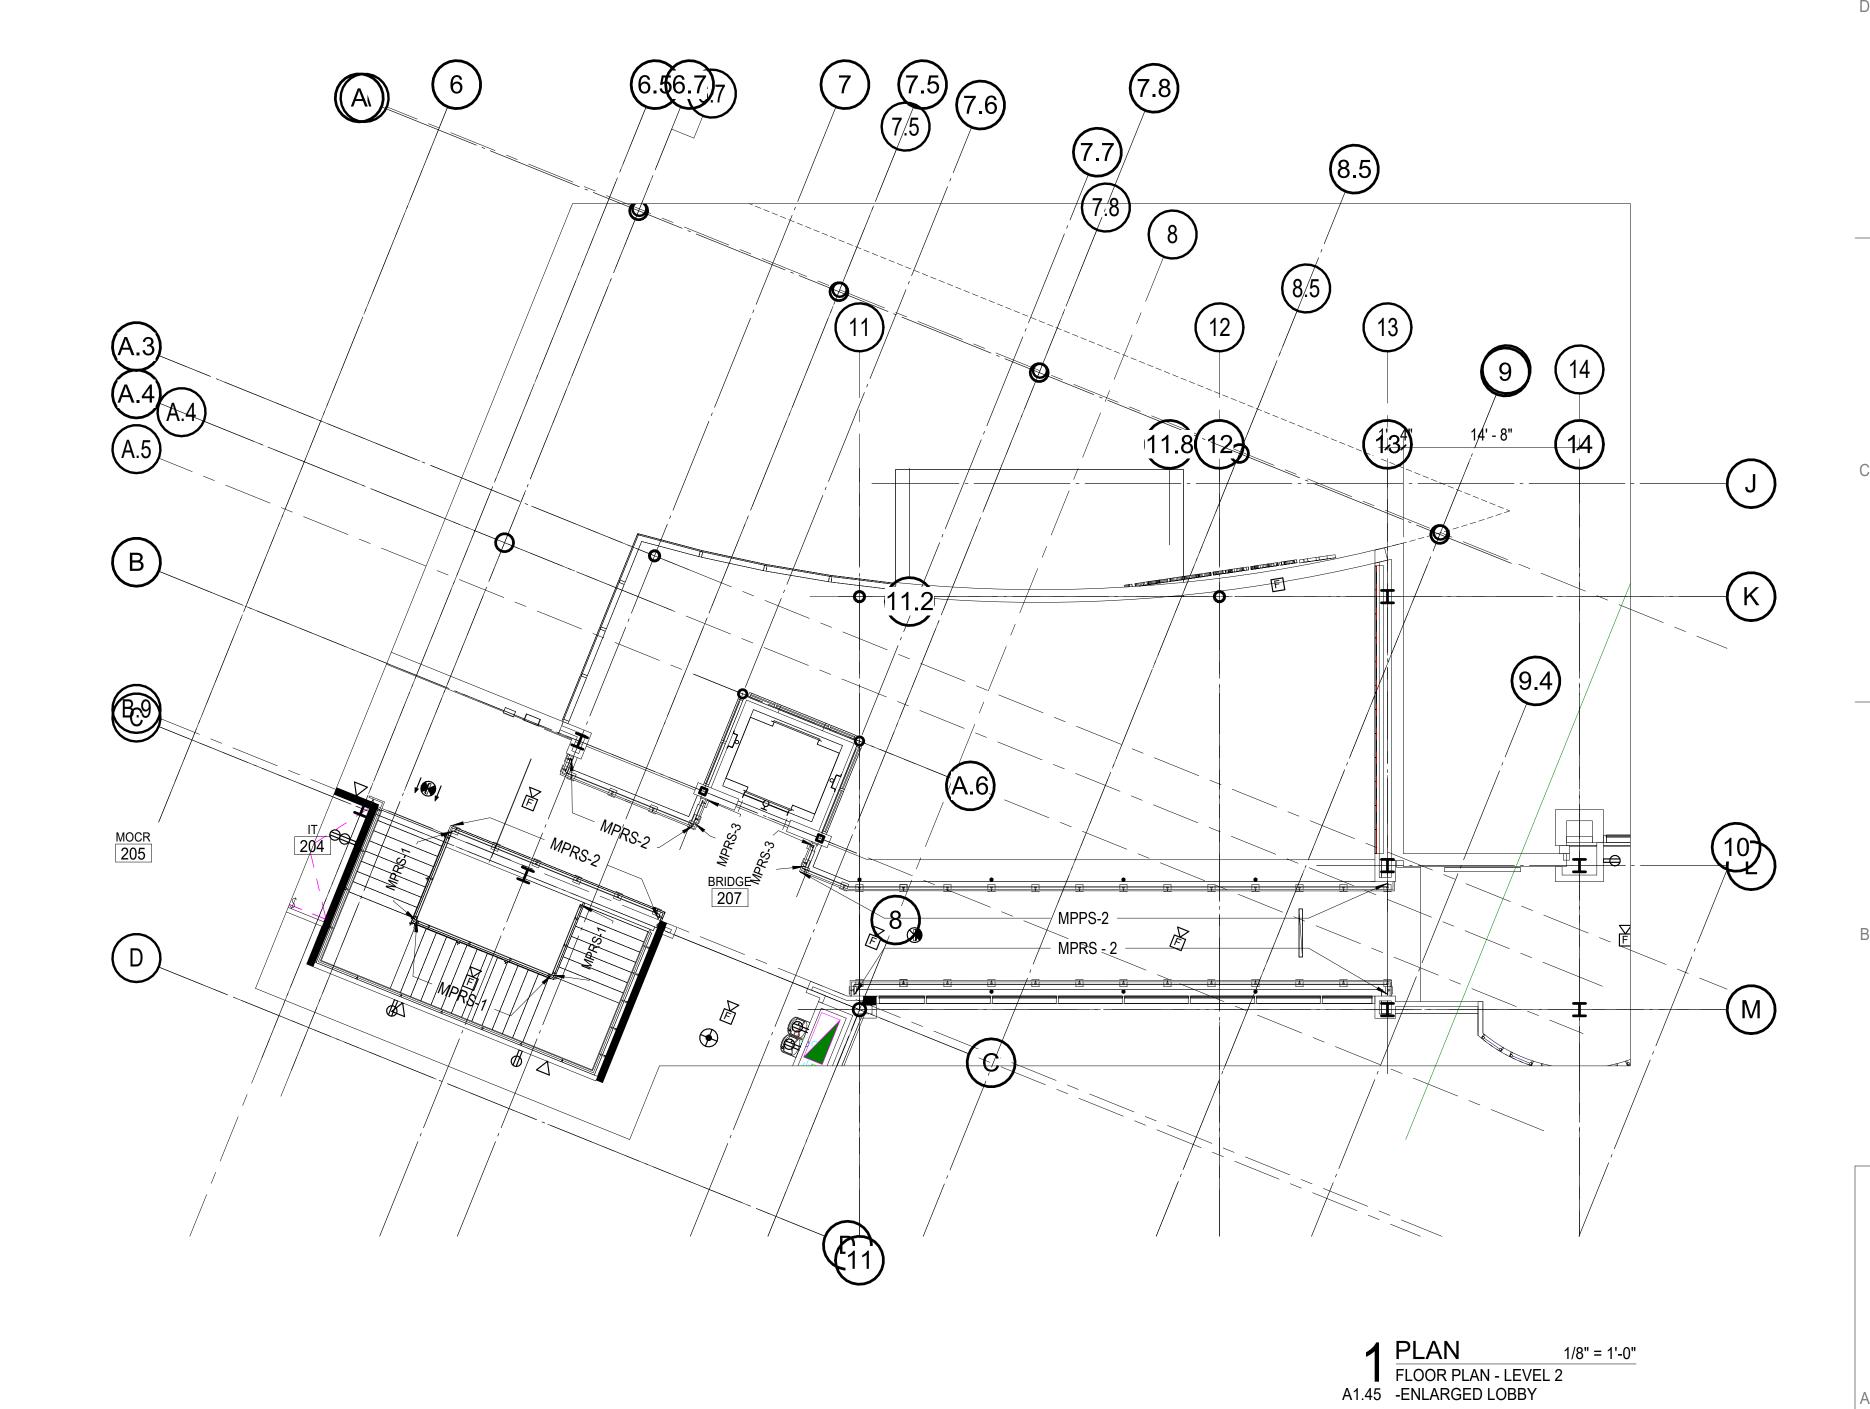

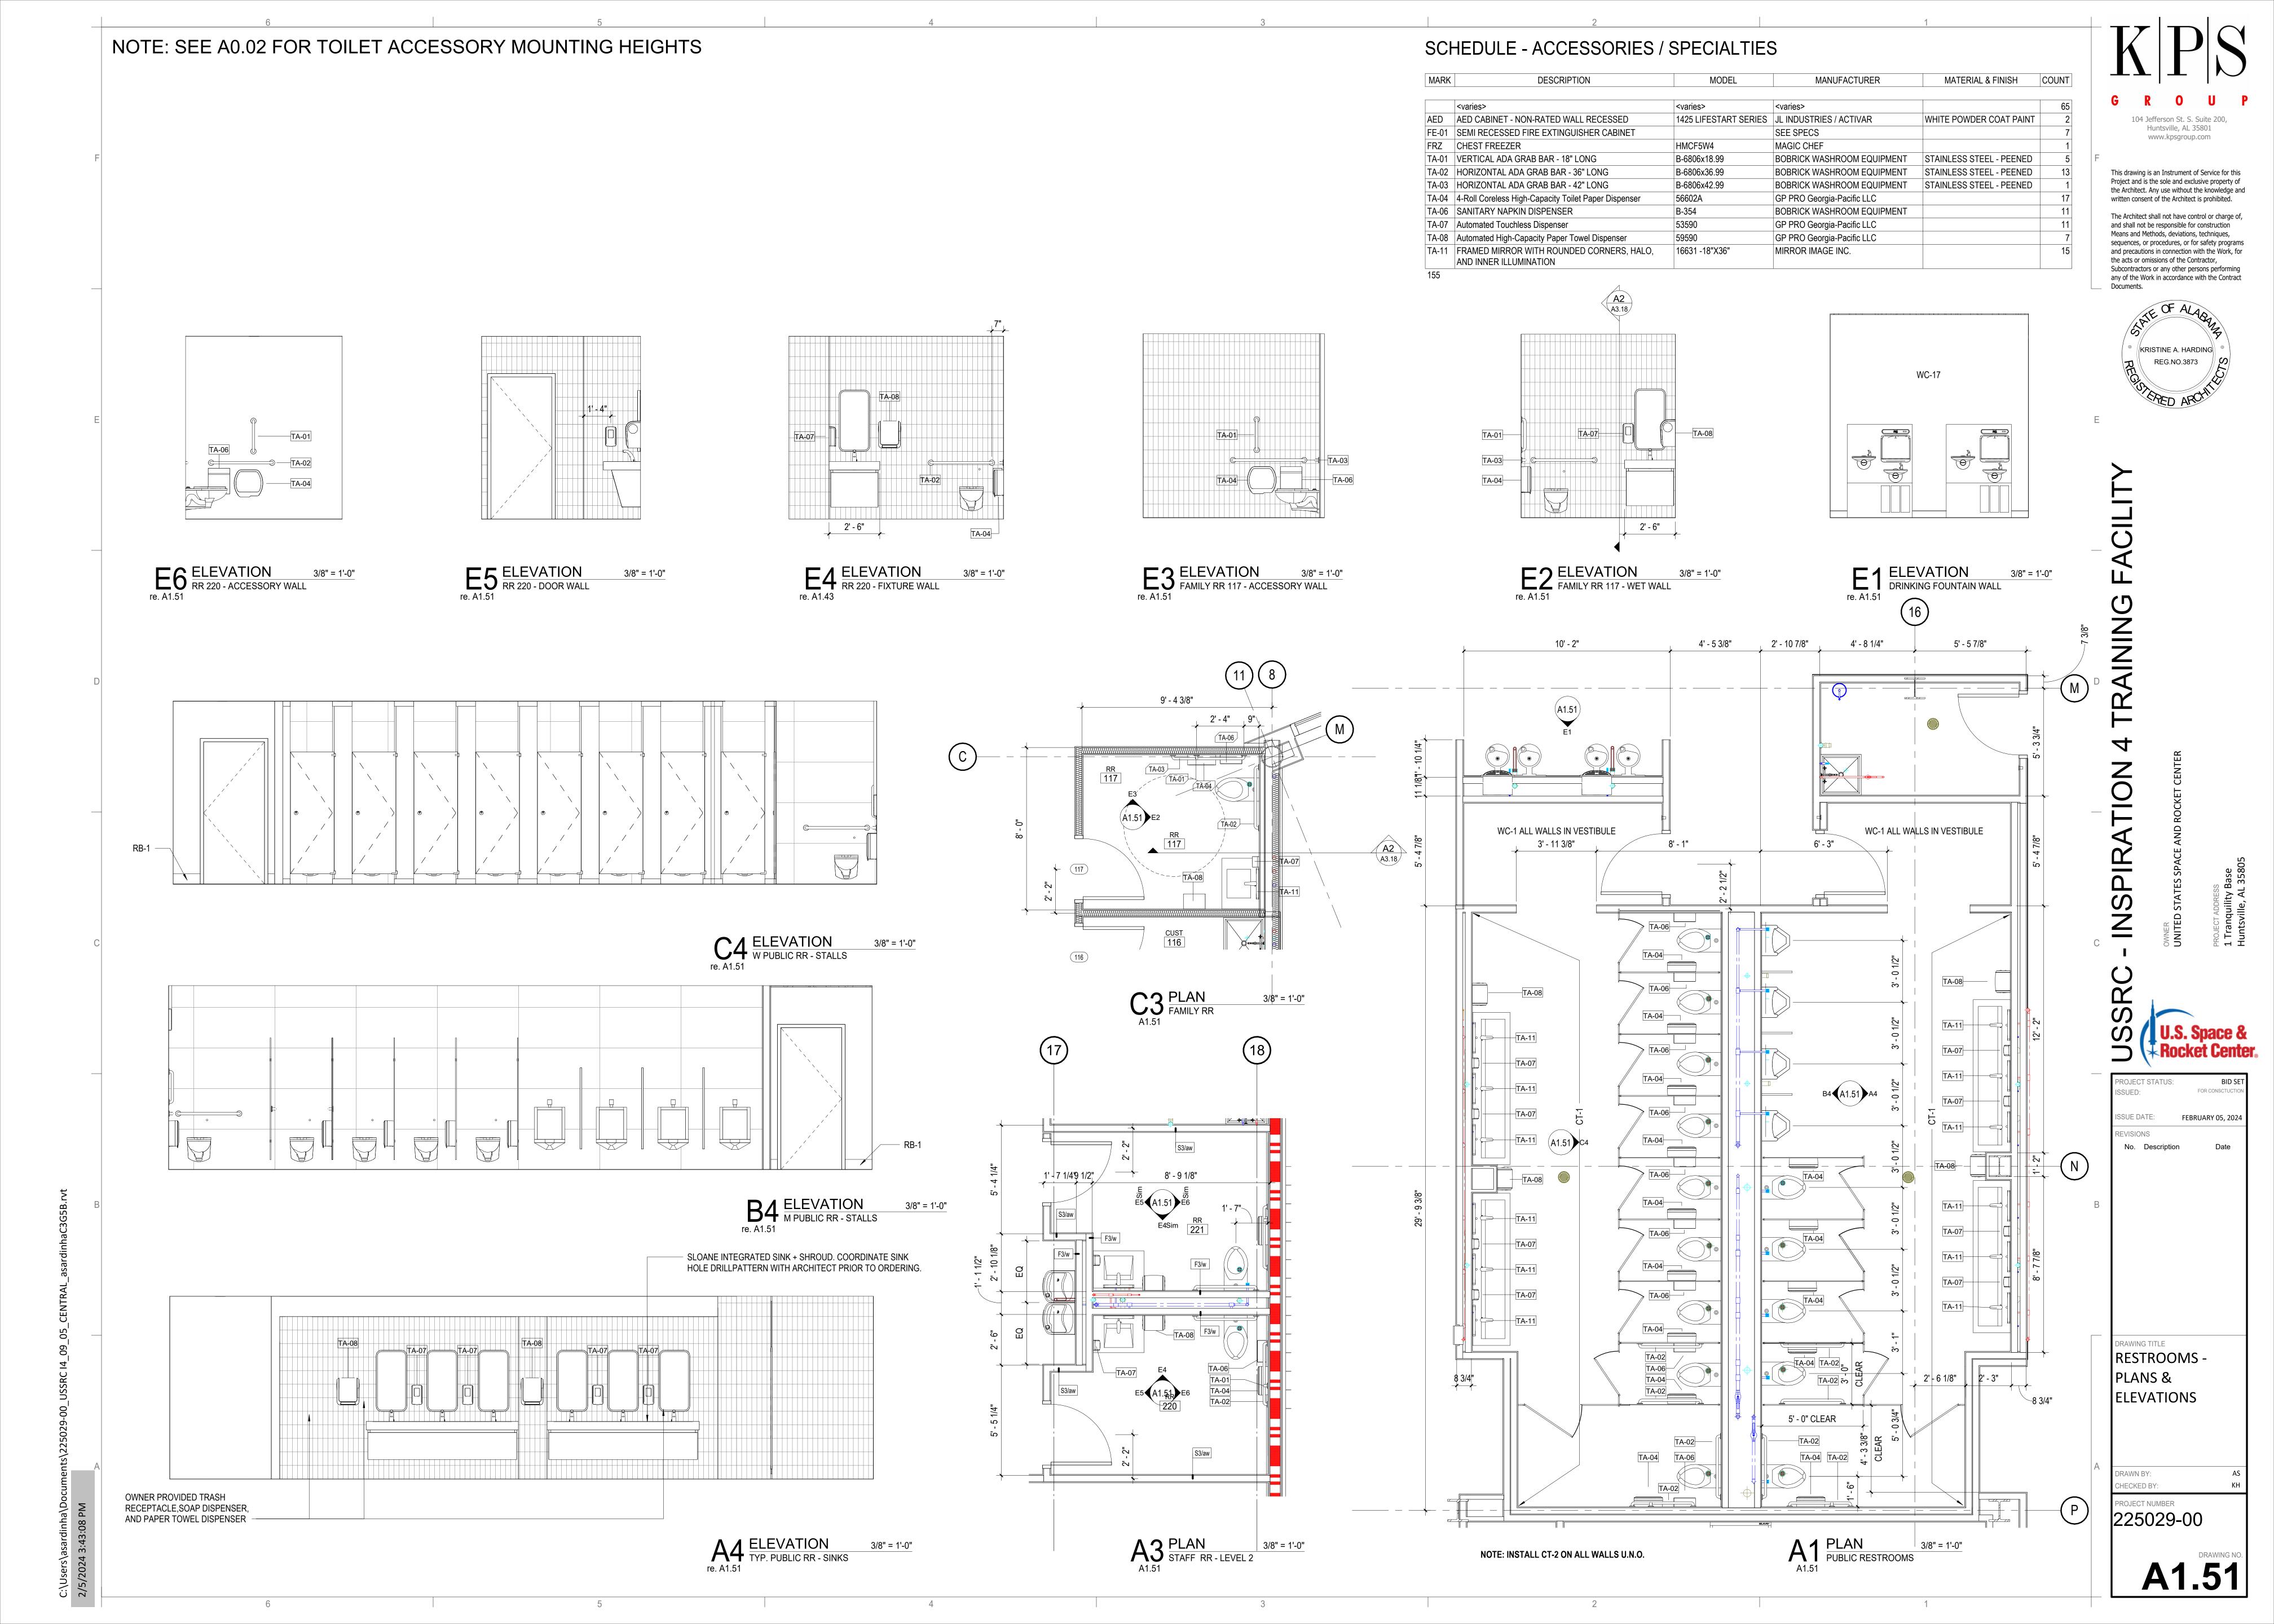

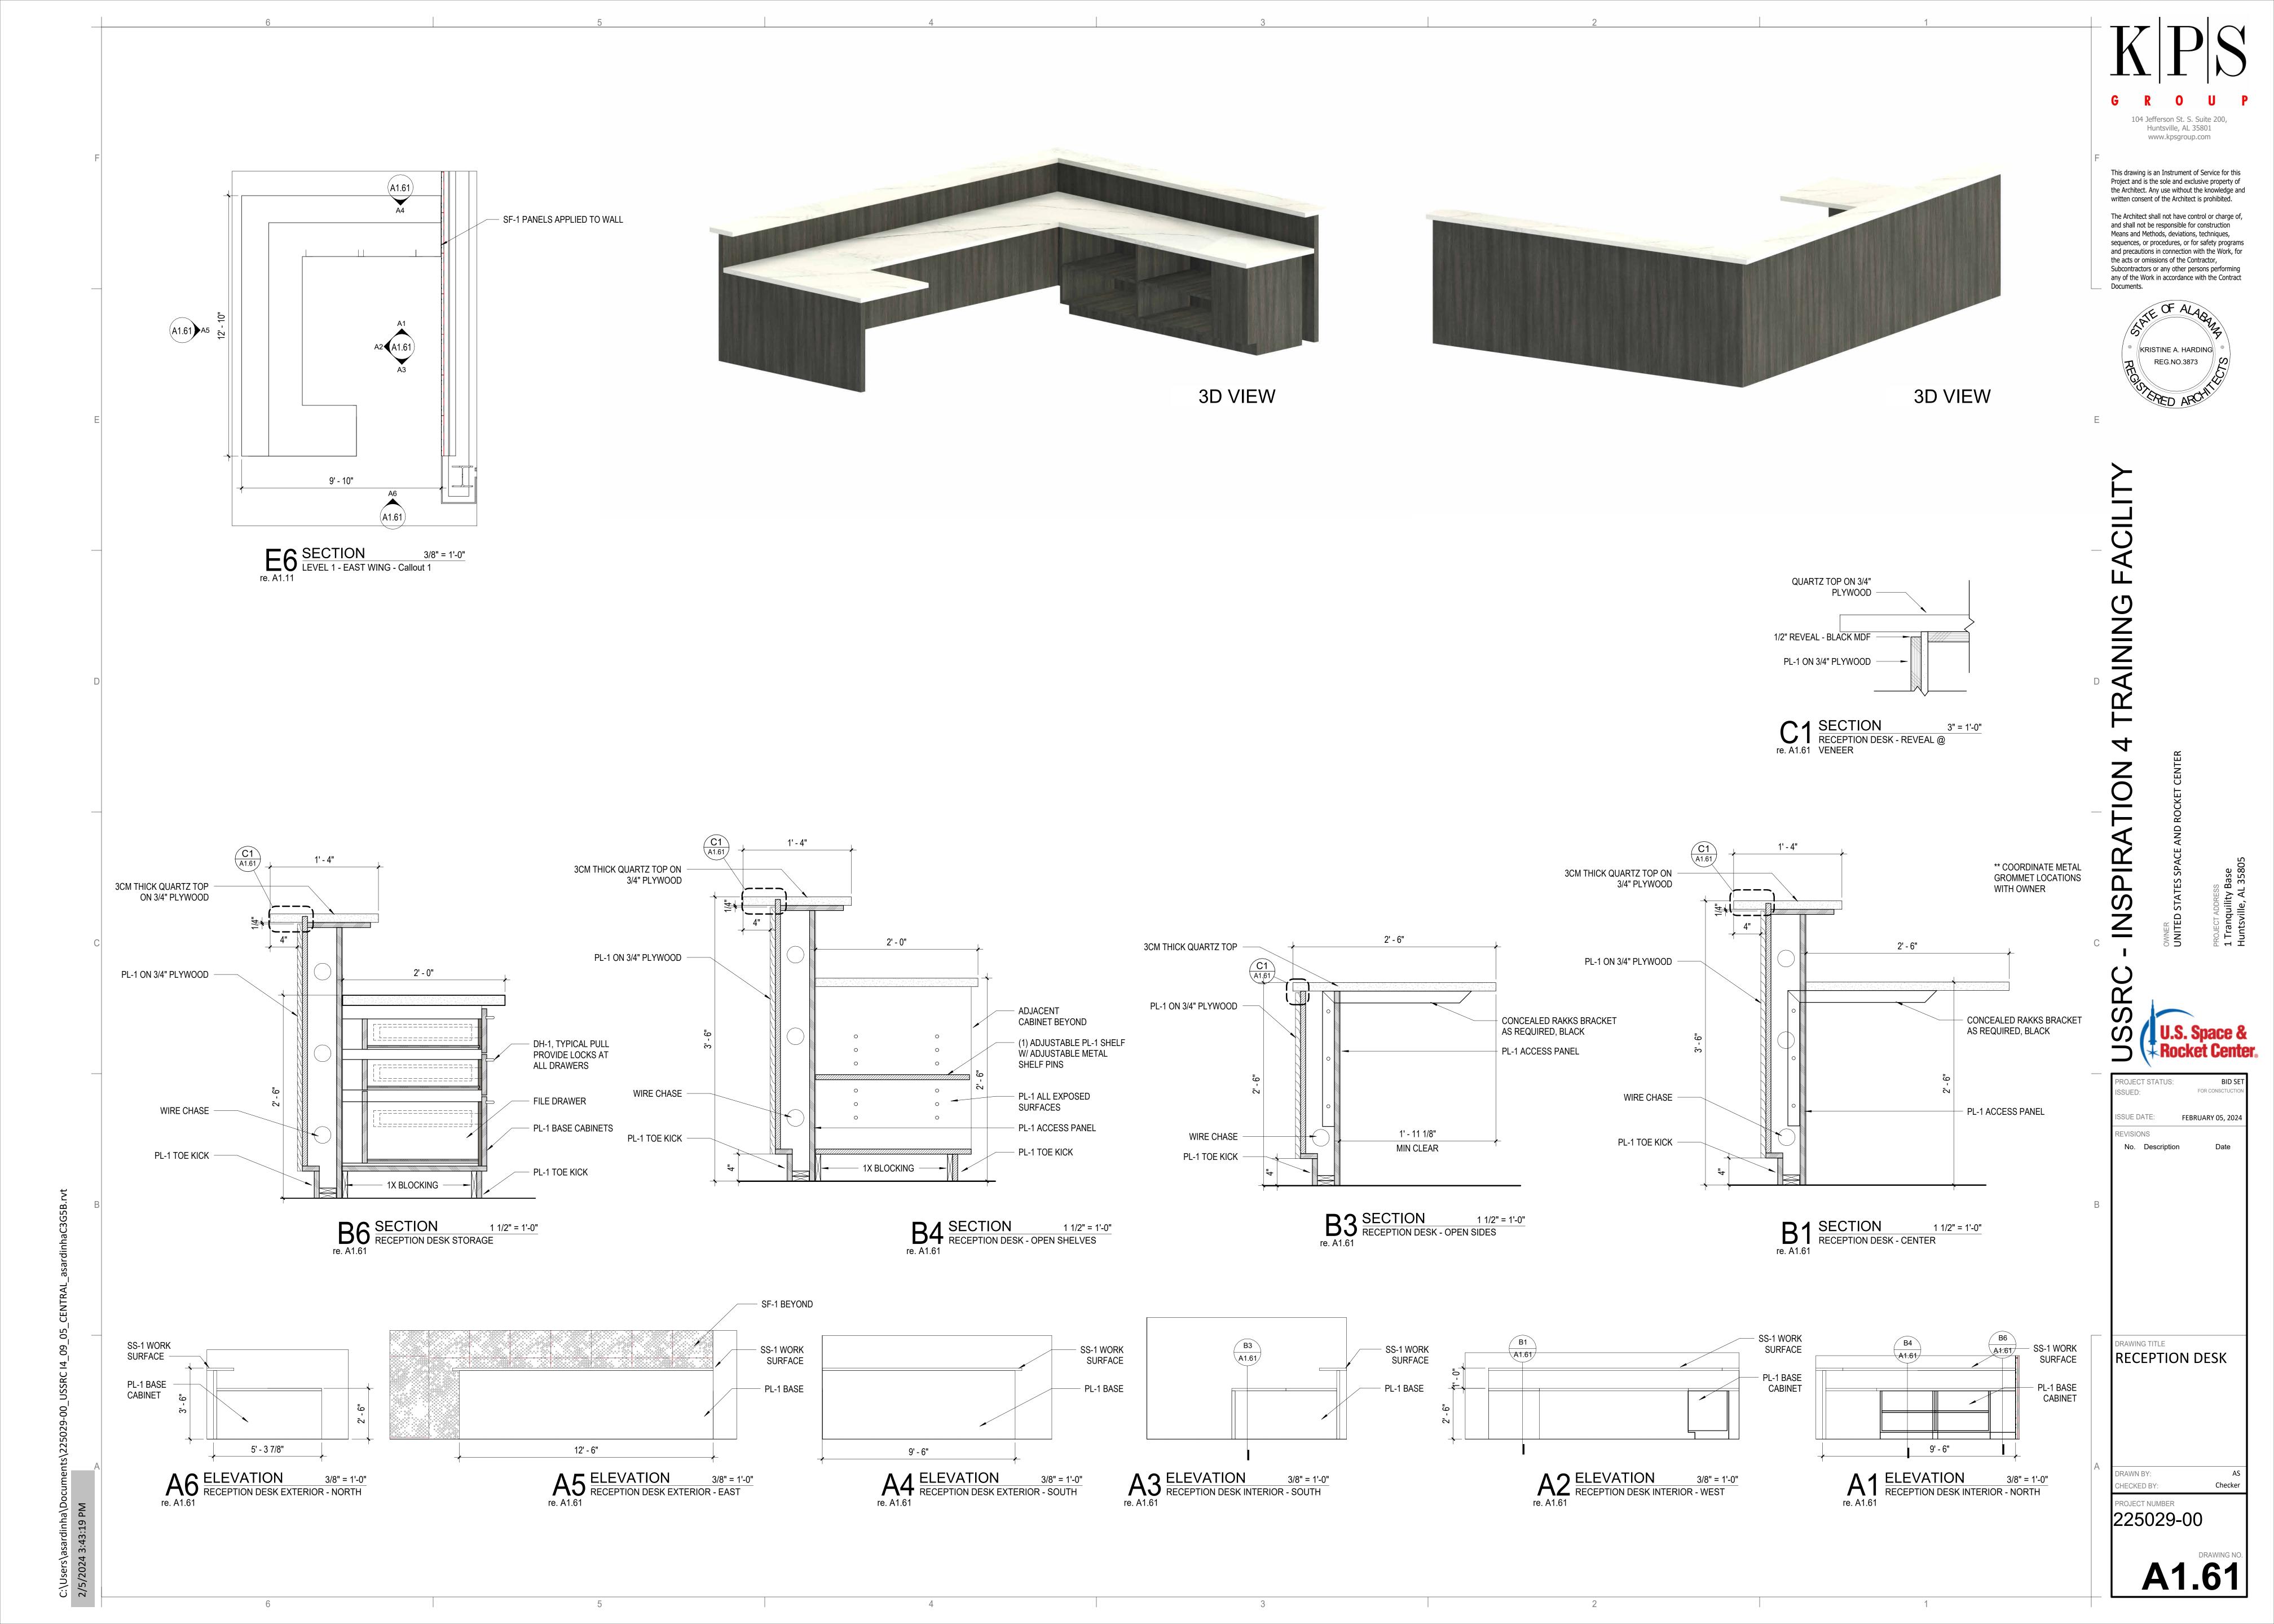

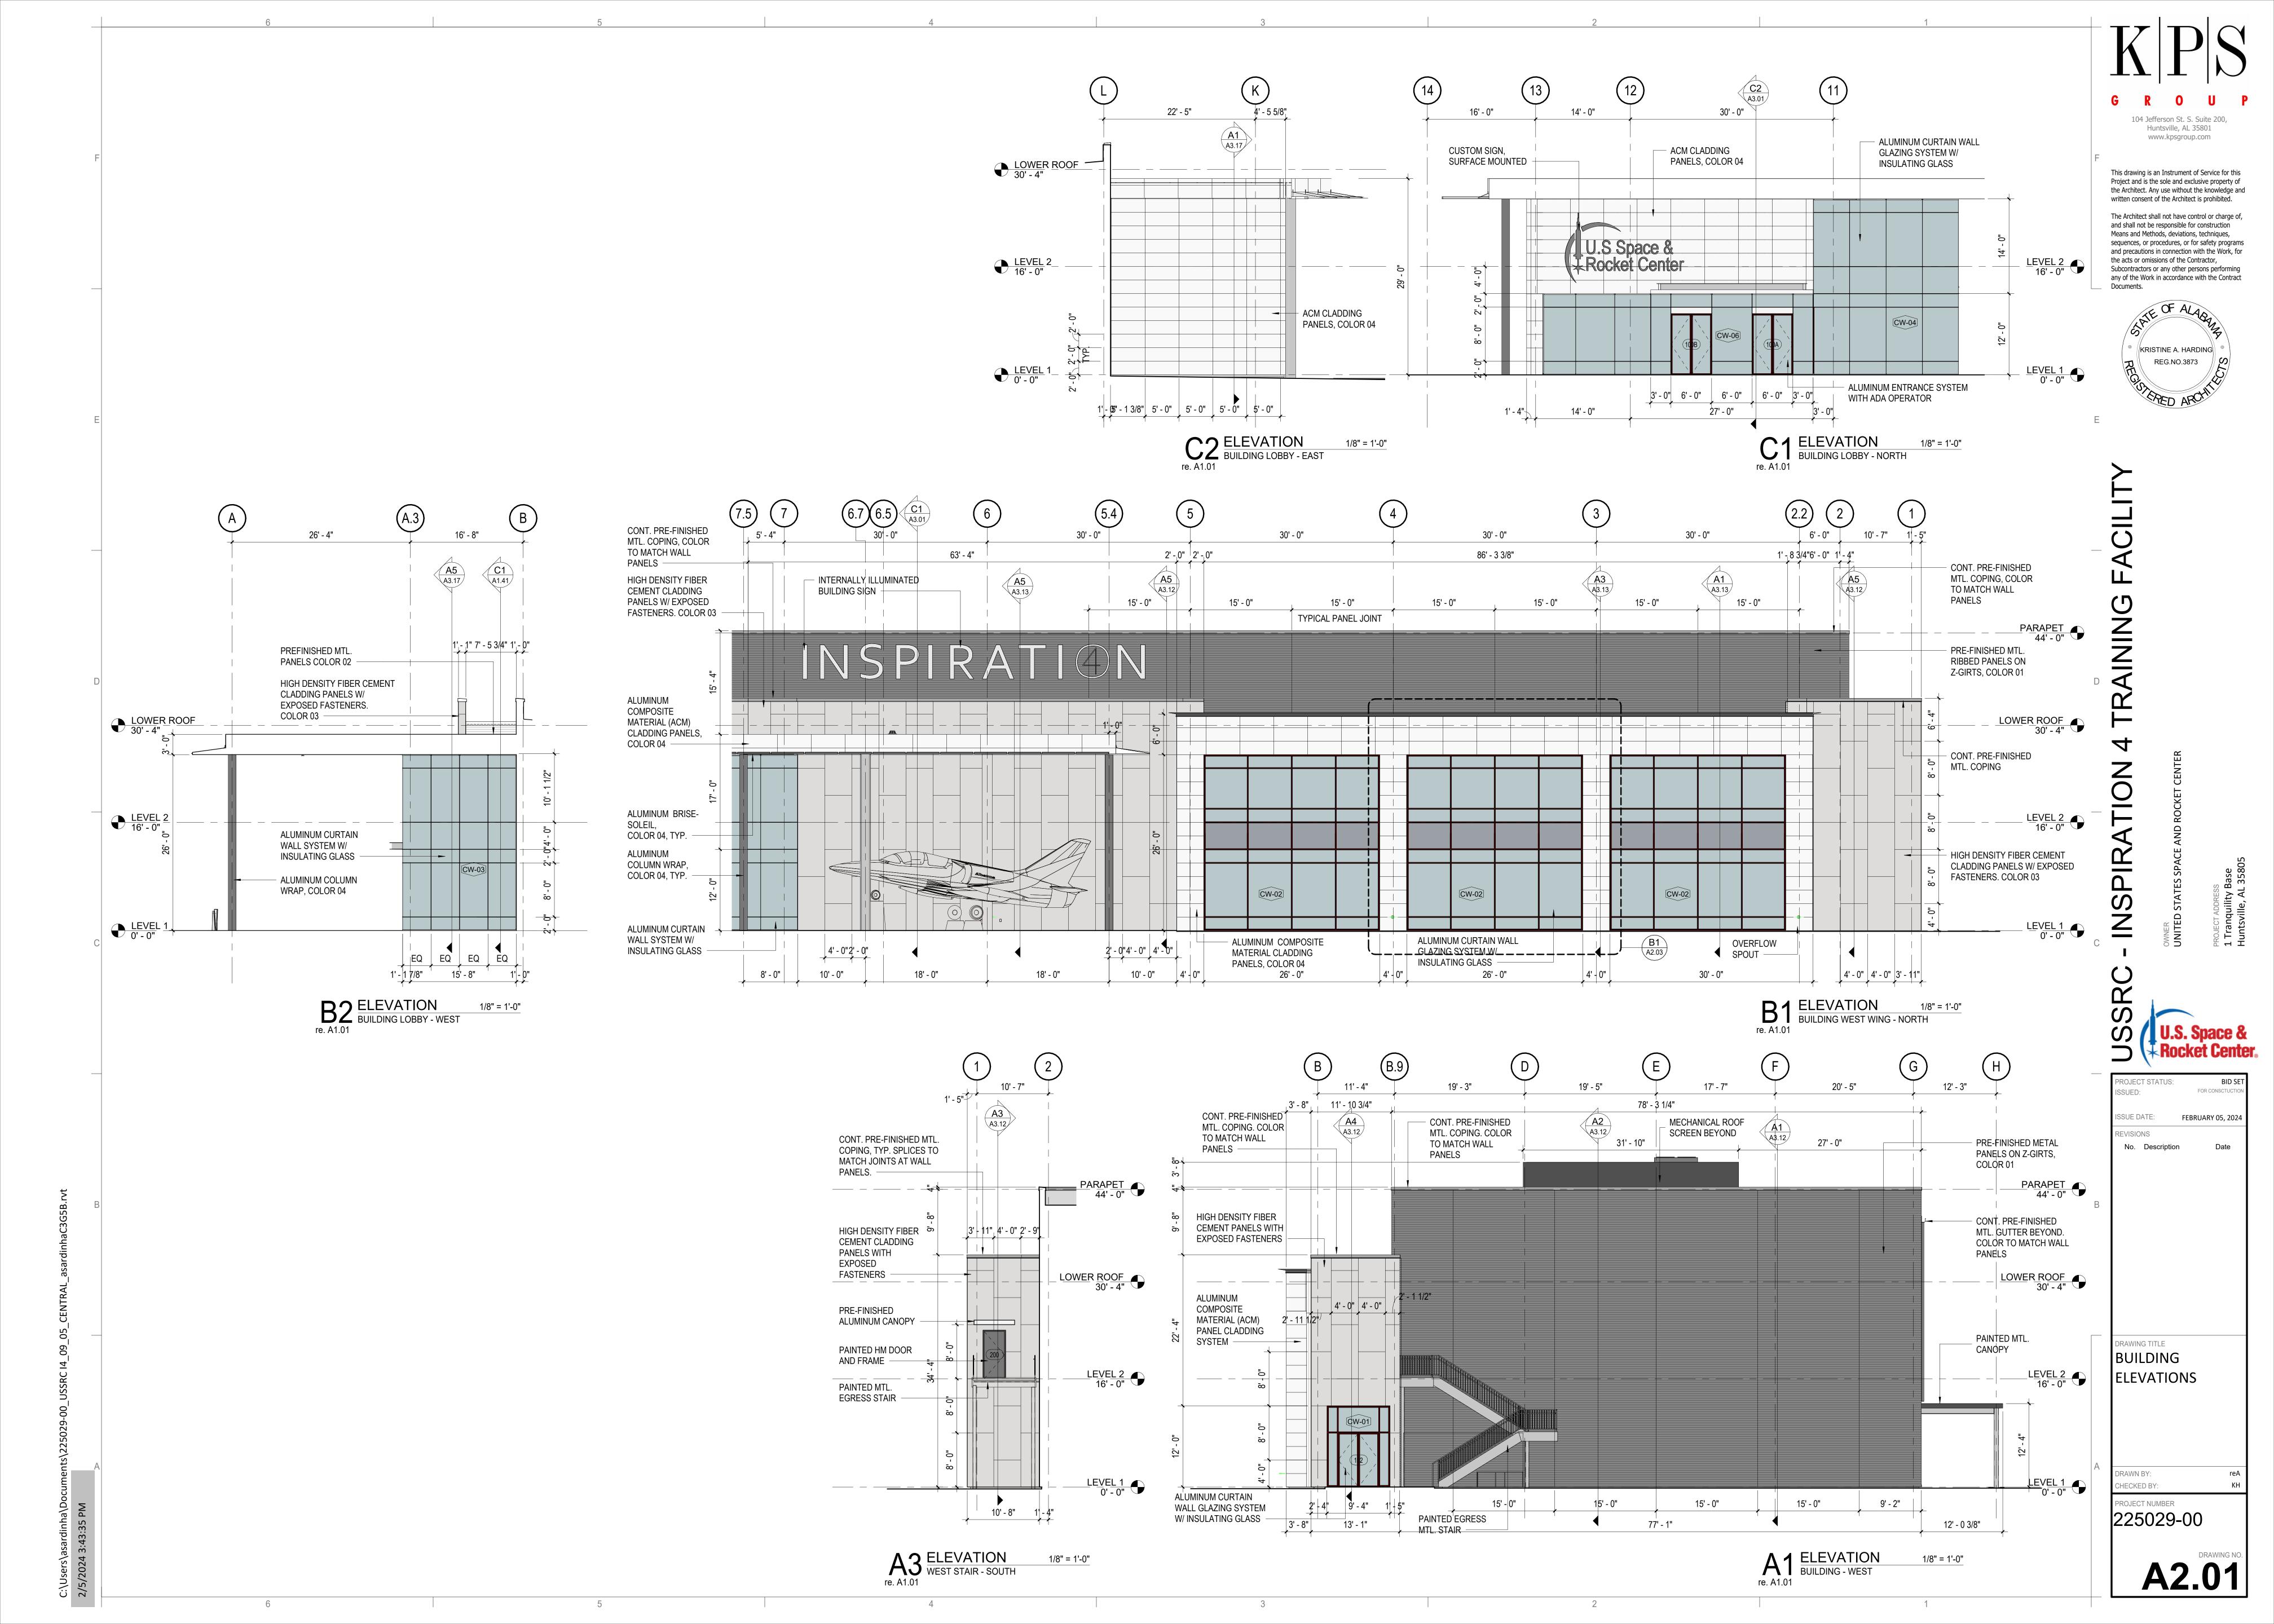


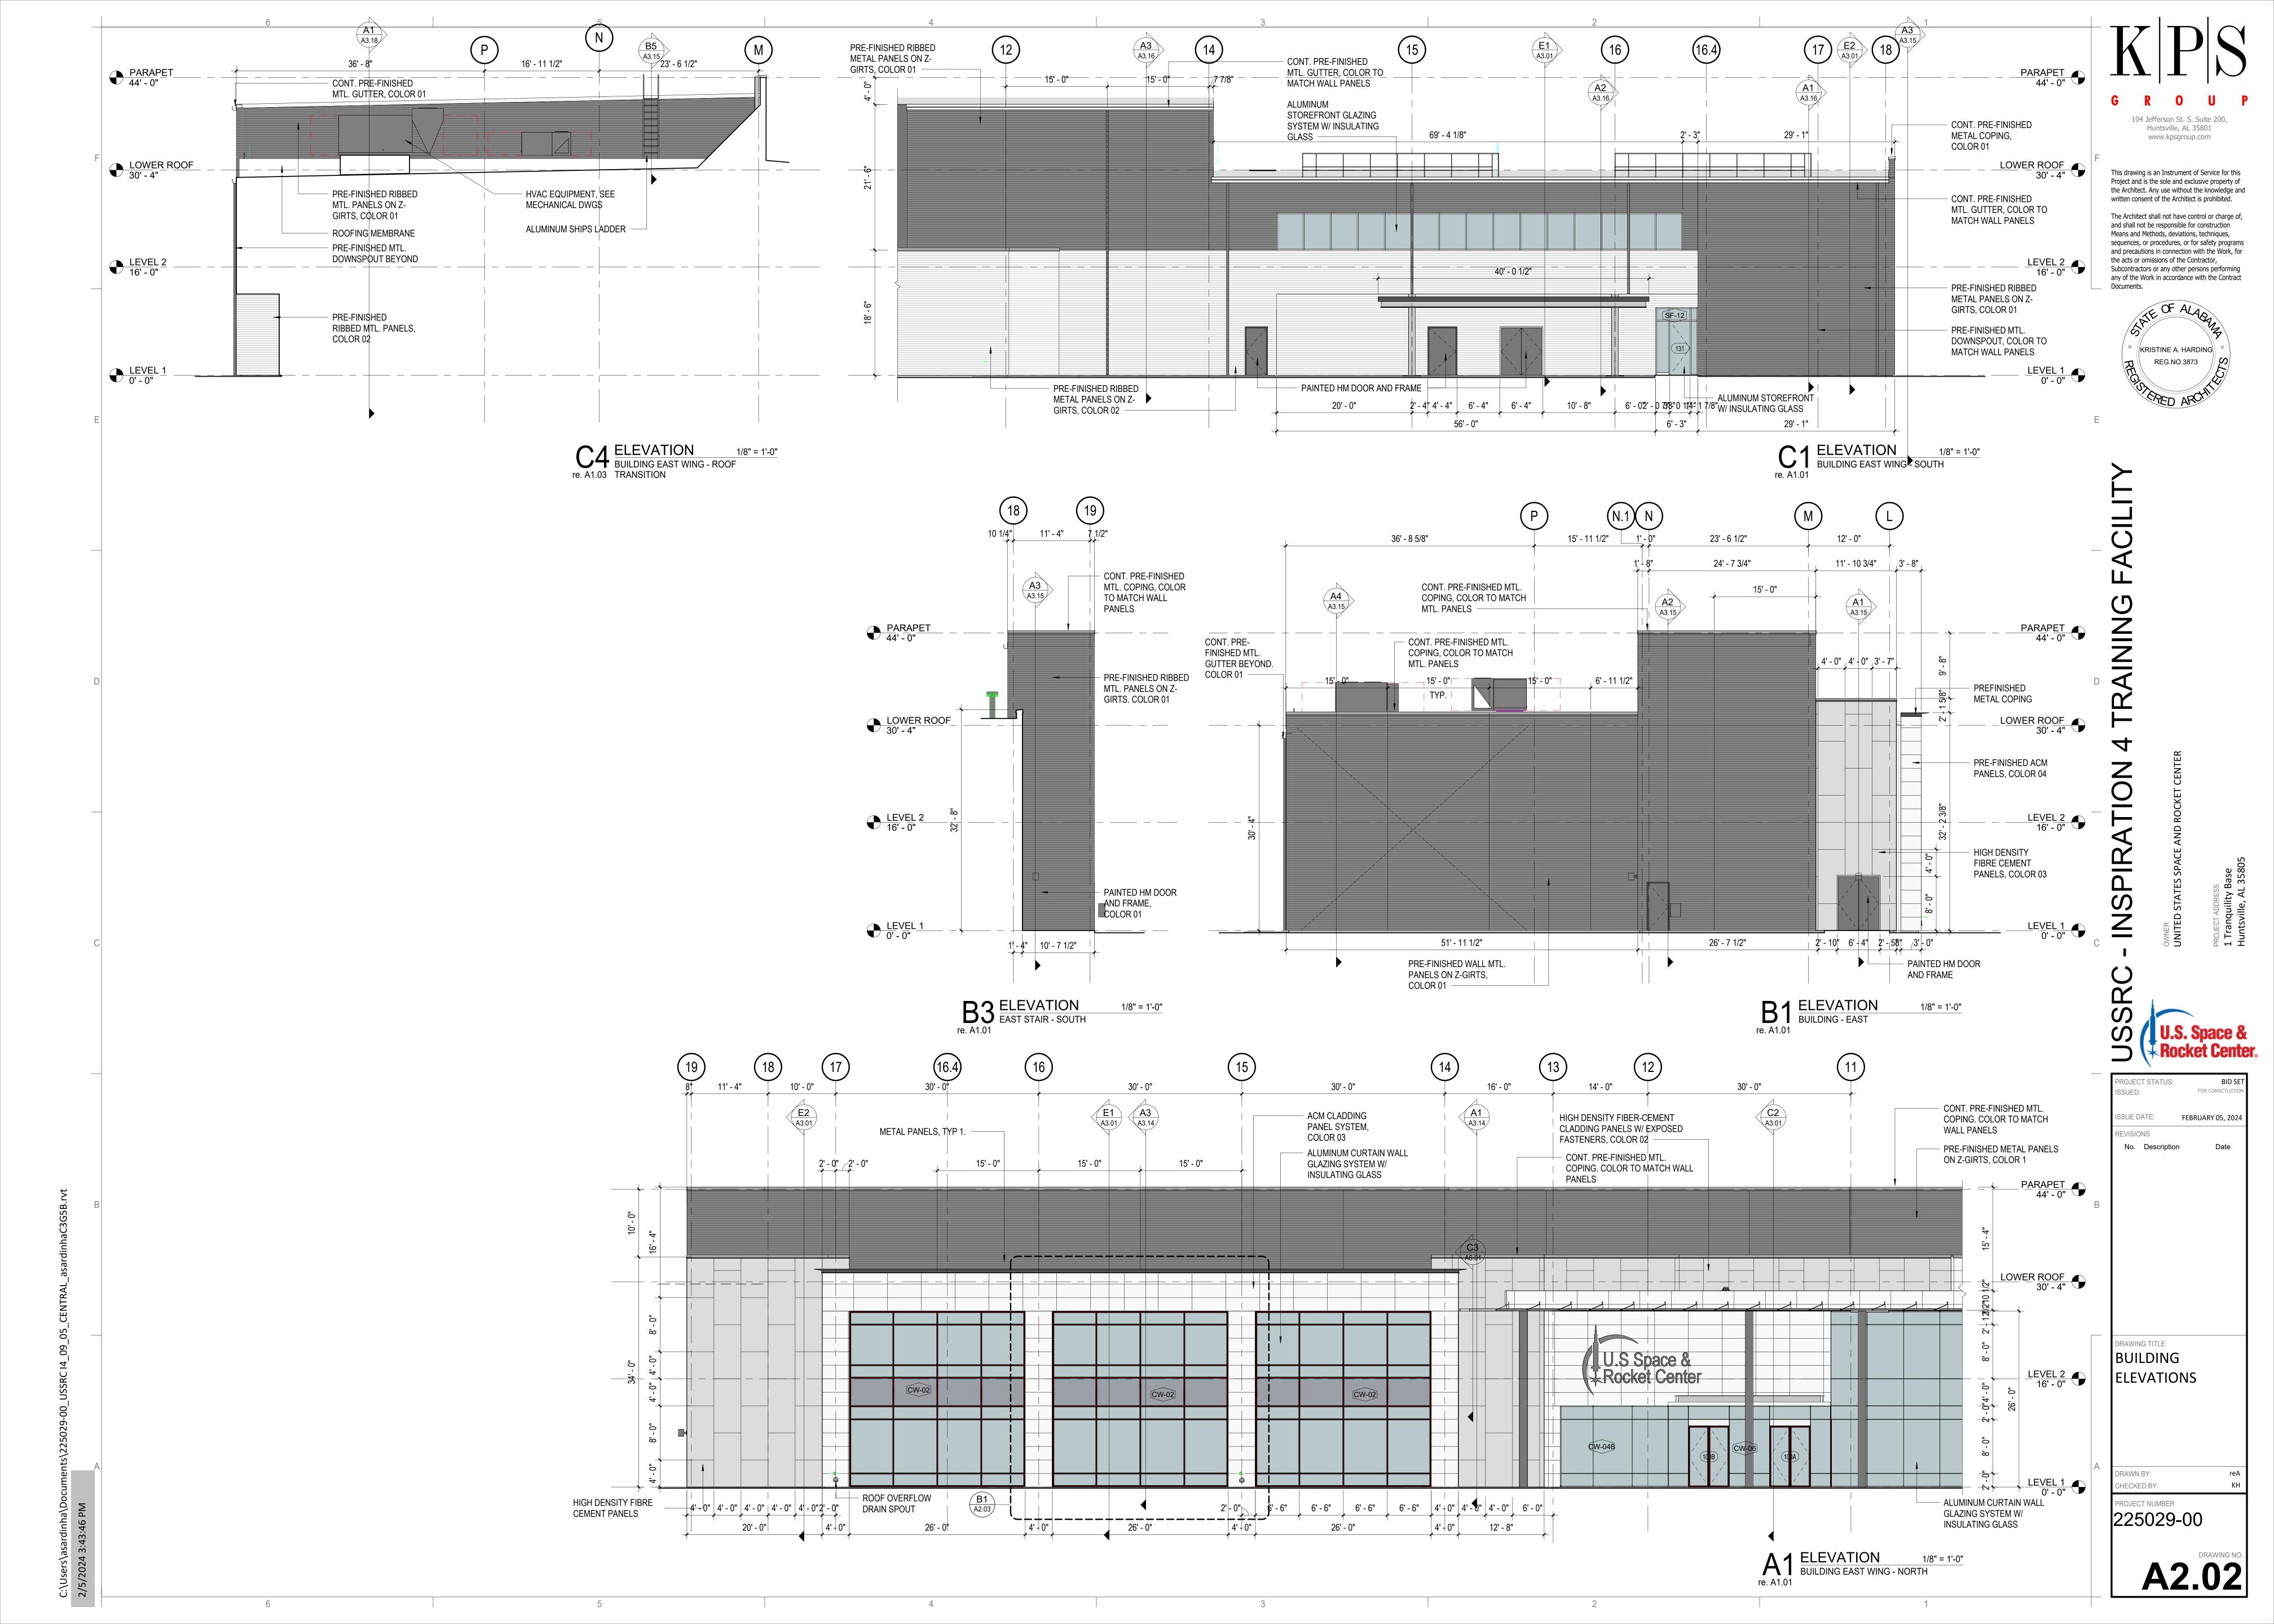



GROUP


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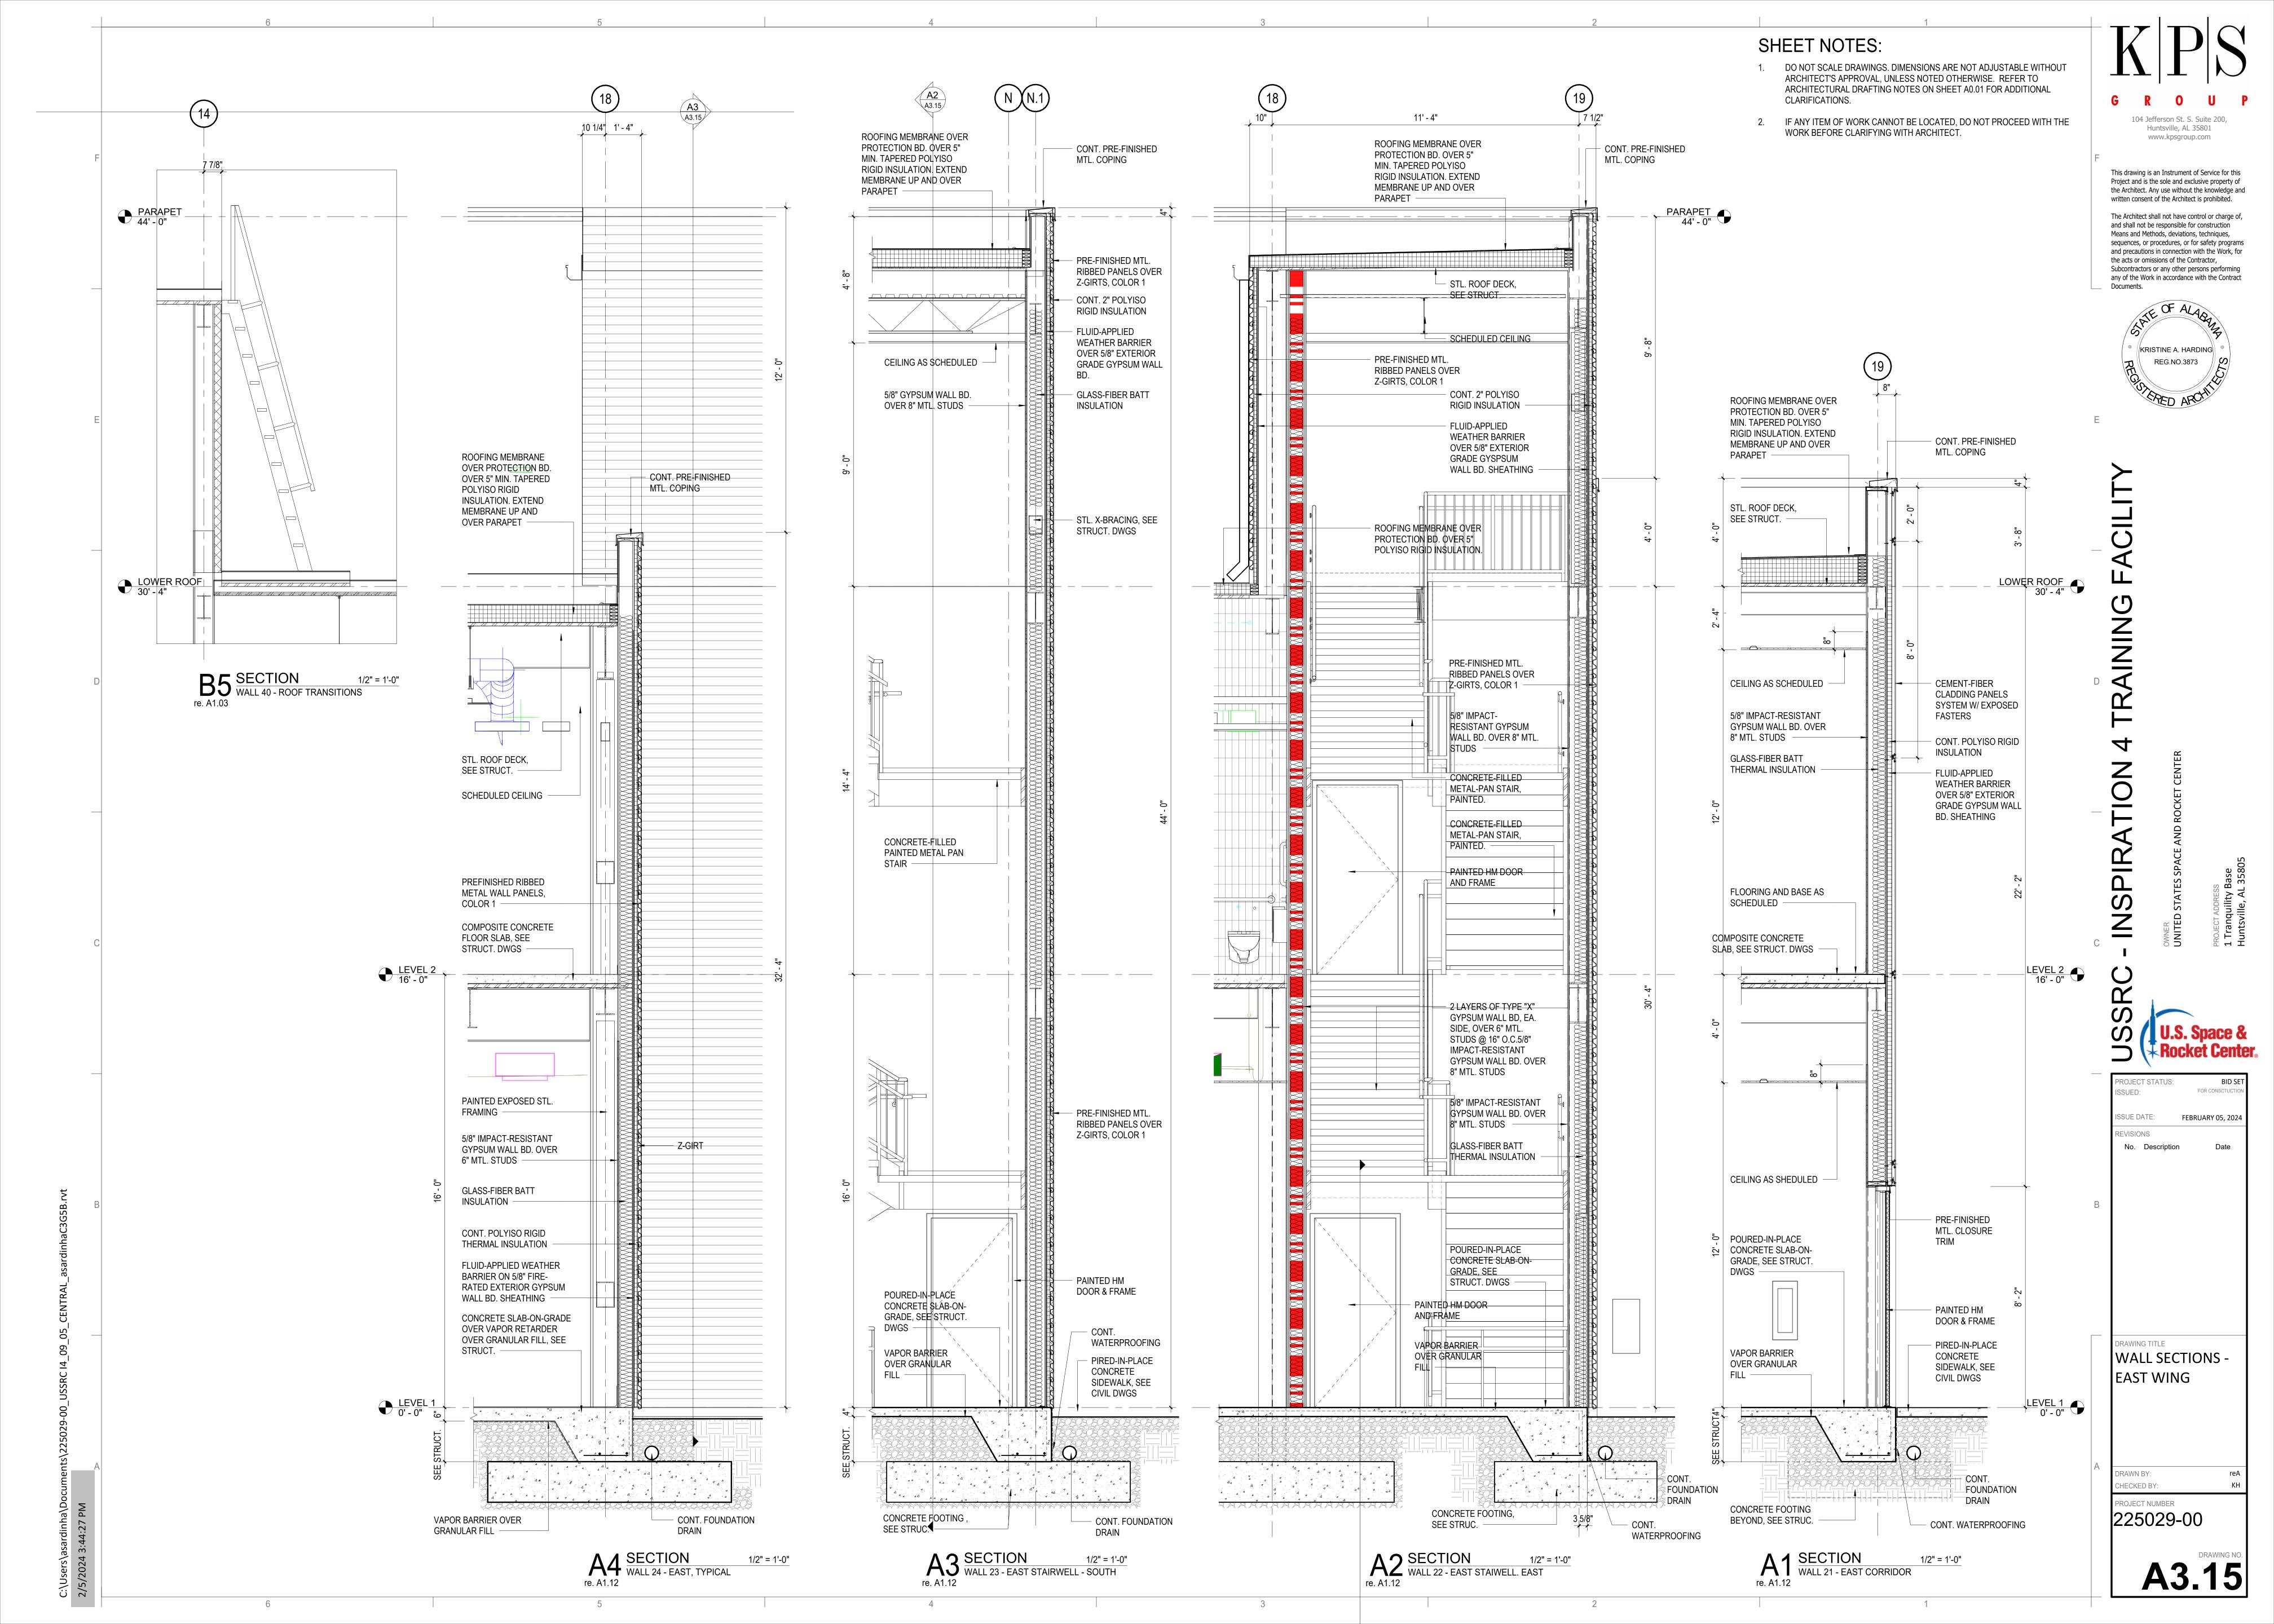



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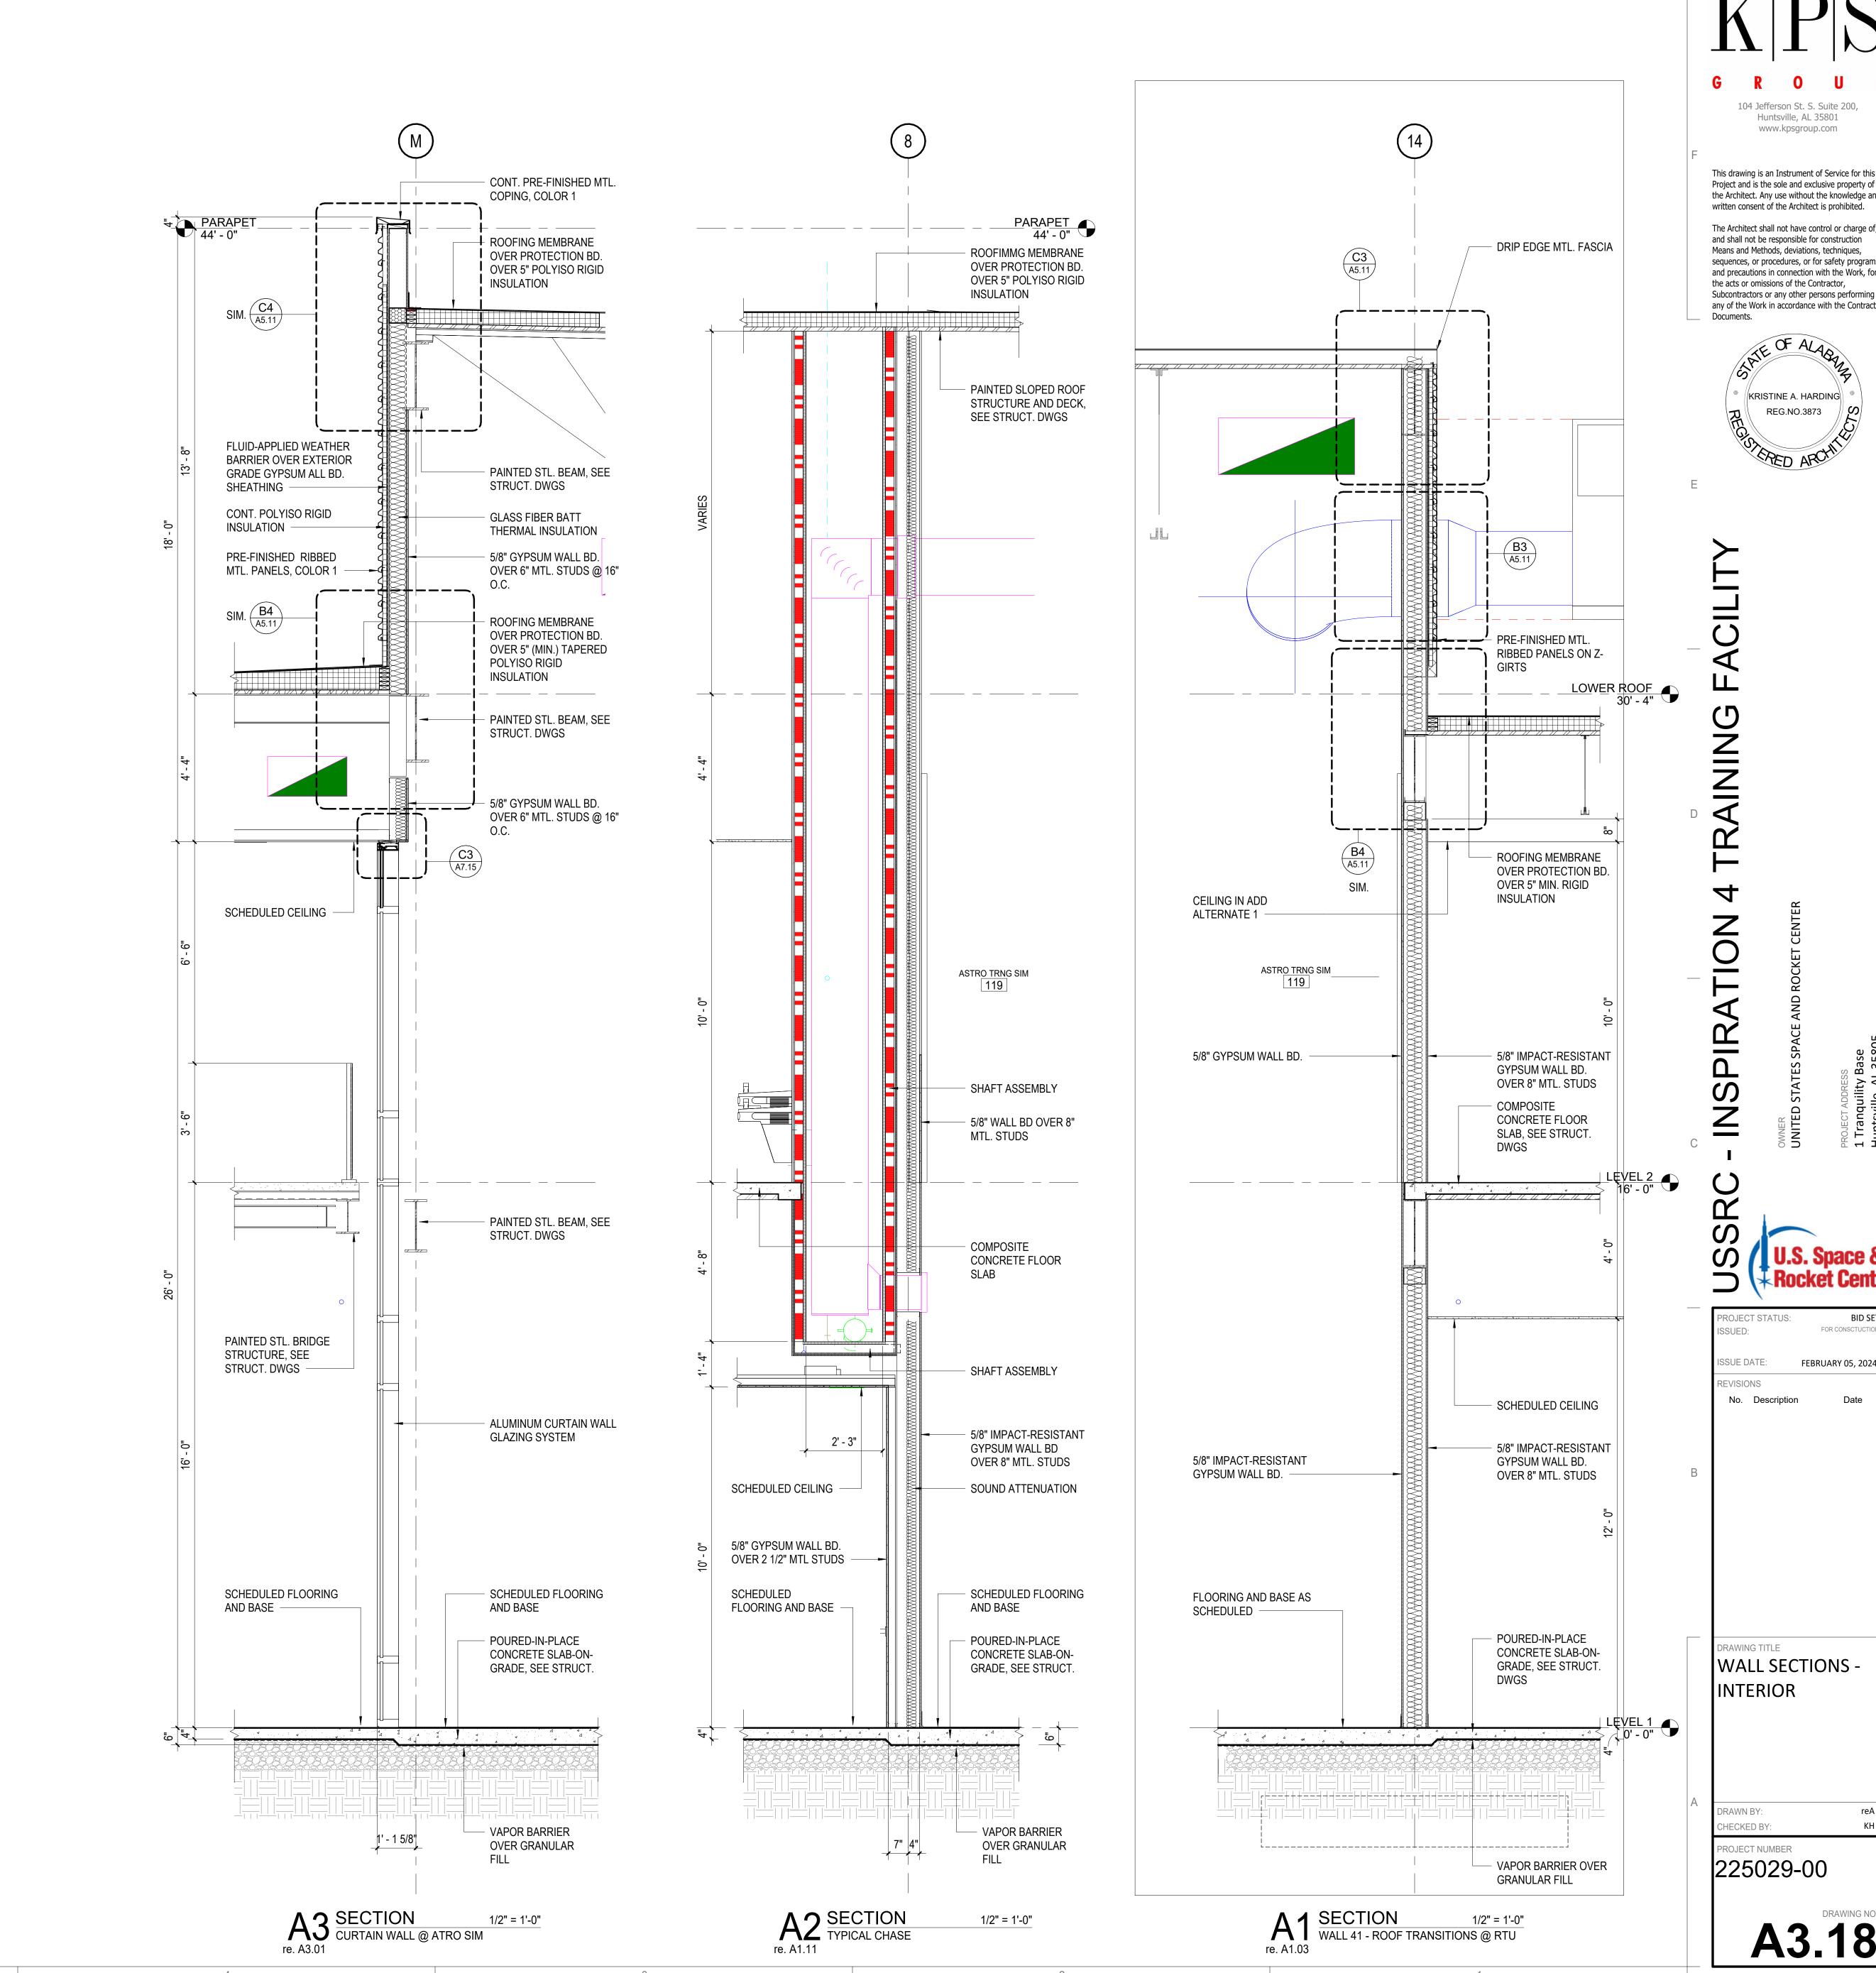
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FOR CONSCTUCTION FEBRUARY 05, 2024

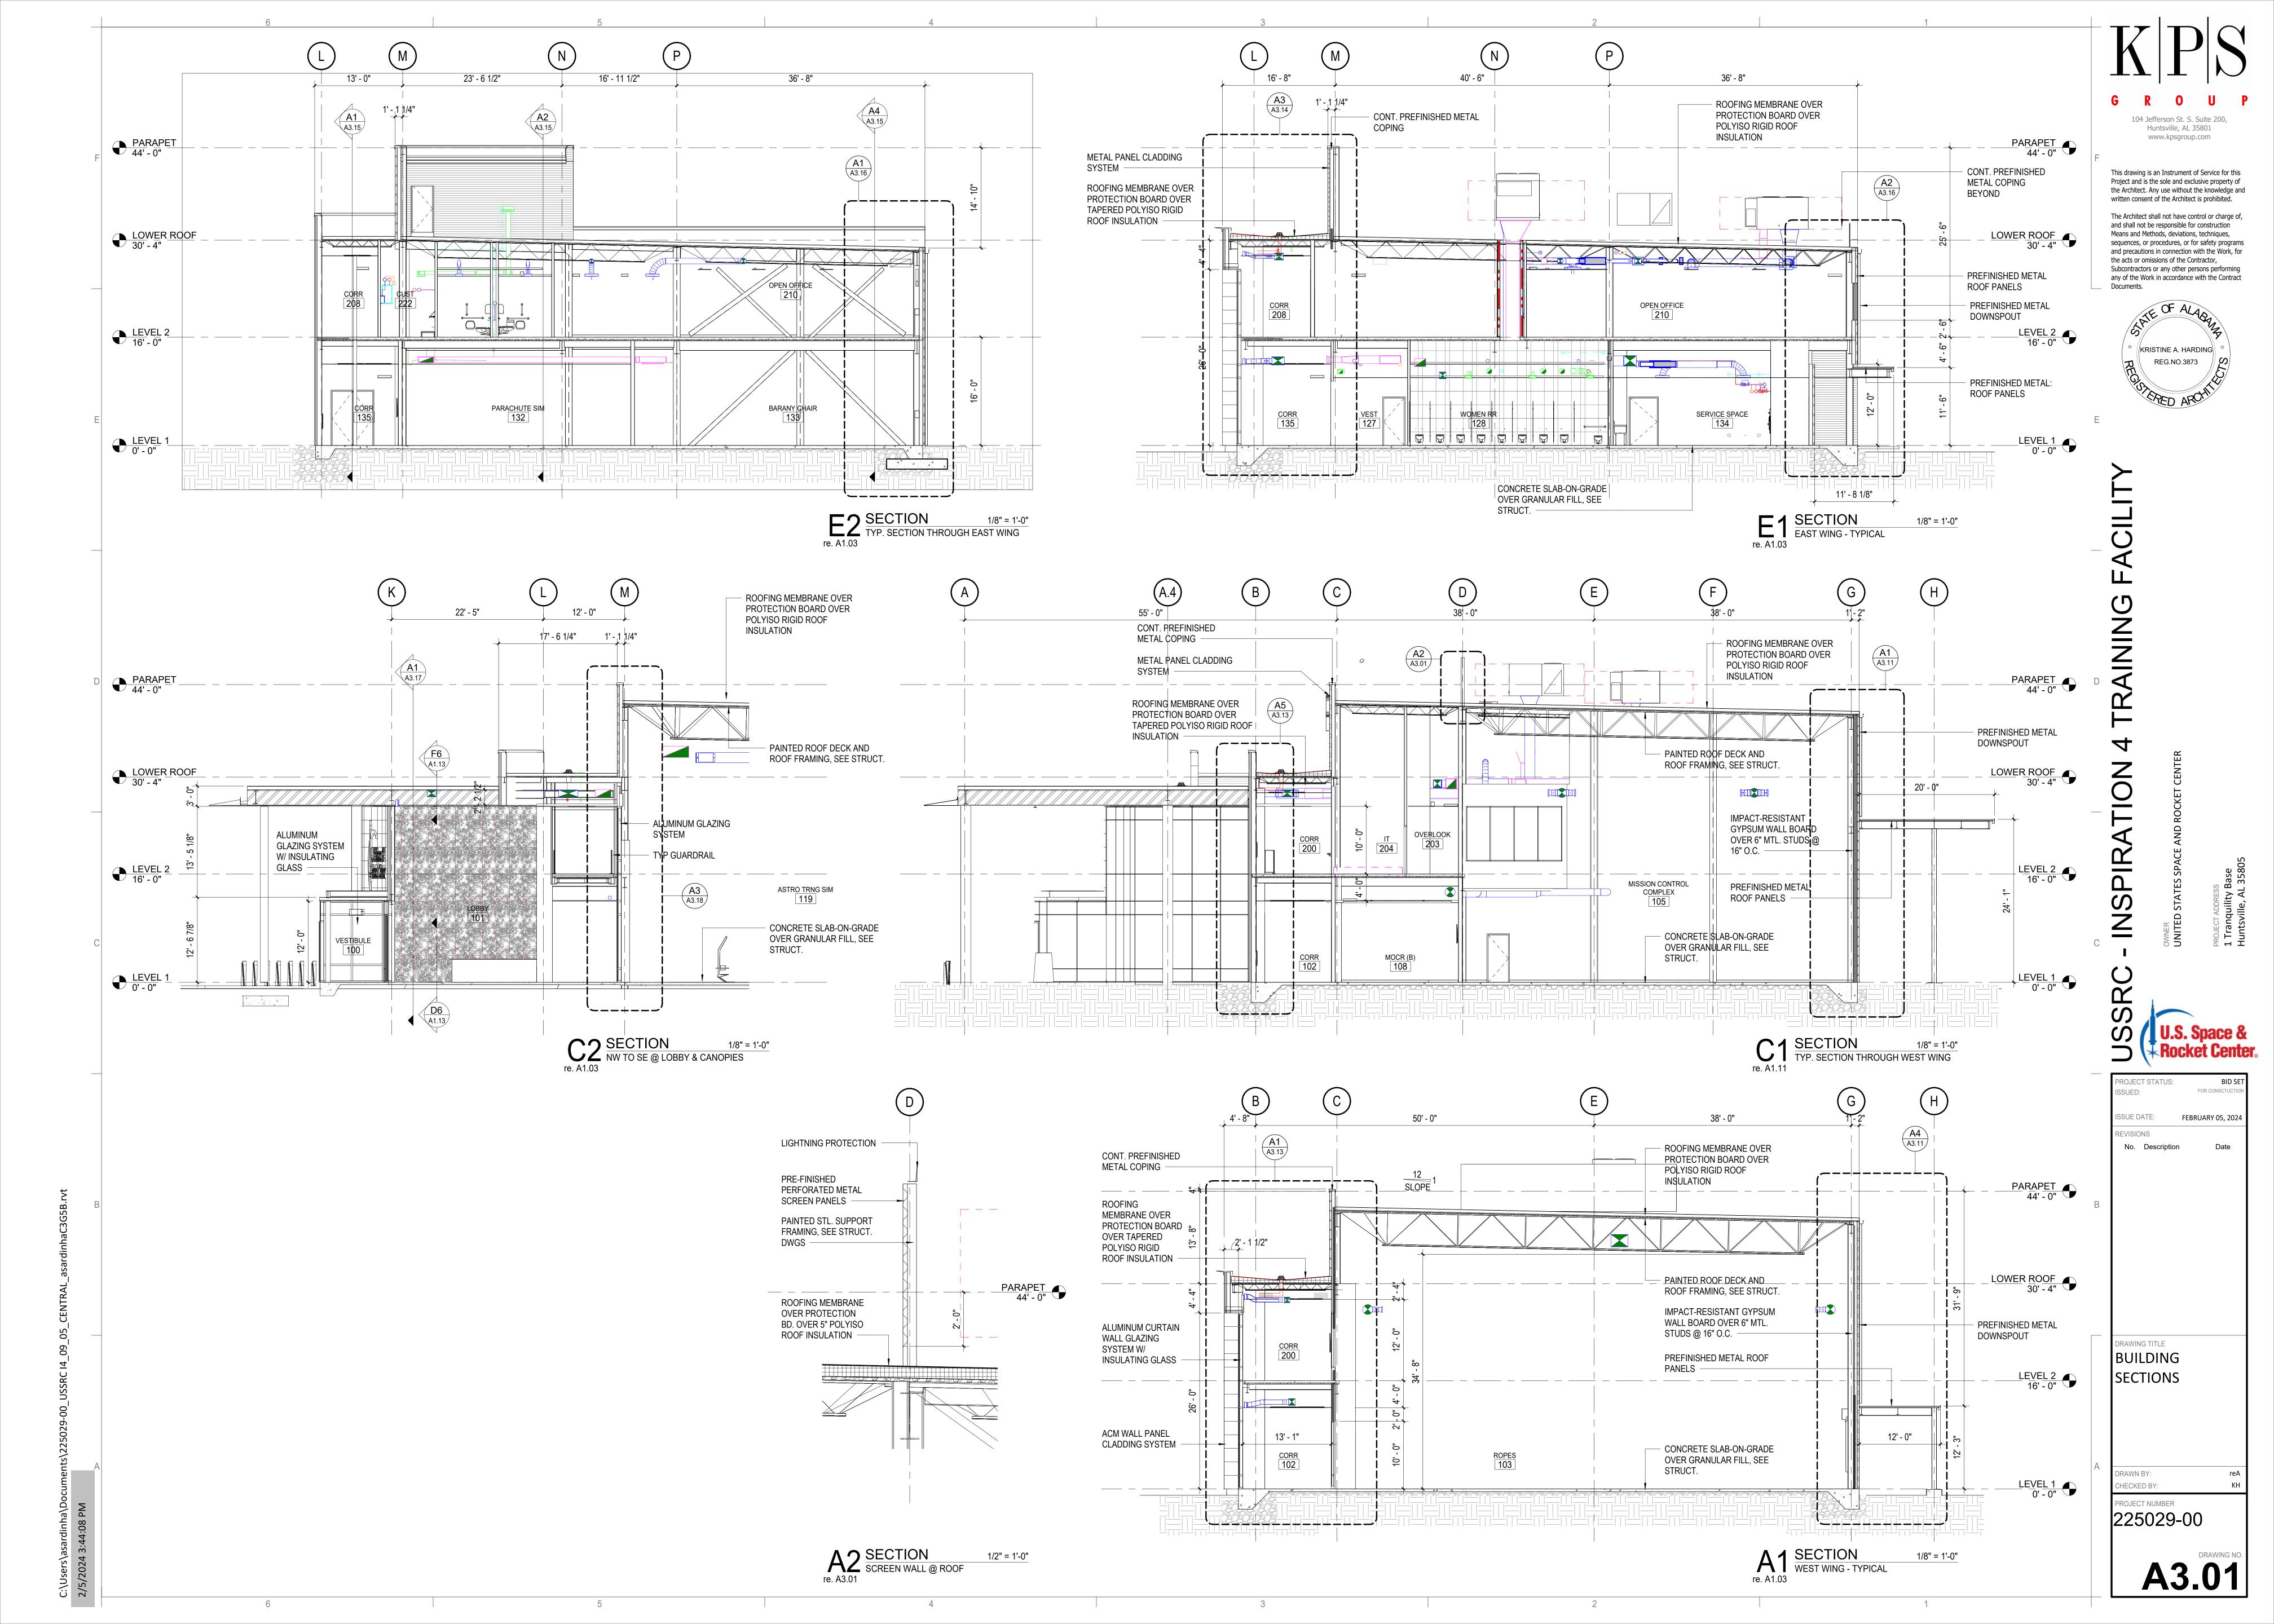

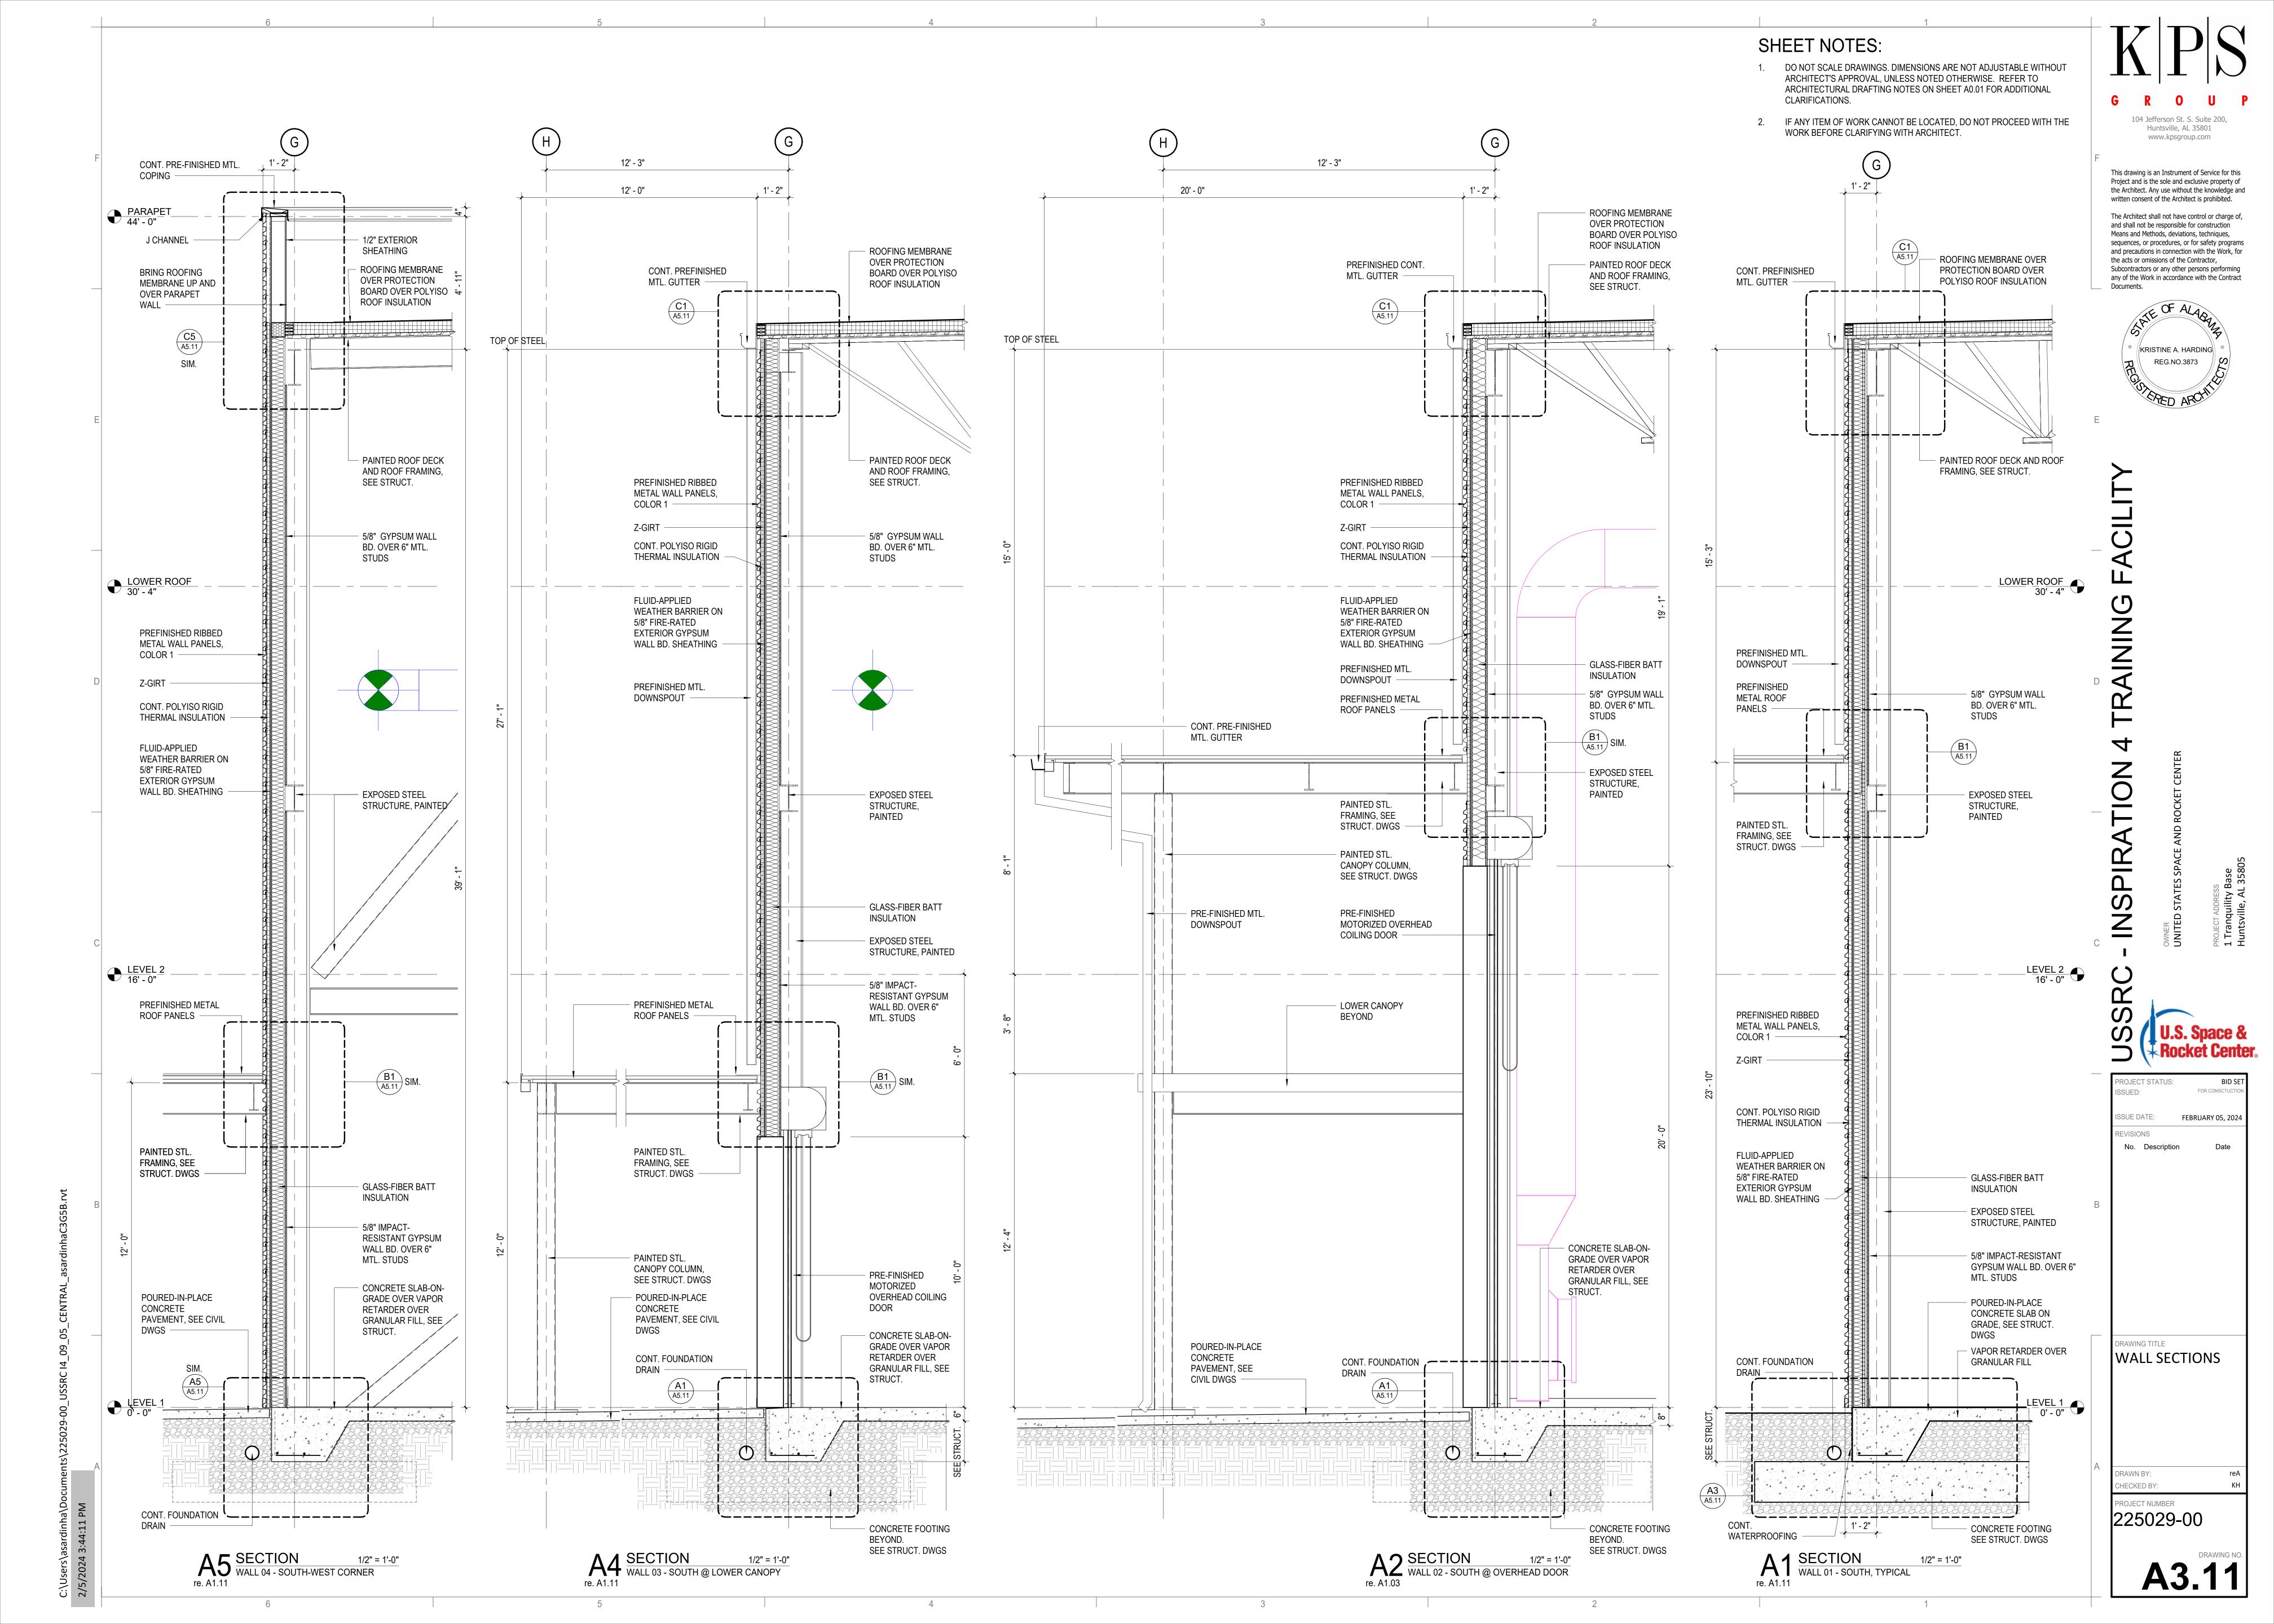

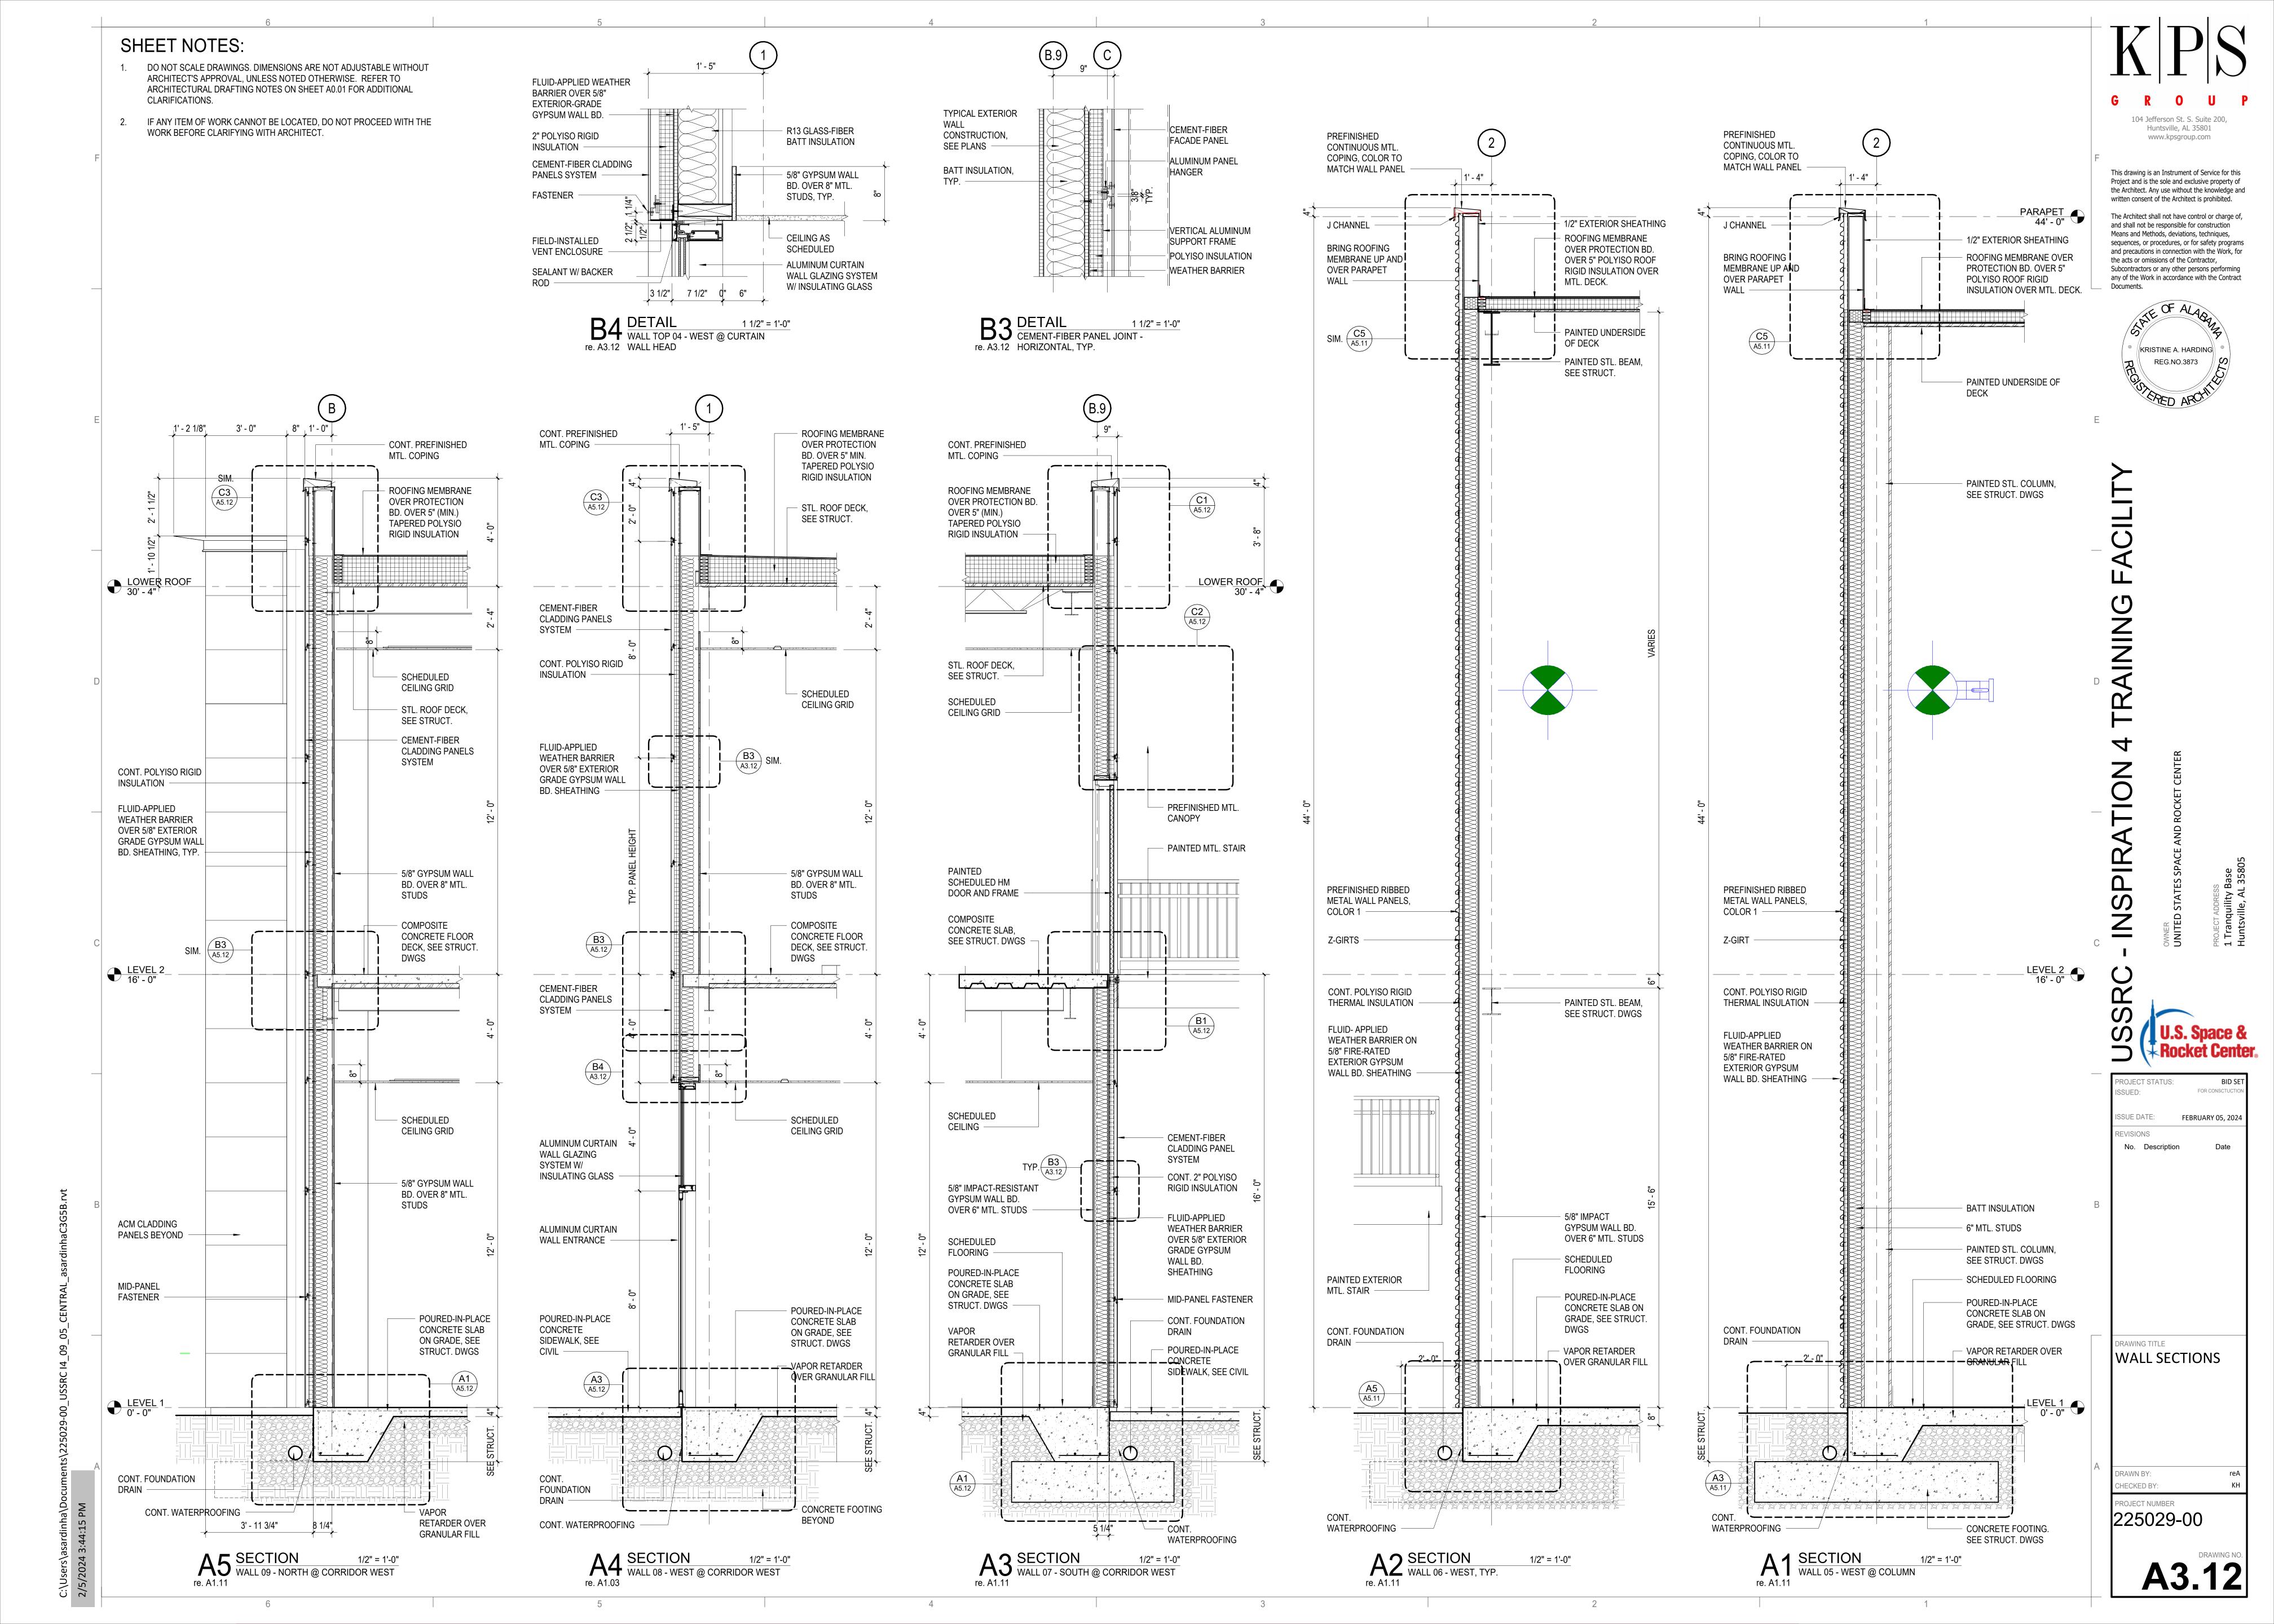

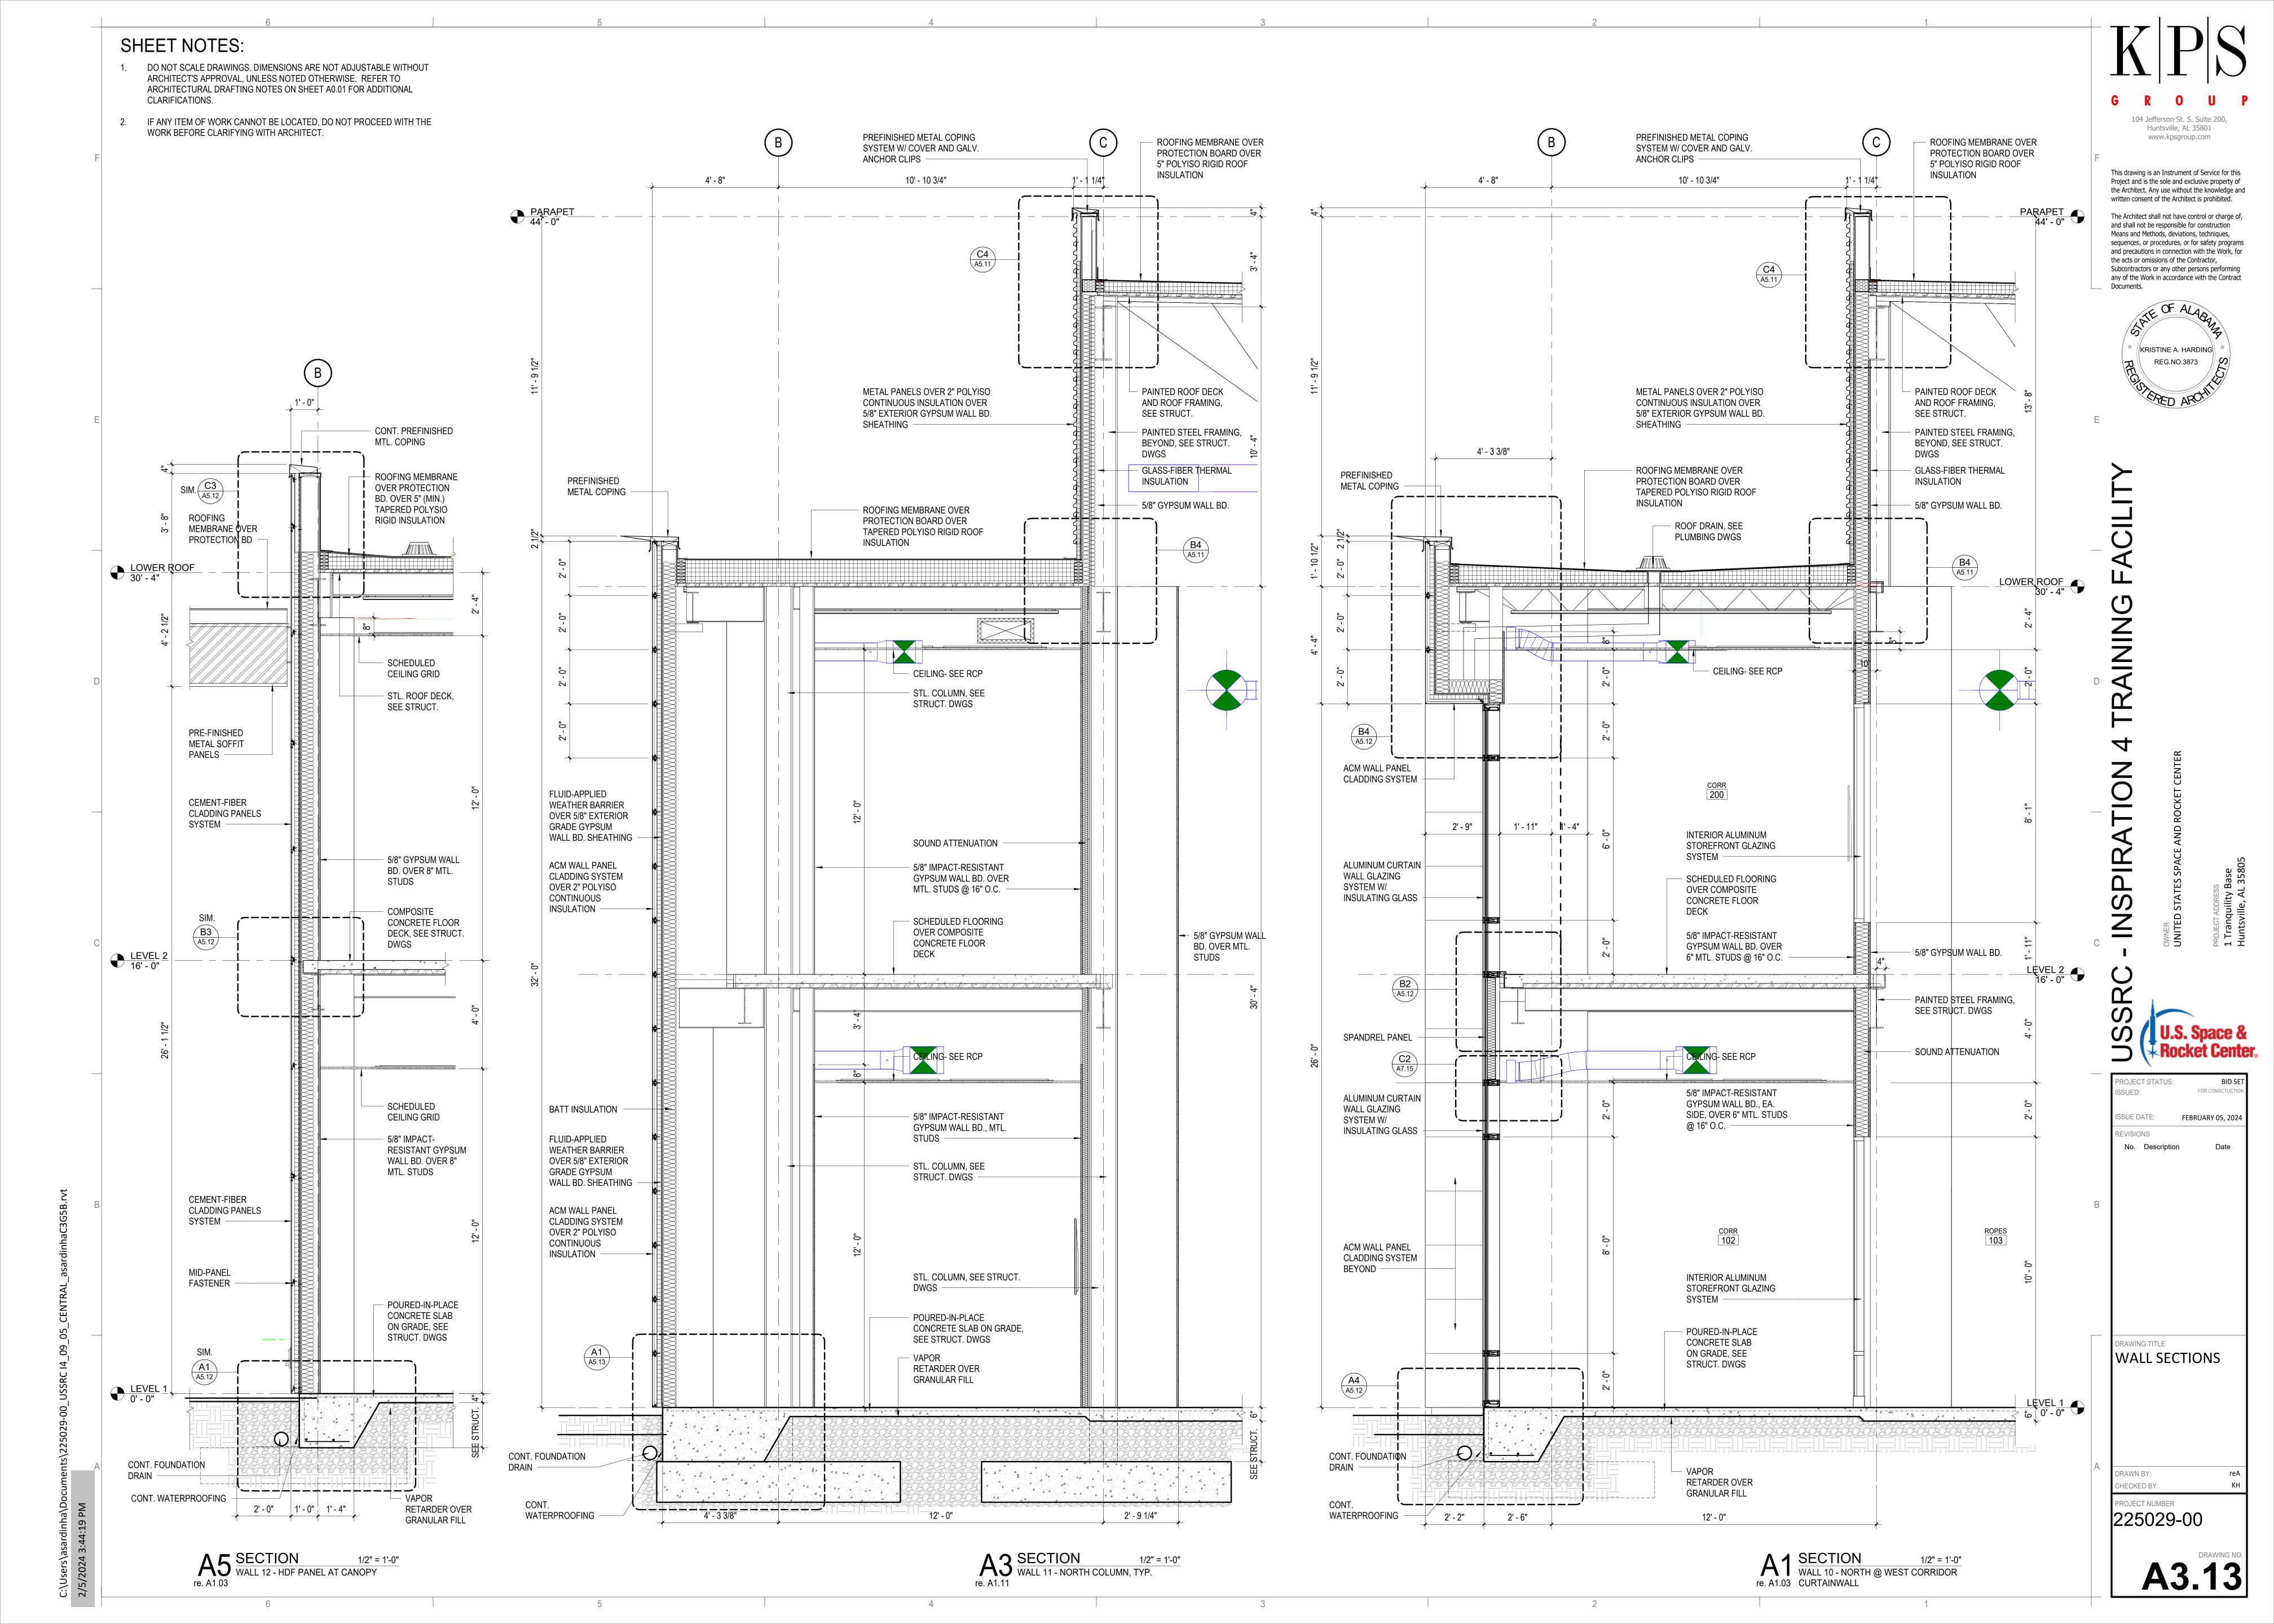
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KRISTINE A. HARDING

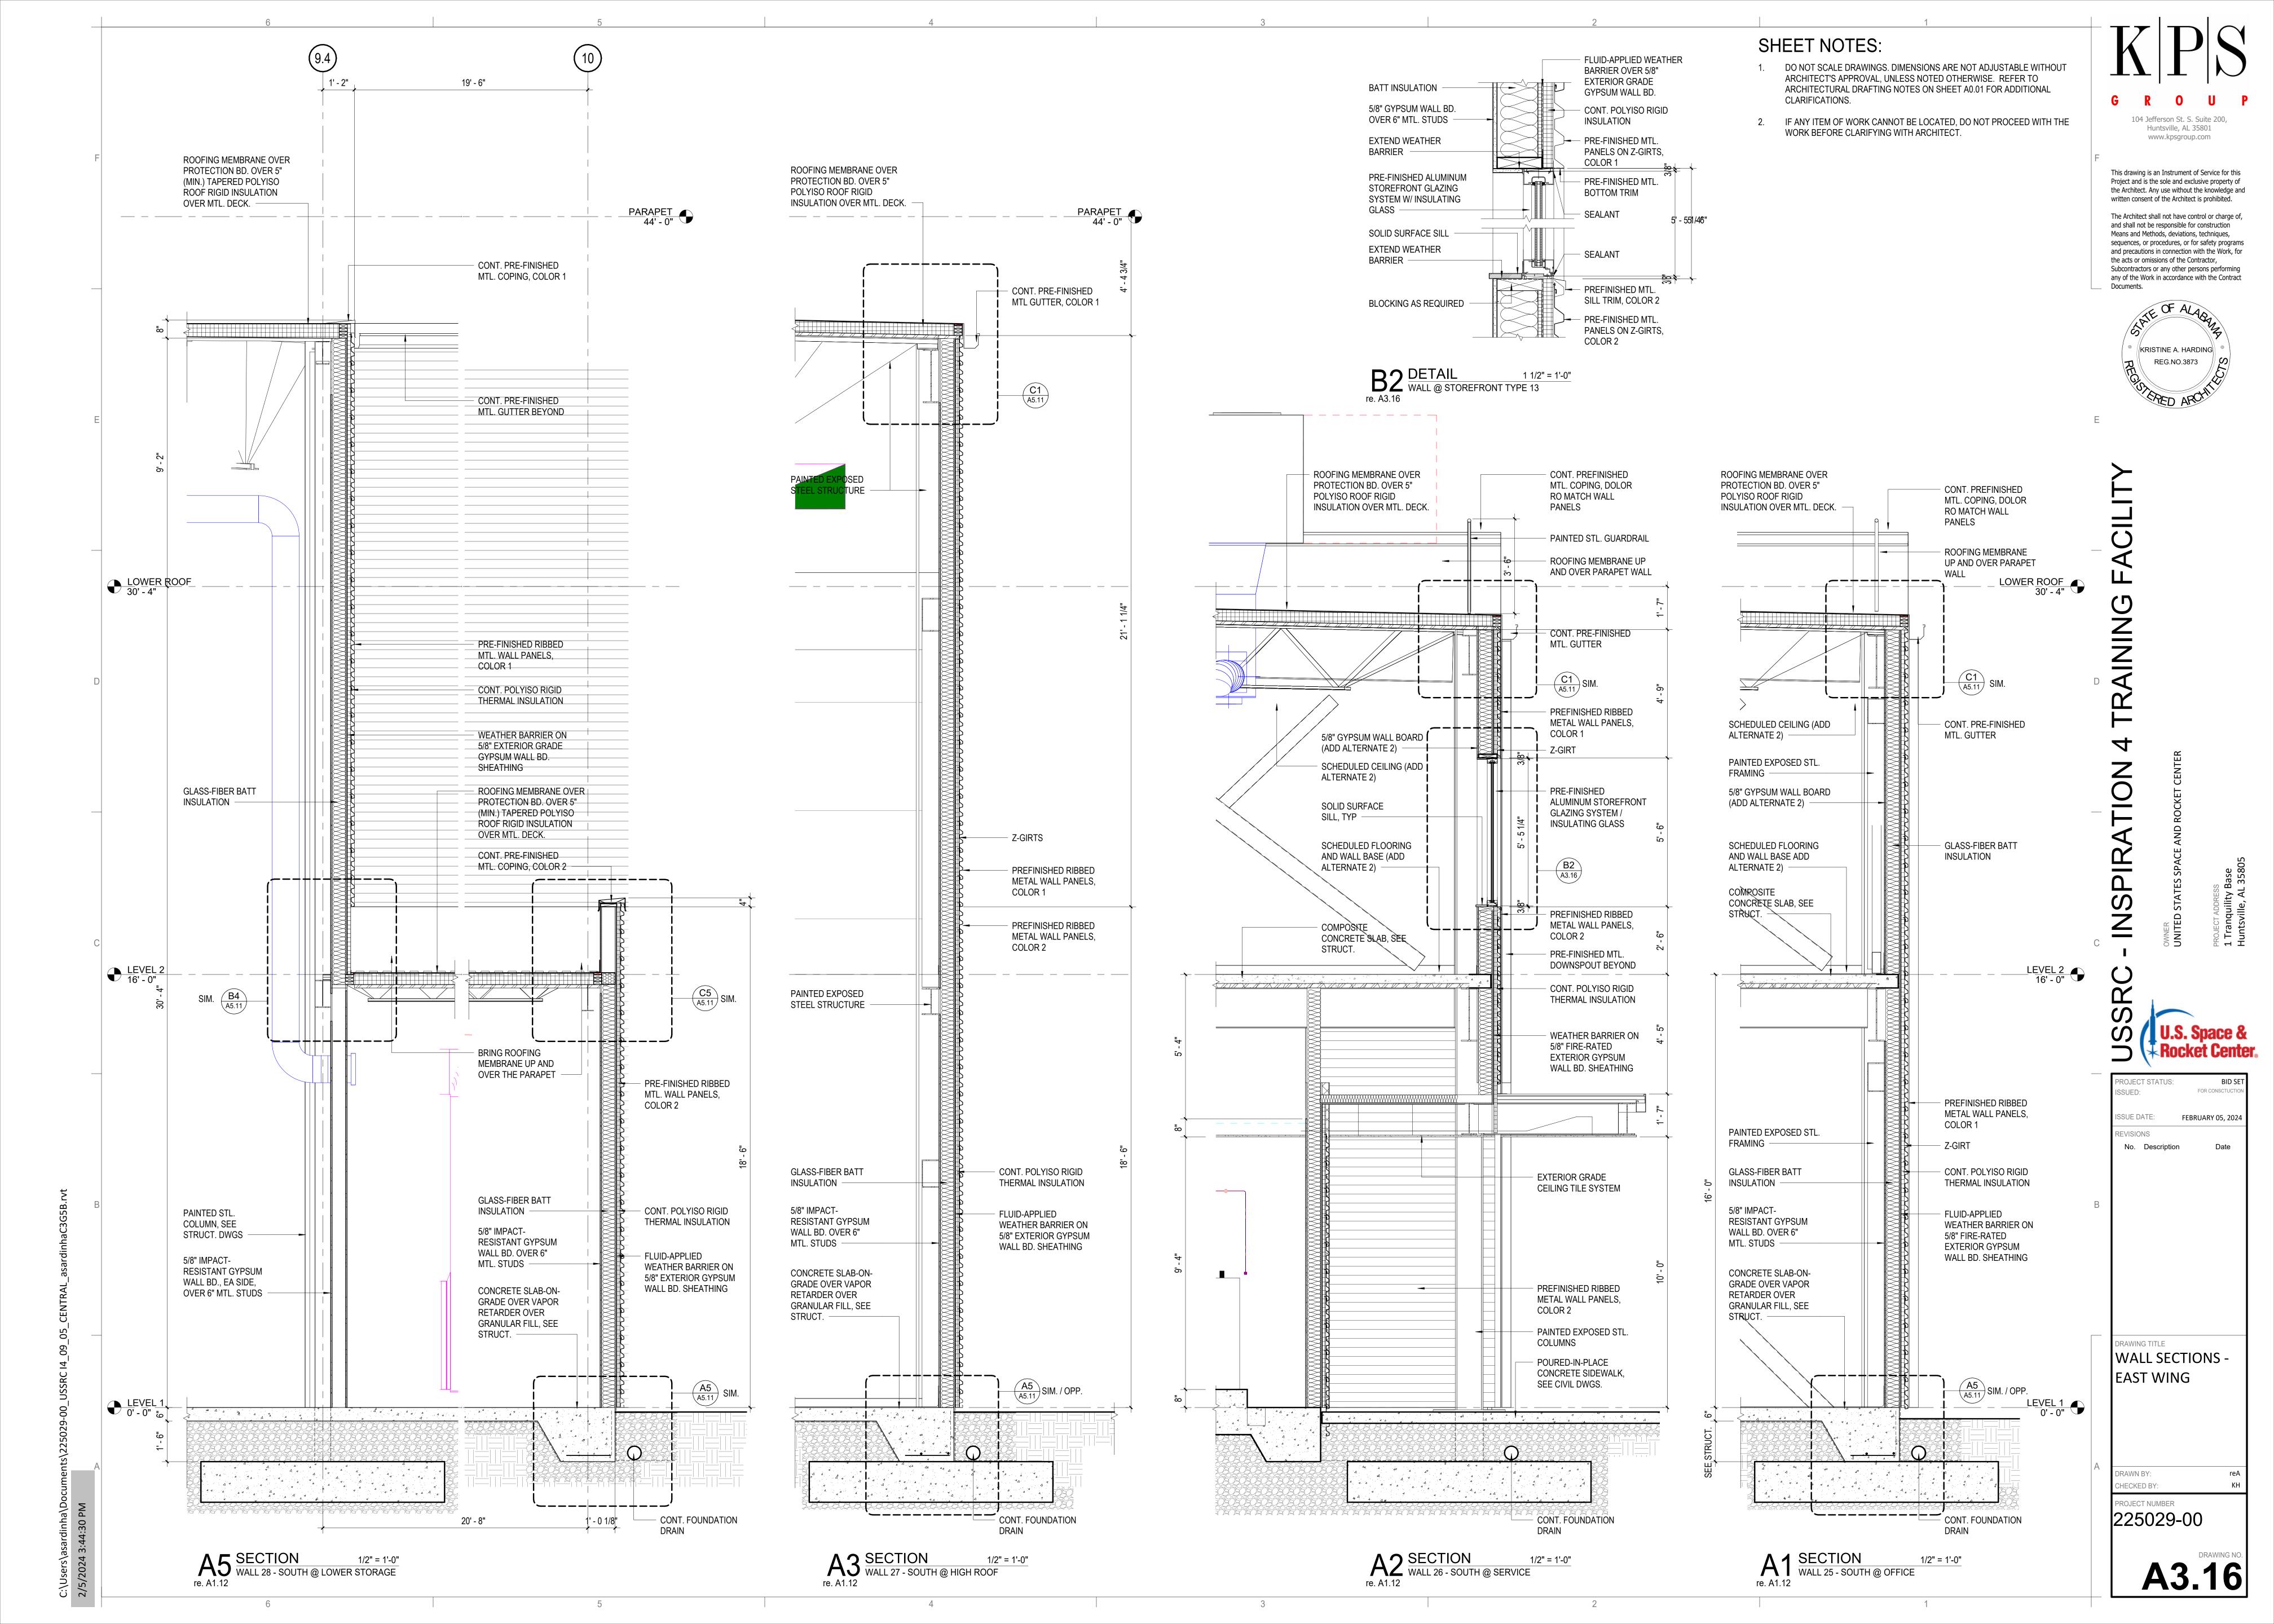
FEBRUARY 05, 2024


WALL SECTIONS -




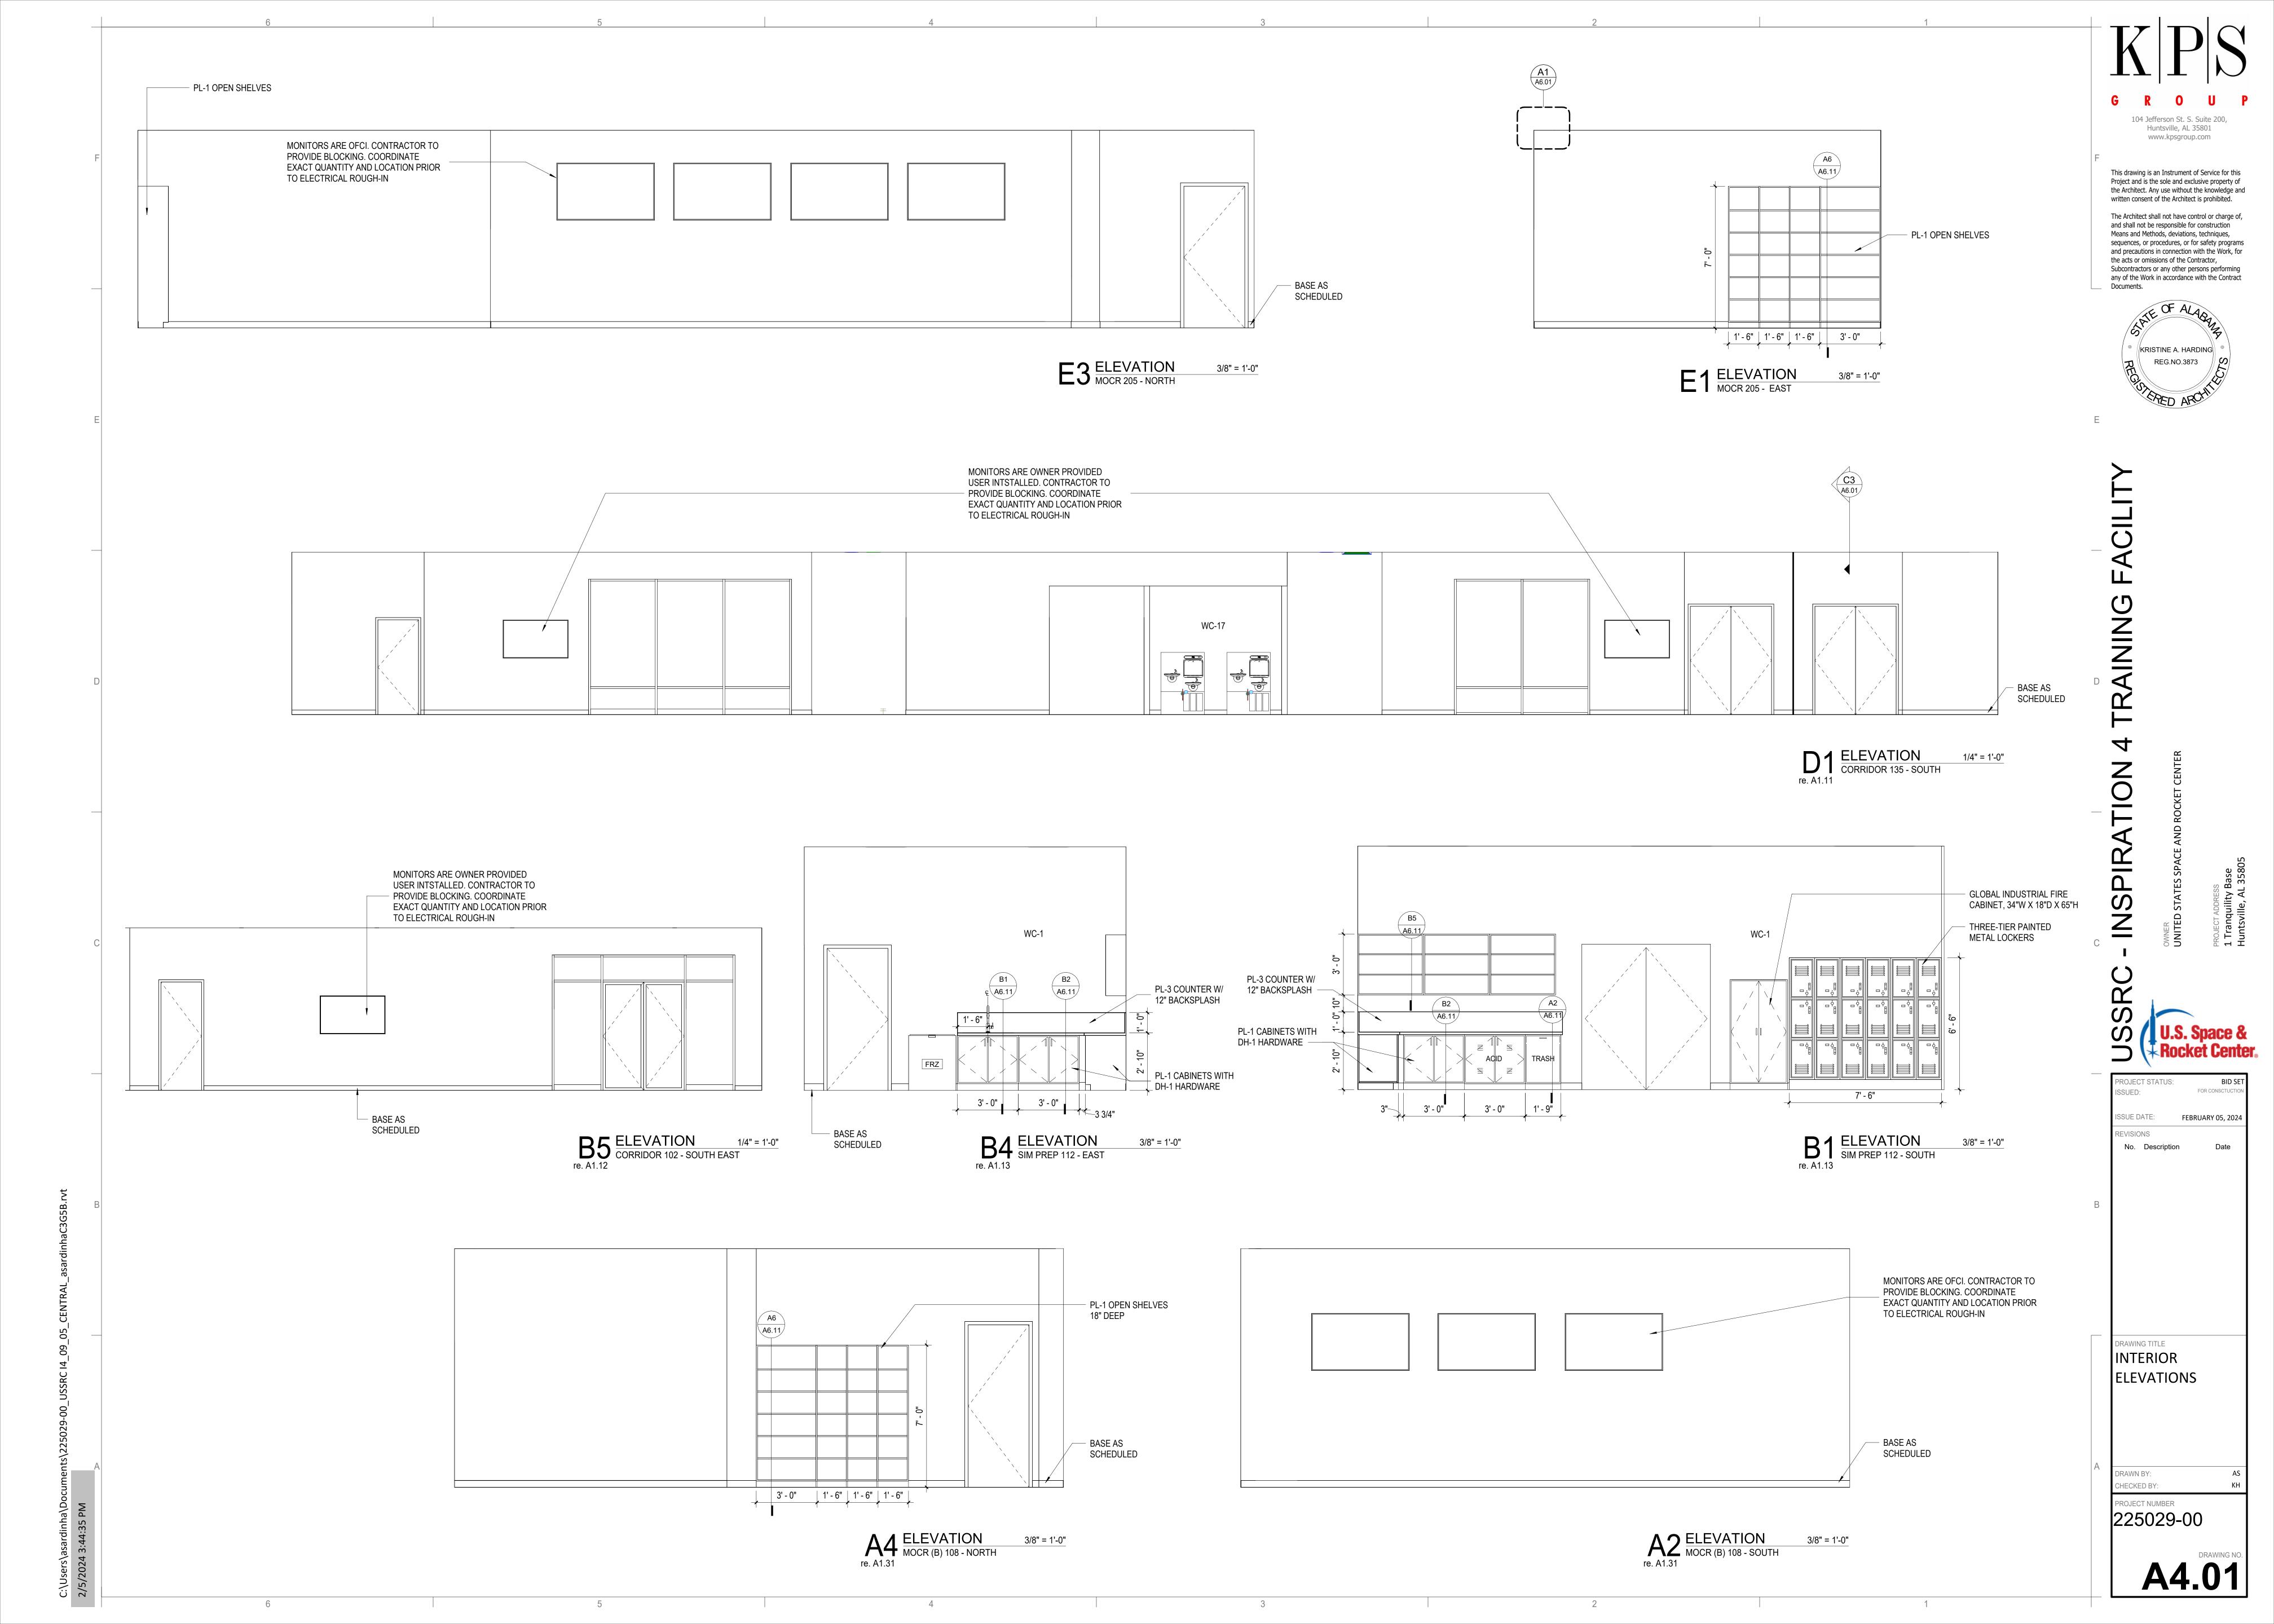



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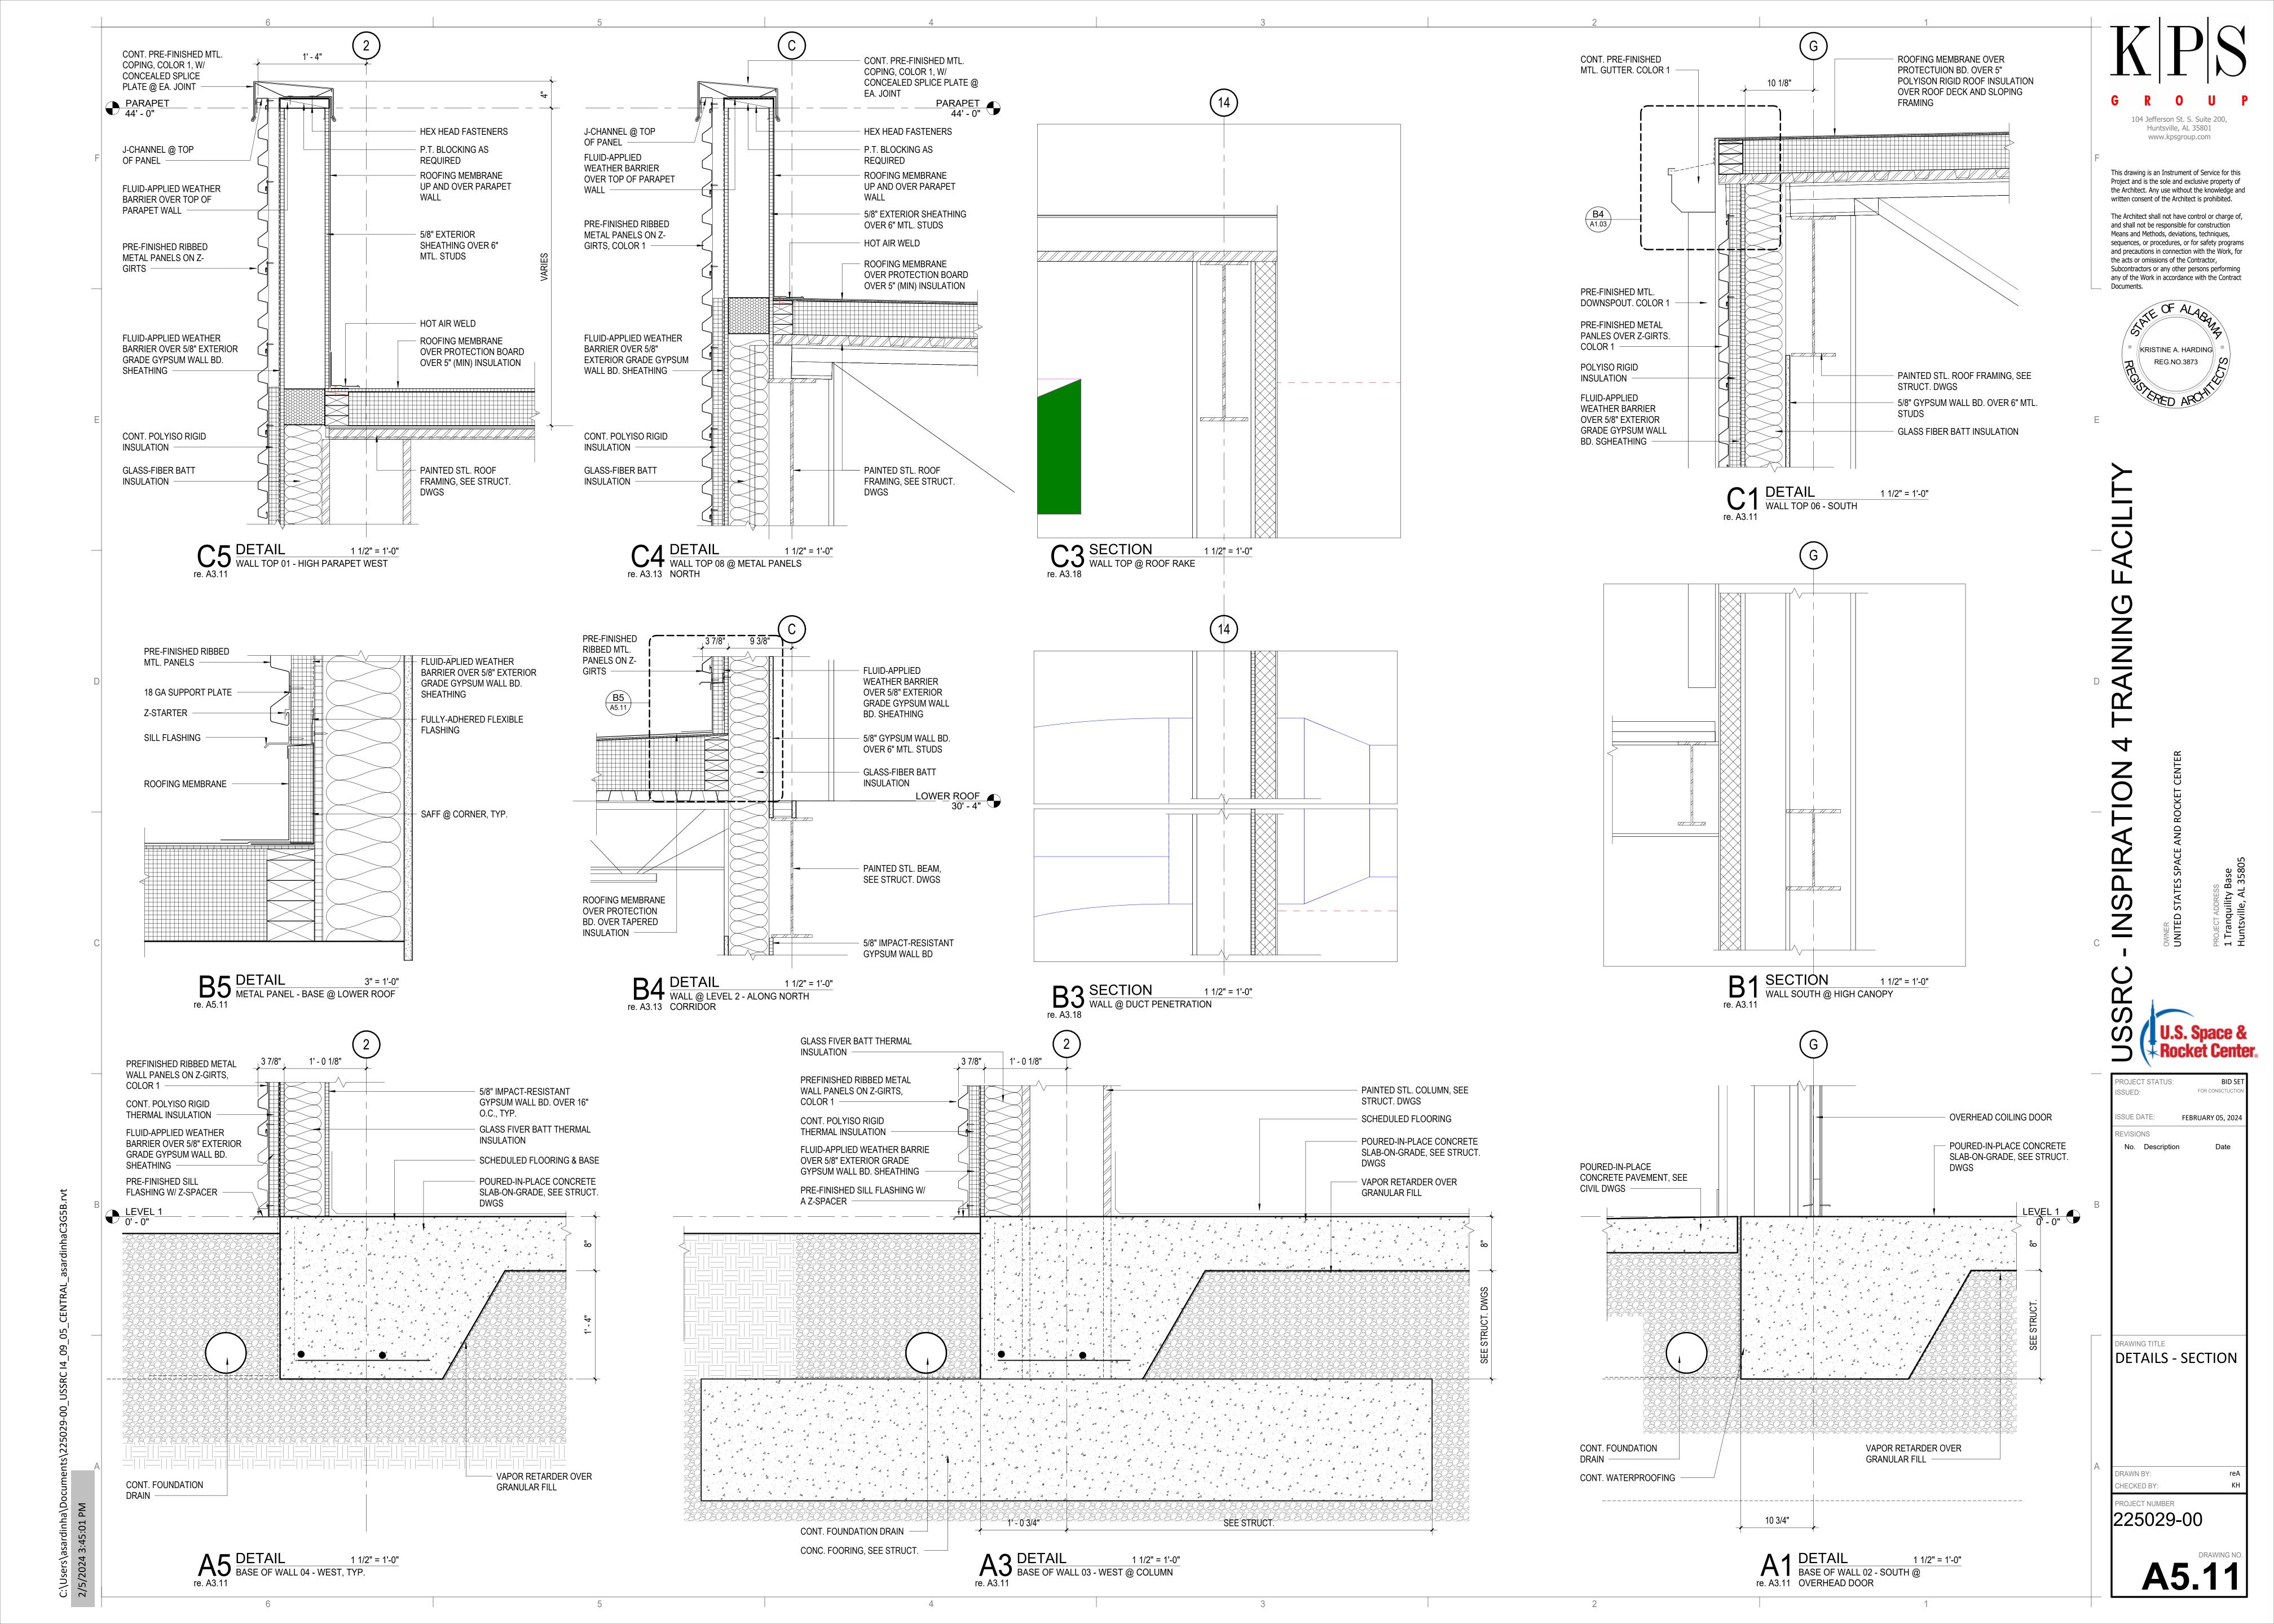
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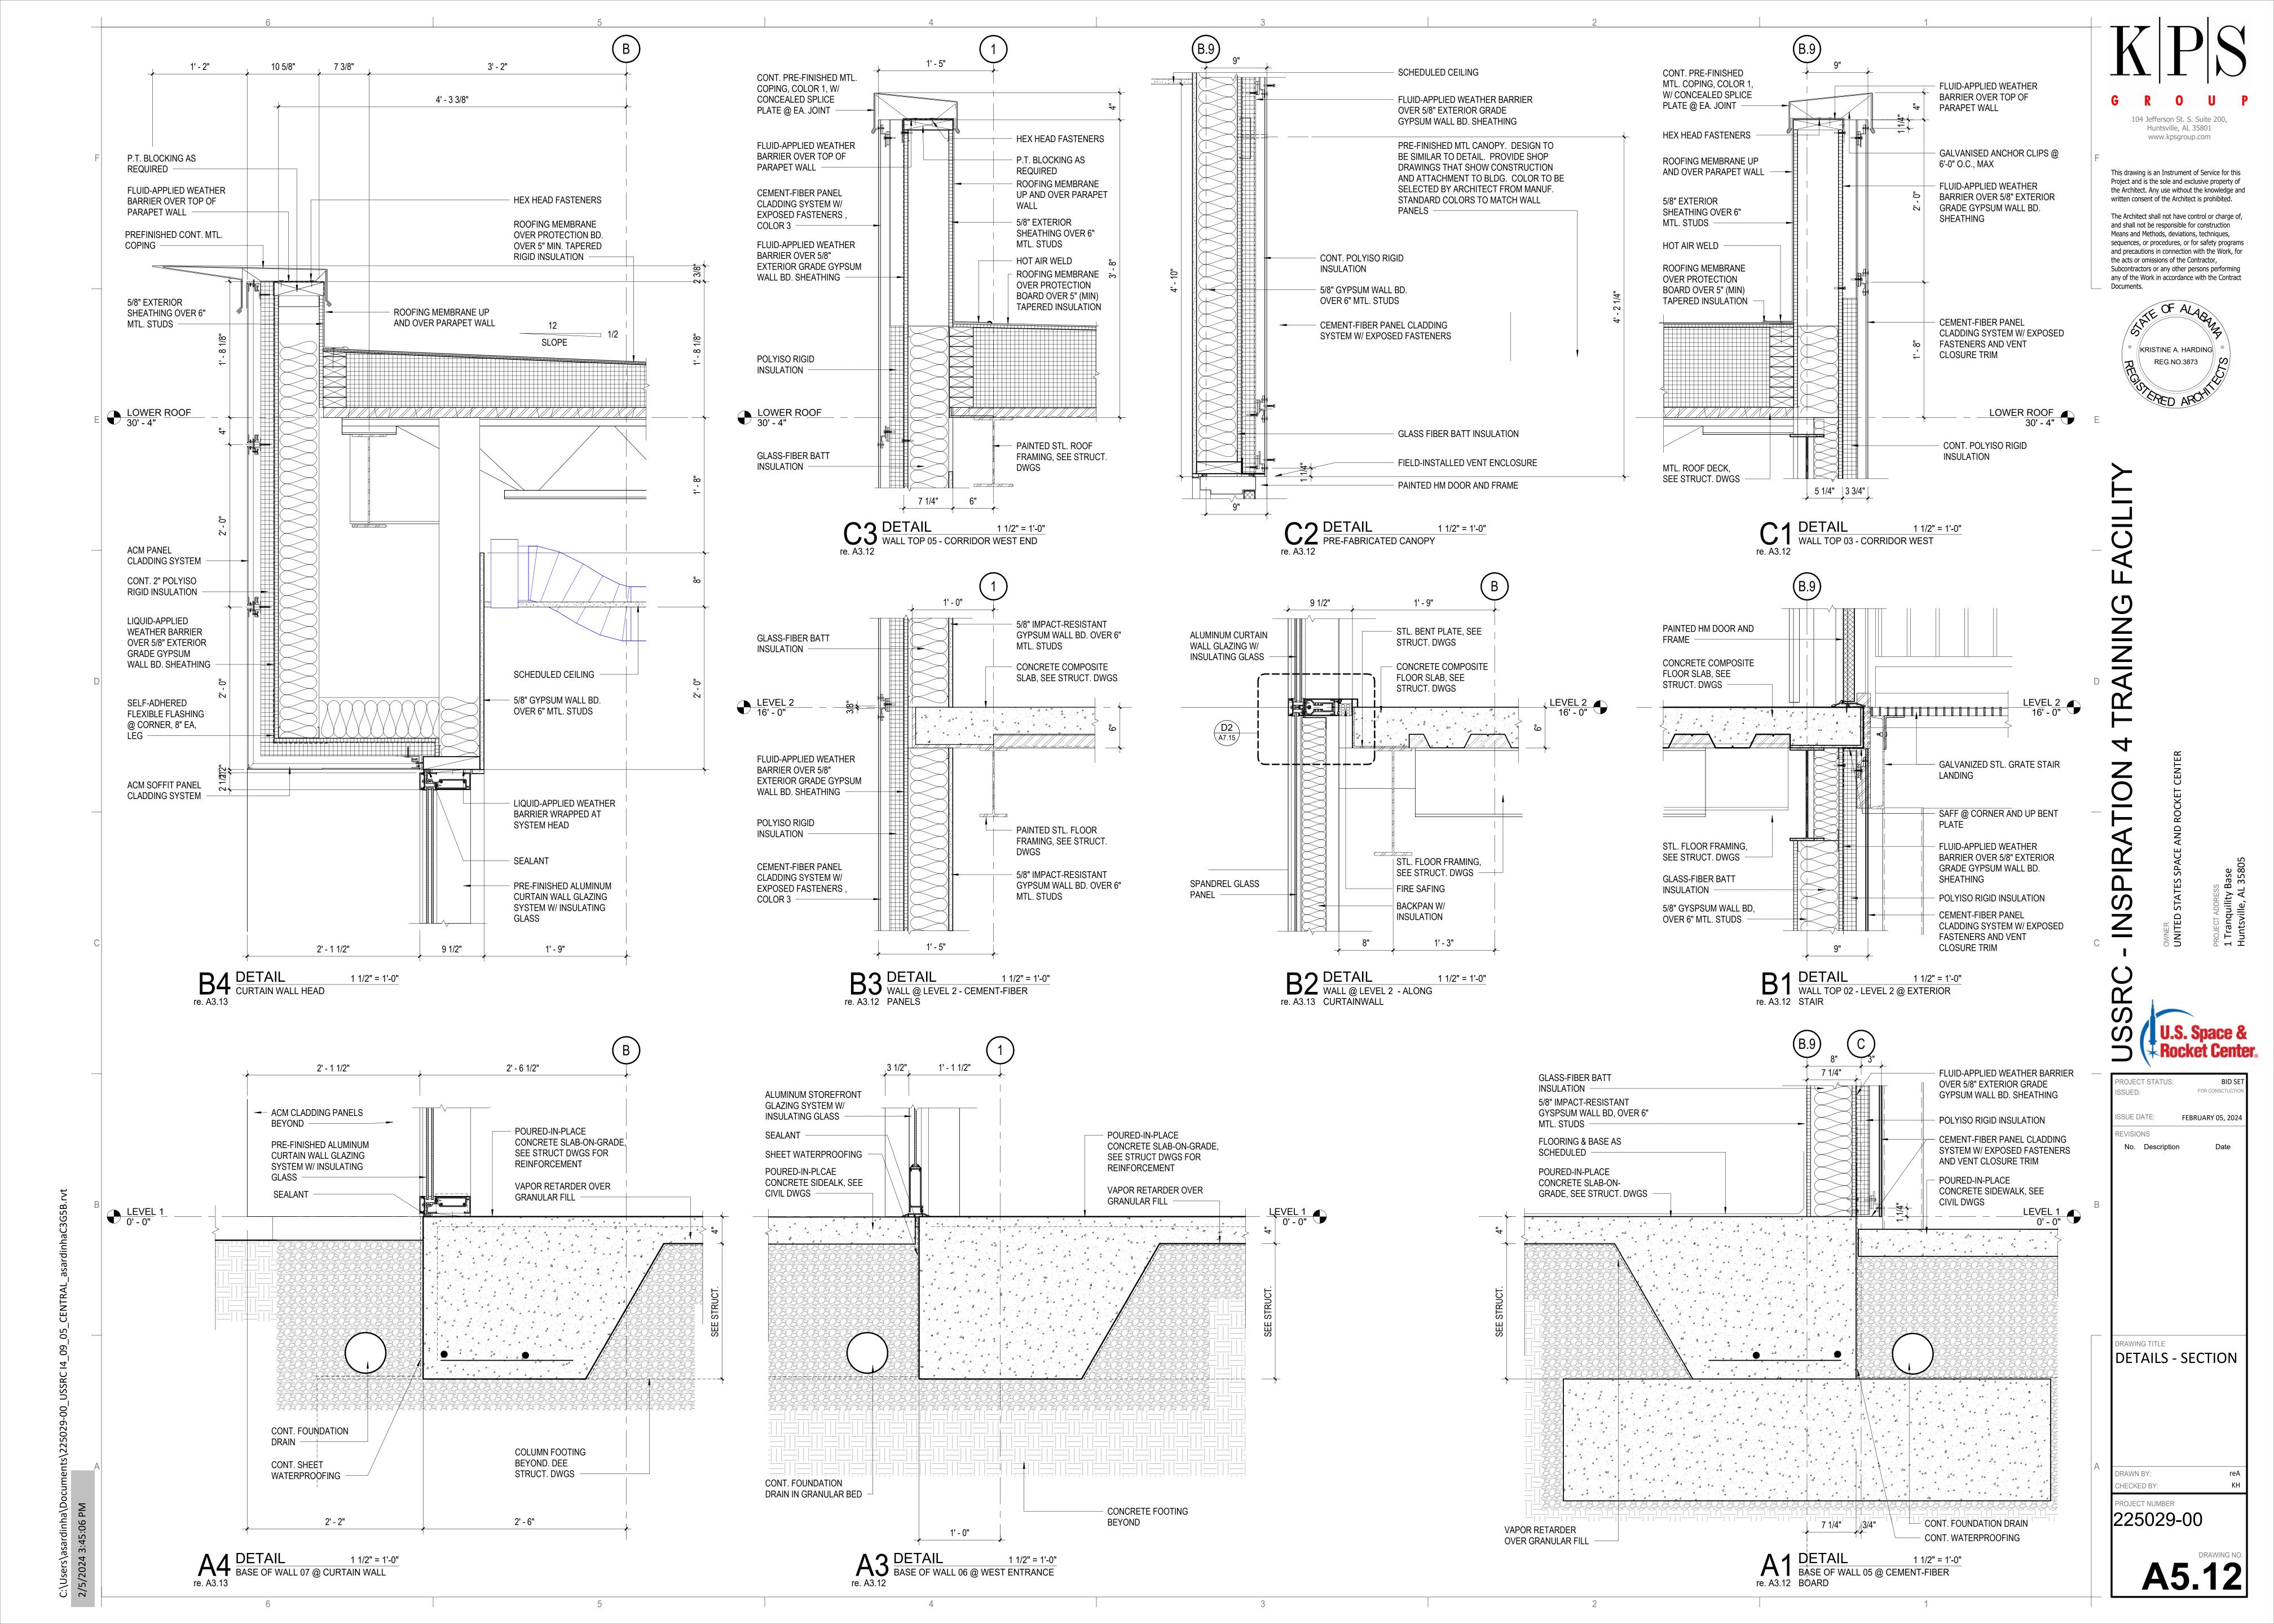
> KRISTINE A. HARDING REG.NO.3873

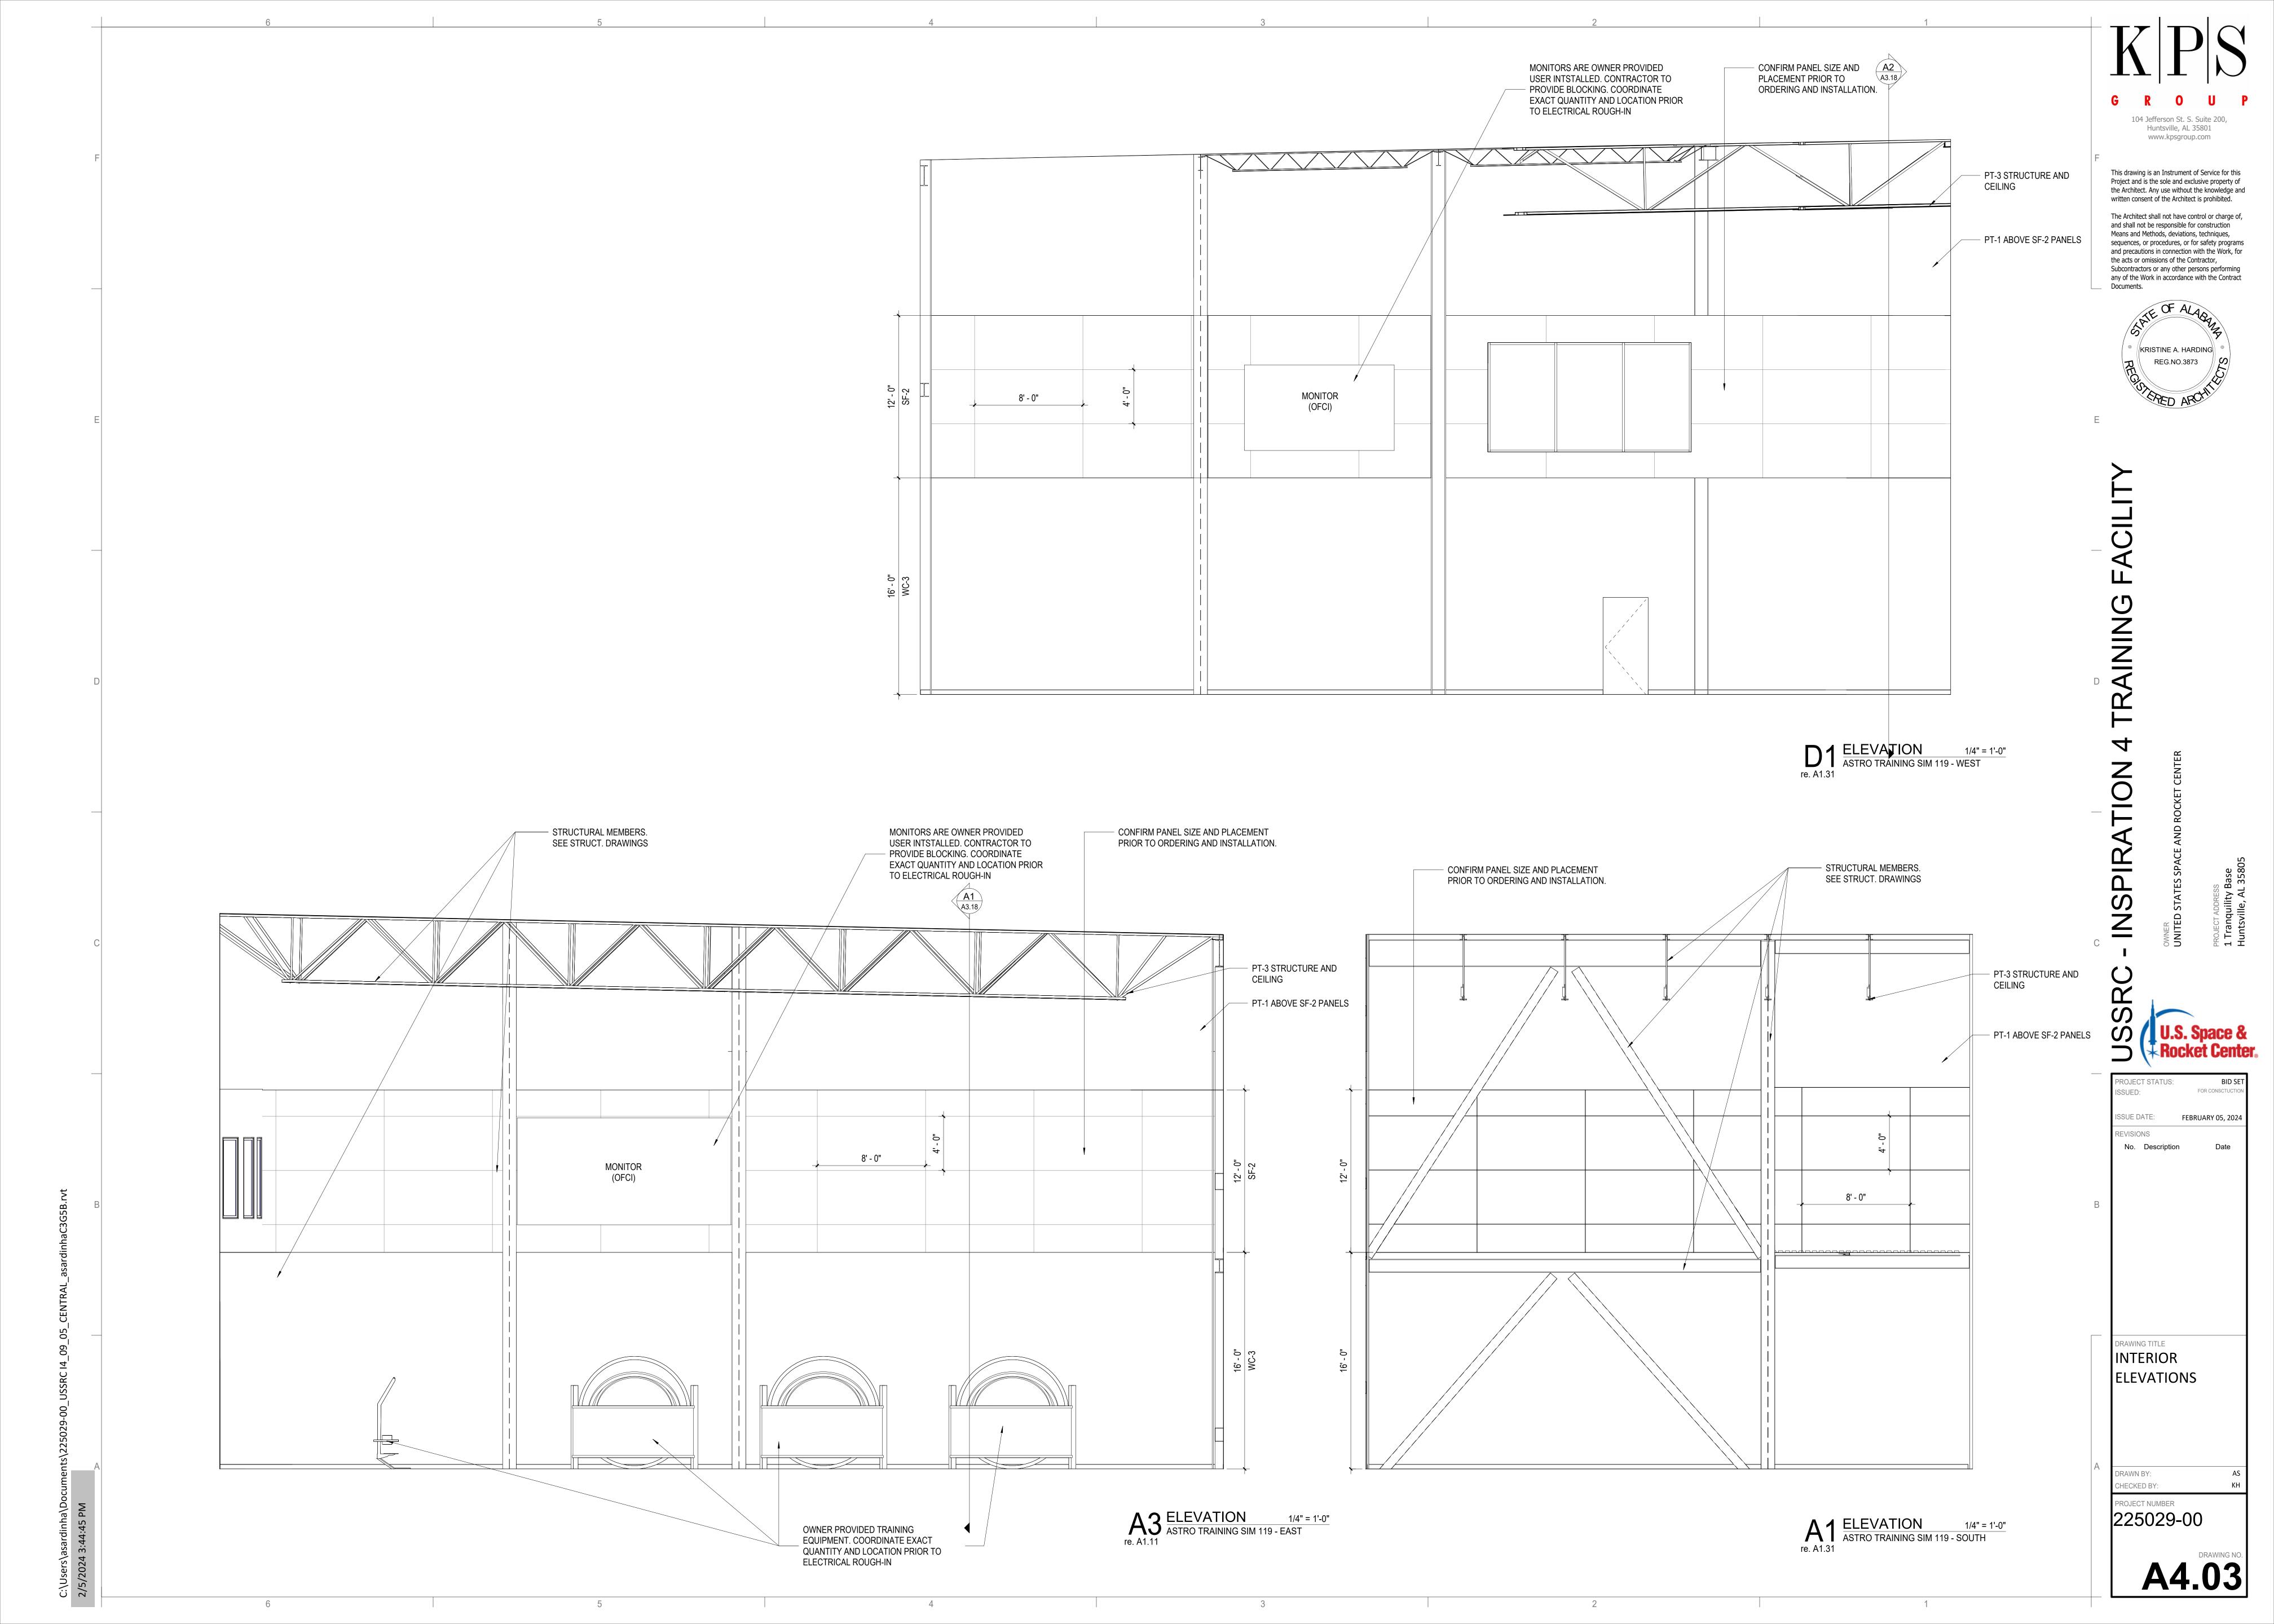FOR CONSCTUCTION FEBRUARY 05, 2024

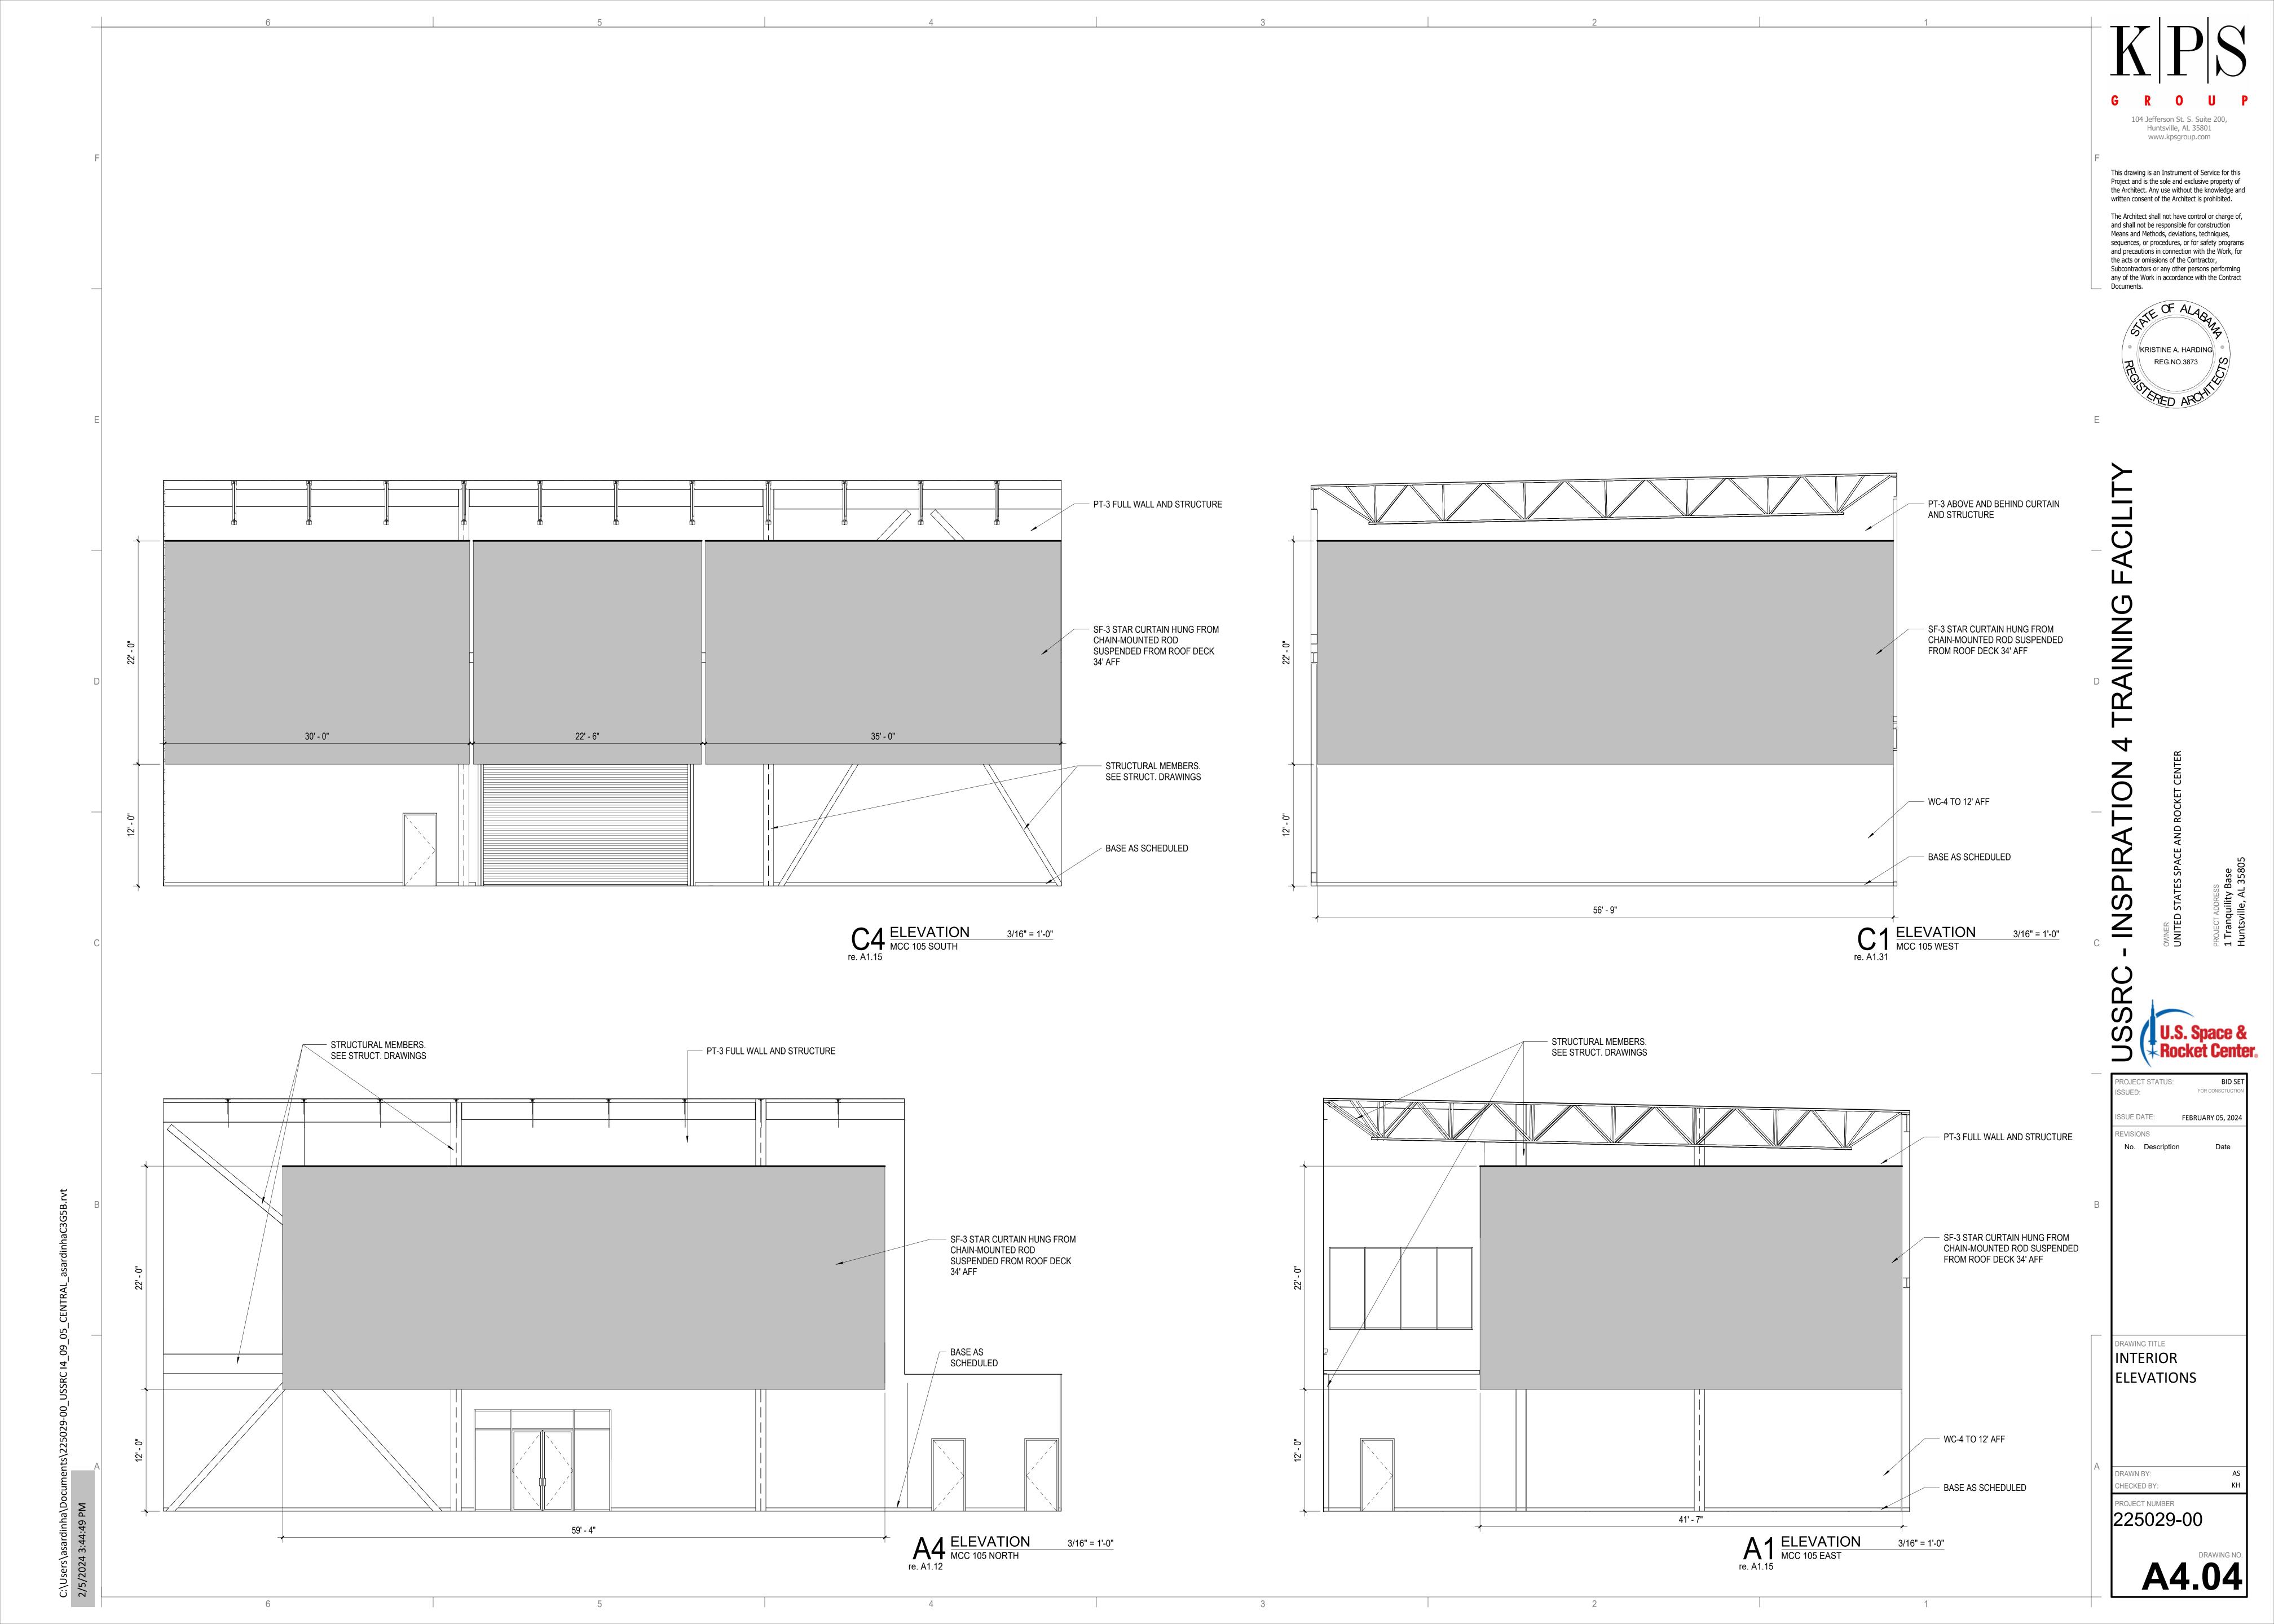Checker

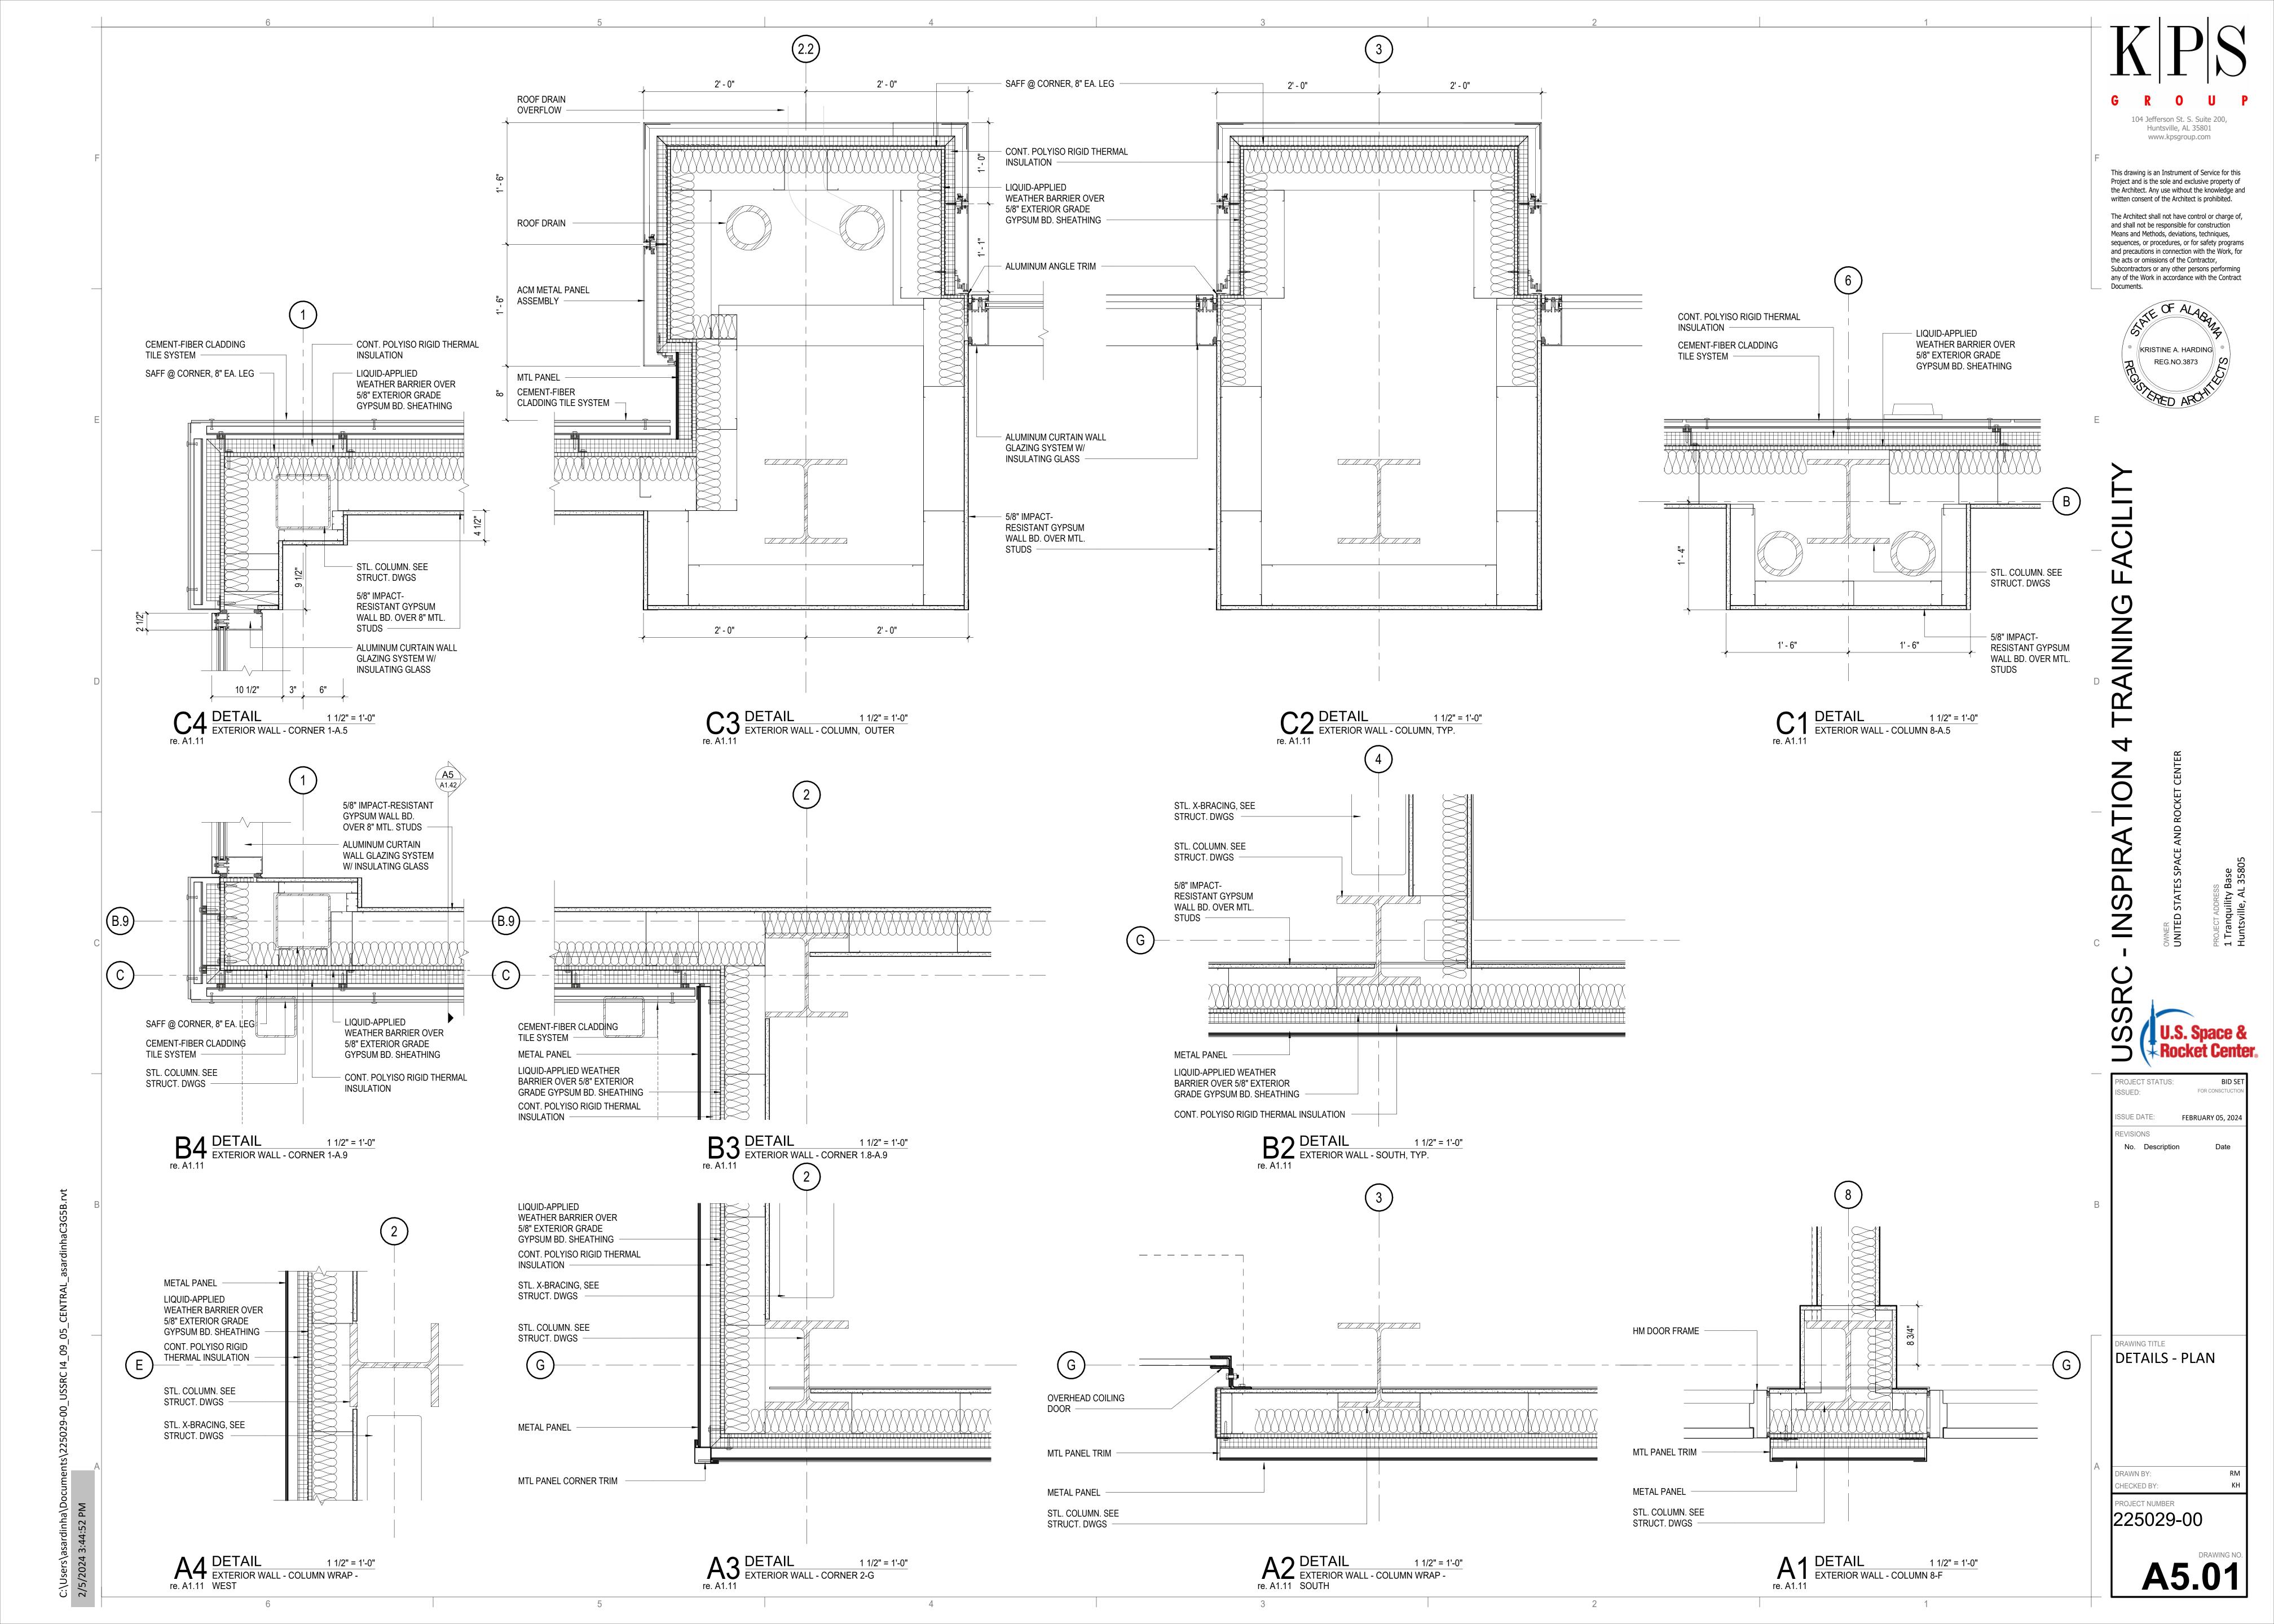A5.10

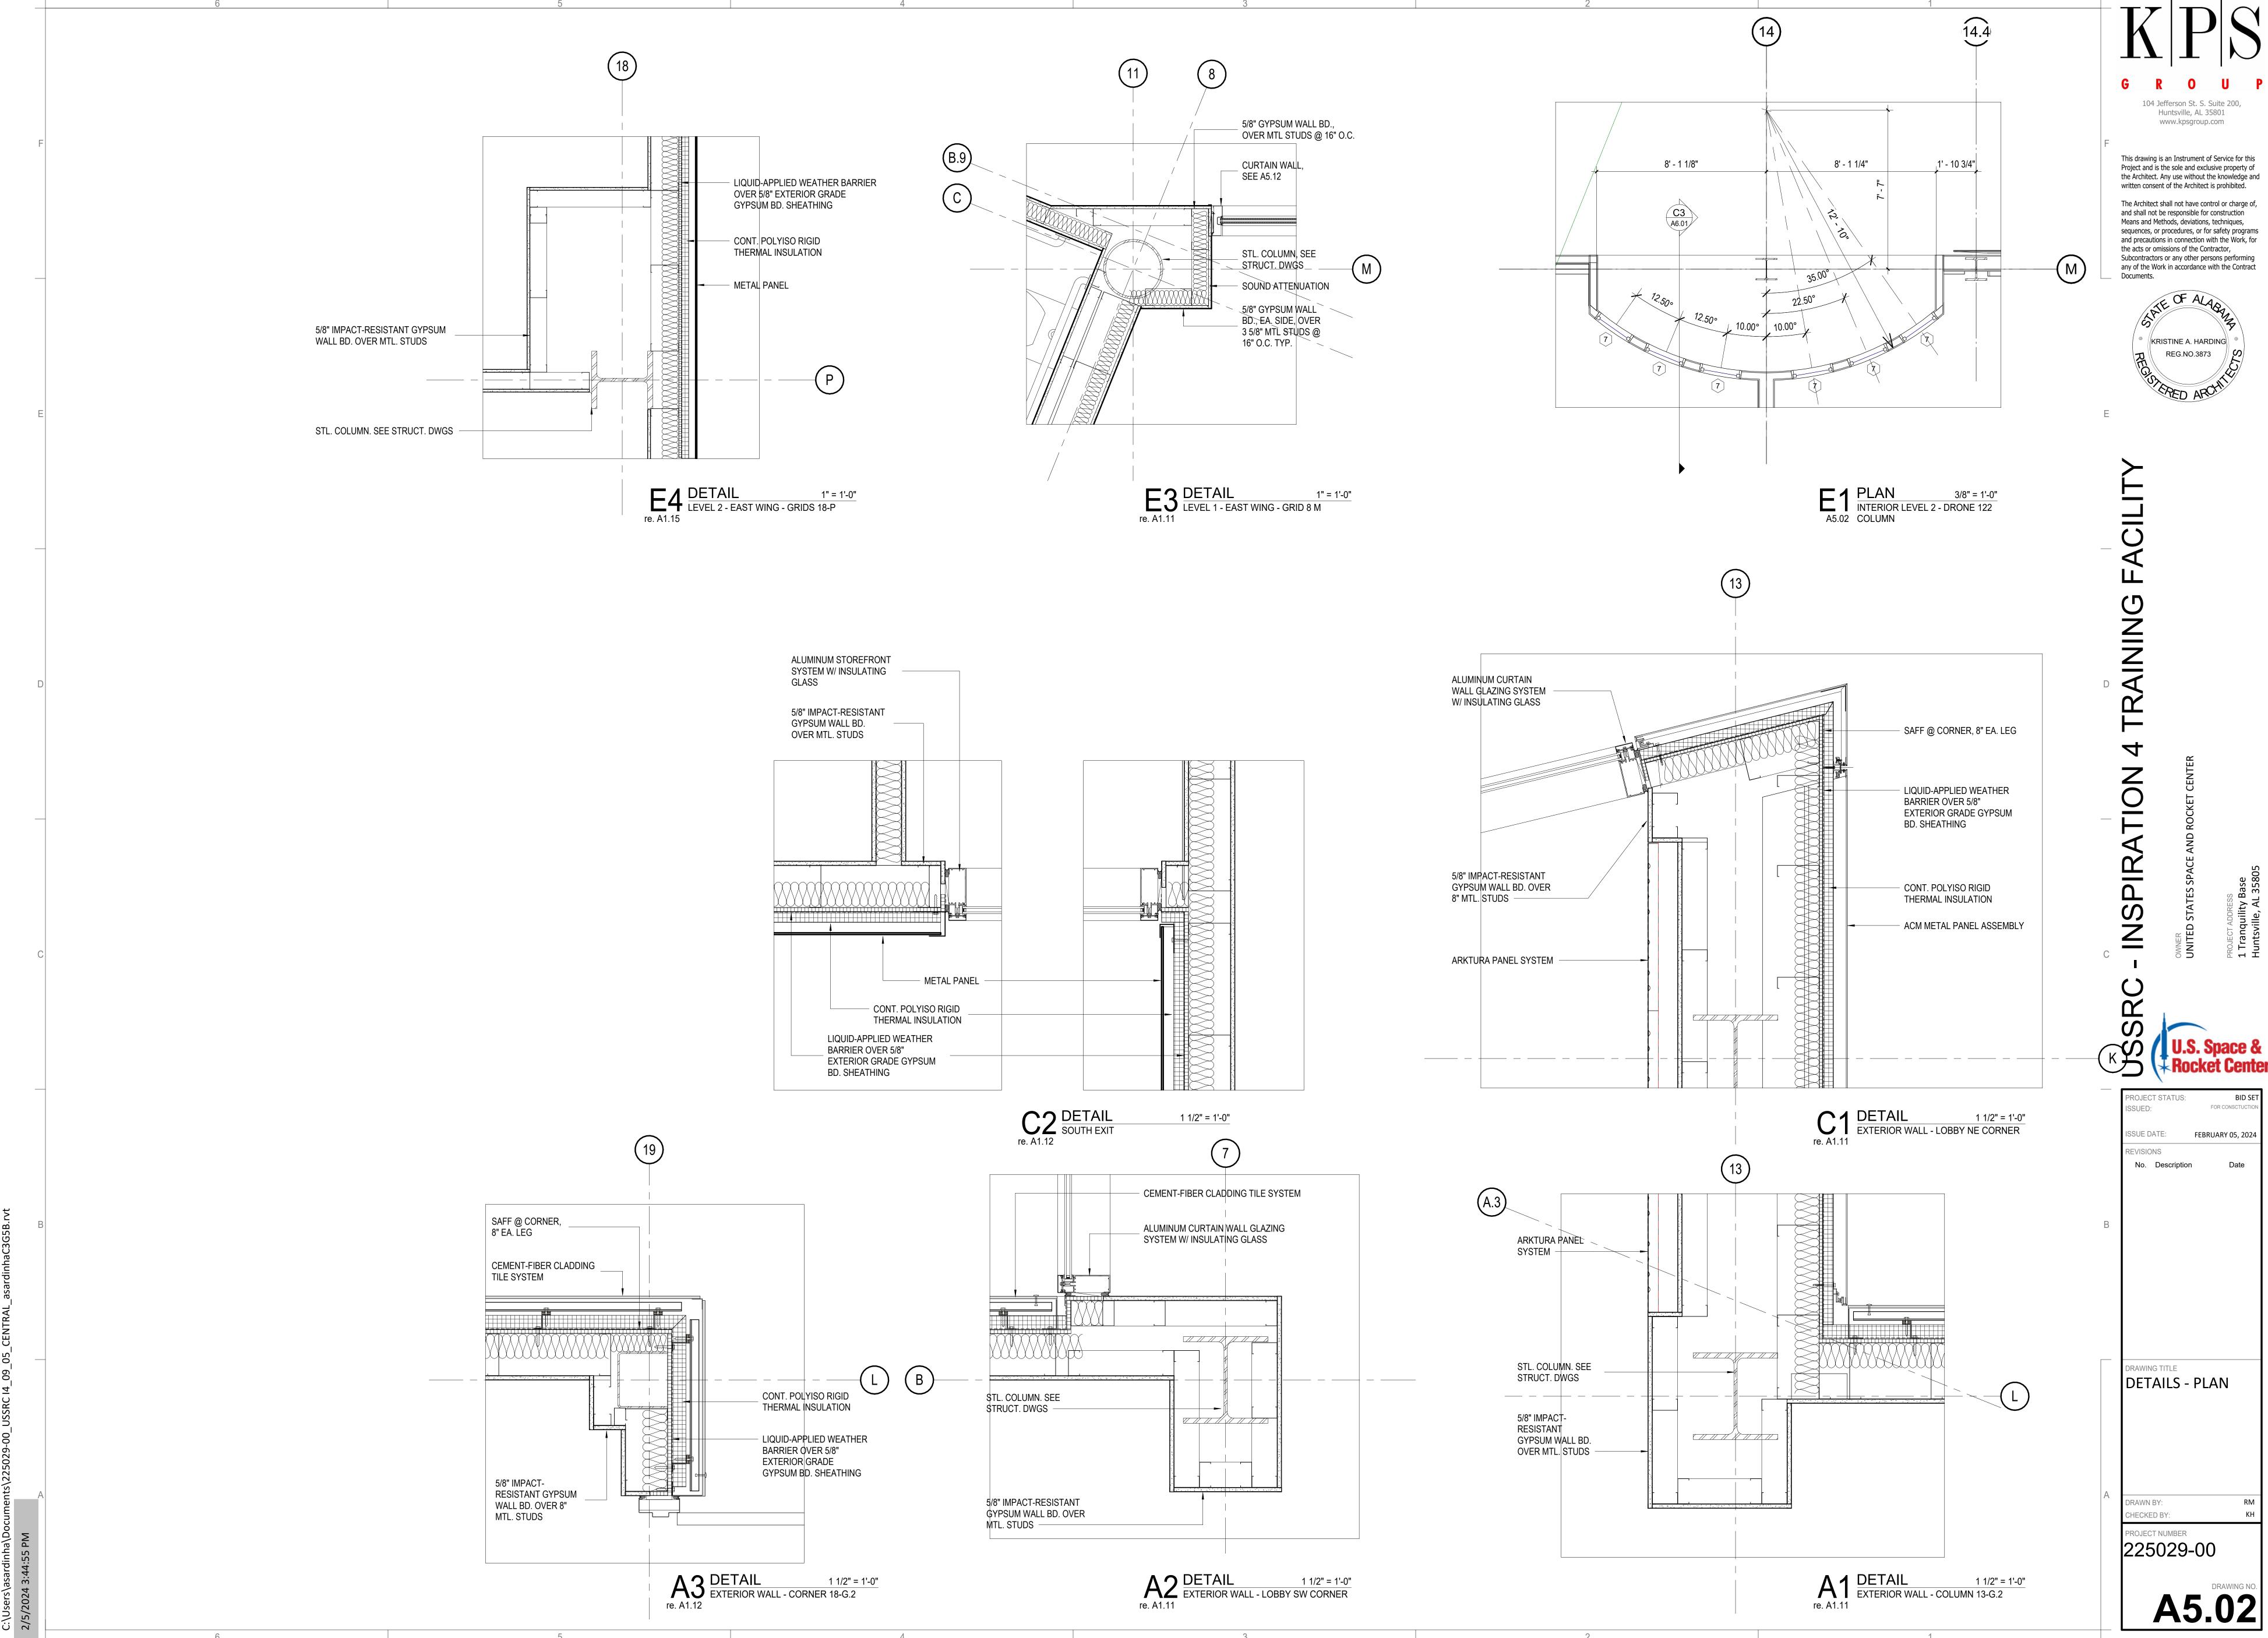

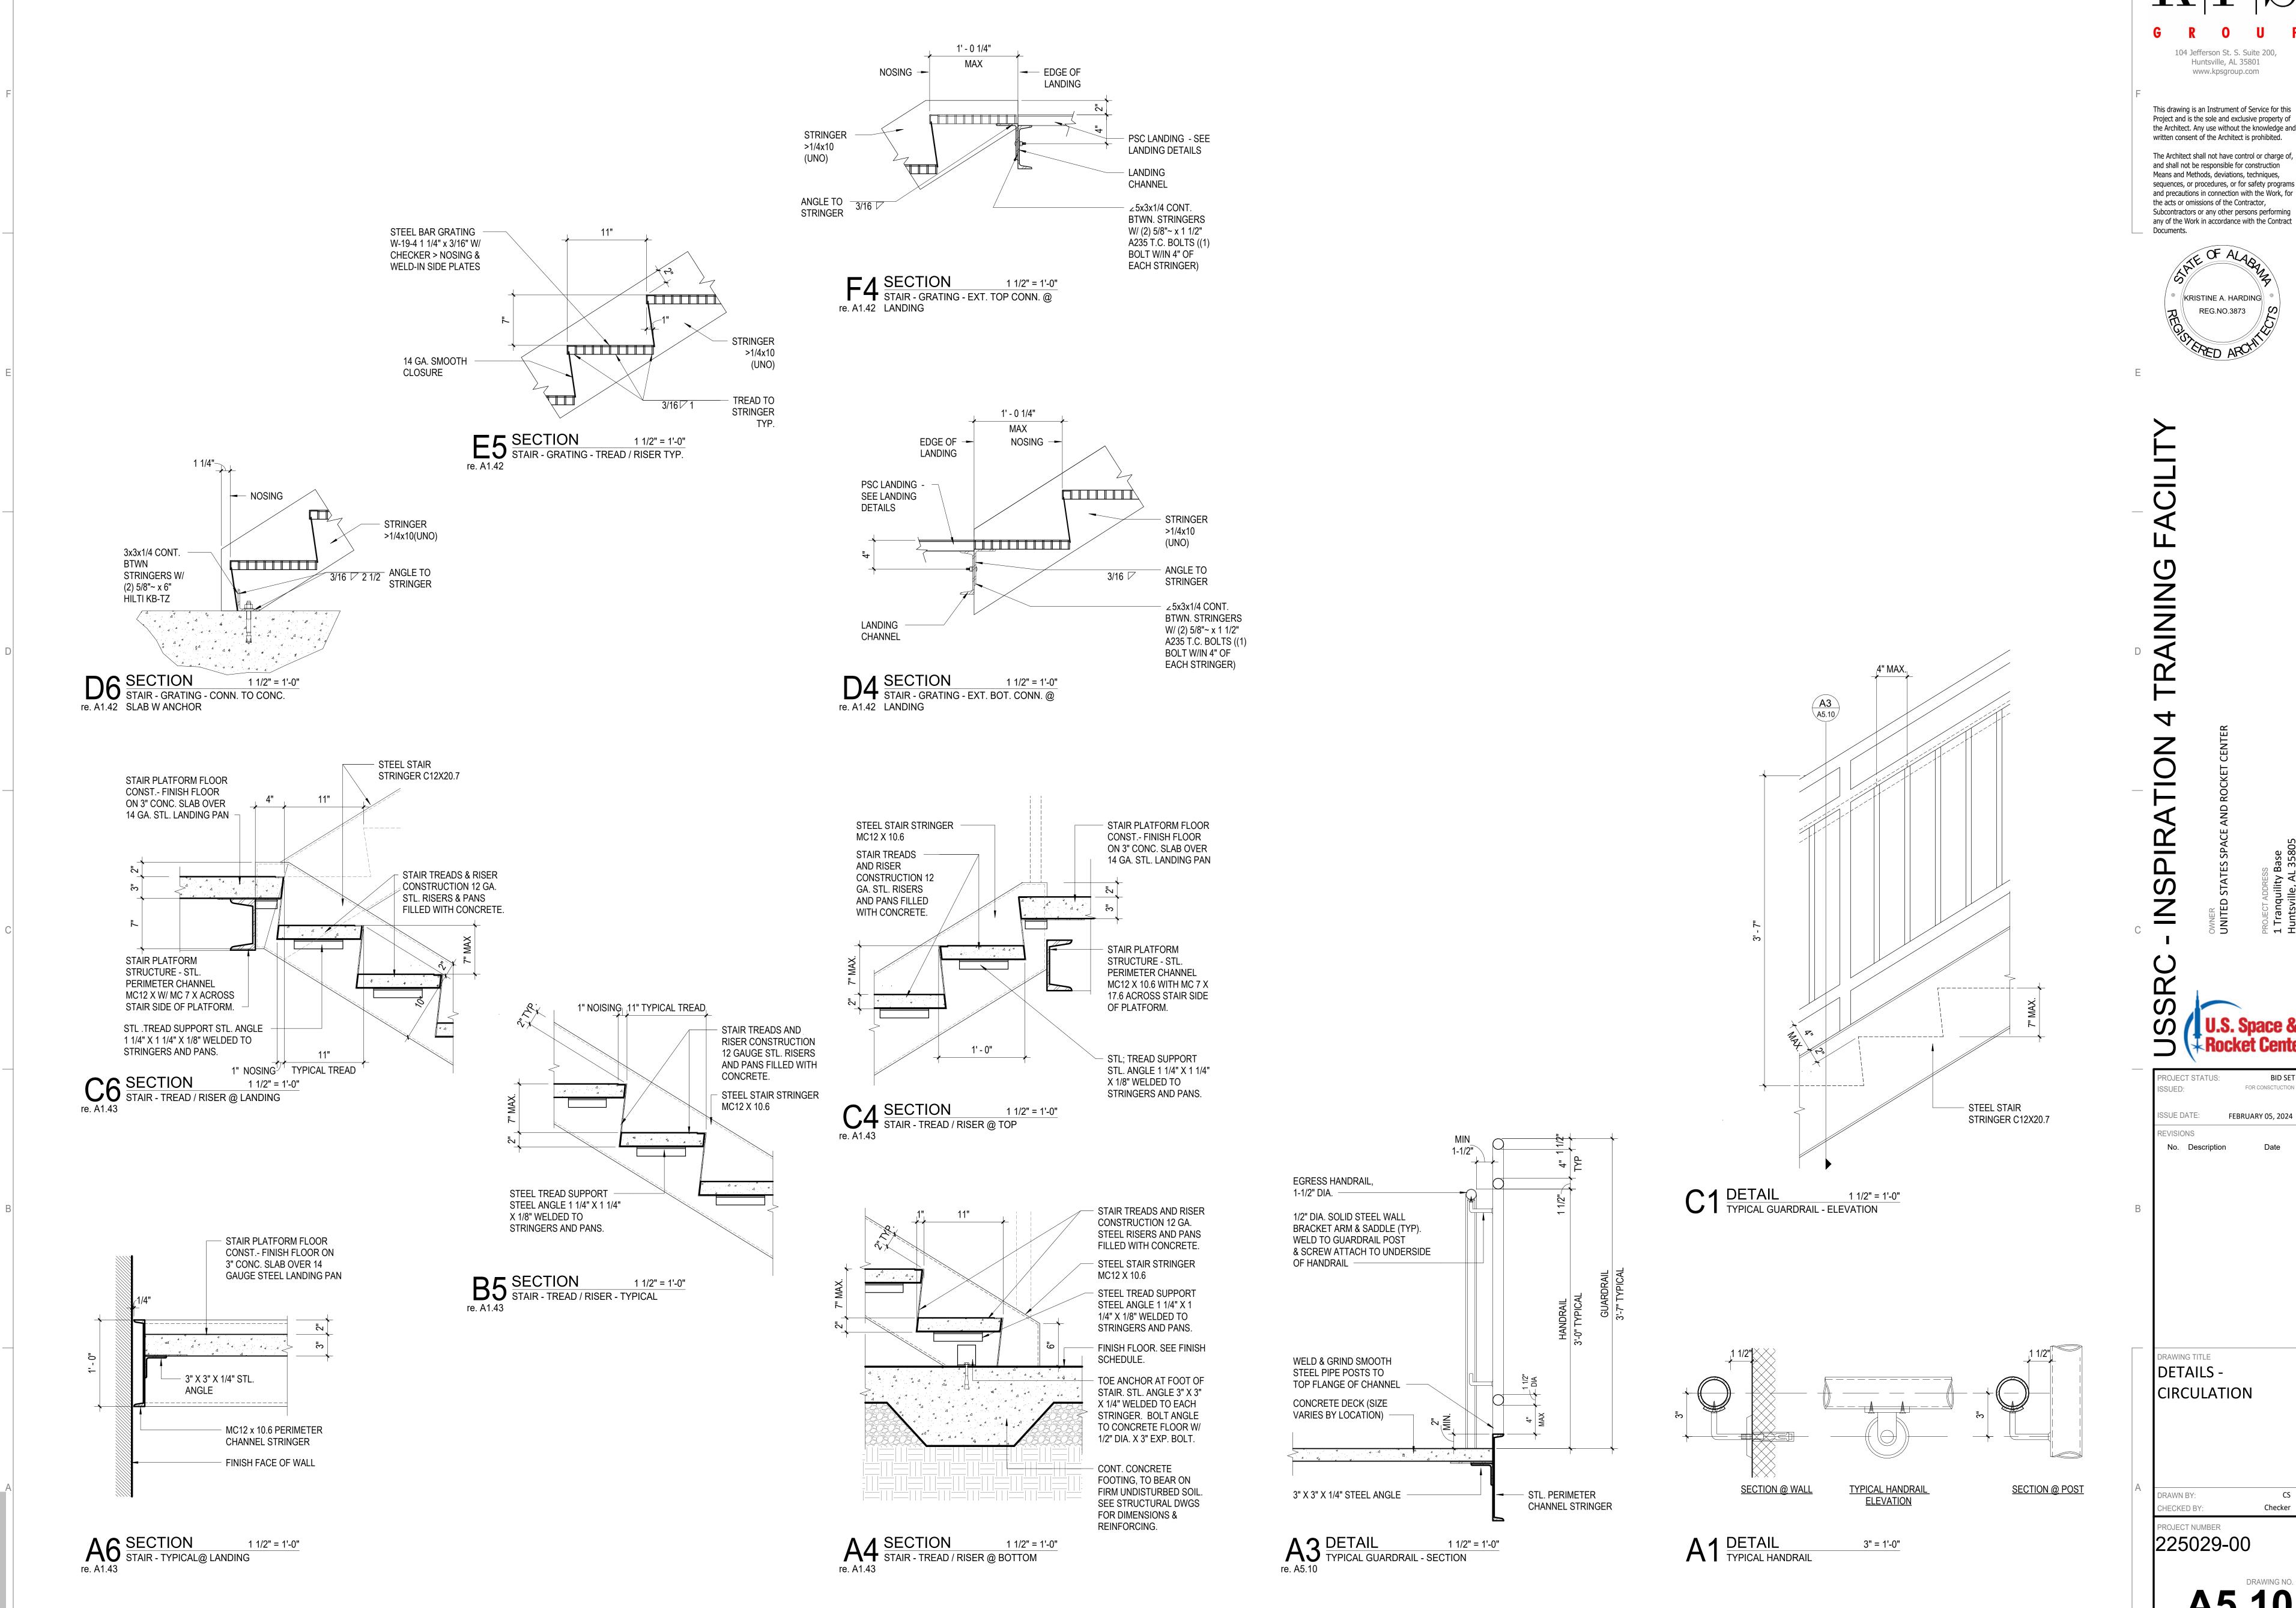

DRAWING TITLE DETAILS - INTERIOR

PAINTED 5/8" GYP BOARD

WIRE W/ TEE ANCHORED
 TO STRUCTURE ABOVE

ACOUSTICAL CEILING TILE ON
 SUSPENSION SYSTEM AS SCHEDULED

1 1/2" = 1'-0"

ON METAL STUDS

A1 DETAIL
GYP TO ACT

CHECKED BY:

PROJECT NUMBER 225029-00

LEVEL 2 16' - 0" _____ 5/8" GYPSUM WALL BD. OVER 3-5/8" MTL STUDS — SOUND ATTENUATION SCHEDULED CEILING

> C3 DETAIL 1 1/2" = 1
> ASTRO SIM BALCONY FLOOR AND CEIING 1 1/2" = 1'-0"





5/8" GYPSUM WALL BD. OVER 6" MTL STUDS

SOUND ATTENUATION -

SCHEDULED CEILING


A3 SECTION 1 1/2" = 1'-0"
SECTION DETAIL @ GYP SURROUND
W/ LINEAR LIGHT

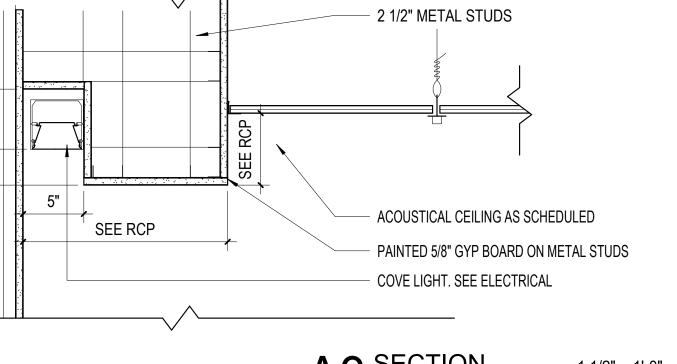

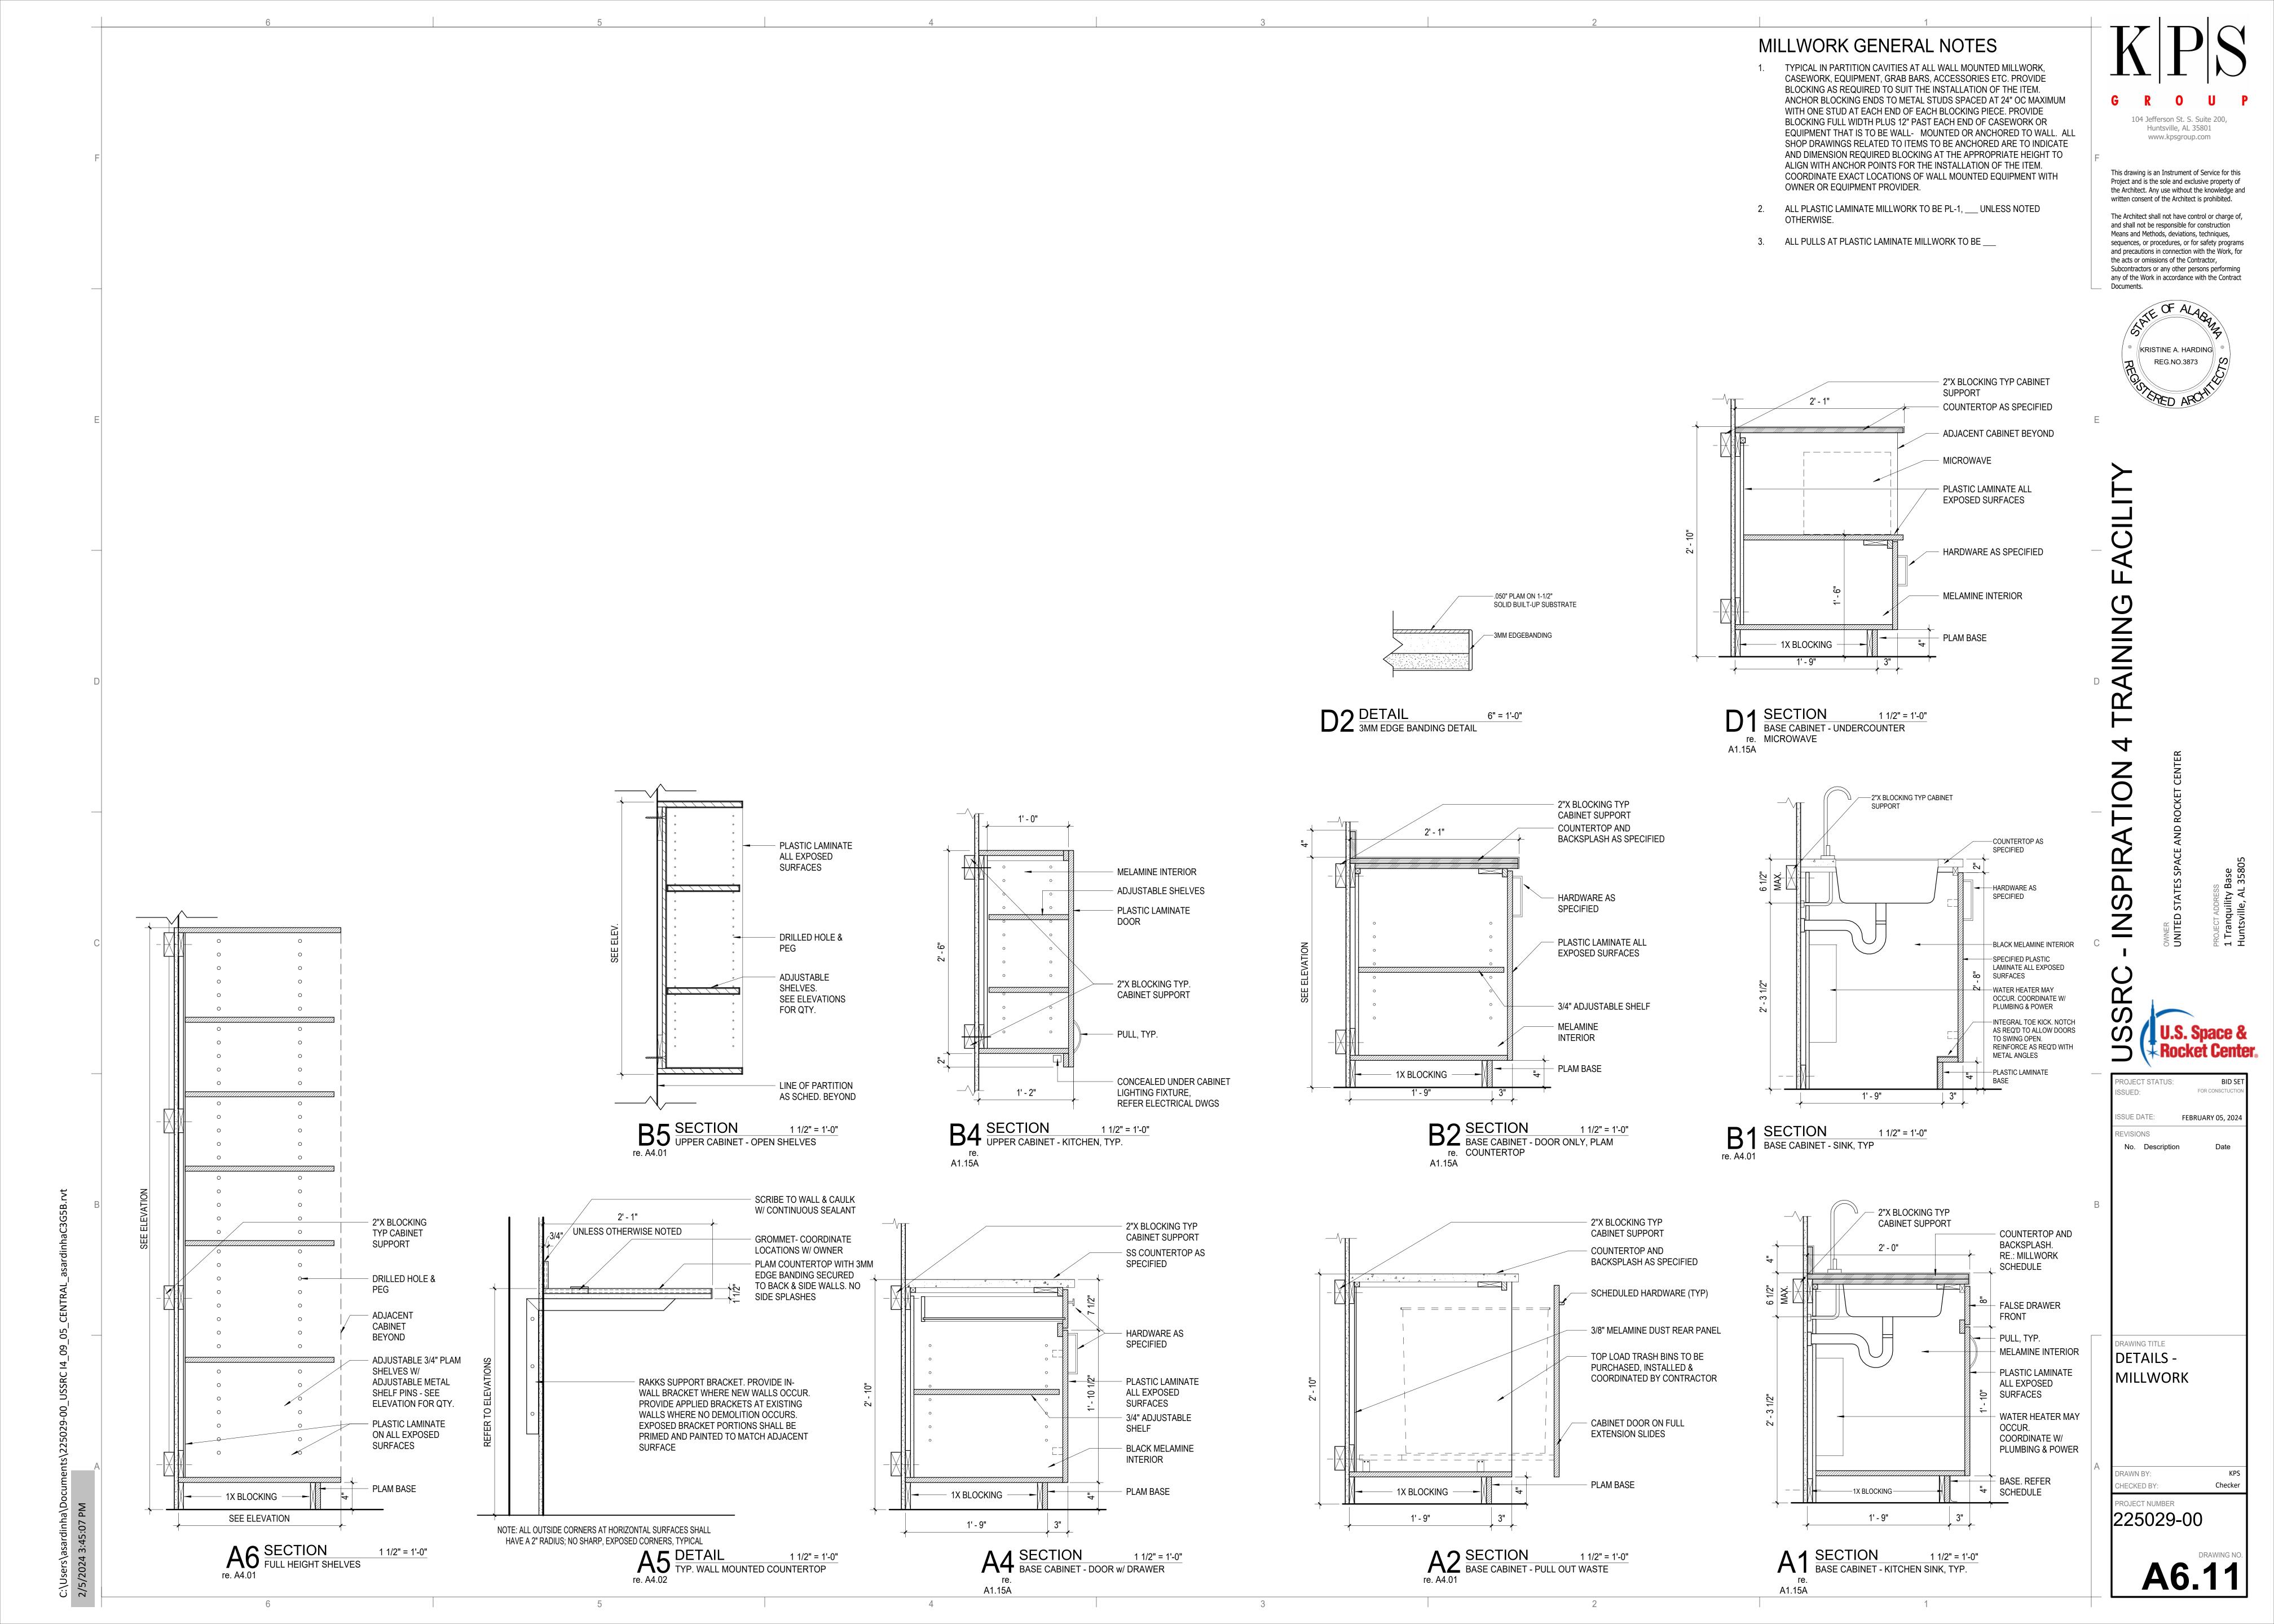

DOOR NOTES:

- 1. DO NOT SCALE DRAWINGS. DIMENSIONS ARE NOT ADJUSTABLE WITHOUT ARCHITECT'S APPROVAL, UNLESS NOTED OTHERWISE. REFER TO ARCHITECTURAL DRAFTING NOTES ON SHEET A0.01 FOR ADDITIONAL CLARIFICATIONS.
- 2. IF ANY ITEM OF WORK CANNOT BE LOCATED, DO NOT PROCEED WITH THE WORK BEFORE CLARIFYING WITH ARCHITECT.

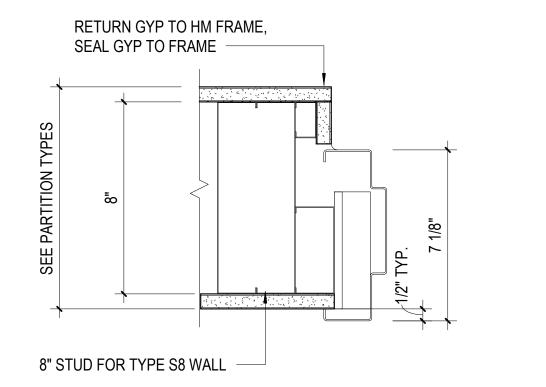


DOUBLE RABBET FIRE RATED
HM DOOR FRAME
DBL STUDS AT JAMBS, TYP.

TYPE "X" 5/8" GYP. BD. EA.
SIDE OF 3 5/8" METAL STUDS


2E DETAIL 3" = 1'-0"
DOOR HEAD/ JAMB - TYPE 'S8' WALL


1 E DETAIL 3" = 1'-0"
DOOR JAMB/HEAD 7 1/8"- TYPE 'S'
WALL RATED

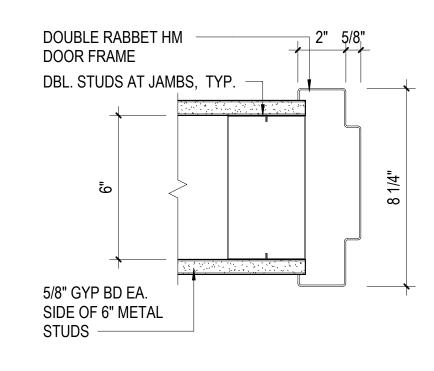

1D DETAIL 3" = 1'-0"

DOOR JAMB/HEAD 8 1/4"- TYPE 'S'

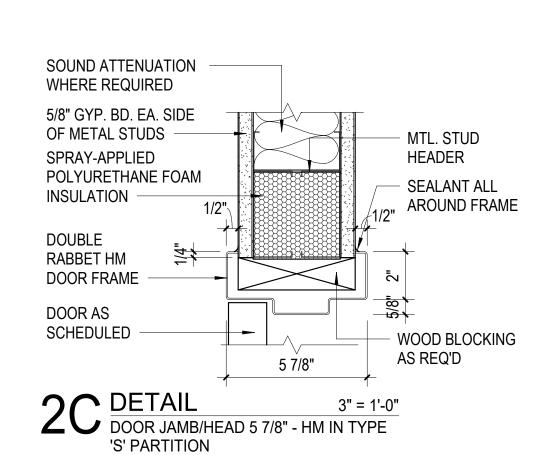

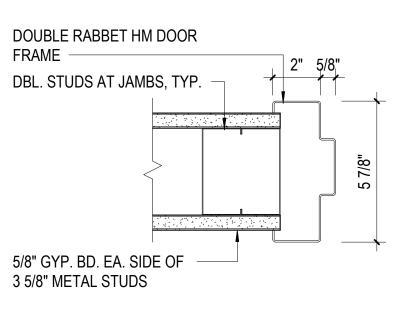


1 C DETAIL 3" = 1'-0"

DOOR JAMB/HEAD 5 7/8"- TYPE 'S'

WALL

DOOR FRAMING DIAGRAM

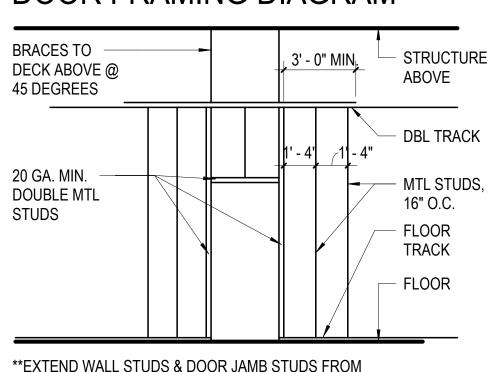

DOOR OPENING

**EXTEND WALL STUDS & DOOR JAMB STUDS FROM FLOOR TO DECK @ RATED WALLS. SEE PARTITION DETAILS SHEET FOR ADDITIONAL

2" SEE 2" 2" SEE 2" 2" SEE 2" SCHEDULE SCHEDULE

DOOR TYPES

SOUND ATTENUATION

5/8" GYP. BD. EA. SIDE

POLYURETHANE FOAM

- SEALANT ALL

AROUND FRAME

- WOOD BLOCKING

AS REQ'D

3" = 1'-0"

8 1/4"

OOR JAMB/HEAD - 8 1/4" HM IN TYPE

2 DETAIL

'S' PARTITION

WHERE REQUIRED

OF METAL STUDS

SPRAY-APPLIED

INSULATION


RABBET HM

DOOR FRAME

SCHEDULED

DOOR AS

DOUBLE

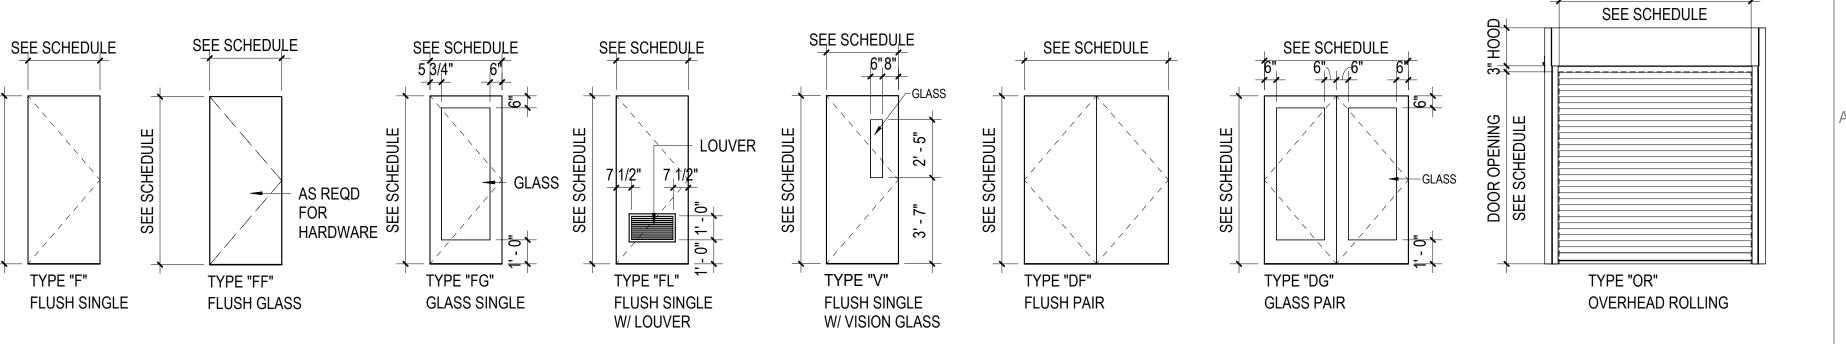

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ACILITY

ACILITY

ACILITY

ARCHIT

INSPIRATION 4 TRAINING

OWNER PROJECT STATE OF THE PRO

PROJECT STATUS: BID SET ISSUED: FOR CONSCTUCTION

ISSUE DATE: FEBRUARY 05, 2024

REVISIONS

No. Description Date

DRAWING TITLE

DOORS -

DOORS SCHEDULE, TYPES &
DETAILS

DRAWN BY:
CHECKED BY:
Author
Checker

PROJECT NUMBER
225029-00

A7.0

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NING

INSPIRA

ROJECT STATUS:

No. Description


SSUE DATE:

REVISIONS


BID SET

FOR CONSCTUCTION


FEBRUARY 05, 2024

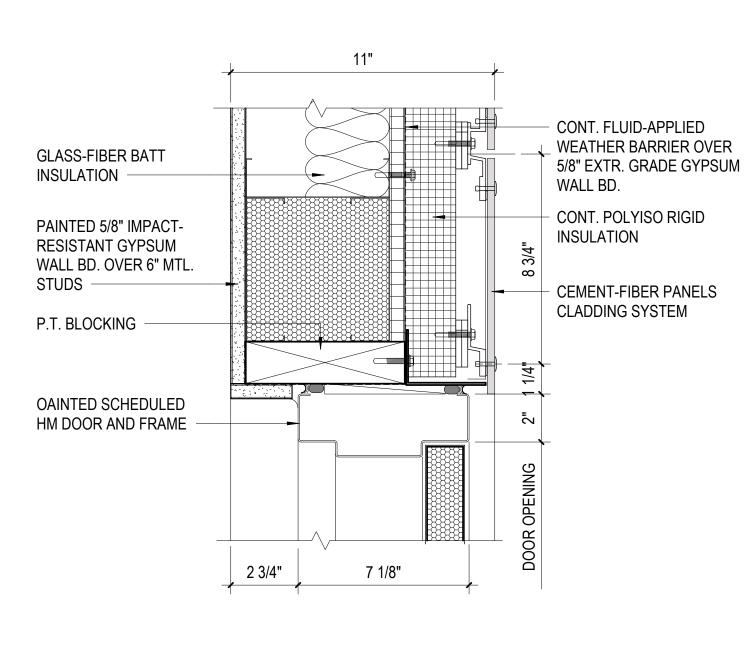


C2 DETAIL 3" = EXTERIOR HM DOOR @ FIBER-CEMENT PANELS - HEAD 3" = 1'-0"

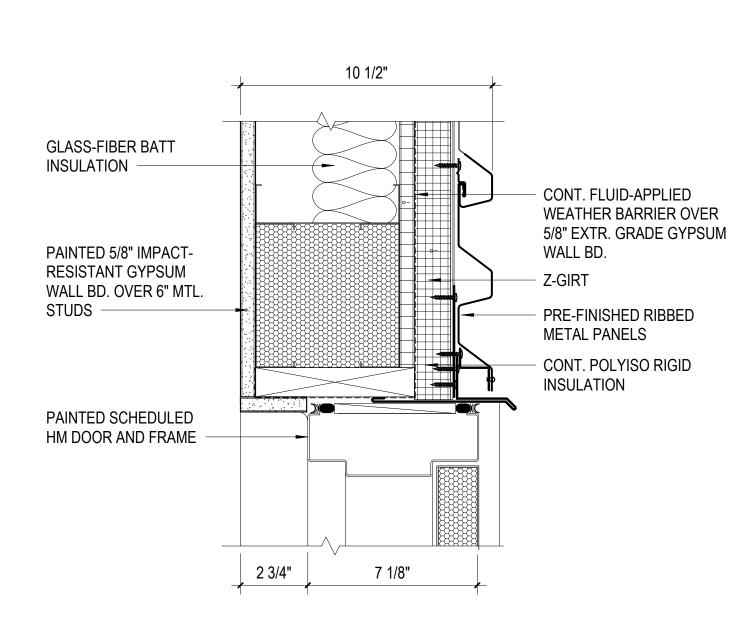


C1 DETAIL 3" = 1'-0" EXTERIOR HM DOOR @ METAL PANELS - HEAD

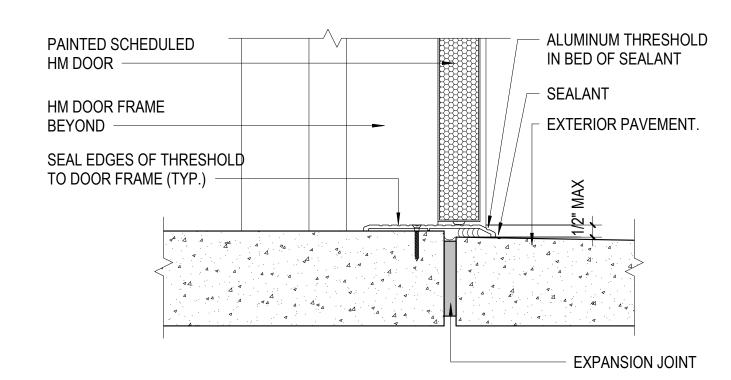

B1 DETAIL EXTERIOR HM DOOR - SILL 3" = 1'-0"

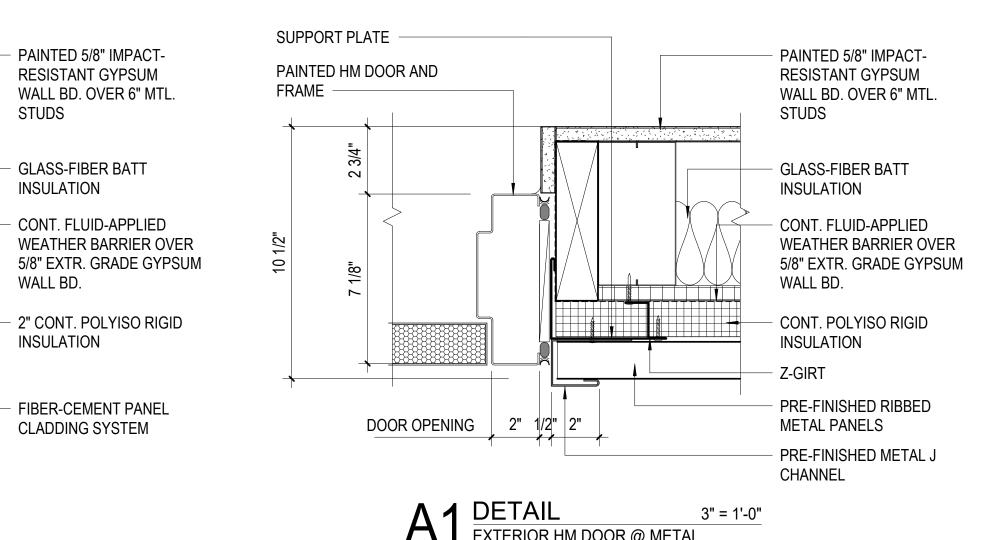

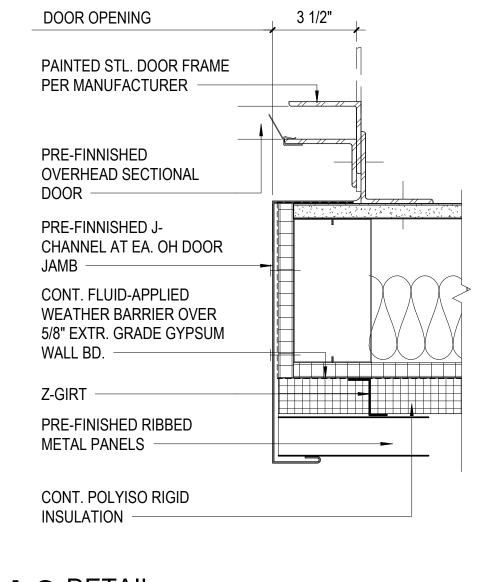

A3 DETAIL OVERHEAD DOOR - JAMB 3" = 1'-0" A2 DETAIL 3" EXTERIOR HM DOOR @ CEMENT-FIBER PANELS - JAMB 3" = 1'-0"

PAINTED HM DOOR AND

DOOR OPENING

FRAME

A1 DETAIL 3"
EXTERIOR HM DOOR @ METAL PANELS - JAMB


DOORS - DETAILS


RAWN BY:

CHECKED BY:

PROJECT NUMBER

225029-00

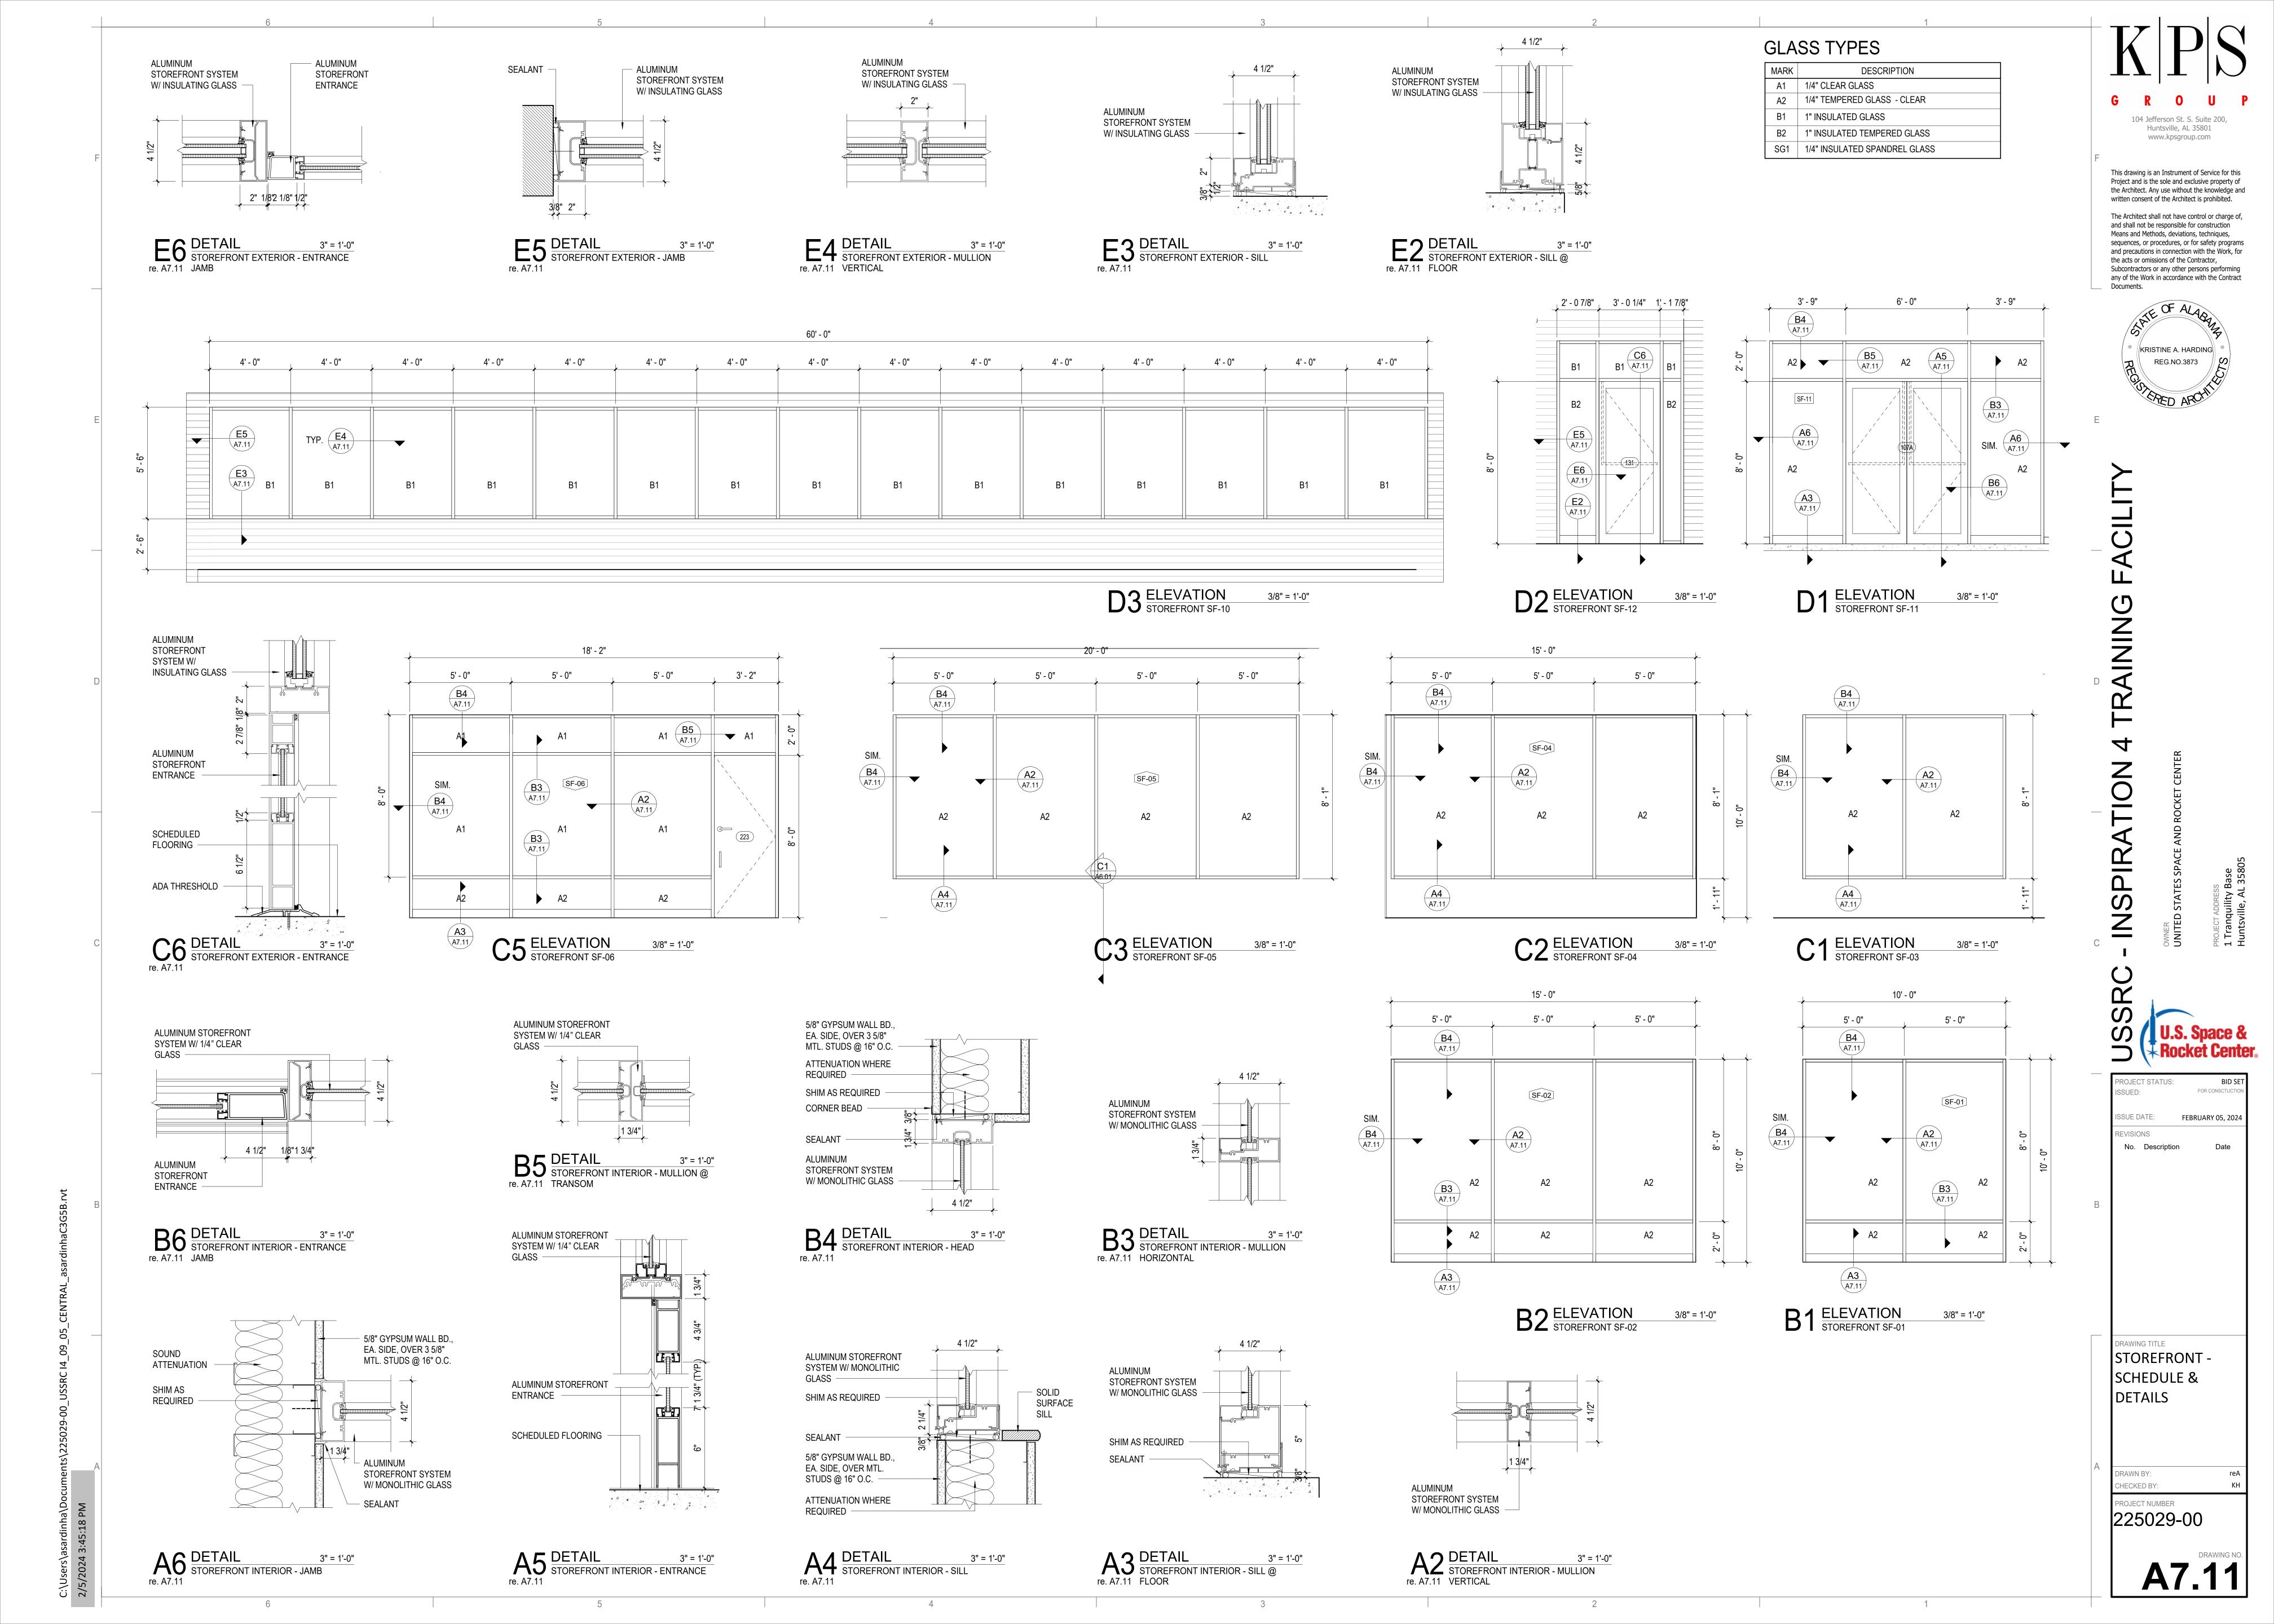

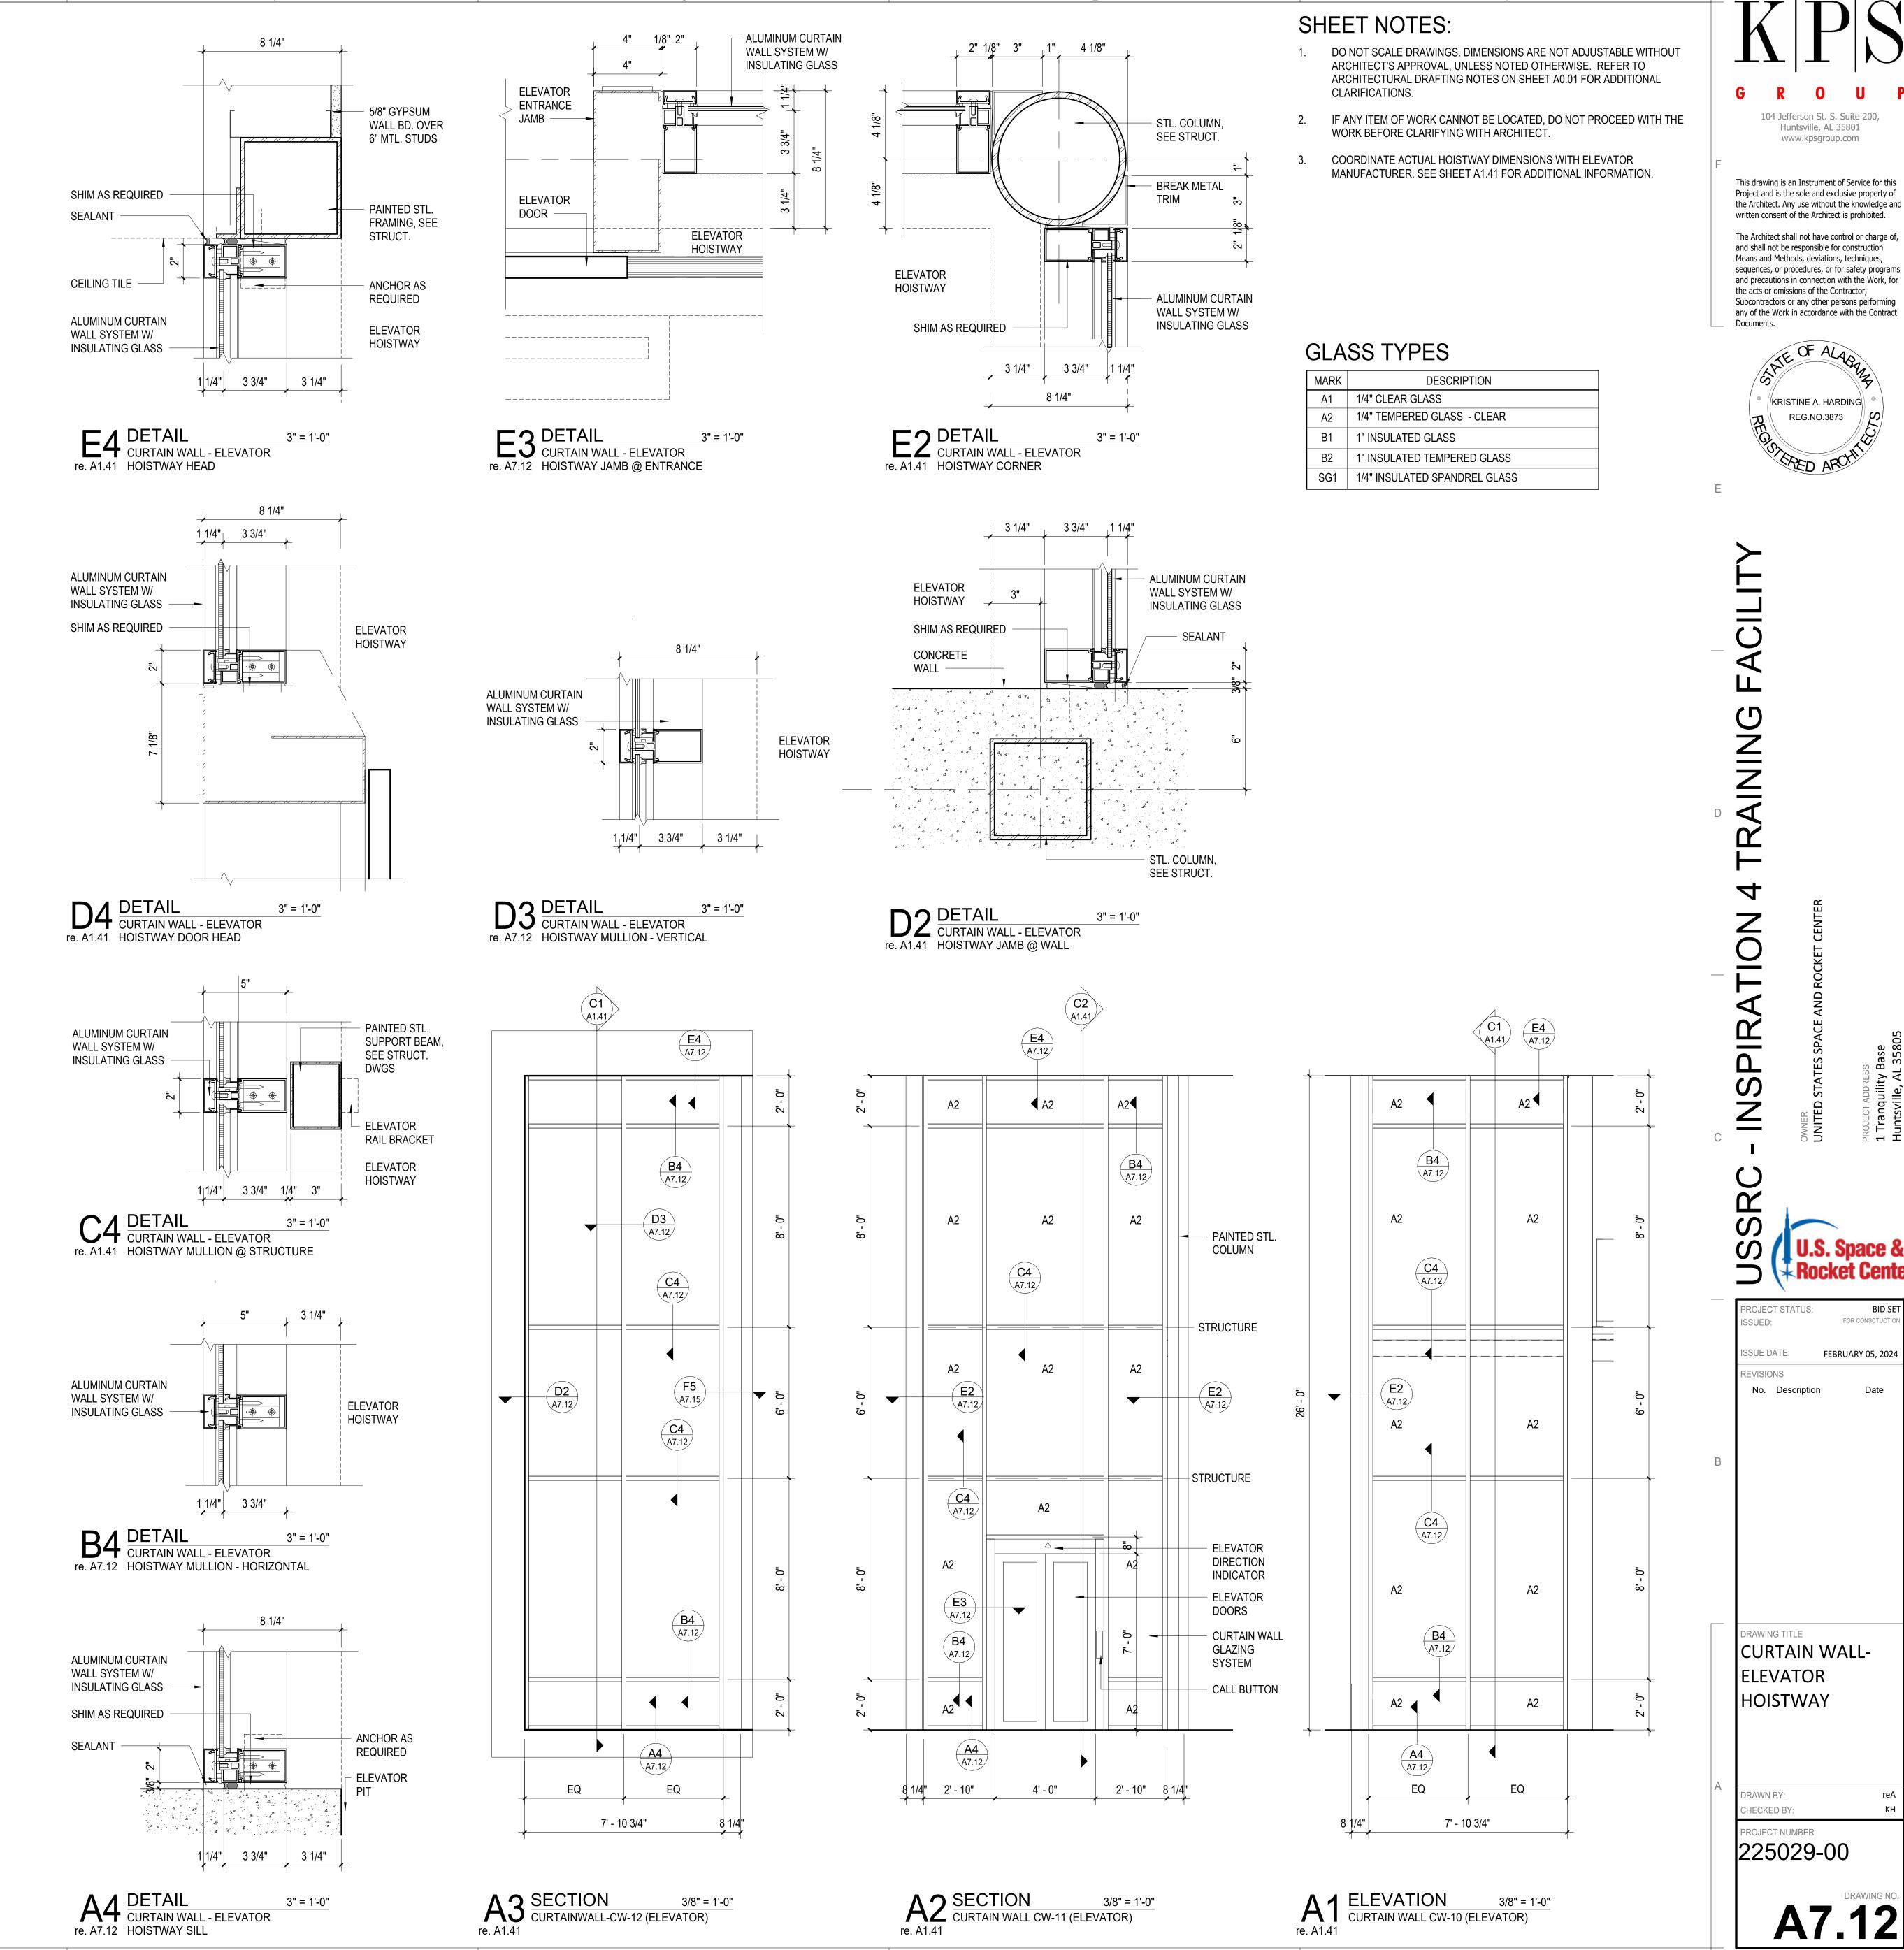

GLASS TYPES						
	MARK	DESCRIPTION				
	A1	1/4" CLEAR GLASS				
	A2	1/4" TEMPERED GLASS - CLEAR				
	B1	1" INSULATED GLASS				
	B2	1" INSULATED TEMPERED GLASS				

SG1 1/4" INSULATED SPANDREL GLASS



This drawing is an Instrument of Service for this Project and is the sole and exclusive property of the Architect. Any use without the knowledge and written consent of the Architect is prohibited.

The Architect shall not have control or charge of, and shall not be responsible for construction Means and Methods, deviations, techniques, sequences, or procedures, or for safety programs and precautions in connection with the Work, for the acts or omissions of the Contractor, Subcontractors or any other persons performing any of the Work in accordance with the Contract Documents.



INING

SSUE DATE:

No. Description

CURTAIN WALL -

SCHEDULE


HECKED BY:


PROJECT NUMBER


225029-00

REVISIONS

FEBRUARY 05, 2024

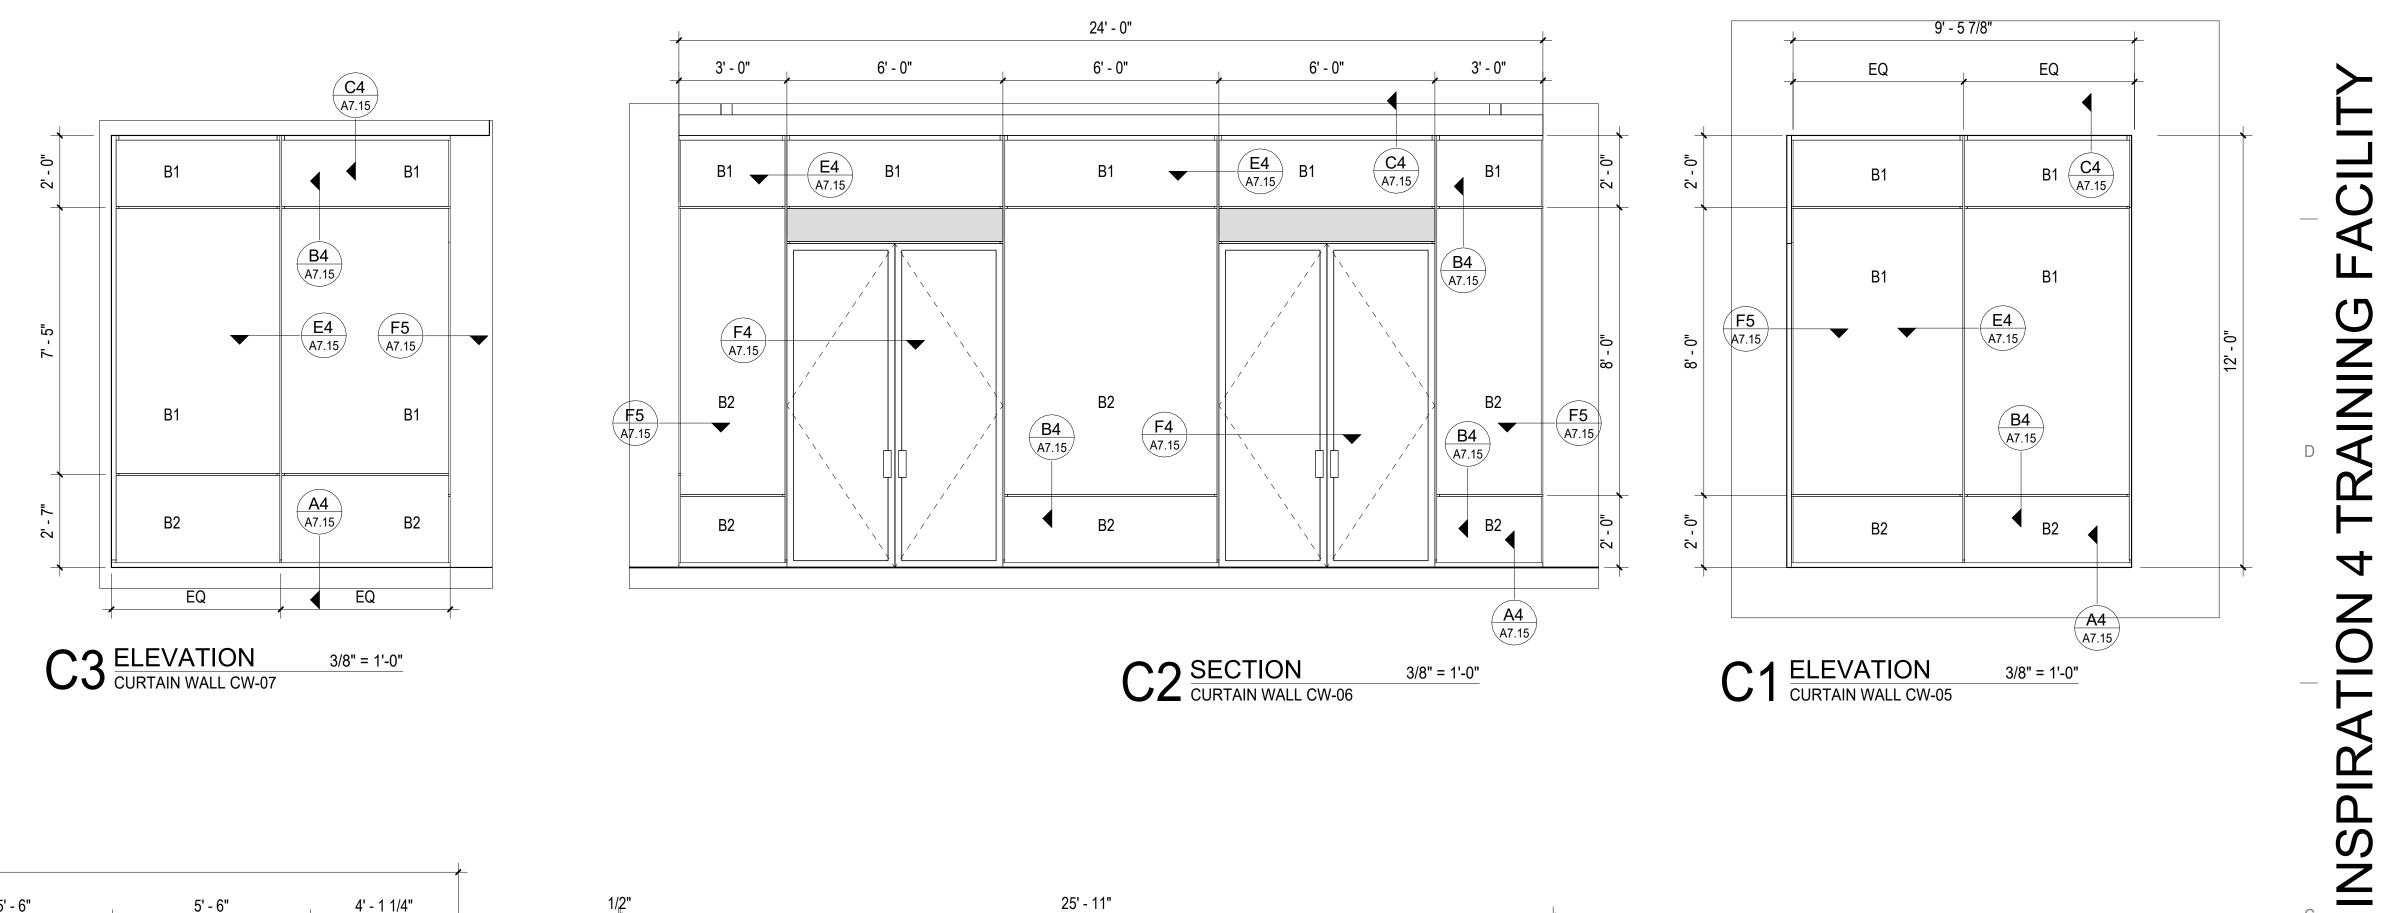


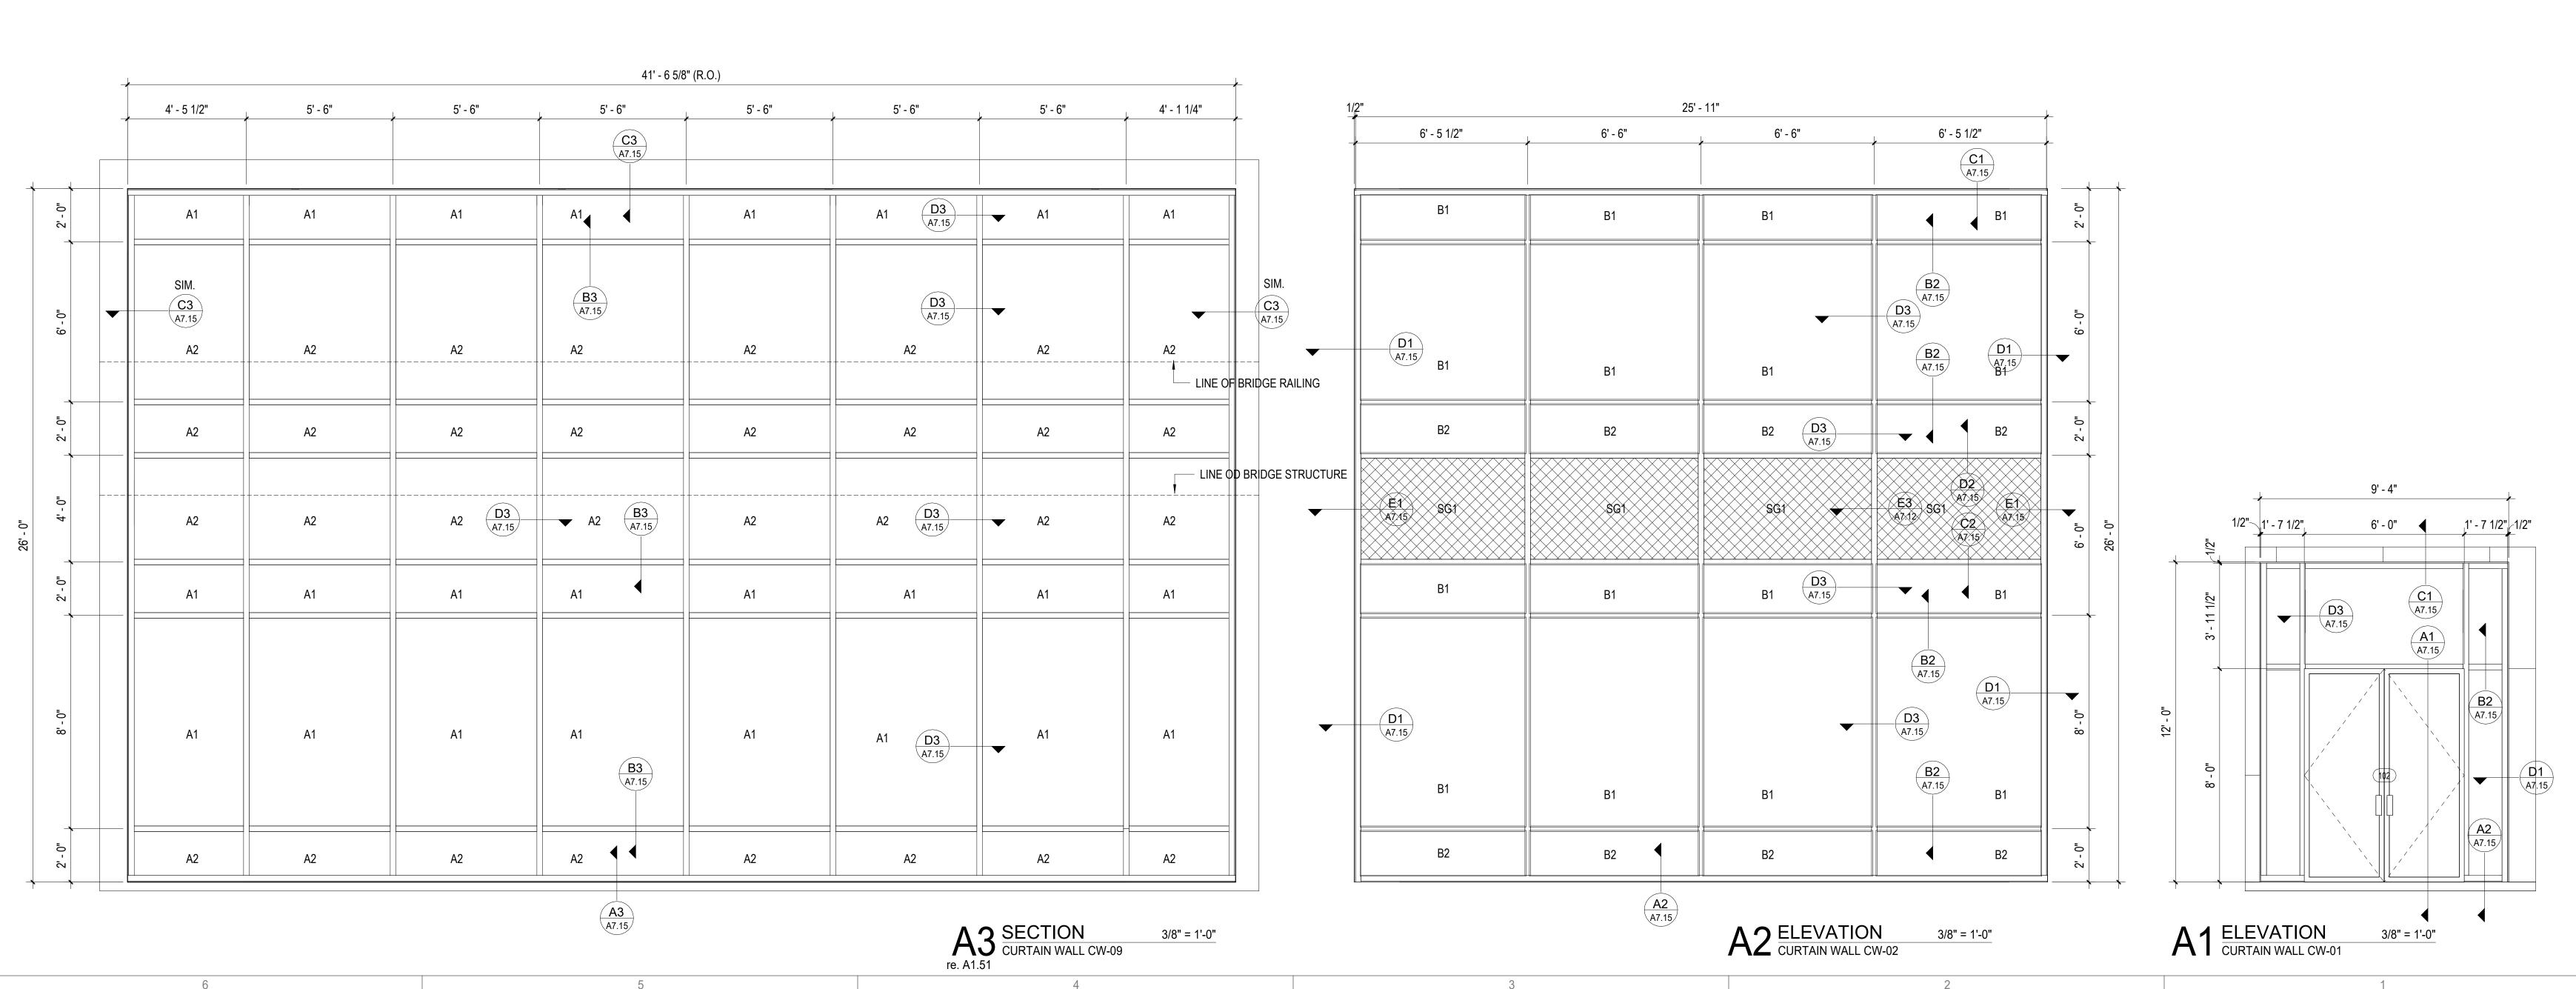

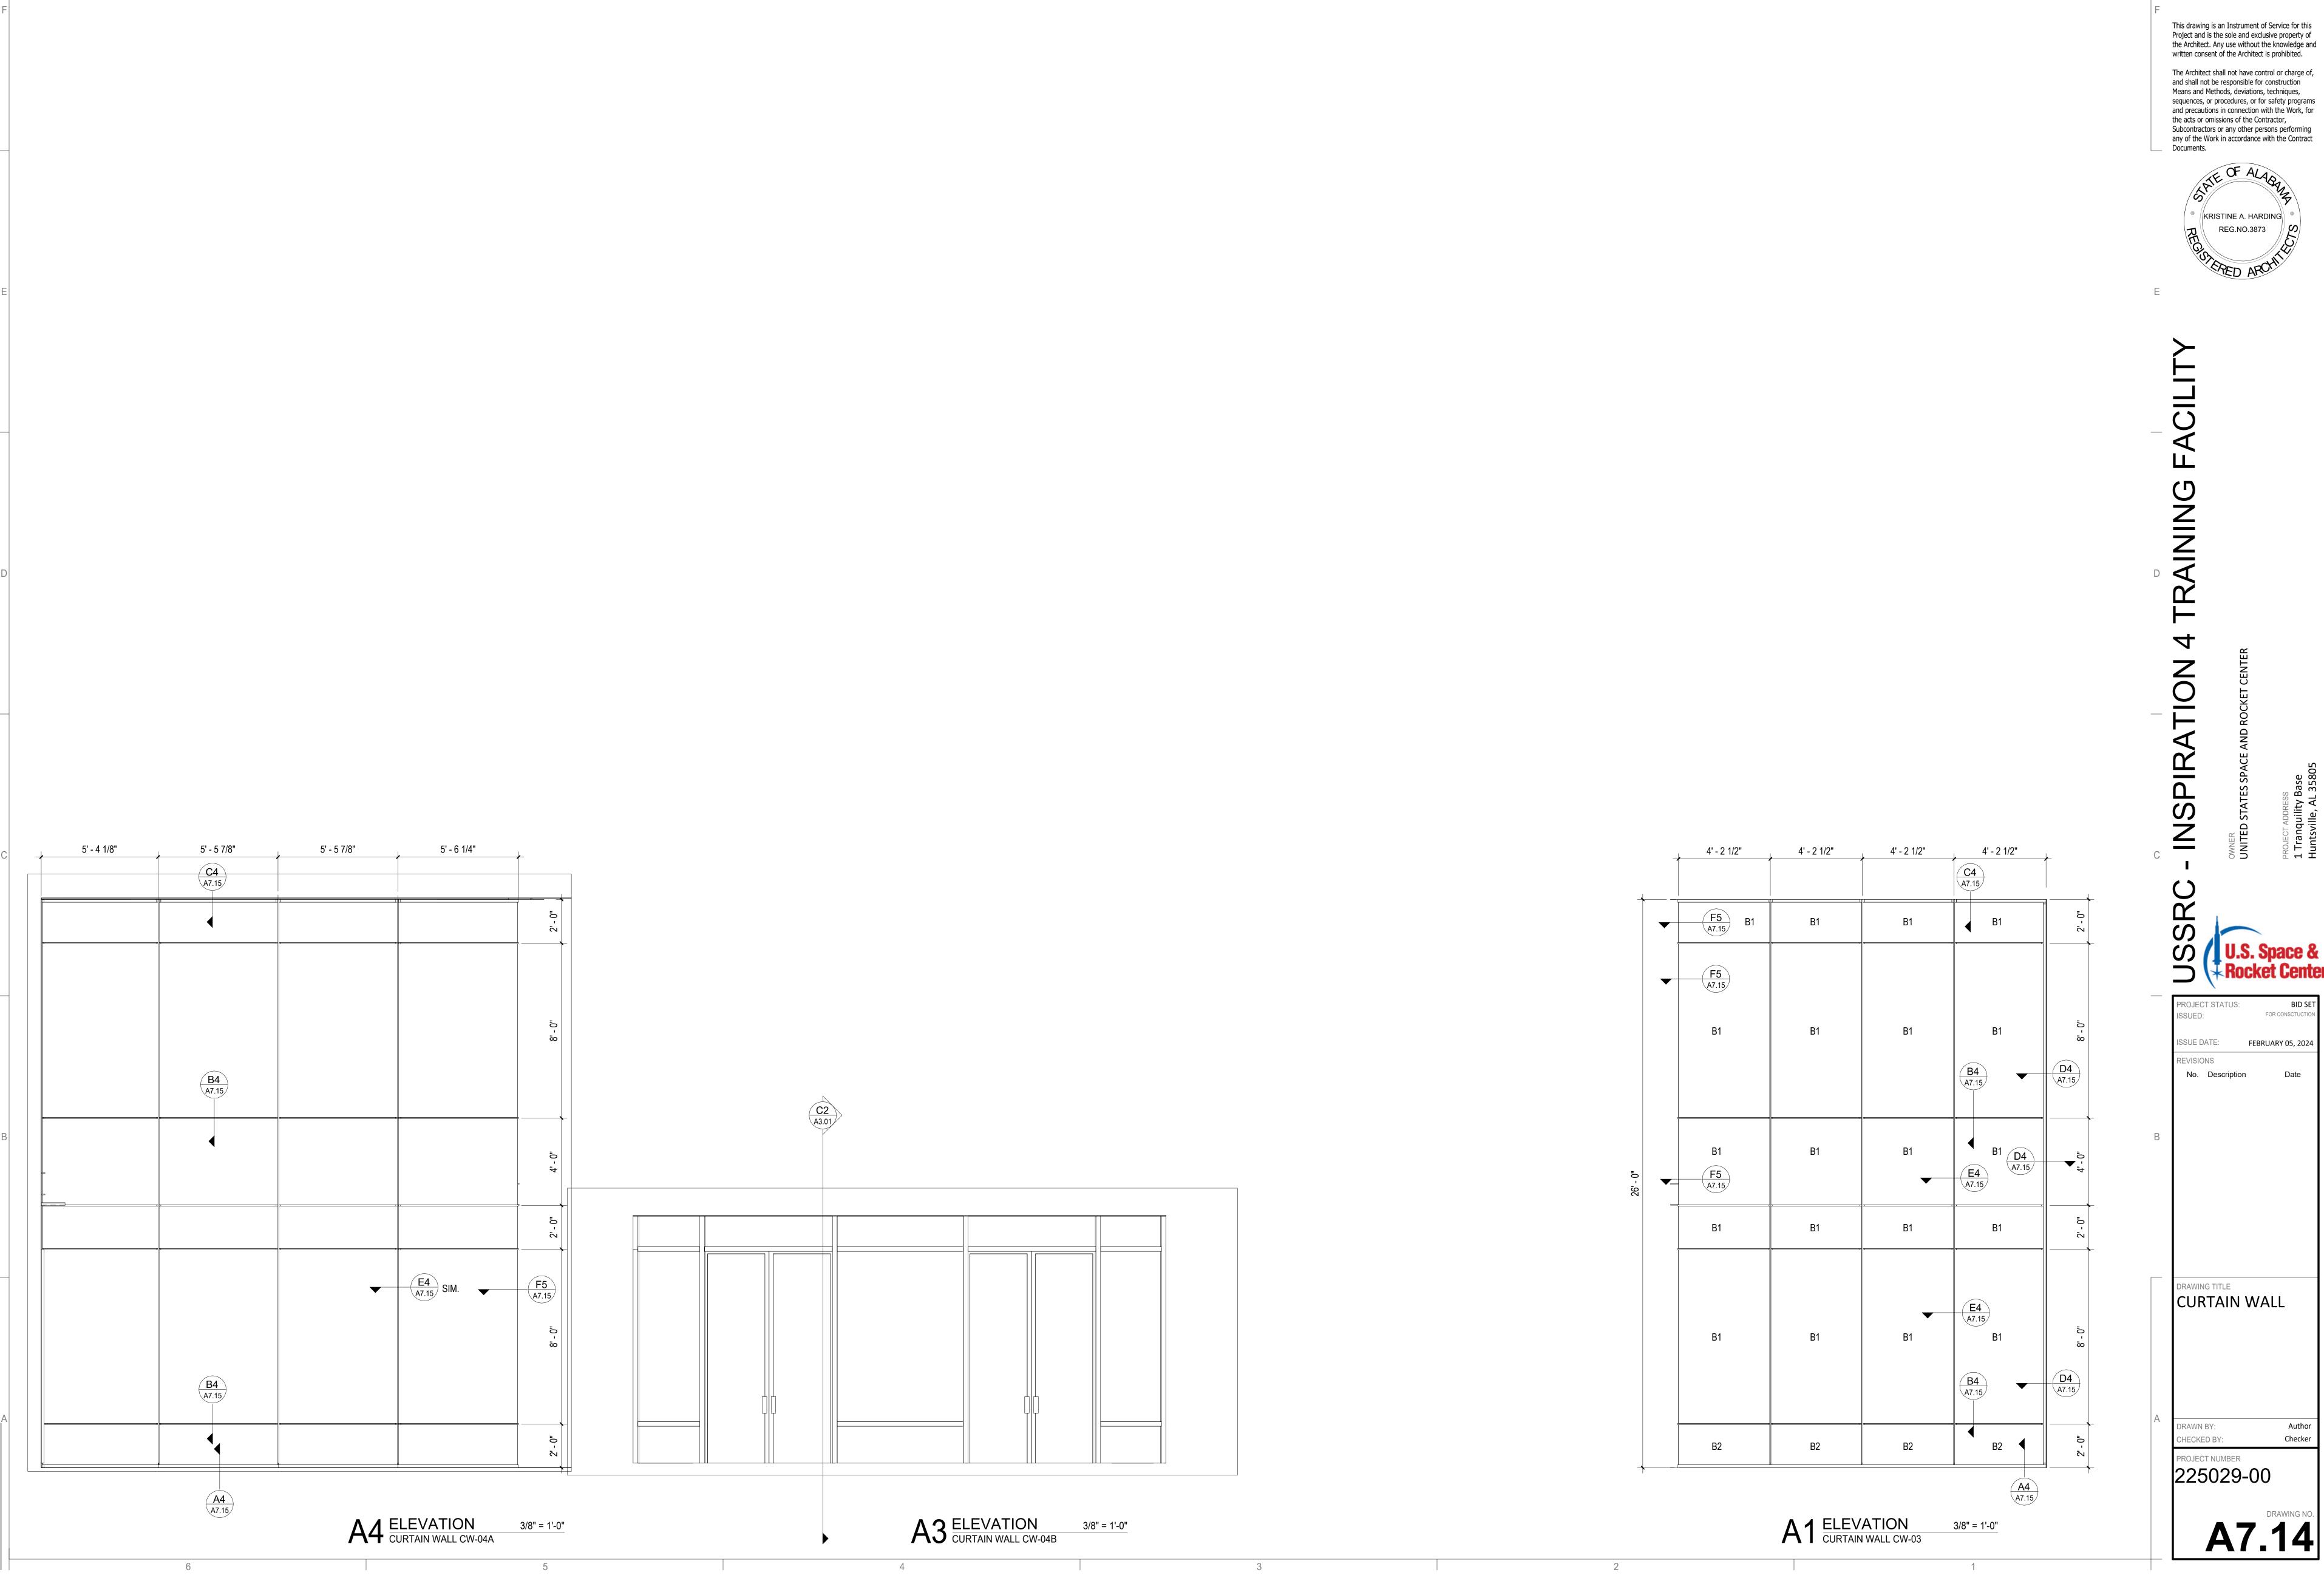

G R O U P

104 Jefferson St. S. Suite 200,
Huntsville, AL 35801
www.kpsgroup.com

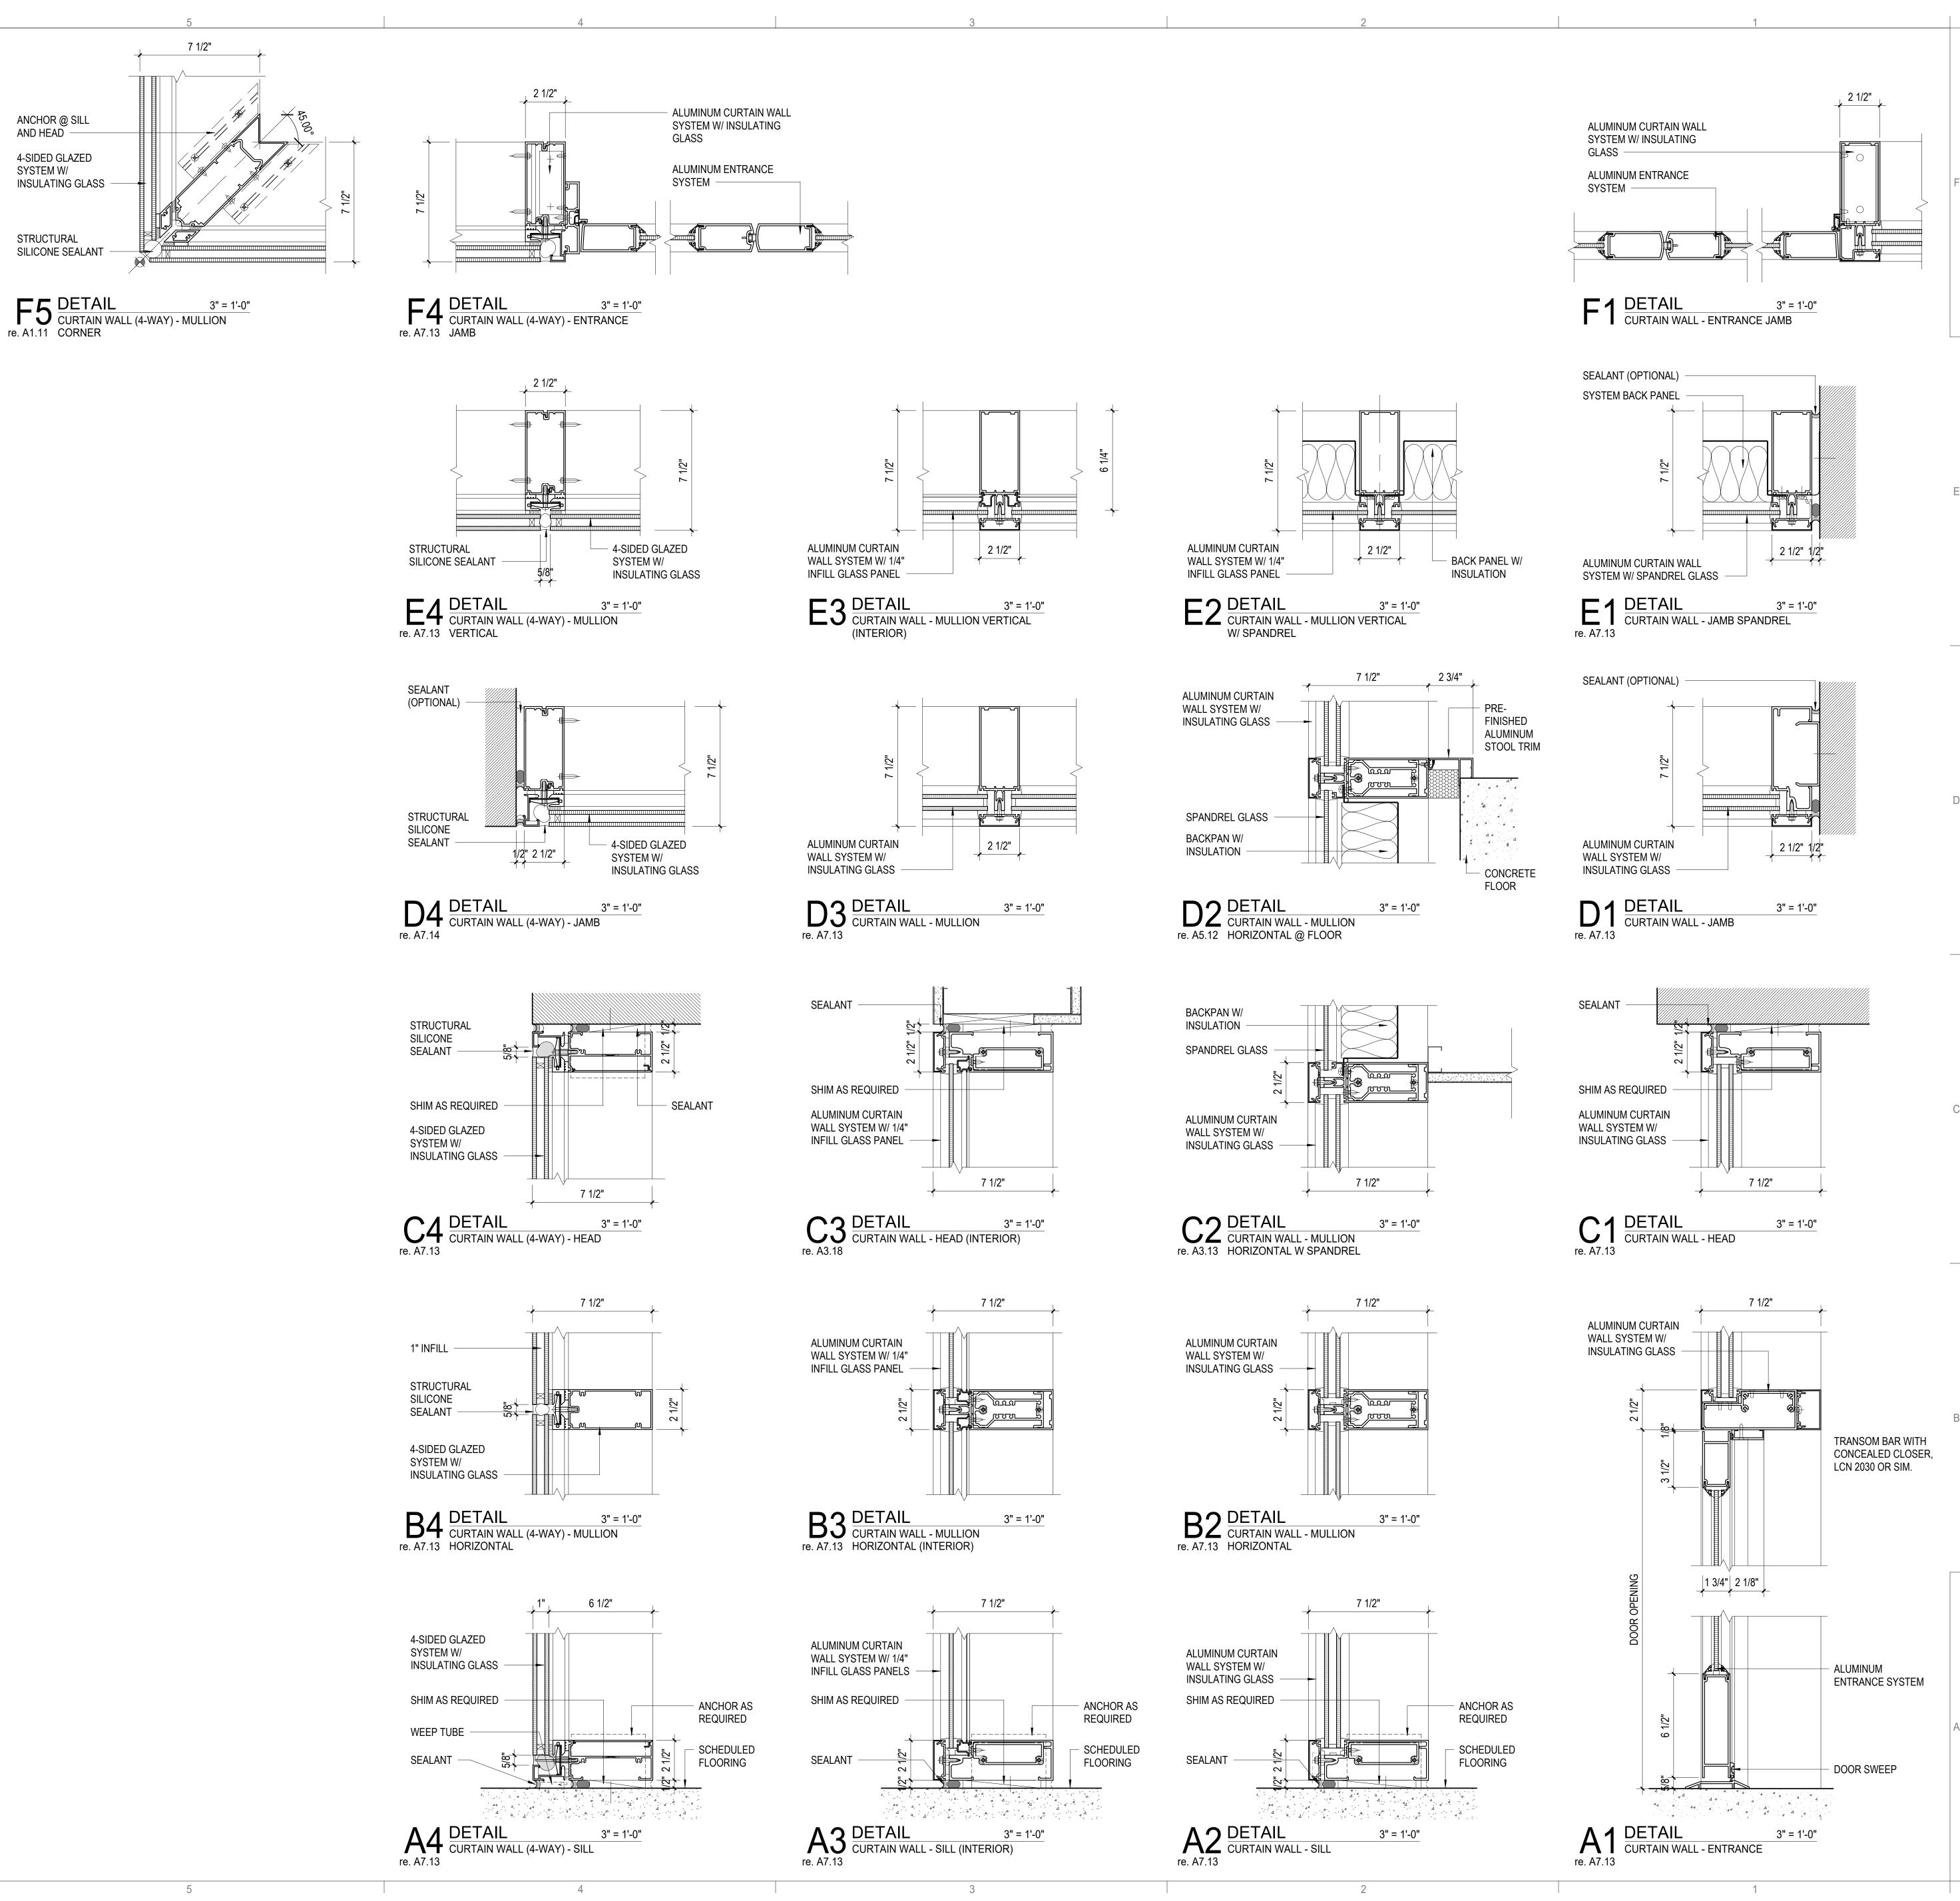

ANCHOR @ SILL

4-SIDED GLAZED

INSULATING GLASS

AND HEAD -

SYSTEM W/

STRUCTURAL SILICONE SEALANT

104 Jefferson St. S. Suite 200,

Huntsville, AL 35801

www.kpsgroup.com

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> KRISTINE A. HARDING REG.NO.3873

the acts or omissions of the Contractor, Subcontractors or any other persons performing any of the Work in accordance with the Contract

Documents.

4

INSPIRATION

ROJECT STATUS:

No. Description

RAWING TITLE

DETAILS

HECKED BY:

PROJECT NUMBER

225029-00

CURTAIN WALL -

SSUED:

SSUE DATE:

REVISIONS

BID SET FOR CONSCTUCTION

FEBRUARY 05, 2024



NUMBER	NAME		FINISHES			
		WALL	BASE	FLOOR	CEILING	COMMENT
LEVEL 2						
209	CORR	WC-1	RB-1	SC-1		
212	KITCHENETTE	PT-2	RB-1	LVT-1		
213	OFFICE	PT-2	RB-1	CPT-2		
214	OFFICE	PT-2	RB-1	CPT-2		
215	OFFICE	PT-2	RB-1	CPT-2		
216	STOR	PT-1	RB-1	SC-1		
217	CORR	WC-1	RB-1	SC-1		
218	COPY	PT-2	RB-1	CPT-2		
219	STOR	PT-1	RB-1	SC-1		
224	CLASSROOM	WC-11	RB-1	LVT-1		

SEE FINISH PLANS FOR ACCENT WALL LOCATIONS

