CLARKE RANGE COMPLEX LIGHTNING PROTECTION SHELTER

ALEXANDRIA, ALABAMA

IFB # AC-24-C-0002-S

SITE LOCATION MAP

Google

TEAM

ARMORY COMMISSION OF ALABAMA OWNER

STATE MILITARY BUILDING 1720 LONG. W.L. DICKENSON DRIVE MONTGOMERY, AL 36109

WILLIAMS BLACKSTOCK ARCHITECTS **ARCHITECT**

2204 1ST AVE. SOUTH SUITE 200 BIRMINGHAM, ALABAMA 35233-2331

McCARTER ENGINEERING ELECTRICAL ENGINEER

878 AVALON LANE ANNISTON, AL 36207

INDEX OF DRAWINGS

SHEET NAME T1.1 TITLE SHEET

ARCHITECTURAL DRAWINGS

ARCHITECTURAL SITE PLAN
FLOOR PLAN, ROOF PLAN, SCHEDULES, AND DETAILS
EXTERIOR ELEVATIONS AND WALL SECTIONS
LOUVER SECTION AND DETAILS

ELECTRICAL DRAWINGS

CODE DATA

2015 INTERNATIONAL BUILDING CODE

2015 INTERNATIONAL PLUMBING CODE

2015 INTERNATIONAL MECHANICAL CODE

2011 NATIONAL ELECTRICAL CODE

2015 INTERNATIONAL FIRE PREVENTION CODE

GOVERNING CODES:

2010 ADA STANDARDS

SYMBOLS, NOTES AND LIGHTNING PROTECTION PLAN

WILLIAMS BLACKSTOCK
ARCHITECTS

CONSTRUCTION

WILLIAMS · BLACKSTOCK

2204 FIRST AVENUE SOUTH BIRMINGHAM, ALABAMA 35233

> ISSUE DATE 10/05/2023

> > REVISIONS

PROJECT NUMBER 19-054.07

> DRAWING TITLE: SHEET

SHEET NUMBER

WILLIAMS BLACKSTOCK ARCHITECTS







WILLIAMS · BLACKSTOCK **A** R C H I T E C T S

ARCHITECTURE INTERIORS PLANNING 2204 FIRST AVENUE SOUTH BIRMINGHAM, ALABAMA 35233

> ISSUE DATE 10/05/2023


> > REVISIONS


PROJECT NUMBER 19-054.07


DRAWING TITLE:

SITE PLAN

SHEET NUMBER

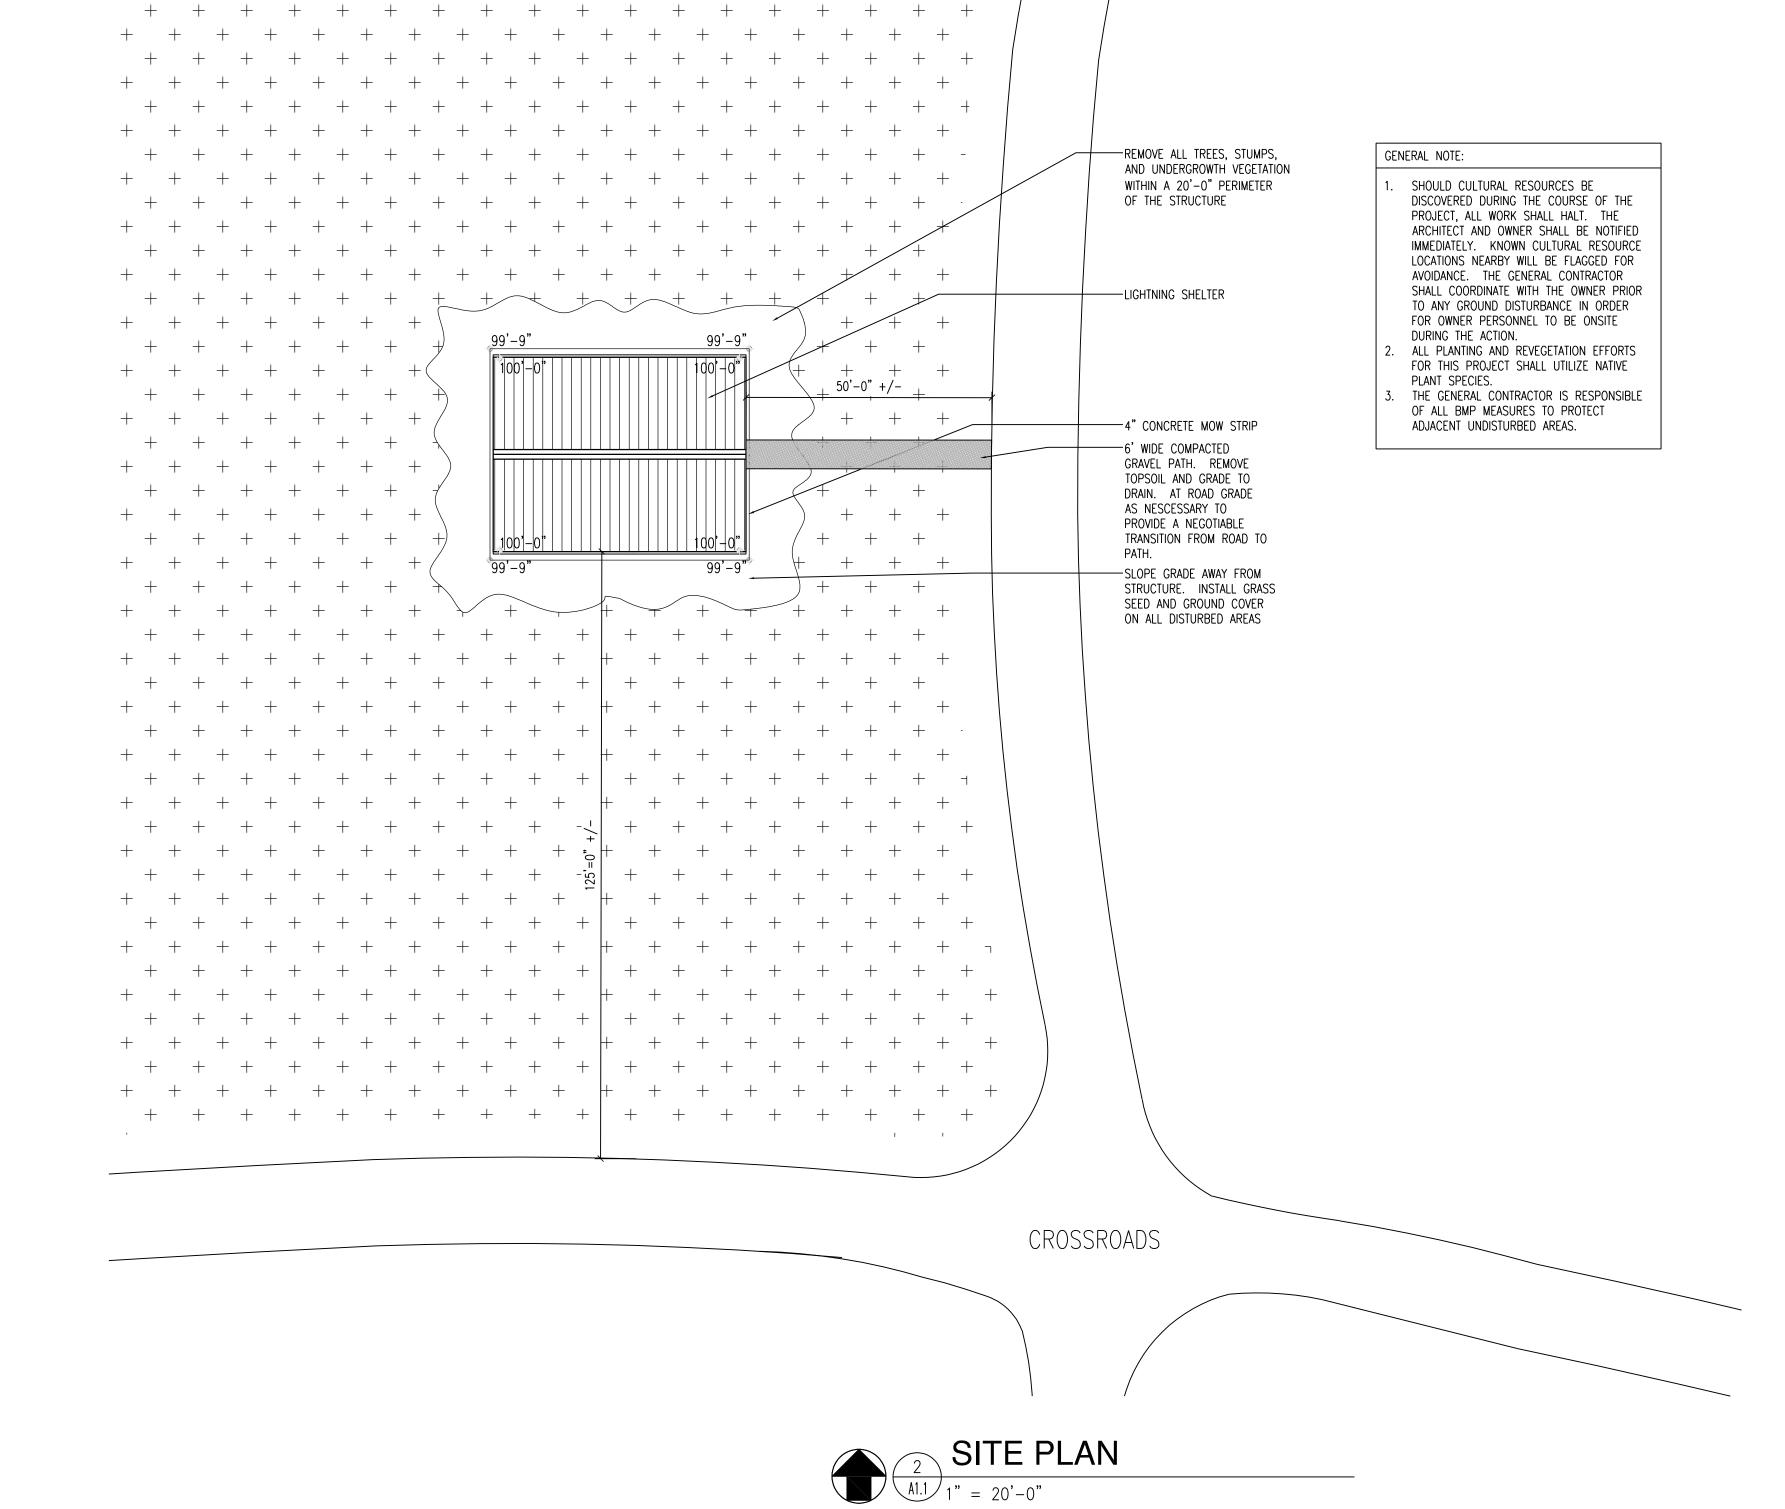


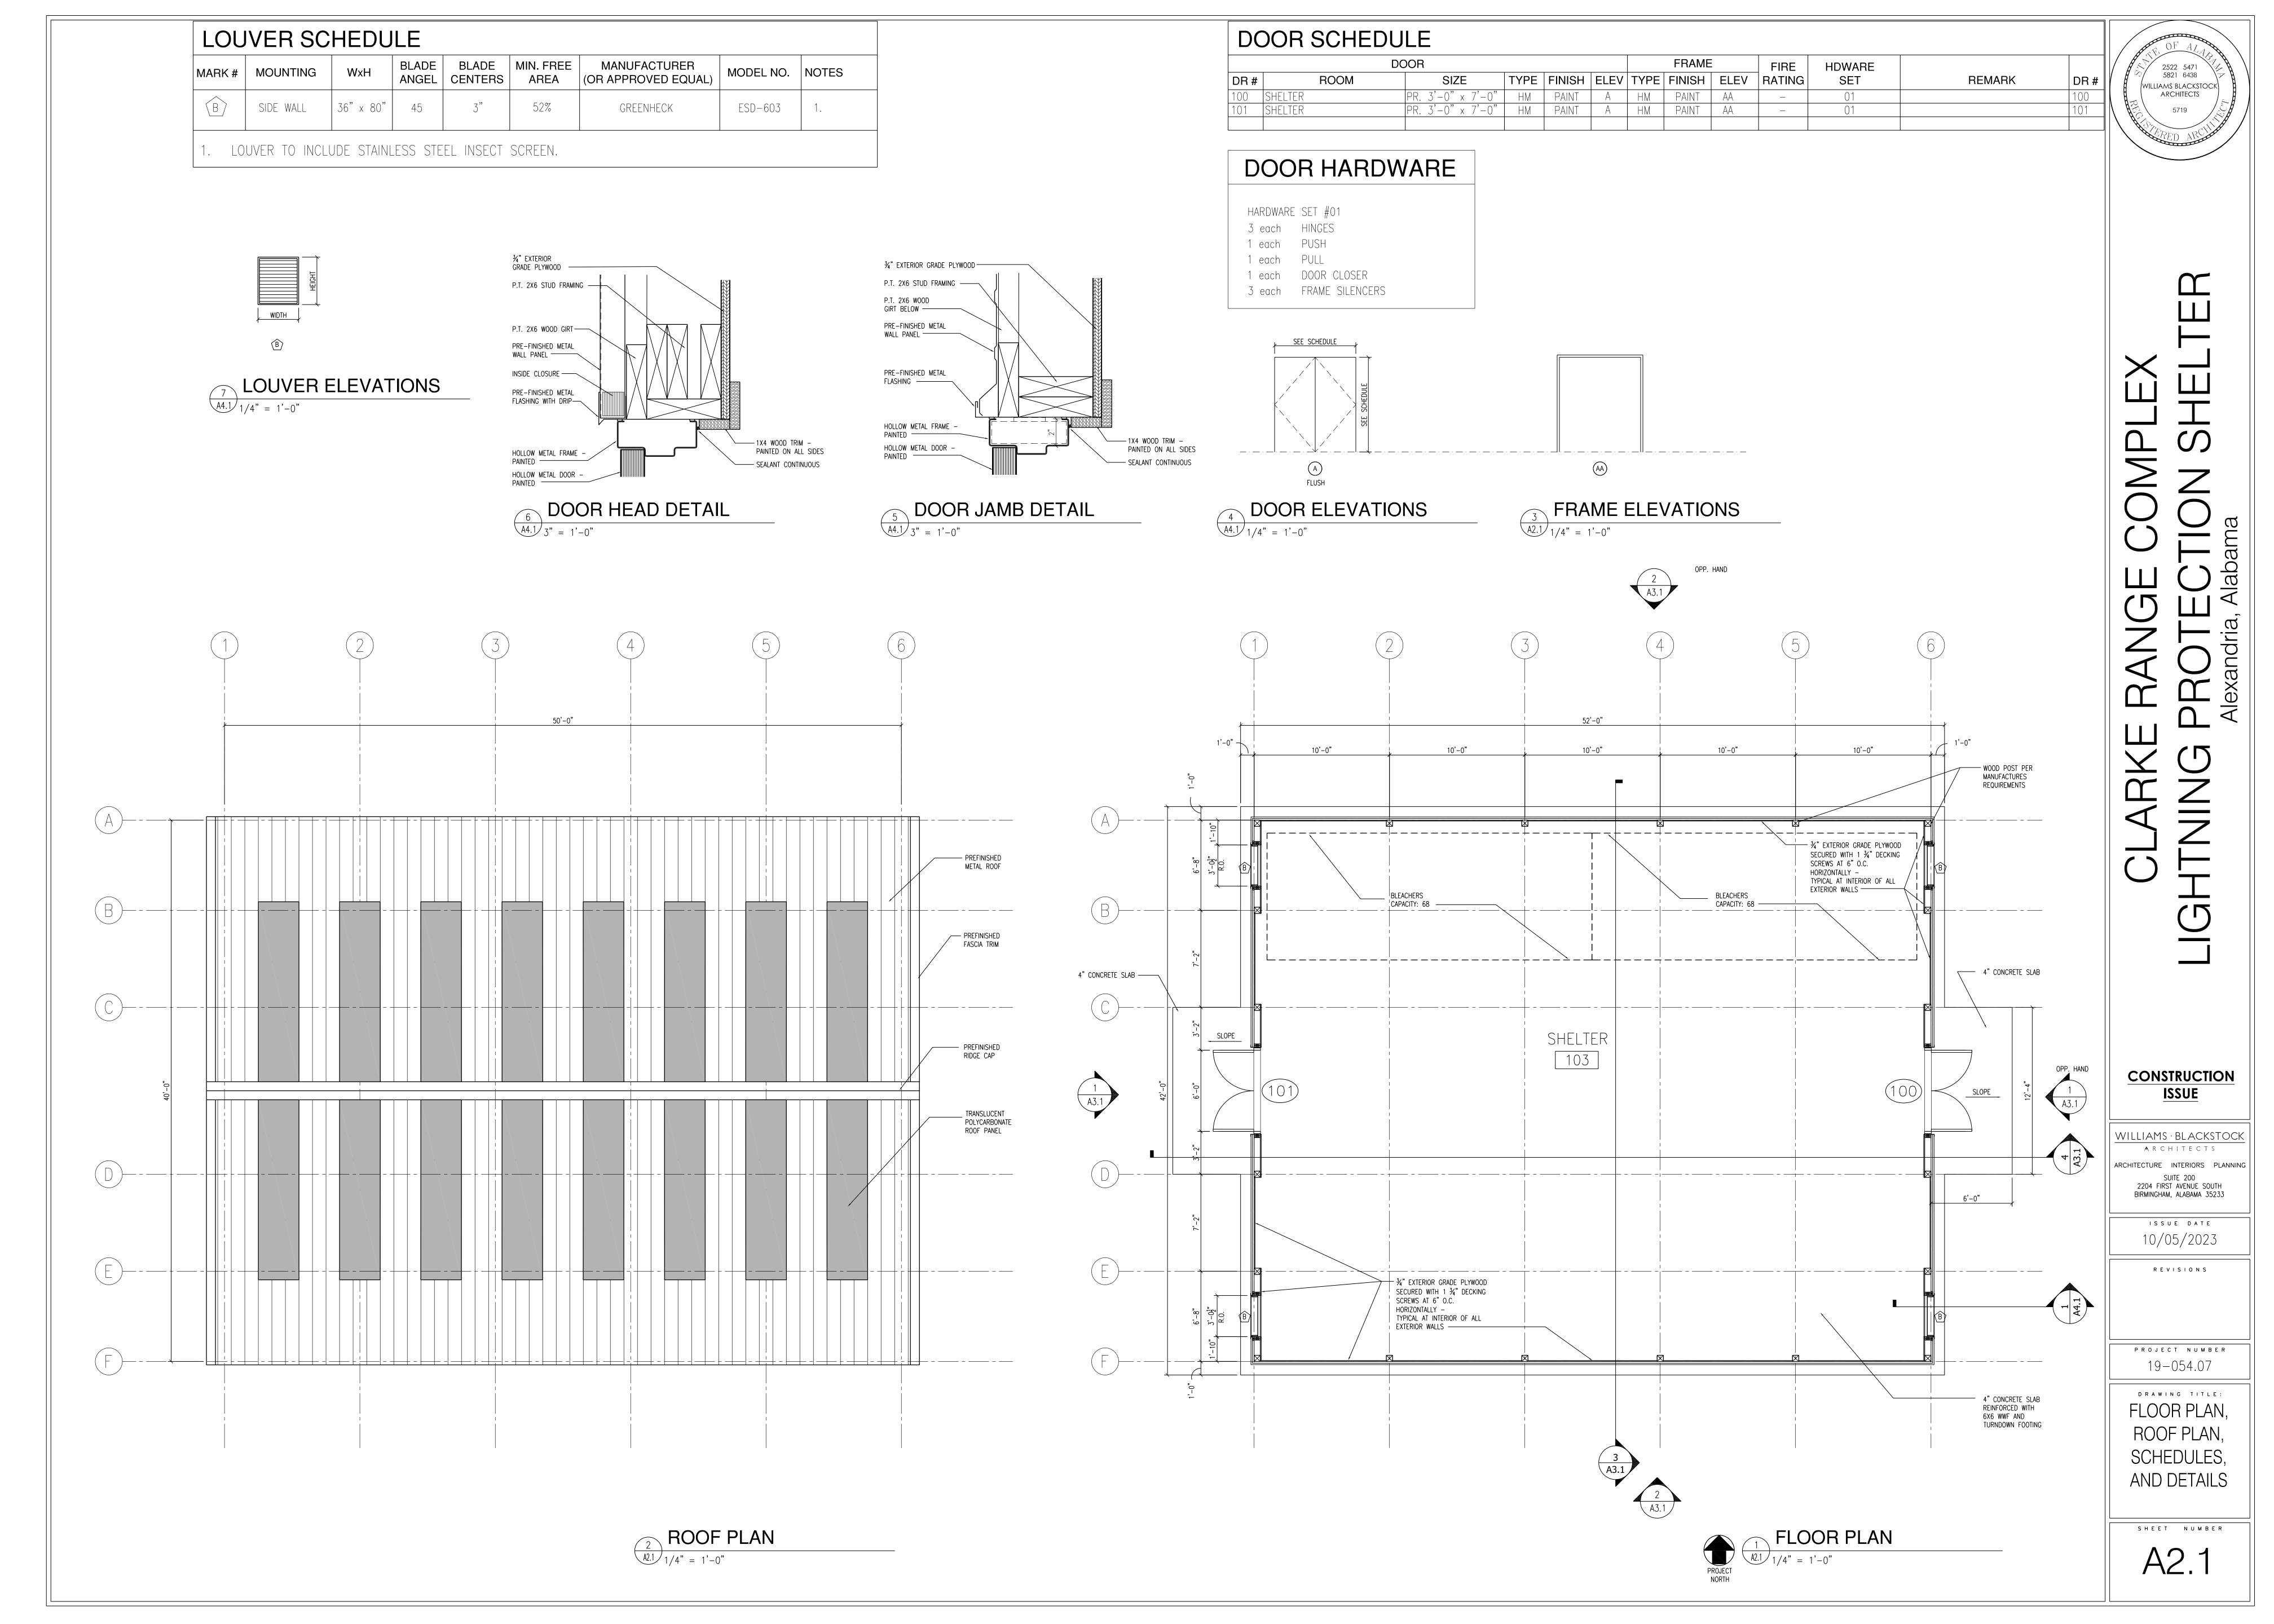

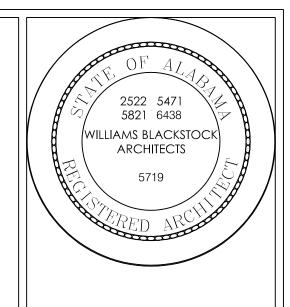



GENERAL NOTES:

1. ALL PLYWOOD IS TO BE PAINTED ON ALL SIX SIDES.
2. ALL WOOD FRAMING AND SHEATHING SHALL BE PAINTED ON ALL SURFACES AND EDGES.

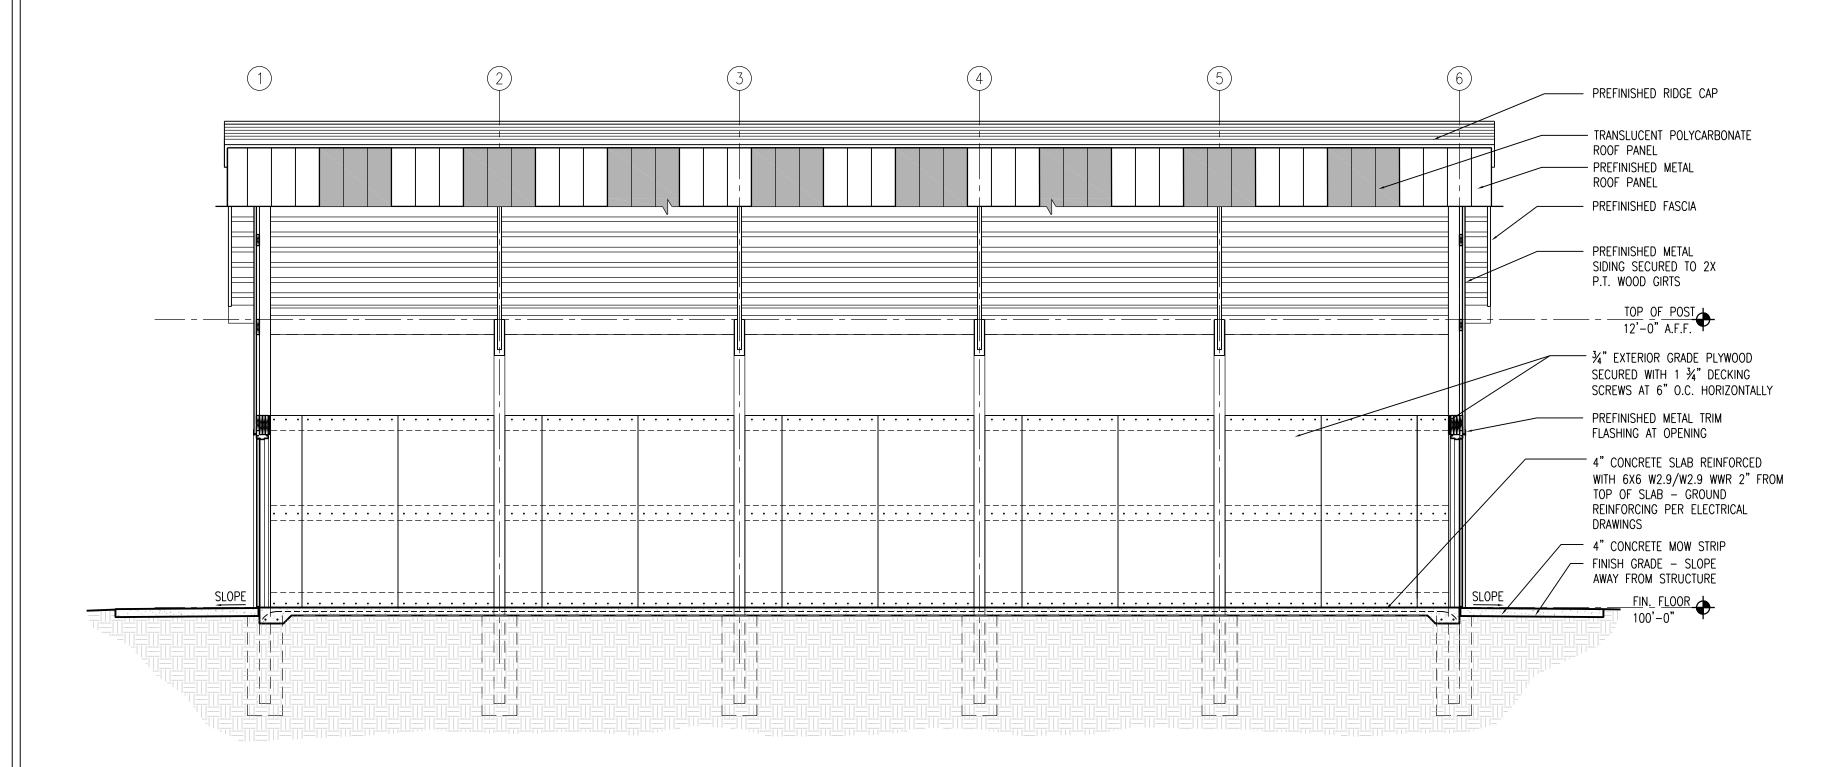




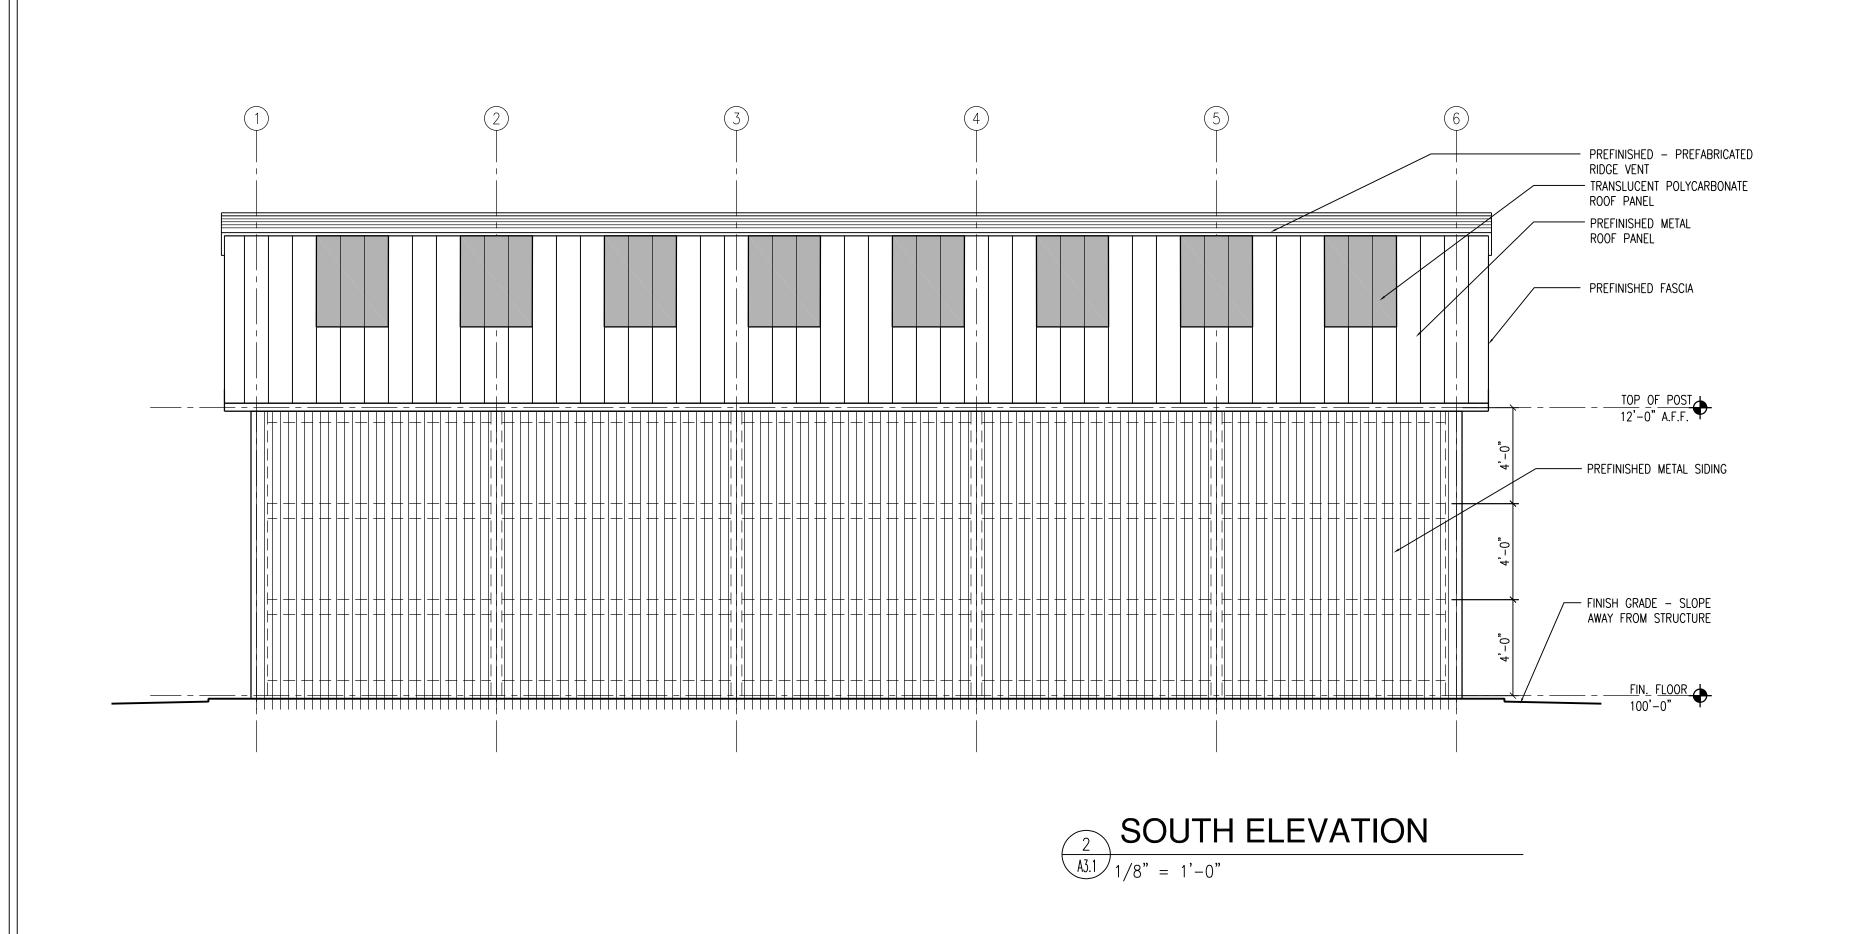

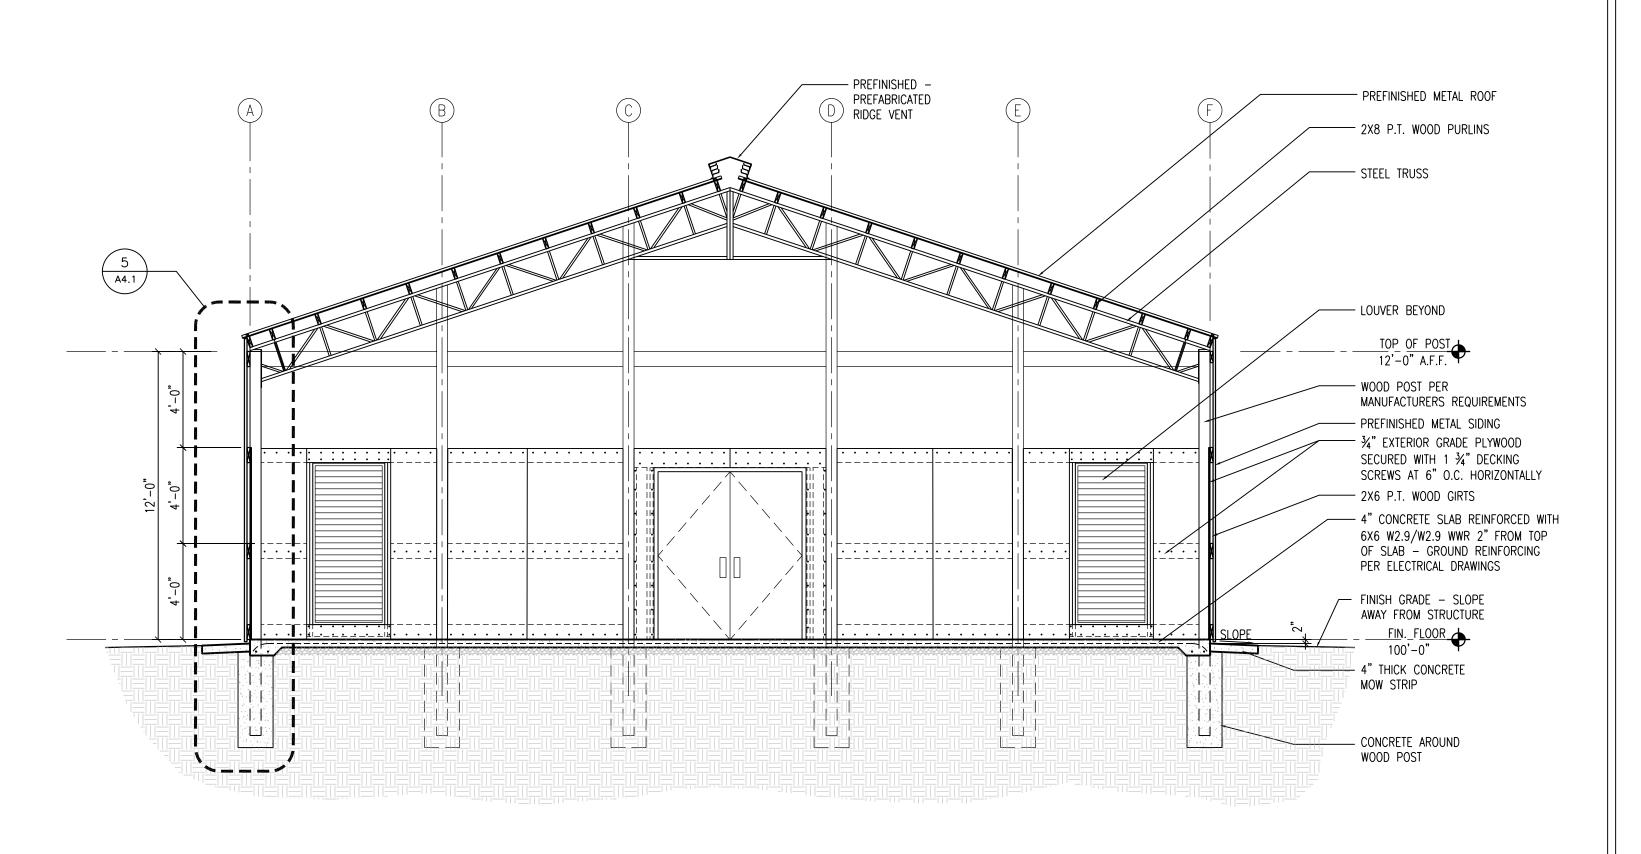



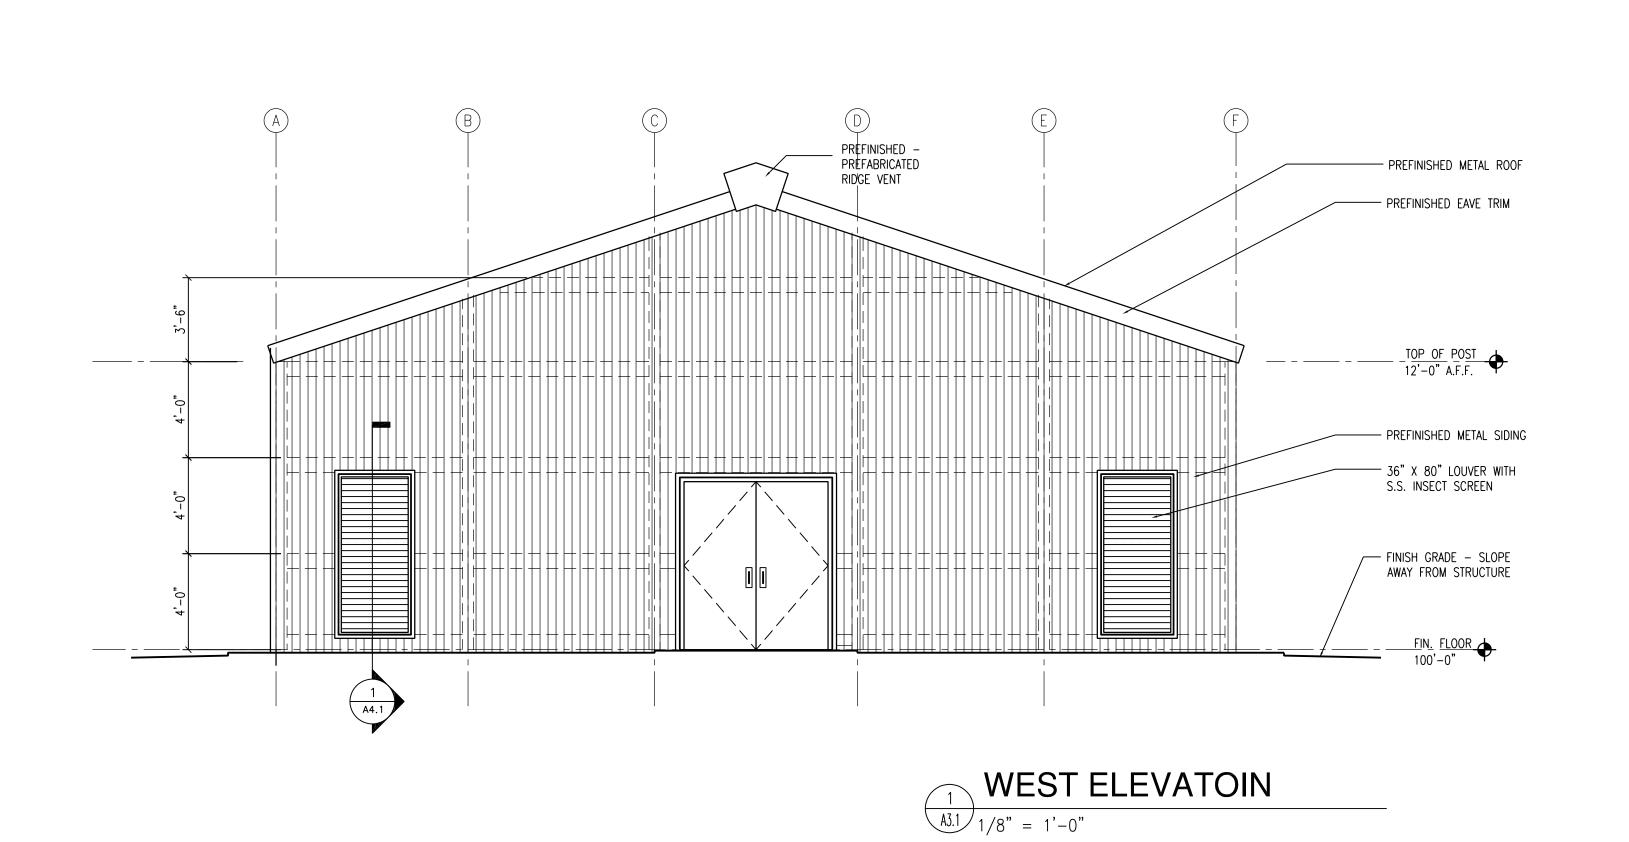

CONSTRUCTION ISSUE

WILLIAMS · BLACKSTOCK

ARCHITECTS

ARCHITERIORS PLANNING

SUITE 200

2204 FIRST AVENUE SOUTH

BIRMINGHAM, ALABAMA 35233

10/05/2023


REVISIONS

PROJECT NUMBER
19-054.07

EXTERIOR ELEVS,

BLDG SECTIONS

A3.1

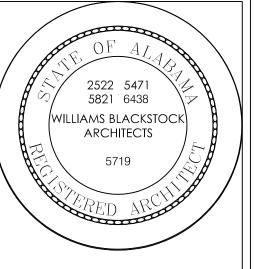

LIGHTNING PROTECTION SHELTE

CONSTRUCTION ISSUE

WILLIAMS · BLACKSTOCK

ARCHITECTS

ARCHITECTURE INTERIORS PLANNING

SUITE 200

2204 FIRST AVENUE SOUTH

BIRMINGHAM, ALABAMA 35233

10/05/2023

REVISIONS

PROJECT NUMBER
19-054.07

SECTIONS AND DETAILS

SHEET NUMBER

A4.1

ELECTRICAL SYMBOLS

CEILING OUTLET — JUNCTION BOX.

A.F.F. ABOVE FINISHED FLOOR.

A.F.G. ABOVE FINISHED GRADE.

B.F.C. BELOW FINISHED CEILING.

VER. VERIFY LOCATION.

NATIONAL ELECTRICAL CODE.

N.E.C.

BLEACHERS CAPACITY: 68 SHELTER 103

LIGHTNING PROTECTION PLAN

SCALE: 1/8" = 1'-0"

NOTES:
1. CONTRACTOR SHALL INSTALL A LIGHTNING PROTECTION SYSTEM ON THIS BUILDING. SEE SPECIFICATION SECTION 26 4113 FOR LIGHTNING PROTECTION SYSTEM REQUIREMENTS.

GENERAL NOTES

- 1. ALL ELECTRICAL WORK SHALL BE DONE IN ACCORDANCE WITH THE NATIONAL ELECTRICAL CODE AND LOCAL ORDINANCES. CONTRACTOR SHALL OBTAIN AND PAY FOR ALL NECESSARY PERMITS.
- 2. CONTRACTOR SHALL VISIT THE SITE AND FAMILIARIZE HIMSELF WITH ALL DETAILS OF THE WORK AND ALL EXISTING FIELD
- 3. CONTRACTOR SHALL PROVIDE A COMPLETE ELECTRICAL INSTALLATION INCLUDING ALL WORK CUSTOMARILY INCLUDED EVEN IF
- NOT SPECIFICALLY CALLED OUT.

 4. THE ELECTRICAL CONTRACTOR SHALL CAREFULLY COORDINATE HIS WORK WITH OTHER CONTRACTORS THROUGH THE GENERAL
- 5. SHOULD THE CONTRACTOR FIND DISCREPANCIES OR OMISSIONS IN THE CONTRACT DOCUMENTS OR BE IN DOUBT AS TO INTENT, HE SHALL IMMEDIATELY OBTAIN CLARIFICATION FROM THE ARCHITECT OR ENGINEER.
- 6. THE ELECTRICAL DRAWINGS ARE SCHEMATIC AND ARE NOT INTENDED TO SHOW THE EXACT LOCATION OF CONDUIT, OUTLETS, ETC.. THE CONTRACTOR SHALL REFER TO ARCHITECTURAL, MECHANICAL AND PLUMBING DRAWINGS AND SHALL FIT HIS WORK TO CONFORM WITH THE BUILDING CONSTRUCTION AND WITH THE OTHER TRADES.
- 7. ALL CONDUITS CROSSING EXPANSION JOINTS SHALL HAVE EXPANSION TYPE FITTINGS.

CONTRACTOR FOR SPACE REQUIREMENTS, ETC.

- 8. CONTRACTOR SHALL PROVIDE RECORD DRAWINGS AND MANUALS THAT PROVIDE INSTRUCTION ABOUT OPERATION AND MAINTENANCE OF THE BUILDING ELECTRICAL DISTRIBUTION SYSTEM TO THE OWNER WITHIN 30 DAYS AFTER THE DATE OF SYSTEM ACCEPTANCE.
- 9. VERIFY EXACT LOCATION AND EXACT MOUNTING HEIGHT OF ALL ELECTRICAL EQUIPMENT AND ELECTRICAL CONNECTIONS WITH THE ARCHITECT AND THE OWNER PRIOR TO ROUGH—IN.

10. CONTRACTOR SHALL ENSURE THAT AII GROUNDING CONDUCTORS IN THE INTERIOR OF THE BUILDING ARE INSTALLED IN CONDUIT.

CLARKE RANGE COMPLEX LIGHTNING PROTECTION SHEL

CONSTRUCTION ISSUE

WILLIAMS · BLACKSTOCK
ARCHITECTS

ARCHITECTURE INTERIORS PLANNING
SUITE 200
2204 FIRST AVENUE SOUTH
BIRMINGHAM, ALABAMA 35233

18 S U E D A T E

REVISIONS

project number 19-054.07

SYMBOLS, NOTES
AND LIGHTNING
PROTECTION PLAN

SHEET NUMBE

ELECTRICAL ENGINEERING CONSULTANTS

878 AVALON LANE Anniston, al 36207

M.E. JOB #2247

E1.1