

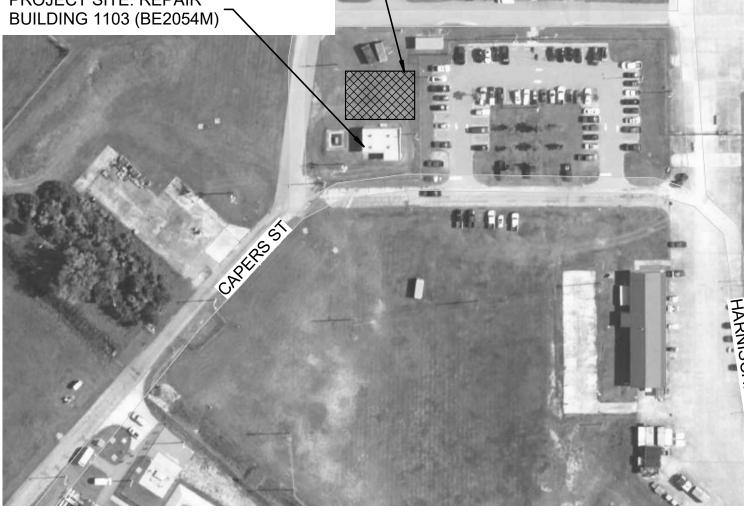
MCAS BEAUFORT **REPAIR BUILDING 1103** (BE2054M)

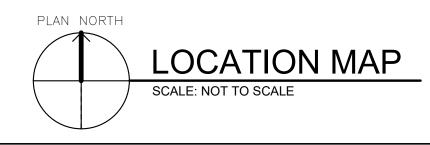
MARINE CORPS AIR STATION BEAUFORT, SOUTH CAROLINA 04 MARCH 2024

INDEX C	INDEX OF DRAWINGS				
# OF		SHEET			
TOTAL	P.W.#	NO.	SHEET TITLE		
GENERAL					
1	28675	G-001	COVER SHEET		
STRUCTURAL					
2	28676	S-001	GENERAL NOTES AND DESIGN LOADS		
3	28677	S-101	DEMOLITION AND NEW WORK PLANS		
4	28678	S-301	SECTIONS		
5	28679	S-501	SECTIONS AND TYPICAL DETAILS		
ARCHITECTURA	L				
6	28680	A-001	ABBREVIATIONS, SYMBOLS AND LEGENDS		
7	28681	A-002	GENERAL ARCHITECTURAL NOTES		
8	28682	AD101	DEMOLITION FLOOR AND ROOF PLAN		
9	28683	AD201	DEMOLITION EXTERIOR ELEVATIONS		
10	28684	AD901	DEMOLITION PHOTOS		
11	28685	A-101	FLOOR PLAN, REFLECTED CEILING AND ROOF PLAN		
12	28686	A-201	EXTERIOR ELEVATIONS AND BUILDING SECTIONS		
13	28687	A-301	SECTIONS AND DETAILS		
14	28688	A-601	SCHEDULES AND DETAILS		
MECHANICAL					
15	28689	M-001	LEGEND, ABBREVIATIONS, AND GENERAL NOTES		
16	28690	M-101	DEMOLITION AND NEW WORK PLANS		
ELECTRICAL					
17	28691	E-001	GENERAL NOTES, LEGENDS AND DETAILS		
18	28692	E-101	FLOOR PLANS		
19	28693	E-501	LIGHTNING PROTECTION DETAILS		
TOTAL: 19	1	1			


CONTRACTOR STAGING AREA AND TEMPORARY CONSTRUCTION FENCE. CONTRACTOR TO COORDINATE EXACT LOCATION AND LIMITS OF CONSTRUCTION FENCE AND OTHER WORK ON OR NEAR THE CONSTRUCTION SITE WITH BASE PM.

PROJECT SITE: REPAIR





SYM.	

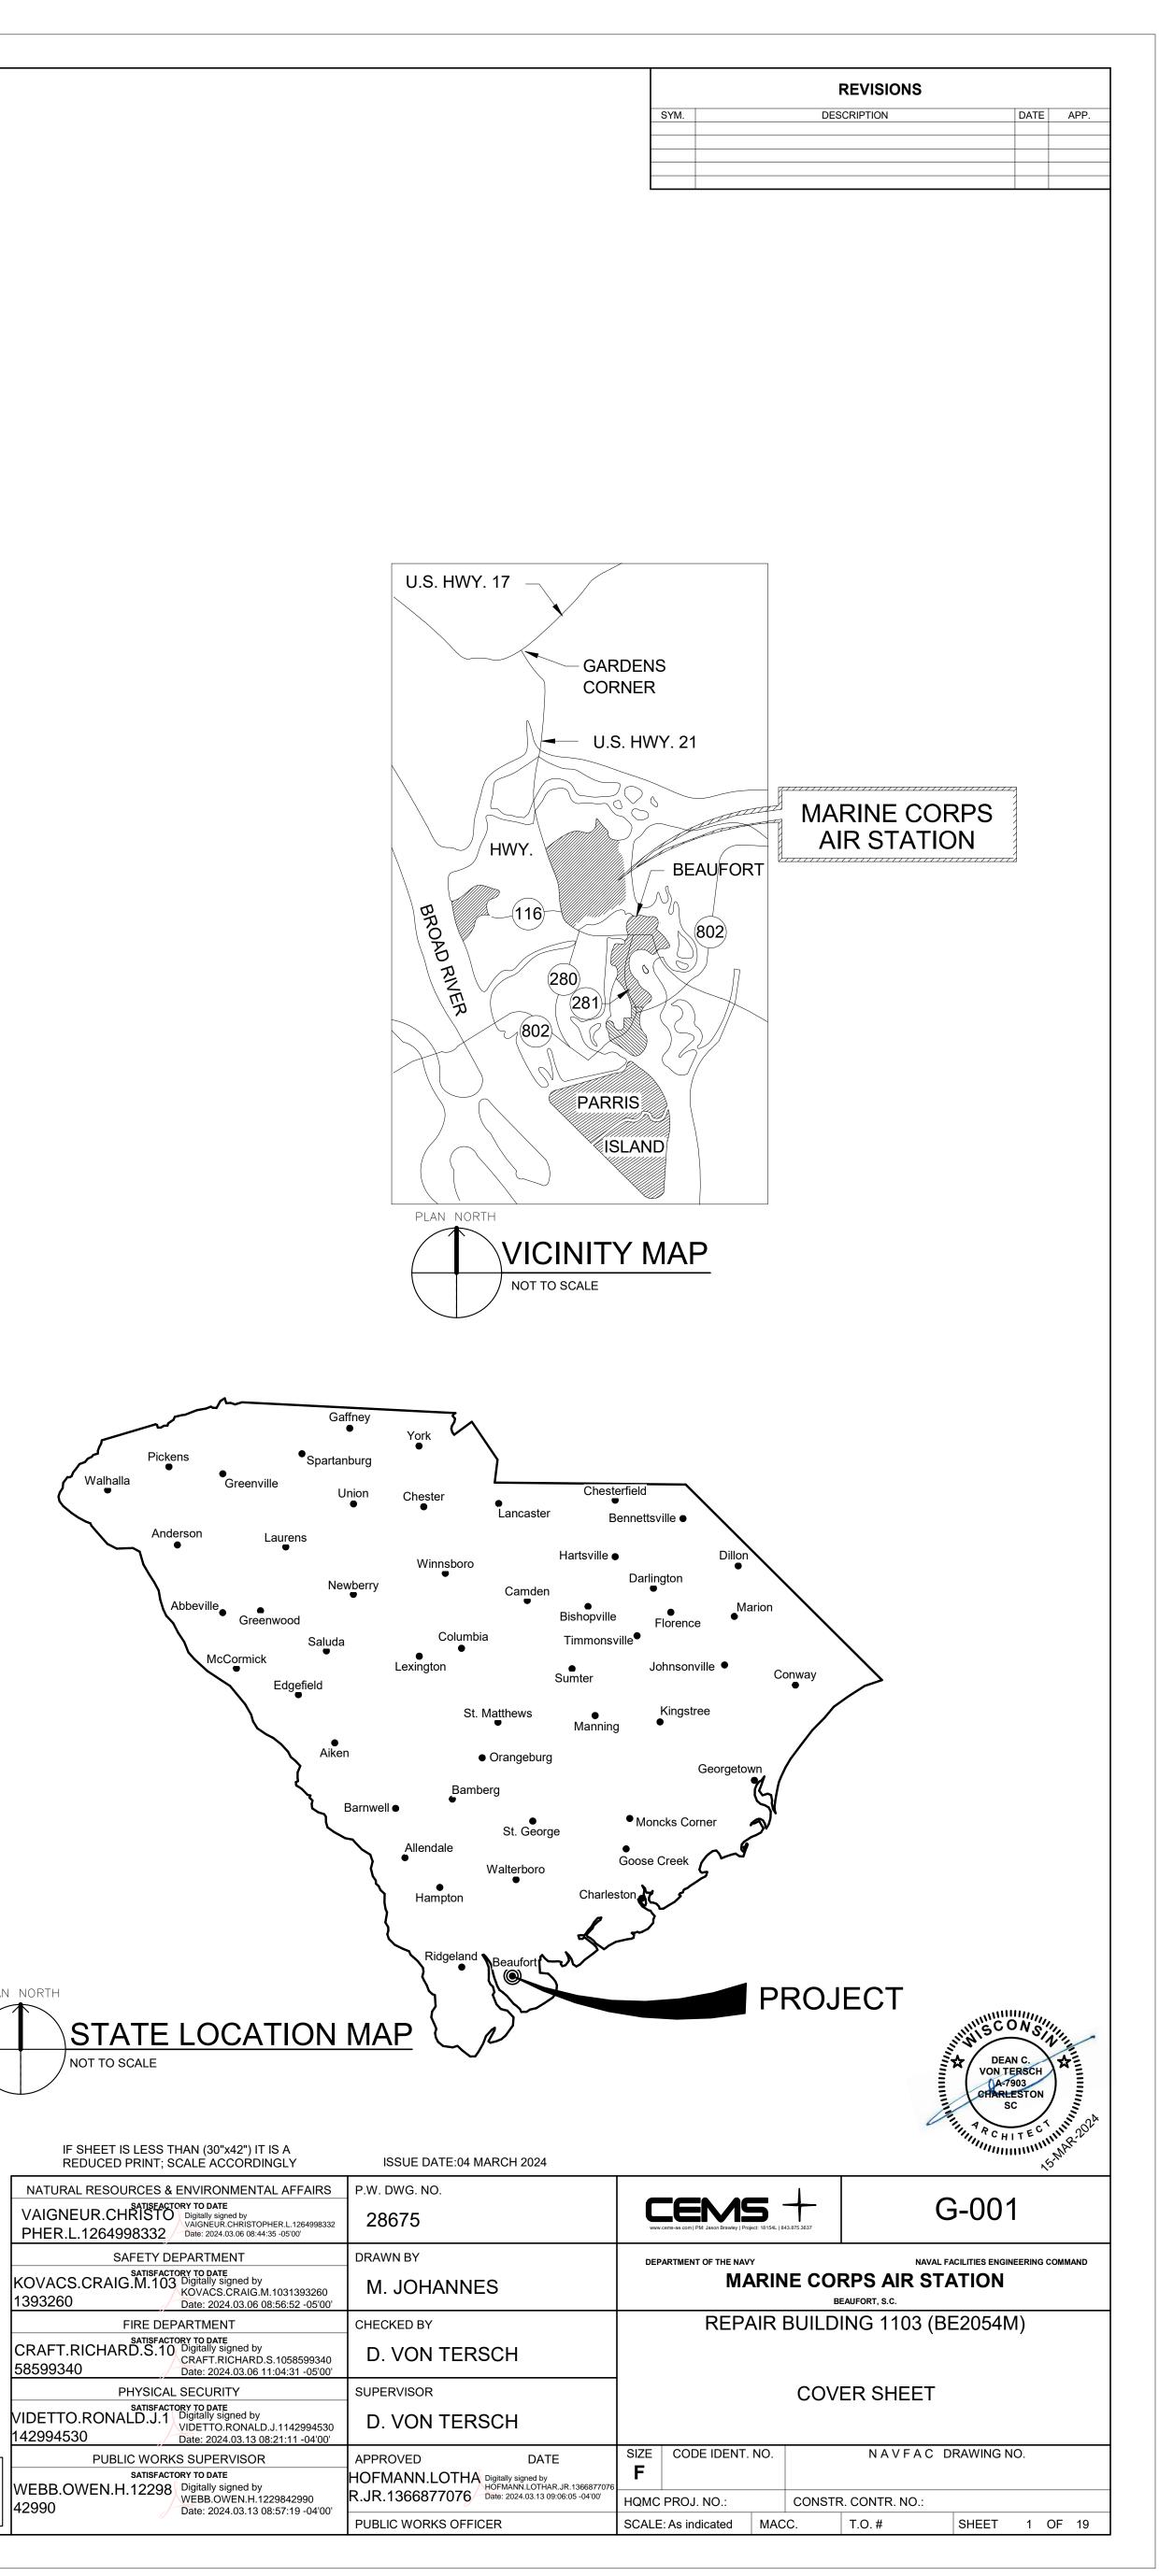




PLAN NORTH STATE LOCATION NOT TO SCALE	Hampton Charles Ridgeland Beaufort MAP	ston
IF SHEET IS LESS THAN (30"x42") IT IS A REDUCED PRINT; SCALE ACCORDINGLY	ISSUE DATE:04 MARCH 2024	
NATURAL RESOURCES & ENVIRONMENTAL AFFAIRS	P.W. DWG. NO.	
SATISEACTORY TO DATE VAIGNEUR.CHRISTO Digitally signed by VAIGNEUR.CHRISTO VAIGNEUR.CHRISTOPHER.L.1264998332 PHER.L.1264998332 Date: 2024.03.06 08:44:35 -05'00'	28675	www.cems-ae.com PM: Ja
SAFETY DEPARTMENT	DRAWN BY	DEPARTMENT OF
SATISFACTORY TO DATE		

YOUR SIGNATURE ON THIS COVER SHEET APPROVES ALL SHEETS ASSOCIATED WITH 42990 THIS SET OF DRAWINGS.

1393260

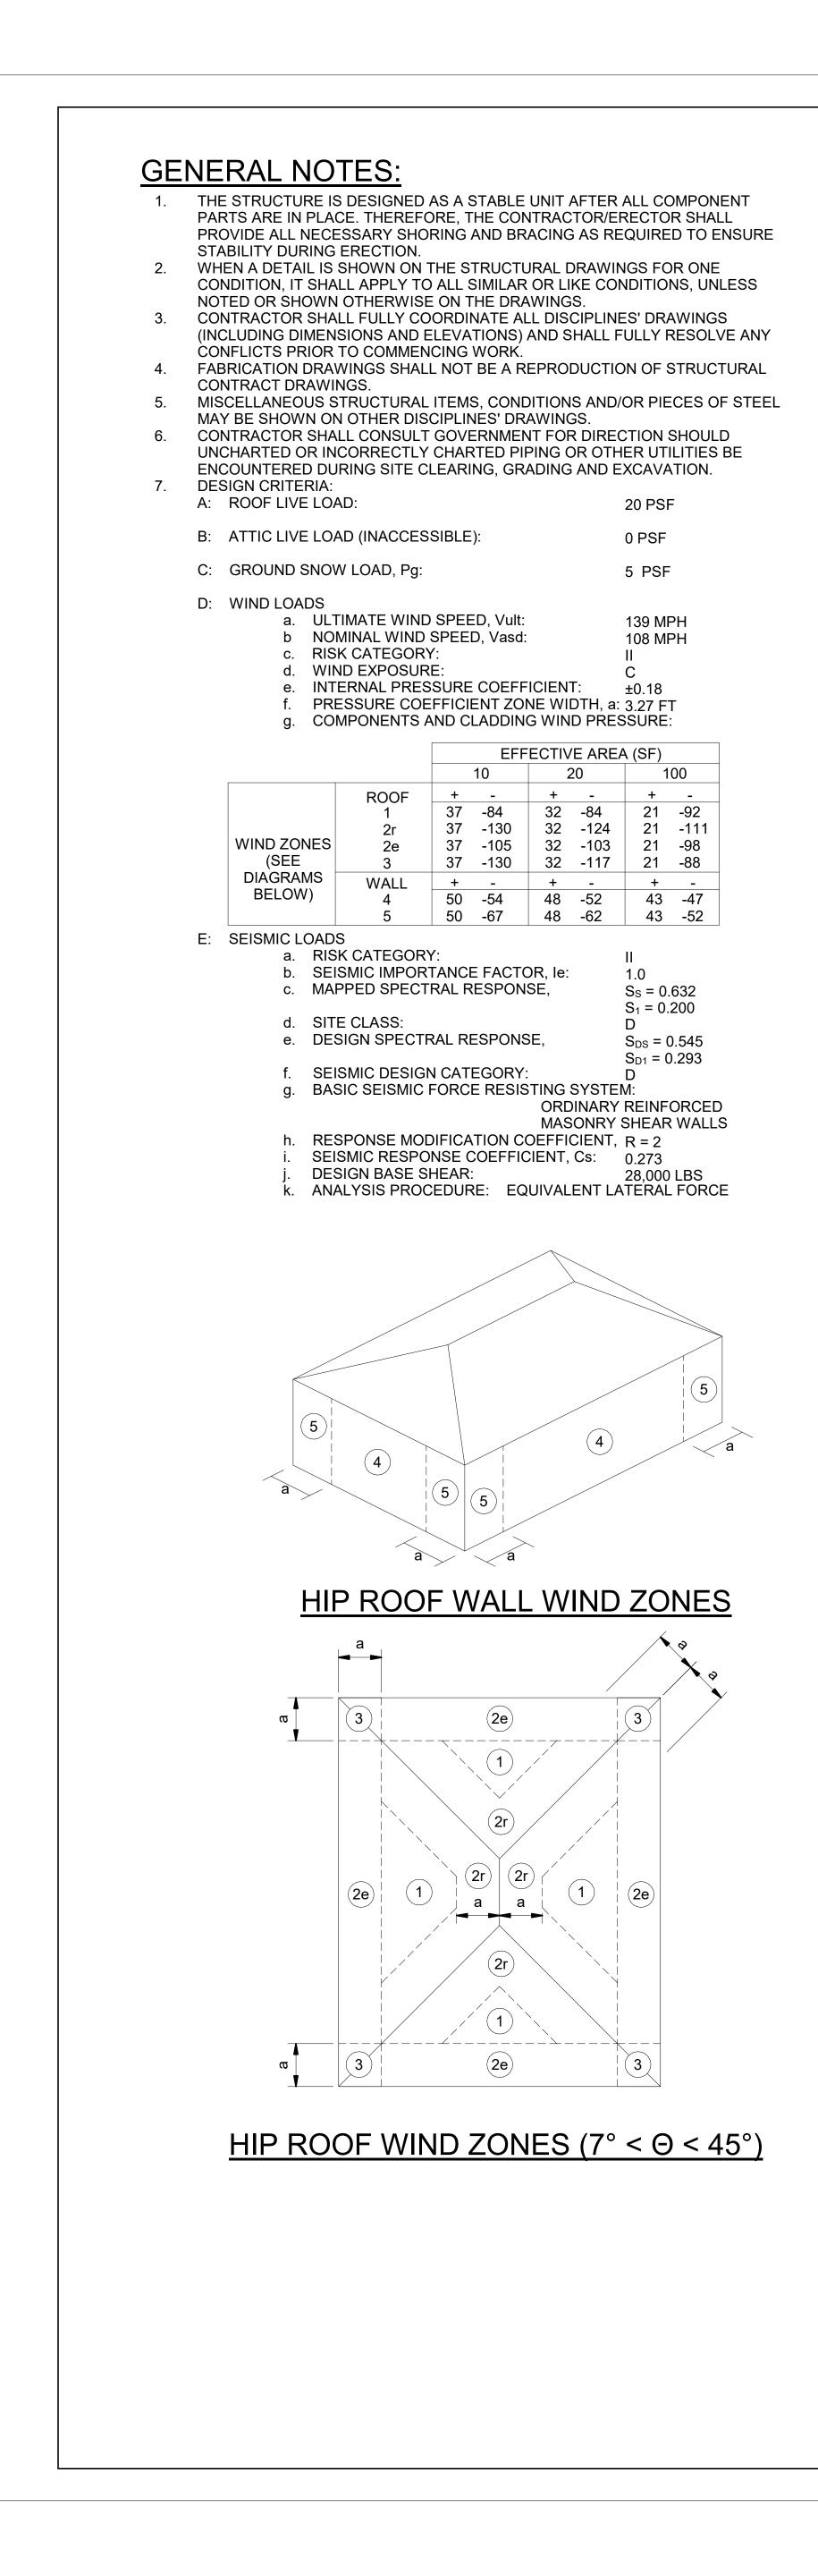58599340



FOUNDATION NOTES:

- STRUCTURAL FOUNDATION DESIGN IS BASED UPON AN ASSUMED ALLOWABLE SOIL BEARING CAPACITY OF 2,000 PSF.
- ALL FOUNDATIONS ARE TO BEAR ON UNDISTURBED IN-SITU SOIL OR ON TESTED STRUCTURAL BACKFILL. FILL SHALL BE PLACED IN UNIFORM LIFTS OF NO MORE THAN 8 INCHES THICK AND COMPACTED TO 95% MODIFIED PROCTOR VALUE FOR BACKFILL IN ACCORDANCE WITH ASTM D-1557 (THIS INCLUDES THE LAYER OF CLEAN WASHED SAND OR STONE FOR SLABS ON GRADE). THE MAXIMUM PARTICLE SIZE FOR FILL PLACEMENT SHALL NOT EXCEED 2/3 OF THE LIFT THICKNESS.
- MAINTAIN POSITIVE SURFACE DRAINAGE TO PREVENT THE ACCUMULATION OF WATER IN EXCAVATED AREAS. MATERIAL TO BE USED AS FILL SHALL BE TESTED BY AN APPROVED
- TESTING LABORATORY TO DETERMINE SUITABILITY PRIOR TO BEING PLACED.
- REMOVE ALL ORGANIC AND DELETERIOUS MATERIAL SURFACE AREAS AT GRADE AND AREAS TO RECEIVE FILL SOILS SHALL BE DETERMINED WITHIN ±2 PERCENTAGE POINTS OF THE OPTIMUM MOISTURE CONTENT DETERMINED FROM THE MODIFIED PROCTOR TEST.

CONCRETE NOTES:

- 1. FOOTINGS: EXPOSURE CLASSES: F2,S0,W1,C1 CONCRETE COMPRESSIVE STRENGTH AT 28 DAYS: fc = 4,500 psi (SEE SPECS) AIR CONTENT 0.45
- MAXIMUM WATER/CEMENTITIOUS RATIO (w/cm): REINFORCING STEEL SHALL BE ASTM A615, GRADE 60.
- PROPORTION AND DESIGN CONCRETE MIXES TO RESULT IN CONCRETE SLUMP AT POINT OF PLACEMENT NOT LESS THAN 3" AND NOT MORE THAN 5". ADDITION OF WATER TO READY-MIX IN THE FIELD SHALL NOT BE ALLOWED.
- DEPOSIT CONCRETE IN A CONTINUOUS OPERATION UNTIL THE PLACING OF CONCRETE IS COMPLETE. IF POUR IS TO BE DISCONTINUOUS, CONTRACTOR SHALL USE CONSTRUCTION JOINTS.
- CONCRETE MUST BE CURED FOR A MINIMUM 21 DAYS PRIOR TO ANY ADHESIVE ANCHOR INSTALLATION.
- SEE SECTION 20.5 OF ACI 318 FOR MINIMUM REINFORCEMENT PROTECTION REQUIREMENTS.
- SEE SPECIFICATION SECTION 03 30 00 FOR ADDITIONAL INFORMATION. WHERE SPECIFIED, GROUT SHALL BE NONSHRINK, ASTM C1107 WITH MINIMUM 4,500 PSI COMPRESSIVE STRENGTH AT 28 DAYS. PROVIDE GROUT
- FLOWABILITY AS REQUIRED TO ENSURE FULL CONSOLIDATION. 10. TYPICAL CLASS B, NON-TOP BAR, REINFORCEMENT SPLICES SHALL BE AS FOLLOWS UNLESS OTHERWISE NOTED:

		LA	P DISTA	NCE BY	BAR SIZE	=
		#4	#5	#6	#7	#8
f'c (PSI) 4	4,500	16"	19"	27"	45"	59"

MASONRY NOTES:

- TYPICAL UNITS SHALL BE TWO-CELL TYPE UNITS AND LINTELS SHALL BE U-SHAPED UNITS. BOND BEAM UNITS MAY BE U-SHAPED OR TWO-CELL KNOCK-OUT BLOCKS.
- MORTAR SHALL BE TYPE S WITH AN AVERAGE COMPRESSIVE STRENGTH OF 1,800 PSI AT 28 DAYS CONFORMING TO ASTM C270. CONCRETE MASONRY SHALL BE GRADE AS SPECIFIED BY ASTM C90. NET AREA COMPRESSIVE STRENGTH OF CONCRETE MASONRY UNIT SHALL BE A MIN. 2,000 PSI. MINIMUM SPECIFIED COMPRESSIVE STRENGTH (f'm) SHALL BE 2,000 PSI PER TABLE 2 OF TMS 602-16
- SPECIFICATIONS. GROUT FOR USE IN MASONRY SHALL CONFORM TO ASTM C476 WITH A MINIMUM COMPRESSIVE STRENGTH OF 2,000 PSI AT 28 DAYS.
- ALL MASONRY SHALL BE LAID IN A RUNNING BOND U.N.O. SEE SPECIFICATION SECTION 04 20 00 FOR ADDITIONAL INFORMATION.

LAP DISTANCE BY BAR SIZE				
				<u>-</u>
BAR CMU	#3	#4	#5	#6
8" CMU	12.0"	12.2"	19.5"	28.5"
12" CMU	12.0"	12.0"	12.4"	18.0"

STRUCTURAL STEEL:

- 3/4" DIAMETER BOLTS SHALL BE USED IN ALL STRUCTURAL STEEL BOLTED CONNECTIONS UNLESS NOTED OTHERWISE. TIGHTEN BOLTS TO TENSION REQUIRED BY AISC. ANCHOR RODS SHALL BE ASTM F1554 Gr. 36, THREADED ON EACH END, WITH HEAVY HEX NUT AND WASHER AT EACH END UNLESS OTHERWISE NOTED. MINIMUM ANCHOR ROD LENGTH AND DIAMETER SHALL BE SPECIFIED ON SHEET S-501.
- ALL WELDED CONSTRUCTION SHALL BE IN ACCORDANCE WITH AWS D1.1 AND AISC. WELDING SHALL BE PERFORMED ONLY BY OPERATORS QUALIFIED BY THE AWS
- STANDARD QUALIFICATION PROCEDURE TO PERFORM THE PARTICULAR TYPE OF WORK REQUIRED. MEMBERS IN FINISHED STRUCTURE, INCLUDING LINTELS AND MECHANICAL EQUIPMENT
- SUPPORT FRAMES SHALL BE GALVANIZED AFTER FABRICATION. STEEL BELOW GRADE SHALL BE PROTECTED BY A MINIMUM OF 3" OF CONCRETE OR 4" OF MASONRY.
- GROUT UNDER BEARING PLATES SHALL BE OF NON-SHRINK, NON-METALLIC COMPOSITION. NO SPLICES IN STRUCTURAL FRAMING MEMBERS ARE PERMITTED EXCEPT AS INDICATED OR APPROVED.
- STRUCTURAL STEEL SHALL BE AS FOLLOWS:
- W-SHAPES PLATES, ANGLES, CHANNELS, MISC. STEEL
- C. HSS

9.

BOLTS, TENSION CONTROL D. WELDING ELECTRODE E.

ASTM A992 ASTM A36 ASTM A1085 ASTM F3125, Gr. F1852-X E70XX

COLD-FORMED METAL TRUSS NOTES:

- FORMED STEEL FRAMING TRUSS DESIGN 2012.
- SUBMIT SHOP DRAWINGS AND CALCULATIONS SIGNED AND SEALED BY A REGISTERED ENGINEER.
- RECOMMENDED BY THE TRUSS MANUFACTURER.
- THE TRUSS FRAMING SHOWN IS FOR INTENT OF DESIGN PURPOSES ONLY. 4. DESIGN
- COORDINATE TRUSS GIRDER BEARING POINTS WITH CMU LAYOUT. OTHERWISE
- TRUSS TOP CHORD MEMBERS SHALL BE 16 GA. MINIMUM.
- WEIGHT 10.
- 11.
- DESIGNED BY TRUSS MANUFACTURER.
- 12. AND CLEARANCES PRIOR TO ORDERING TRUSSES.

13.

- 14. SEE SPECIFICATION SECTION 05 40 00 FOR ADDITIONAL INFORMATION.
 - TOP CHORD LIVE LOAD
 - TOP CHORD DEAD LOAD BOTTOM CHORD DEAD LOAD

STEEL DECK NOTES:

STEEL DECK SHALL BE MINIMUM 3 SPAN CONDITION WITH THE FOLLOWING MINIMUM PROPERTIES. ROOF:

> TYPE 1.5B-36 I_d + = 0.155 in⁴/ft.

> S_e + = 0.169 in³/ft. ΦM_{n} + = 634 lb-ft/f

SEE SPECIFICATION SECTION 05

DESIGN REFERENCES:

FERENCE STANDAR	RDS:
ACI 301-16	SPECIFICATIONS
ACI 318-19	BUILDING CODE
	CONCRETE
AISC 325-17	STEEL CONSTRU
AISI S100-16	SPECIFICATION F
	STEEL STRUCTU
ASCE/SEI 7-16	MINIMUM DESIGN
	FOR BUILDINGS
IBC 2021	INTERNATIONAL
IEBC 2021	INTERNATIONAL
TMS 402/602-16	BUILDING CODE
	STRUCTURES
UFC 1-200-01	DoD BUILDING CO
UFC 3-301-01	STRUCTURAL EN
UFC 4-010-01	DoD MINIMUM AN

RECORD DRAWINGS: 1. RUNWAY APPROACH LIGHTING RUNWAY 04, DATED FEB 28, 1989

COLD-FORMED METAL TRUSSES SHALL BE DESIGNED, FABRICATED AND INSTALLED AS INDICATED ON THE DRAWINGS AND IN ACCORDANCE WITH THE AMERICAN IRON AND STEEL INSTITUTE, NORTH AMERICAN SPECIFICATION FOR THE DESIGN OF COLD-FORMED STEEL STRUCTURAL MEMBERS (2016 EDITION) AND AMERICAN IRON AND STEEL INSTITUTE STANDARD FOR COLD-

PROVIDE HORIZONTAL BRIDGING (PERMANENT AND TEMPORARY) AS

FINAL FRAMING LAYOUT MAY VARY BASED UPON TRUSS MANUFACTURER'S

ROOF TRUSSES TO BE SPACED AT 48" O.C. MAXIMUM UNLESS SHOWN

MAXIMUM LIVE LOAD DEFLECTION SHALL BE SPAN/240 FOR ROOF TRUSSES TOP CORD DEAD LOAD SHOWN BELOW INCLUDES 5 PSF FOR TRUSS SELF-

ROOF TRUSSES SHALL BE DESIGNED FOR APPLICABLE WIND LOADS AS INDICATED IN GENERAL NOTES, IN COMBINATION WITH LOADS SHOWN BELOW. TRUSS TO TRUSS AND TRUSS TO BEARING CONNECTIONS SHALL BE

CONTRACTOR SHALL COORDINATE WITH APPLICABLE MECHANICAL LOADS TRUSS FRAMING SHALL BE GALVANIZED IN ACCORDANCE WITH A653, G60.

15. ROOF TRUSS DESIGN LOADS TO BE AS FOLLOWS: 20 PSF

10 PSF 5 PSF

l _d - = 0.178 in⁴/ft.	22GA
S _e - = 0.179 in³/ft.	Fy = 50 ksi
t ΦM _n - = 671 lb-ft/ft 30 00 FOR ADDITIONAL	INFORMATION.

IS FOR STRUCTURAL CONCRETE REQUIREMENTS FOR STRUCTURAL

UCTION MANUAL, 15TH EDITION FOR THE DESIGN OF COLD-FORMED URAL MEMBERS SN LOADS AND ASSOCIATED CRITERIA S AND OTHER STRUCTURES

BUILDING CODE, 2021 EDITION L EXISTING BUILDING CODE, 2021 EDITION REQUIREMENTS FOR MASONRY

CODE, CHANGE 2, 12 JUNE 2023 NGINEERING, CHANGE 1, 02 OCT 2023 DoD MINIMUM ANTITERRORISM STANDARDS FOR BULDINGS, CHANGE 2, 30 JULY 2022

STRUC	CTURAL ABBREVIA	TIONS:	
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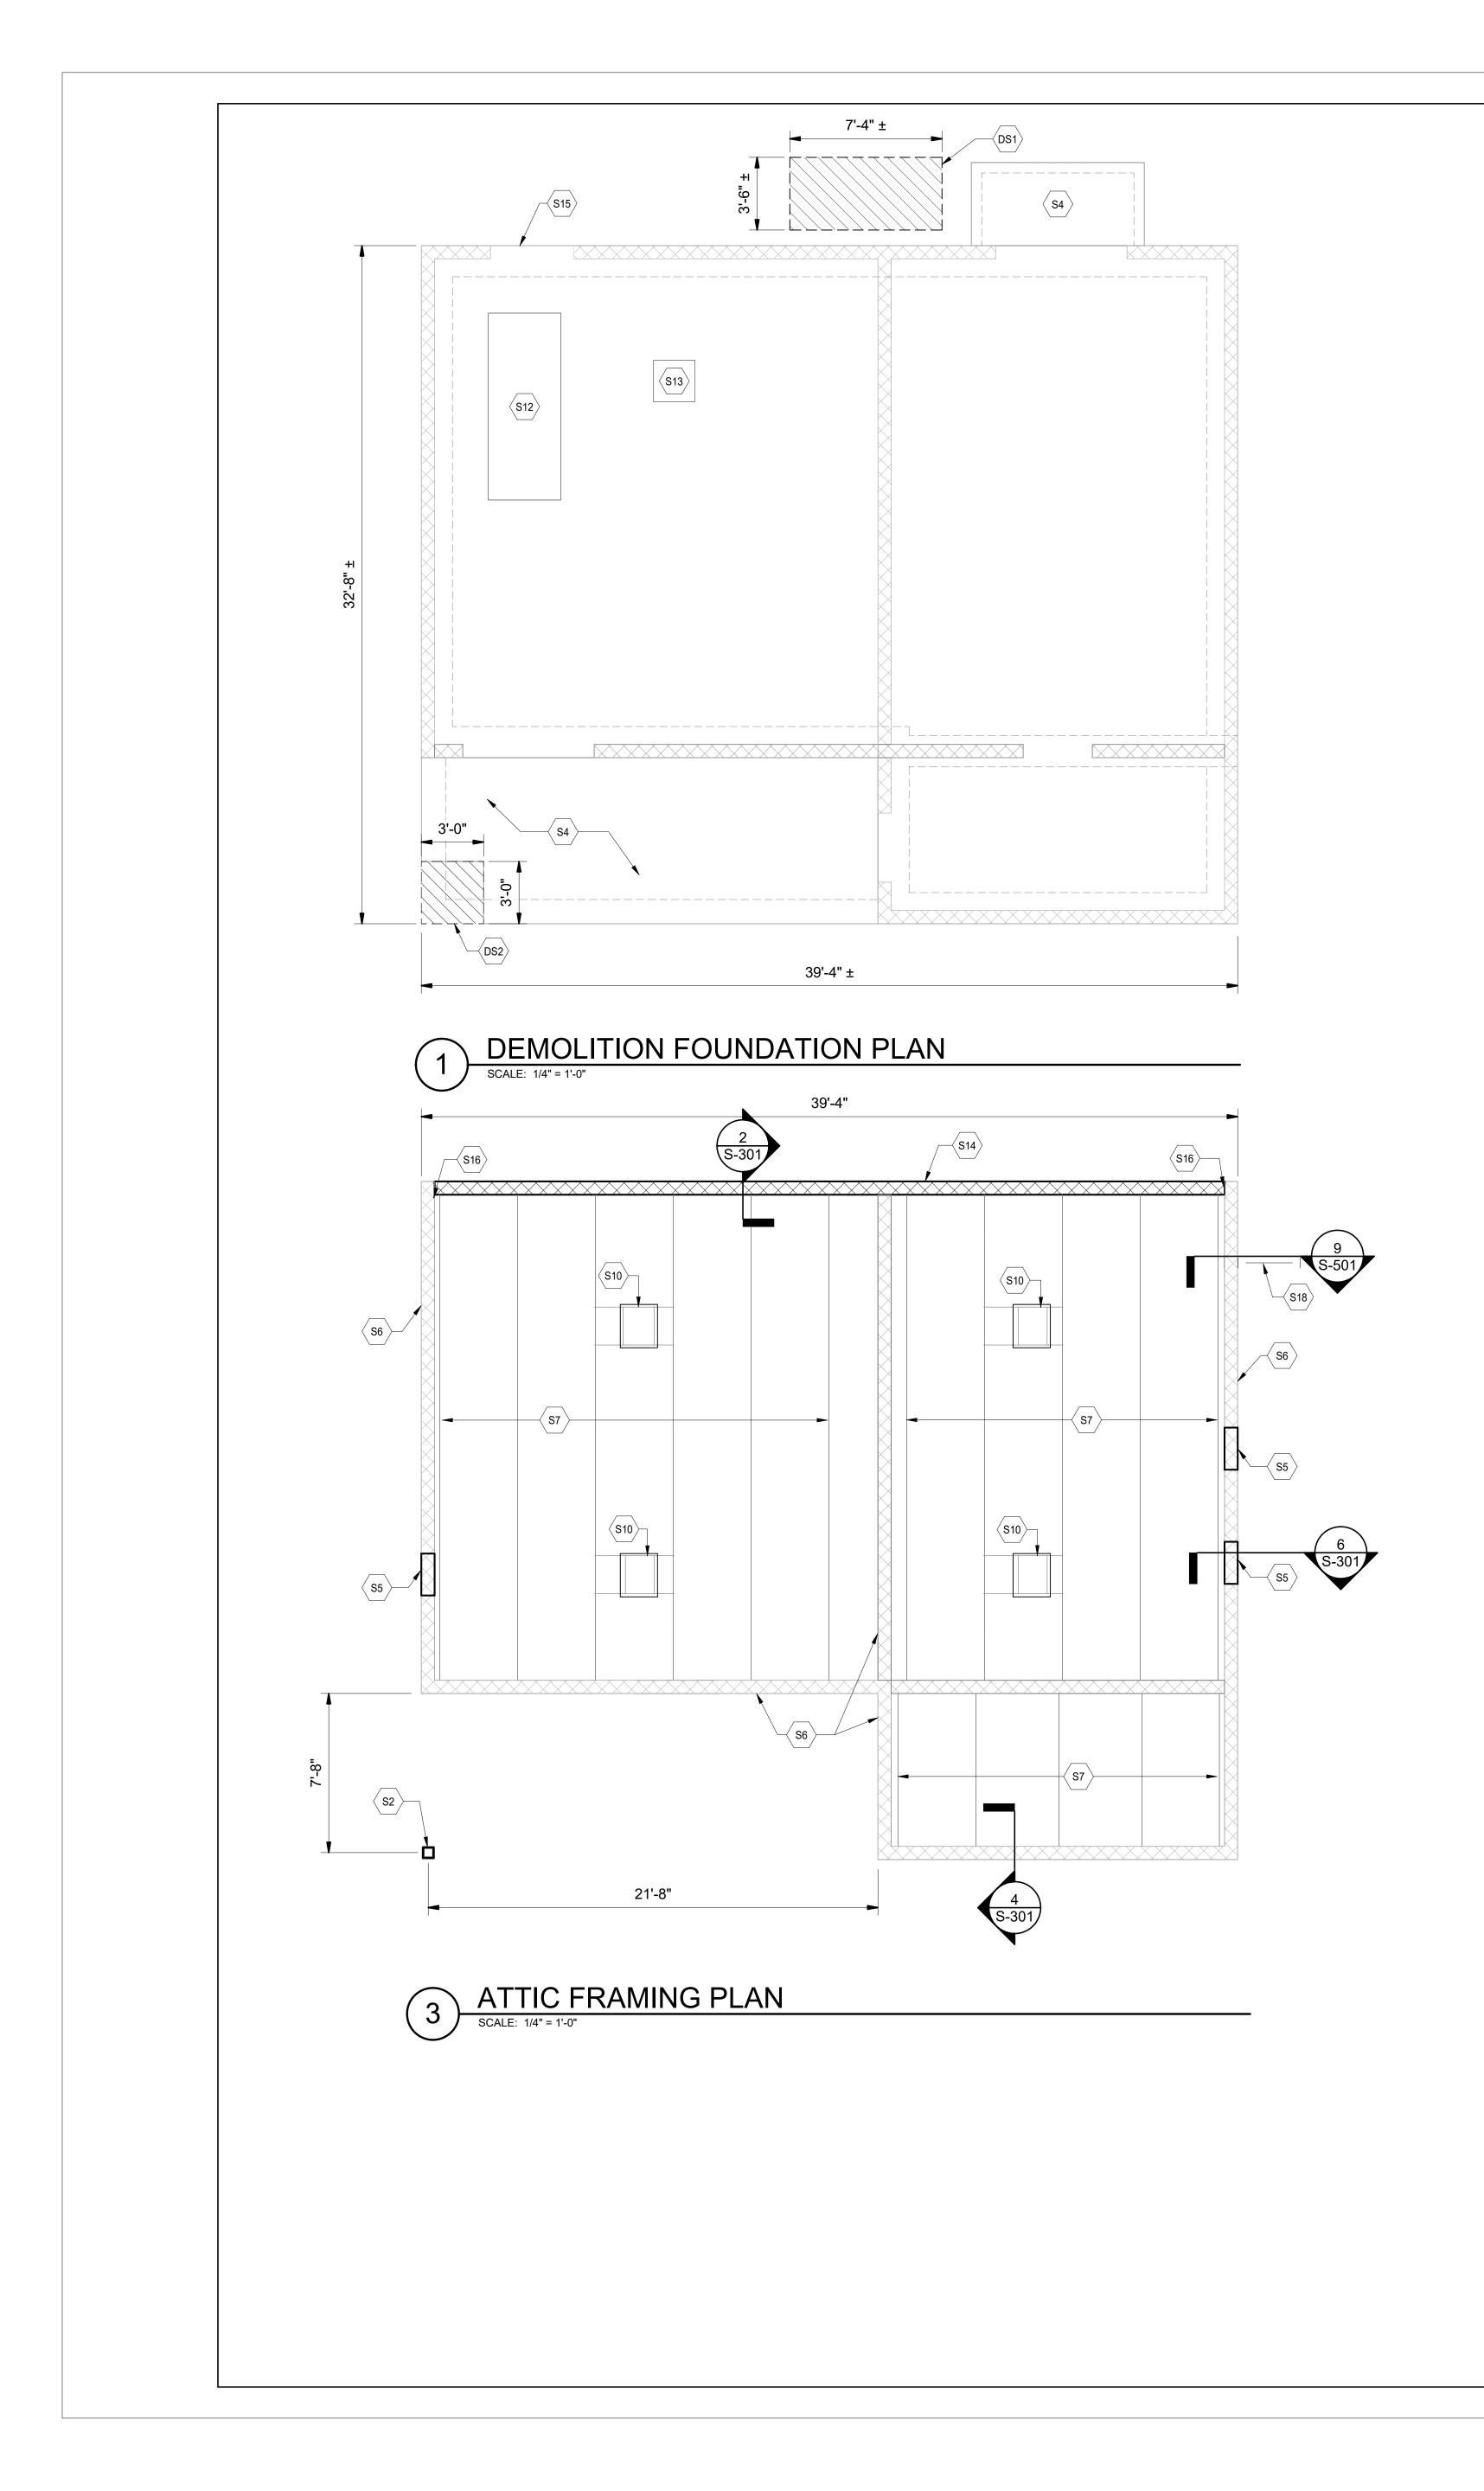
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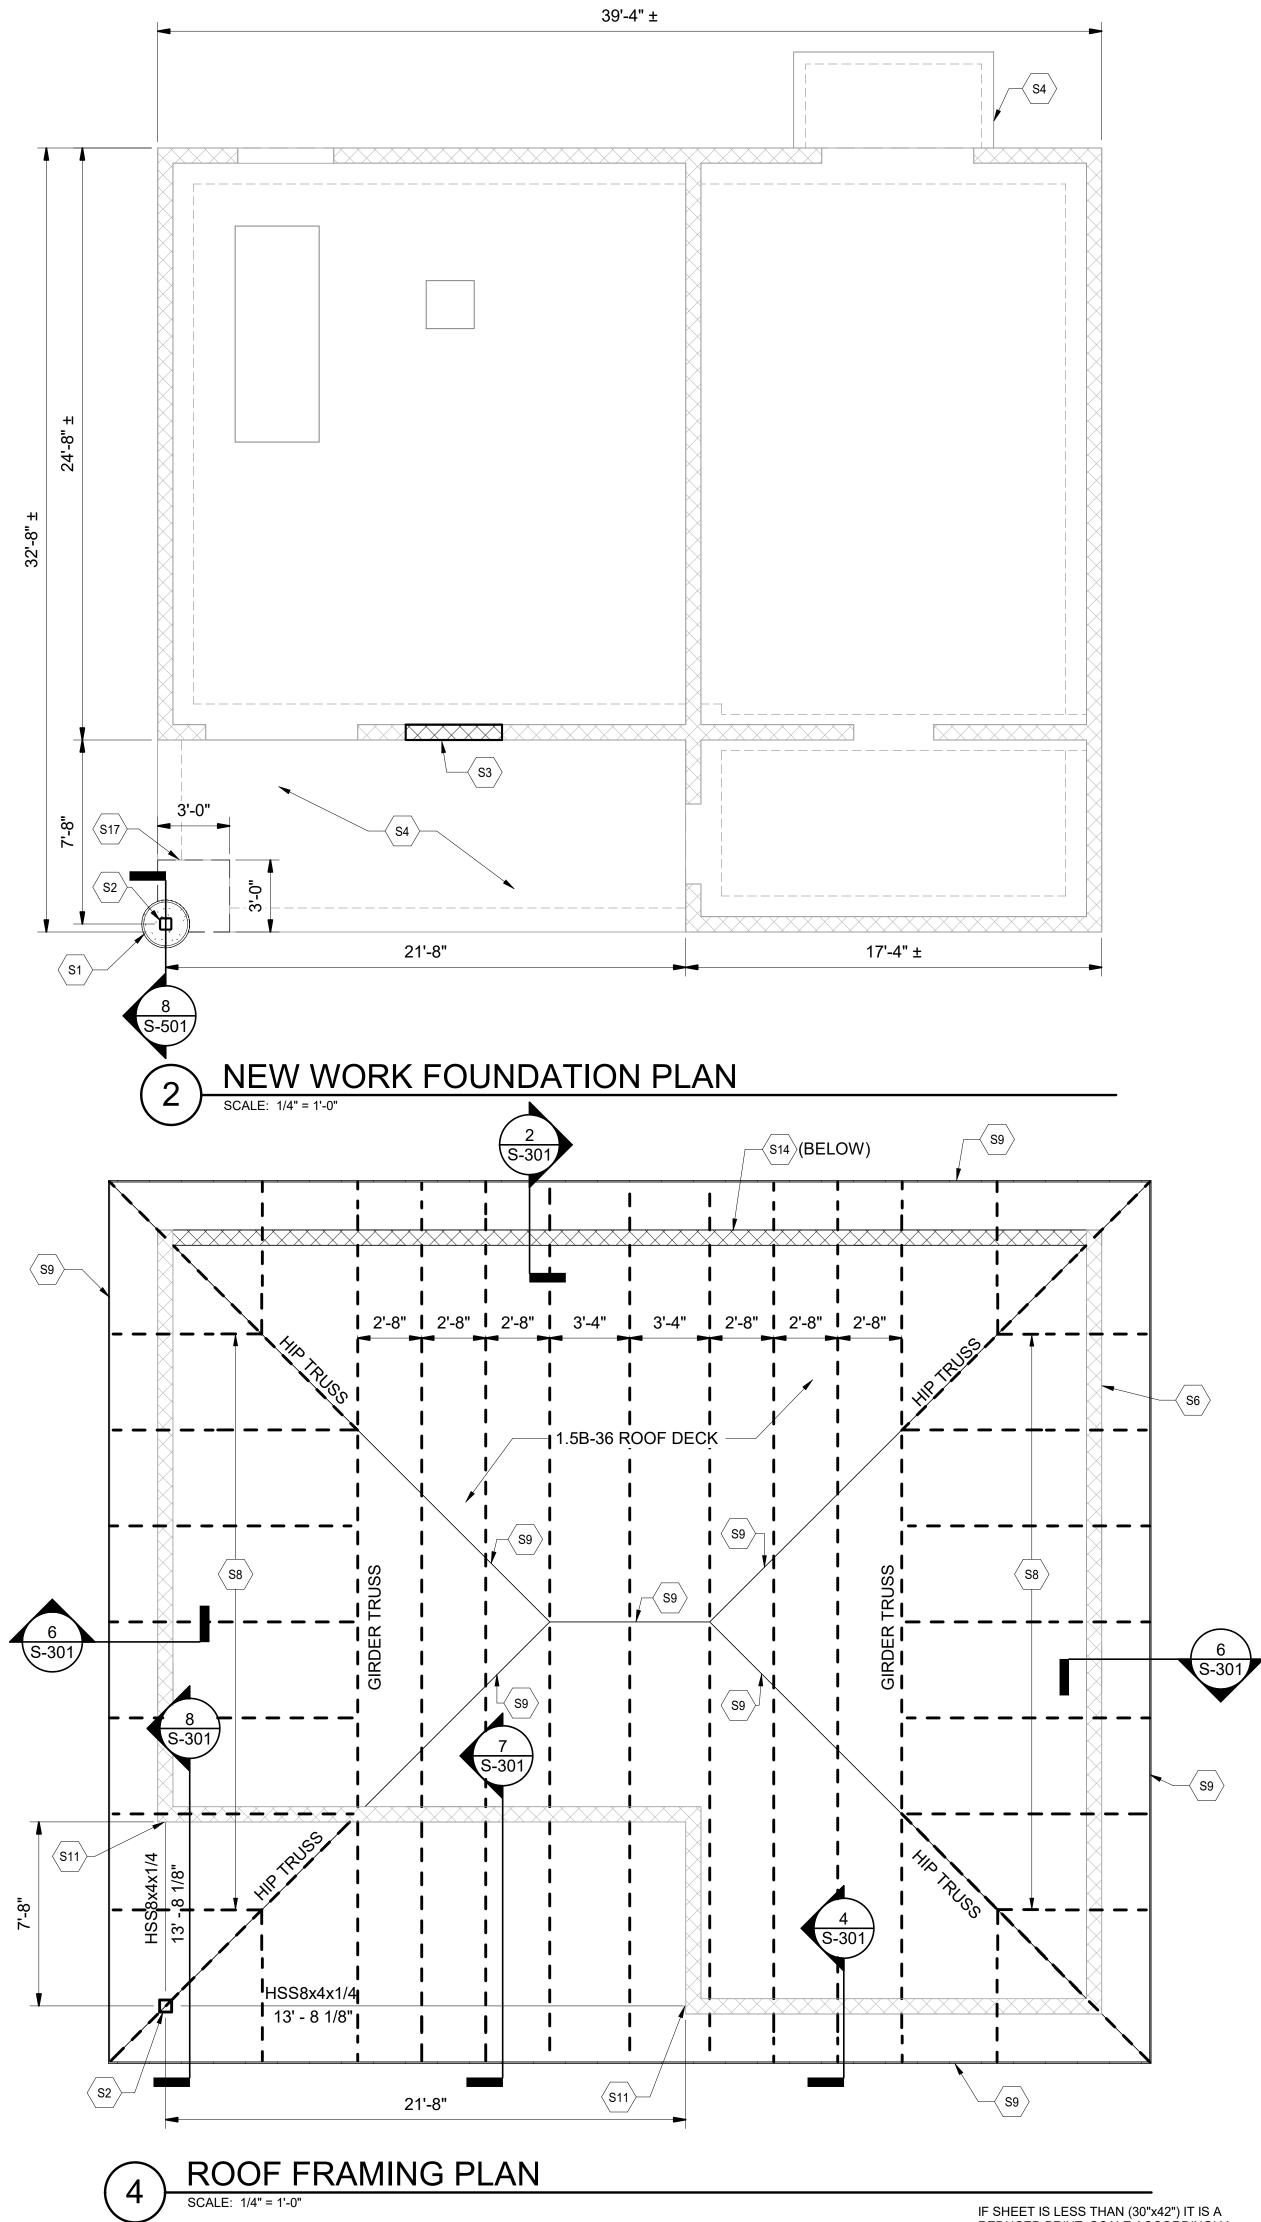
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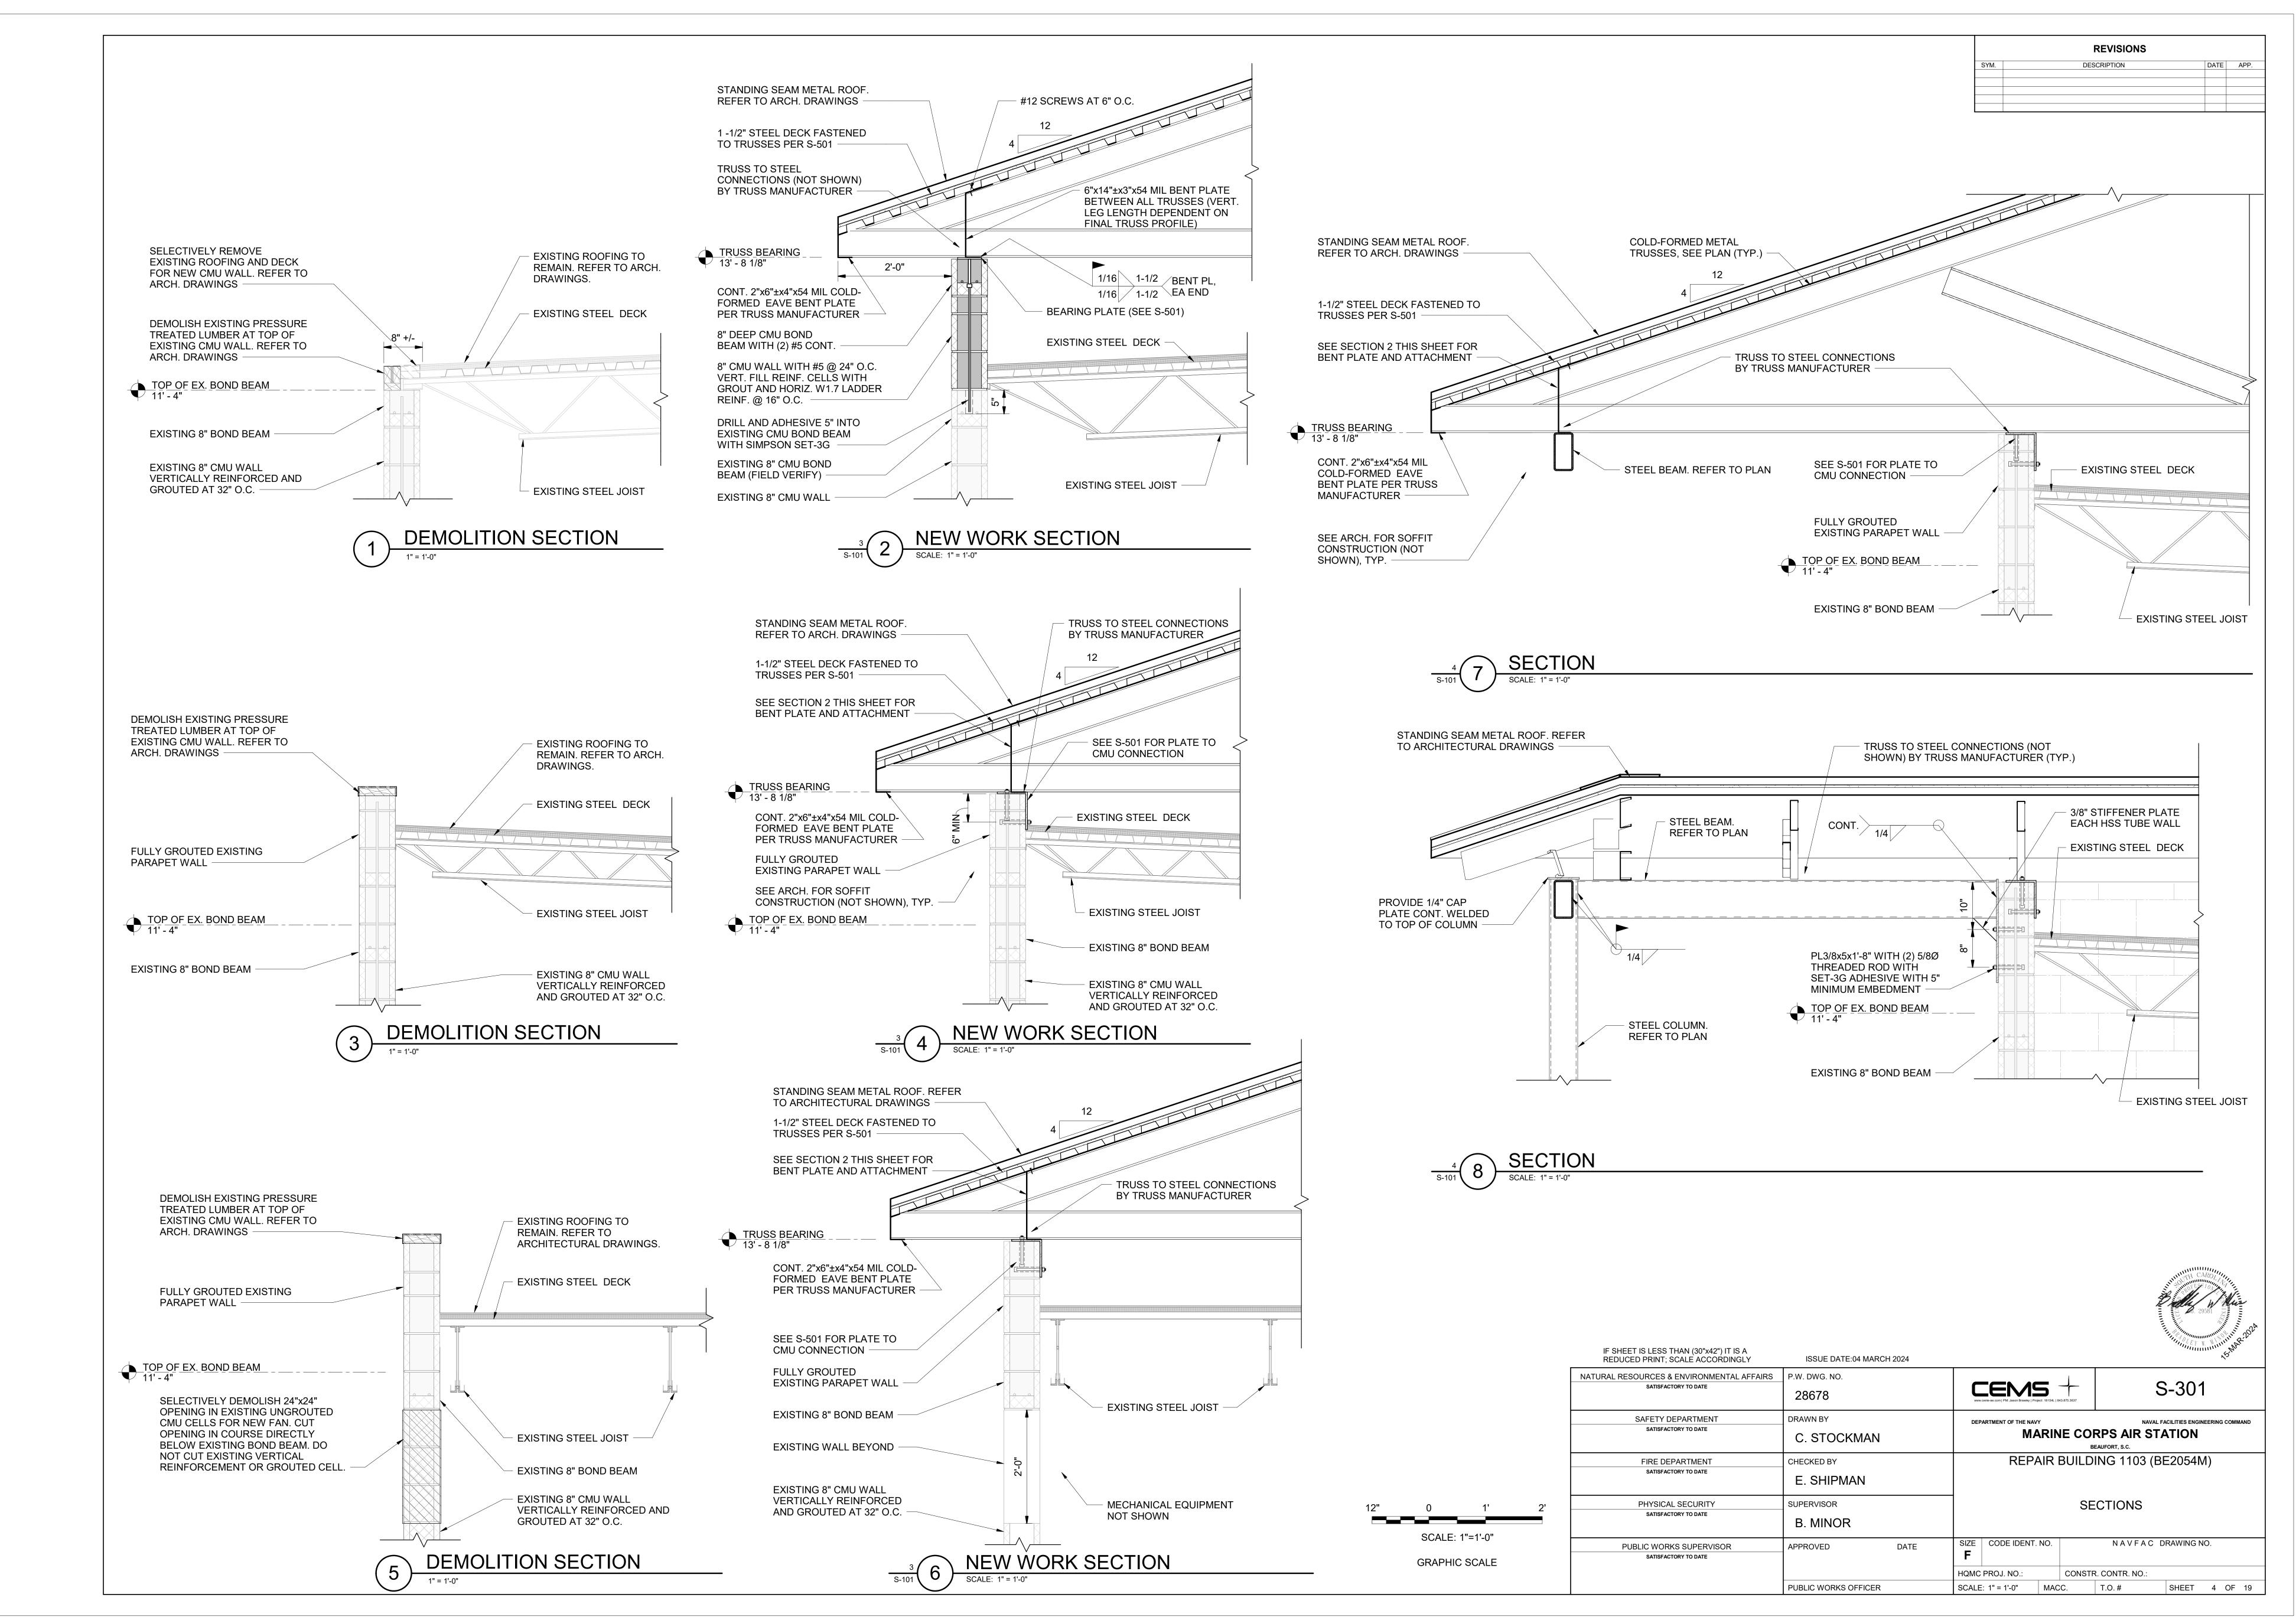
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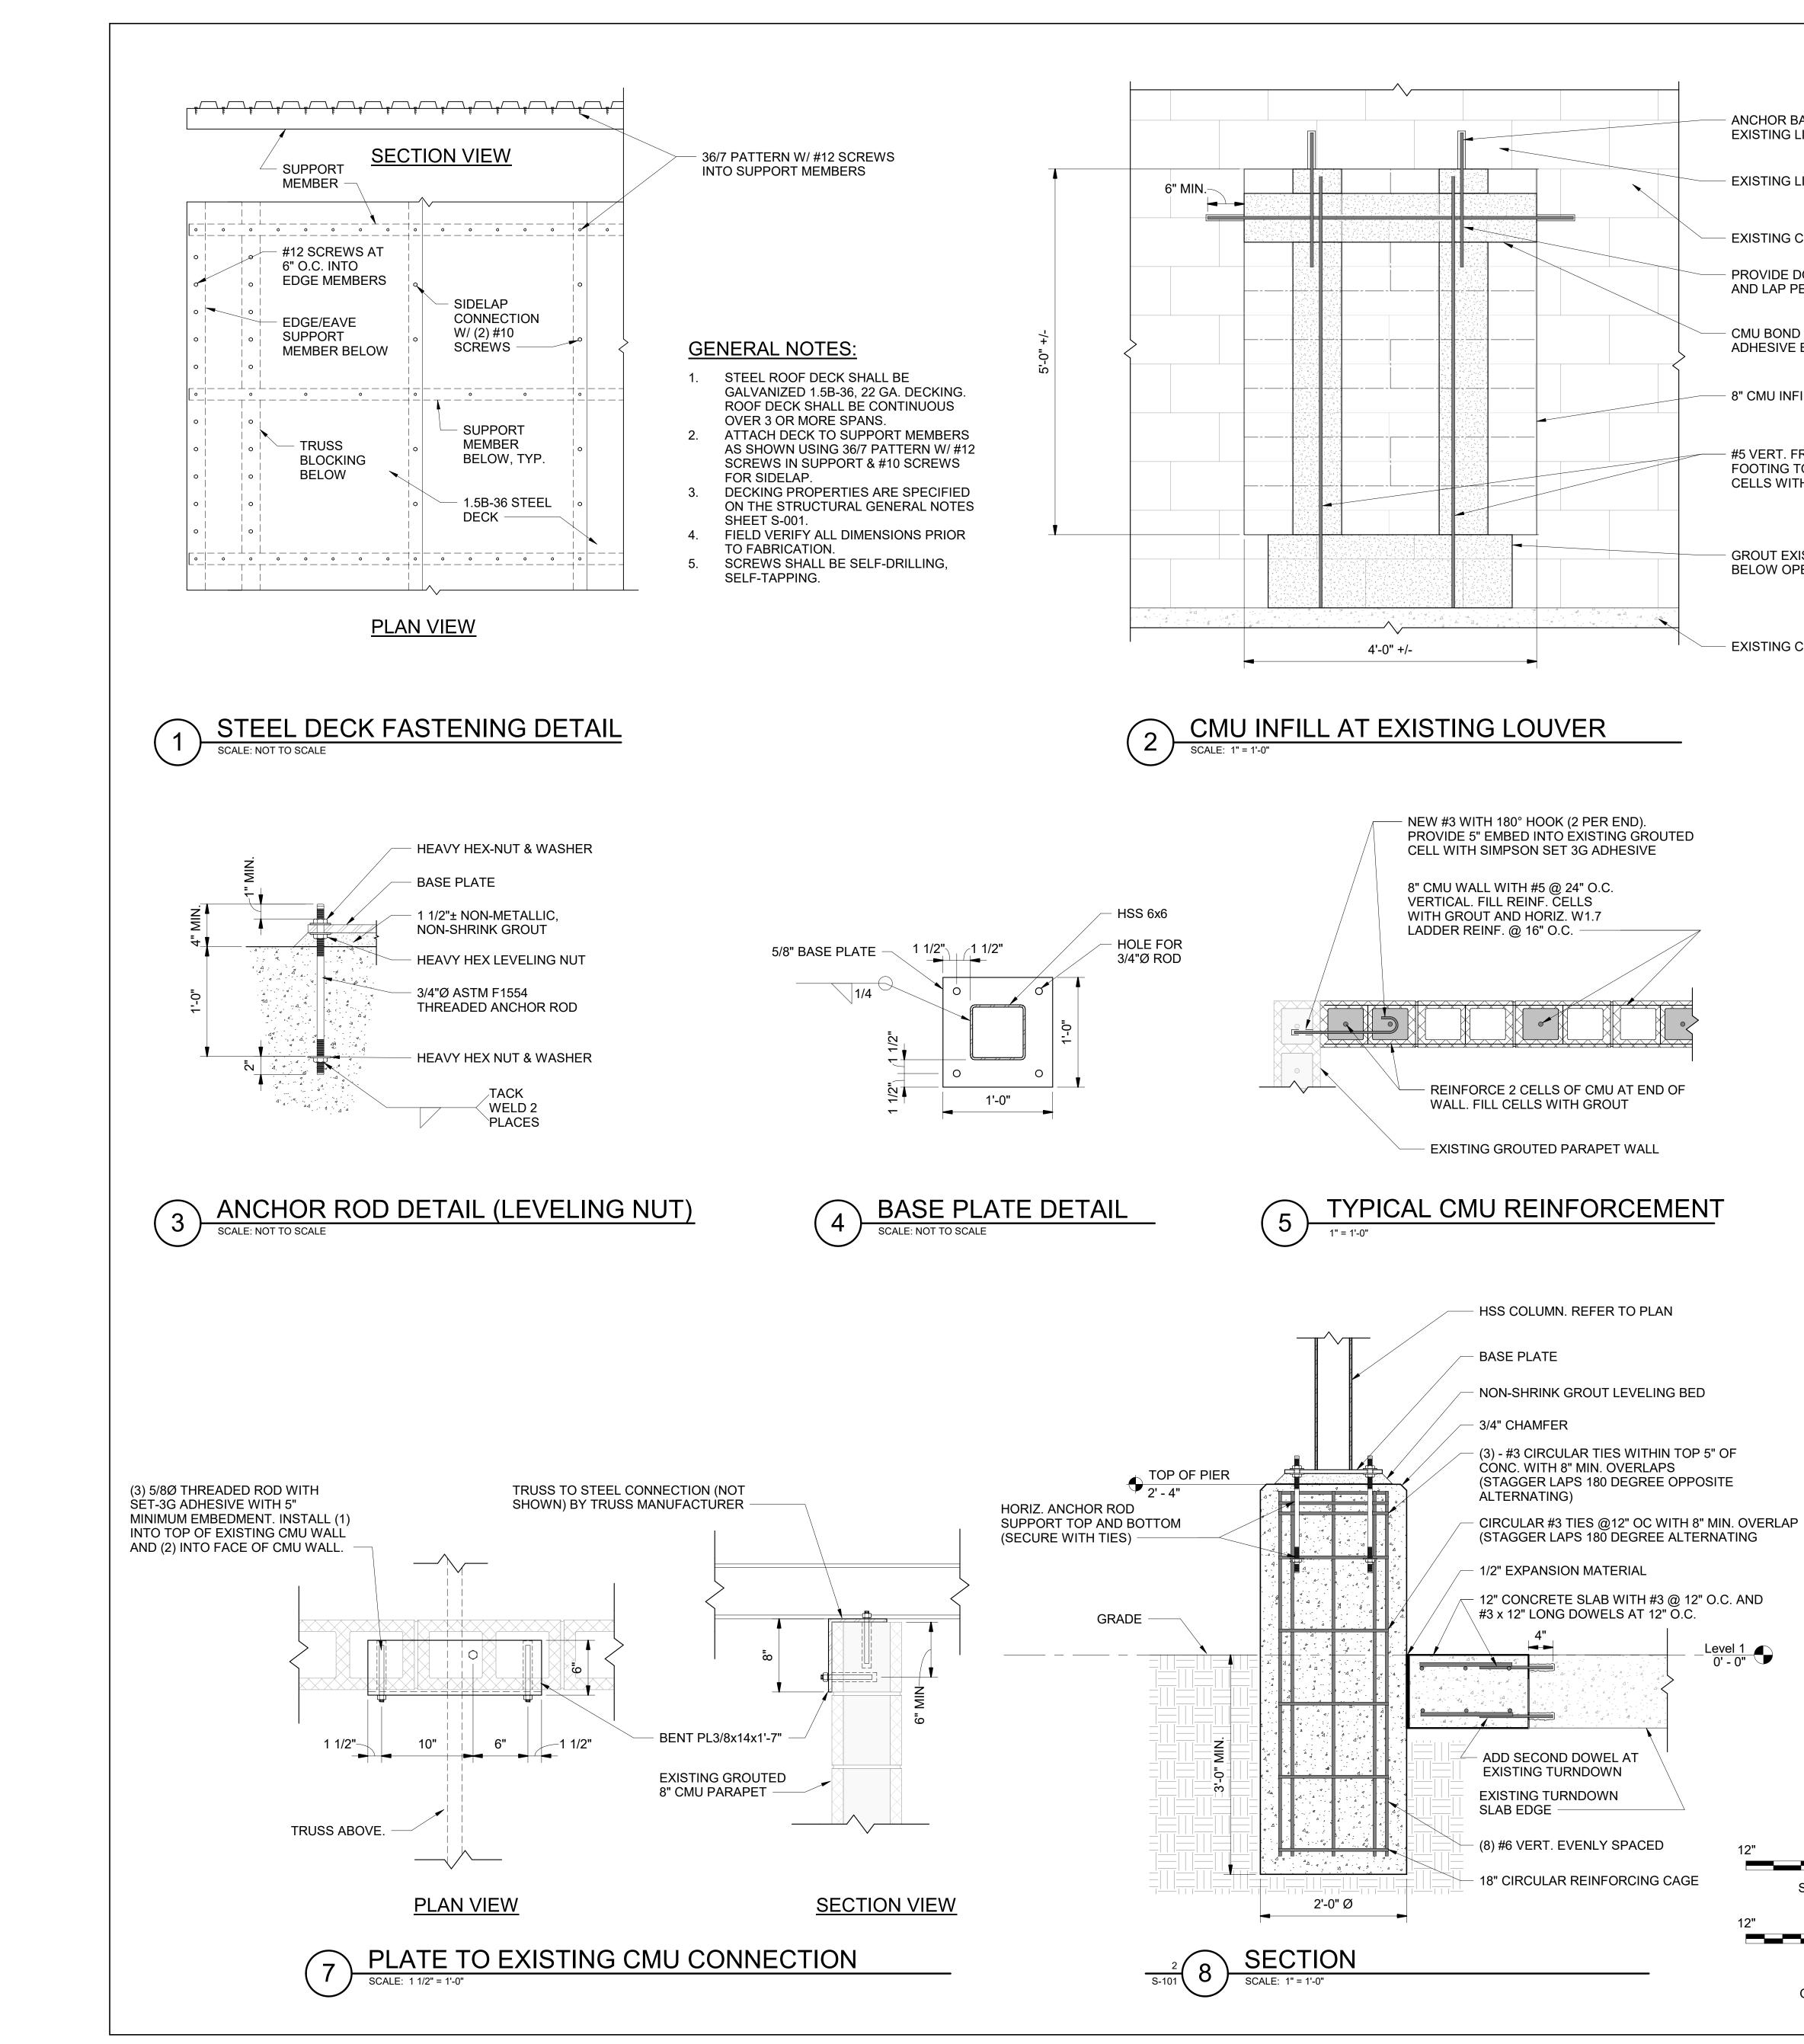
DS1	EXISTING 18"+ LOCATED ELS DEMOLISH/RE
DS2	WITH ARCHITE DEMOLISH EX NEW COLUMN
S1	24" DIA. x 5'-4"
S2	HSS6x6x3/8 S1
S3	8" CMU WALL S-501).
S4	EXISTING 4" S THICKENED S
S5	24" x 24" OPEN FOR MECHAN AS REQUIRED UNGROUTED 5/S-301).
S6	EXISTING 8" C
S7	EXISTING STE
S8	PRE-ENGINEE TRUSSES AT 4 SUPPORTING BE DESIGNED
S9	COLD-FORME MEMBERS. ME TRUSSES BY I
S10	PROVIDE SHE EXISTING EXH WITH ARCH.
S11	BEAM CONNE REFER TO SE
S12	EXISTING GEN
S13	EXISTING SUM
S14	NEW 8" CMU V
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S16	SEE S-501 FOI AND NEW TO
S17	INFILL WITH 12 REFER TO SE
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. NOTES	
CONDITIONS PER ORIGINAL	
AND NON-DESTRUCTIVE	
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RMEDIATE COLD-FORMED	
EYNOTES	
+/- THICK CONCRETE SLAB MAY BE SEWHERE ON SITE.	
EMOVE FROM SITE. COORDINATE ECTURAL DEMOLITION SHEETS.	
ISTING SLAB AS REQUIRED FOR FOUNDATION.	
CONCRETE PEDESTAL. TEEL COLUMN.	
INFILL AT EXISTING LOUVER (SEE	
SLAB ON GRADE WITH 12" SLAB EDGE.	
NINGS IN EXISTING CMU WALLS	
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CMU WALL.	
EEL JOISTS. ERED COLD-FORMED METAL	
48" O.C. MAX U.N.O. TRUSS TO STRUCTURE CONNECTIONS SHALL	
D BY TRUSS MANUFACTURER.	
EMBERS AND CONNECTIONS TO MANUFACTURER.	
ET METAL CAP ATOP CURB OF HAUST FAN OPENING. COORDINATE	
CTION TO EXISTING CMU WALL.	
CTIONS ON S-301. NERATOR PAD TO REMAIN.	
MP TO REMAIN. WALL. REFER TO SECTIONS.	
JVER OPENING TO REMAIN. R TYPICAL CMU REINFORCEMENT	
EXISTING PARAPET CONNECTION. 2" CONCRETE SLAB ON GRADE.	
CTION ON S-501.	
RAL AND ELECTRICAL FOR NFORMATION.	
CHECKROL	
B. 29581	
C. 29581	
······································	
S-101	
CORPS AIR STATION	
BEAUFORT, S.C. LDING 1103 (BE2054M)	
AND NEW WORK PLANS	
N A V F A C DRAWING NO.	
ISTR. CONTR. NO.:	
T.O. # SHEET 3 OF 19	



NATURAL RESOURCES & ENVIRONMENTAL AFFAIRS			
SATISFACTORY TO DATE	P.W. DWG. NO. 28678	WWW.CEMB-ae.com PM: Jason Brawley Project: 1815	154L 843.875.3637
SAFETY DEPARTMENT SATISFACTORY TO DATE	DRAWN BY C. STOCKMAN	DEPARTMENT OF THE NAVY	
FIRE DEPARTMENT SATISFACTORY TO DATE	CHECKED BY E. SHIPMAN	REPAIF	र BUILD
SATISFACTORY TO DATE	SUPERVISOR B. MINOR		SE
SCALE: 1"=1'-0" PUBLIC WORKS SUPERVISOR GRAPHIC SCALE SATISFACTORY TO DATE	APPROVED DATE	SIZE CODE IDENT. NO).
		HQMC PROJ. NO.:	CONST
	PUBLIC WORKS OFFICER	SCALE: 1" = 1'-0" M/	IACC.



ANCHOR BARS 5" MIN. INTO EXISTING LINTEL WITH ADHESIVE

EXISTING LINTEL

— EXISTING CMU WALL

PROVIDE DOWELS AS REQUIRED AND LAP PER S-001


CMU BOND BEAM WITH (2) #5 ADHESIVE BARS INTO EXISTING CMU


8" CMU INFILL

#5 VERT. FROM TOP OF NEW FOOTING TO EXISTING LINTEL. FILL CELLS WITH GROUT

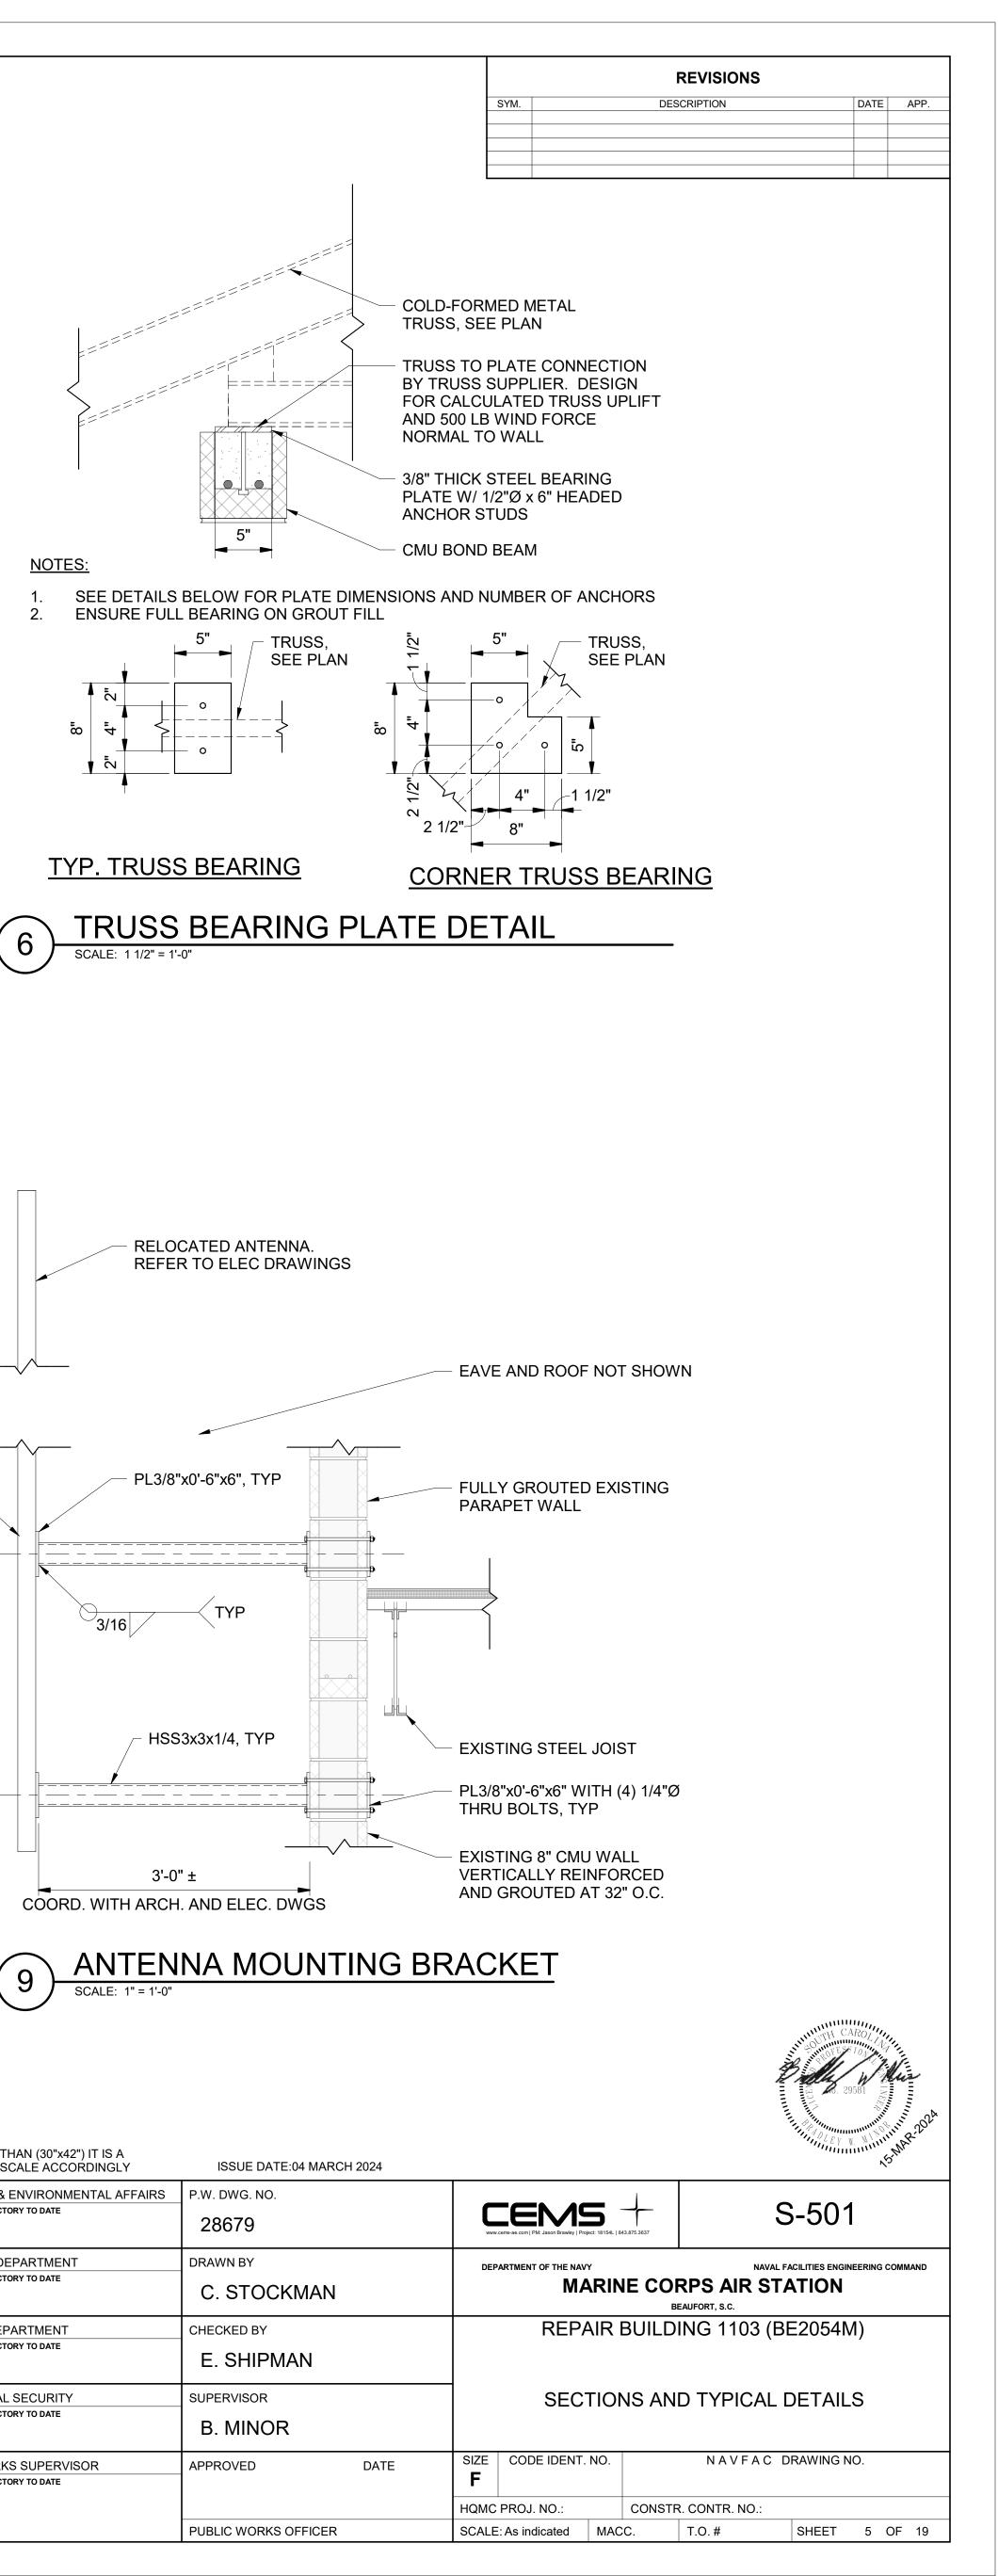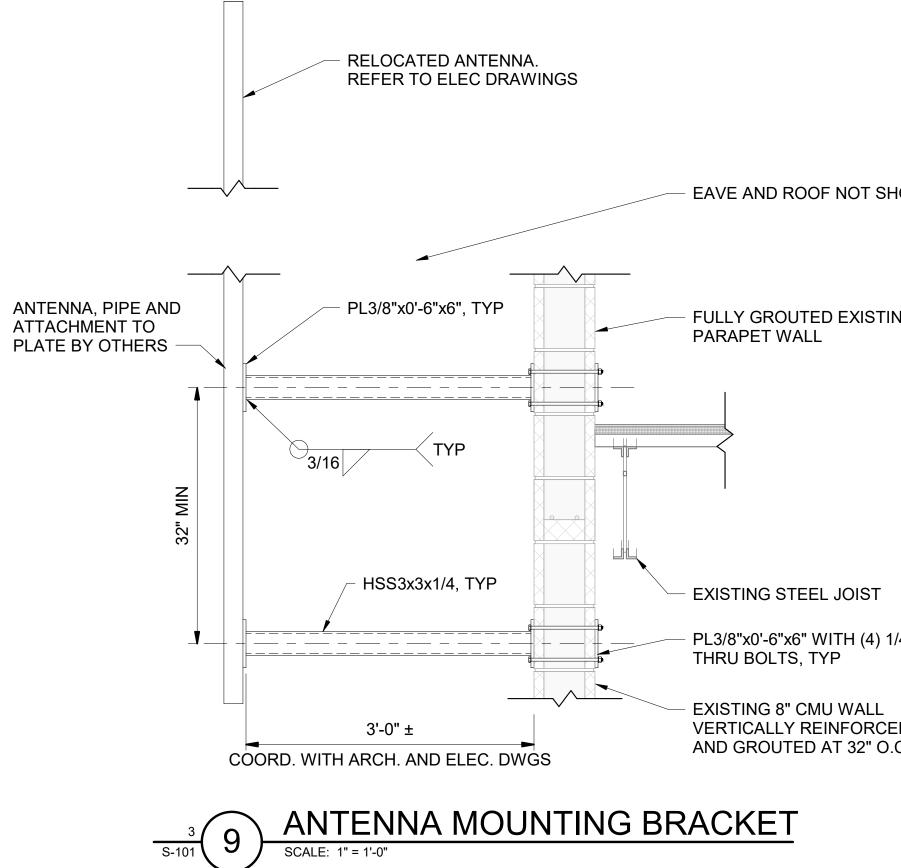GROUT EXISTING CELLS BELOW OPENING

EXISTING CONCRETE FOUNDATION





SCALE: 1 1/2"=1'-0"


SCALE: 1"=1'-0"

GRAPHIC SCALES

	IF SHEET IS LESS THAN (30"x42") IT IS A REDUCED PRINT; SCALE ACCORDINGLY	ISSUE DATE:04 MARCH	1 2024				
	NATURAL RESOURCES & ENVIRONMENTAL AFFAIRS SATISFACTORY TO DATE	P.W. DWG. NO. 28679				act: 18154L 84	43.875.3637
1'	SAFETY DEPARTMENT SATISFACTORY TO DATE	DRAWN BY C. STOCKMAN		DEP	ARTMENT OF THE NAVY		
	FIRE DEPARTMENT SATISFACTORY TO DATE	CHECKED BY E. SHIPMAN			REPA	AIR I	BUILD
2'	PHYSICAL SECURITY SATISFACTORY TO DATE	SUPERVISOR B. MINOR			SEC	ΓΙΟΙ	NS ANI
	PUBLIC WORKS SUPERVISOR SATISFACTORY TO DATE	APPROVED	DATE	SIZE F	CODE IDENT.	NO.	
					PROJ. NO.:		CONSTR
		PUBLIC WORKS OFFICER		SCALE	: As indicated	MAC	C.

PLAN NORTH	
	TRUE NORTH ARROW
DRAWING SCALE INDICATO	R
8 6 4 2 0 8 16	
SCALE: 1/8"=1'-0"	
GRAPHIC SCALE	
	WINDOW IDENTIFICATION TAG
M8A.1sa	
11	SIGNAGE TAG
KEYNOTE INDICATORS	
(DA1)-	
INTERIOR ELEVATION INDIC	ATOR
A 1	DETAIL NUMBER
A1	 DIRECTION OF ELEVATION SHEET DETAIL IS LOCATED ON
(A101)	SHEET DETAIL IS LOOATED ON
EXTERIOR ELEVATION INDIC	
	— DIRECTION OF ELEVATION — DETAIL NUMBER
A1-	-SHEET DETAIL IS LOCATED ON
WALL/BUILDING SECTION IN	
	DICATOR — DIRECTION OF CUTTING PLANE
	DETAIL NUMBER
A1-	LIMIT OF CUTTING PLANE
A101,	LINE OF CUTTING PLANE
ENLARGED DETAIL/AREA IN	SHEET DETAIL IS LOCATED ON
	DICATOR — DETAIL NUMBER
<u>1</u> A101	
	LIMIT OF ENLARGED AREA
	MATCHLINE STYLE
SEE 1/ A101-	VIEW NUMBER AND SHEET OTHER PART OF PLAN IS ON
DRAWING TITLE INDICATOR	
• · · · · · · · ·	DRAWING VIEW TITLE
A-101	
	ELEVATION HEIGHT
REVISION CLOUD AND NUM	BER
	LIMIT OF REVISION AREA
ROOM TAG	
101	
	- ROOM SQUARE FOOTAGE
	RE IDENTIFICATION TAG
	DENTIFICATION TAG

] _	ONS:		GYPSUM BOARD	NFPA	NATIONAL FIRE PROTECTION	TMPD	TEMPE	ERED GLASS		WATER C		SYM.
	AIR CONDITION ARCHITECT/ENGINEER	E	EAST	GYP PLAS	GYPSUM PLASTER	NIC	ASSOCIATION NOT IN CONTRACT	GL TO	TOP O	F		WOOD DO WALL HU		
C /	ACCESSIBLE	EA	EACH	ц Ц		NOM NR	NOMINAL NOISE REDUCTION	TO FDI TOB		F FOUNDATION F BEAM	WM	WIRE ME	SH	GENER
	ACOUSTICAL CEILING TILE AMERICANS WITH DISABILITIES ACT	EE EF	EACH END EACH FACE	H	HATCH (ROOF)	NRC	NOISE REDUCTION COEFFICIENT	TOC	TABLE	OF CONTENT		WEATHEI WAINSCC		1. ABBREVIATI
	AUTOMATIC DOOR CLOSER ADMINISTRATION	EGSB	EXTERIOR GYPSUM SHEATHING BOARD	H HB	HIGH HOSE BIBB	NTS	NOT TO SCALE	TOF TOJ		F FOOTING F JOIST	WSL	WEATHE	R SEAL	LINEWORK I MATERIALS
S A	AUTOMATIC DOOR SEAL	EHD EIFS	ELECTRIC HAND DRYER EXTERIOR INSULATION AND FINISH	HC	HANDICAP HOLLOW CORE	O OA	OVERALL	TOM TOS		F MASONRY F STEEL	Y			ARCHITECTI 2. SEE OTHER
	ABOVE FINISHED COUNTER ABOVE FINISHED FLOOR		SYSTEM	HCP	HANDICAPPED	OC	ON CENTER	TOW	TOP O	FWALL	YD	YARD		ABBREVIATI HAVE THE S
	ABOVE FINISHED GRADE AUTHORITY HAVING JURISDICTION	EJ ELAST	EXPANSION JOINT ELASTOMERIC	HCWD HD	HOLLOW CORE WOOD DOOR HAND DRYER	OD OF	OUTSIDE DIAMETER OUTSIDE FACE	TPD TPH	_	Γ PAPER DISPENSER				DIFFERENT
- /	ALTERNATE	ELEC	ELECTRIC ELEVATOR	HDW HM	HARDWARE HOLLOW METAL	OF/CI	OWNER FURNISHED/CONTRACTOR	R TR TRANS						
	ALUMINUM APPROVED	EM	EXPANDED METAL	HMD	HOLLOW METAL DOOR	OF/OI	OWNER FURNISHED/OWNER	TRANS	TRANS	SPARENT				
	APPROXIMATE AS REQUIRED	ENGR ENTR	ENGINEER ENTRANCE	HMDF HMF	HOLLOW METAL DOOR AND FRAME HOLLOW METAL FRAME	OFD	OVERFLOW DRAIN	TSH	TOWEI TELEV	L SHELF ISION				LINEWORK L
CH A	ARCHITECT	EPS	EXPANDED POLYSTYRENE BOARD (INSULATION)	HNDRL	HANDRAIL HOLD OPEN	OFS OH	OUTSIDE FACE OF STUDS OVERHANG	TYP	TYPICA	AL				AS INDICATED ON NEW
/	ABOVE SUSPENDED CEILING ARCHITECT'S SUPPLEMENTAL	EQ EQL SP	EQUAL EQUALLY SPACED	HORIZ	HORIZONTAL	OH DR OPP	OVERHEAD (COILING) DOOR OPPOSITE	U						NEW CON
	NSTRUCTION AVERAGE	EQUIP	EQUIPMENT	HS HT	HAND SINK HEIGHT	OPP	OVERFLOW ROOF DRAIN	UCD UL		RCUT DOOR RWRITERS LABORATORIES				EXISTING
	ARCHITECTURAL WOODWORK ARCHITECTURAL WOODWORKING	EQUIV ERD	EQUIVALENT EXISTING ROOF DRAIN	HVAC	HEATING, VENTILATING, AND AIR CONDITIONING	OVFL	OVERFLOW	UNFIN UNO		ISH IS NOTED OTHERWISE				SHADED SHADED SHADED S
	NSTITUTE		ESCALATOR	-		P			URINA					AS INDICATED ON DEMO
Т	ACOUSTICAL WALL TREATMENT	ETC ETR	ET CETERA EXISTING TO REMAIN	I ID	INSIDE DIAMETER	PAR PAT	PARAPET PATTERN	V						
r	BOARD	EVAC EWC	EVACUATE ELECTRIC WATER COOLER	IF IFS	INISIDE FACE INISDE FACE OF STUD	PCC PEJ	PRECAST CONCRETE PREMOLDED EXPANSION JOINT							EXISTING SHADED S
E	BOTH FACES	EWS	EYE WASH STATION	ILTG	INSULATED LAMINATED TEMPERED	PH	PHASE	UAR	VARIES VINYL					LINEWOR
	BELOW FINISH FLOOR BUILDERS HARDWARE	EXH EXH FN	EXHAUST EXHAUST FAN	IMP	GLASS INSULATED METAL PANEL	PHOTO PL	PHOTOGRAPH PROPERTY LINE	VCT	VINYL	COMPOSITION TILE				
1	MANUFACTURERS ASSOCIATION BITUMINOUS	EXH HD EXHV	EXHAUST HOOD EXHAUST VENT	INS INSUL	INSURANCE INSULATION	PLAM PORC	PLASTIC LAMINATE PORCELAIN	VERT	VESTIE	BULE				FIRE RATED
G E	BACKING	EXP	EXPANSION	INSUL	INTERIOR	PR	PAIR	VIF VR		Y IN FIELD R RETARDER				
	BUILDING BULKHEAD	EXST EXT	EXISTING EXTERIOR	J		PREFA PREFIN	B PREFABRICATE I PREFINISH	VTR		THROUGH ROOF				30 MINUT LINEWOR
KT E	BLANKET	EXT GR	EXTERIOR GRADE			PRELIM		W						
G	BELOW CEILING	F		JAN CLC JS	JANITOR CLOSET JANITOR'S SINK	PREV PRKG	PREVIOUS PARKING	W/ W/O	WITH WITHO	DUT				APPLIED
	BEAM BULLNOSE	F	FEMALE FIRE ALARM	K		PSF PSI	POUNDS PER SQUARE FOOT POUNDS PER SQUARE INCH			-				2 HOUR F APPLIED
	BOTTOM OF STEEL BOTTOM	FAB	FABRIC	KD	KNOCKED DOWN	PT	PAINT							
E	BOTH SIDES	FAS FAS BD	FASCIA FASCIA BOARD	KO KOP	KNOCKOUT KNOCK OUT PANEL	PTD PTDR	PAPER TOWEL DISPENSER PAPER TOWEL DISPENSER AND			MATERIALS	LEGEN	<u>ND:</u>		
	BUILT-UP BUILT-UP ROOFING	FC FC BRK	FILE CABINET FACE BRICK	KPL	KICKPLATE	PTN	RECEPTACLE PARTITION							
			FACTORY	L		PTR	PAPER TOWEL RECEPTACLE			MATERIALS		<u>NEW</u>	EXISTING	<u>O REMAIN</u> DEM
(CHANNEL	FD FDR	FLOOR DRAIN FIRE DOOR	L LAB	ANGLE LABORATORY	Q					IN SECTIC	N IN	ELEVATION IN SECTION	IN ELEVATION
	CENTER TO CENTER CARPET AND PAD	FDTN	FOUNDATION FIRE EXTINGUISHER	LAM LAM GL	LAMINATE LAMINATED GLASS	QT QTB	QUARRY TILE QUARRY TILE BASE							
З (CABINET	FEC	FIRE EXTINGUISHER CABINET	LAT	LATITUDE	QTF	QUARRY TILE FLOOR			EARTH				
	CERAMIC BASE CONSTRUCTION DOCUMENTS	FED FF	FEDERAL FINISH FACE	LAU LAV	LAUNDRY LAVATORY	QTY	QUANTITY							
	CONTRACTOR FURNISHED/CONTRACTOR	FF&E	FURNITURE, FIXTURE, AND EQUIPMENT	LB	POUND	R	RADIUS			CONCRETE/GROUT				
	NSTALLED CONTRACTOR FURNISHED/OWNER	FFA	FROM FLOOR ABOVE	LBR LC	LUMBER LAUNDRY CHUTE	RB	RUBBER BASE	_						
	NSTALLED	FFB FGL	FROM FLOOR BELOW FIBERGLASS	LD BRG	LOAD-BEARING LANDING	RC RCP	REINFORCED CONCRETE REFLECTED CEILING PLAN			FACE BRICK				
	CONTRACTOR FURNISHED EQUIPMENT	FH FHC	FIRE HYDRANT FIRE HOSE CABINET	LF	LINEAR FEET (FOOT)	RD	ROOF DRAIN REINFORCING STEEL BARS	_						
	CORNER GUARD CHALKBOARD	FIN	FINISH	LH	LEFT HAND LEFT HAND REVERSE	REBAR REC	RECESSED			MASONRY				
(CONTROL JOINT	FIN BS	FINISH BOTH SIDES FINISH FLOOR	LIN LKR	LINEAR LOCKER	REF REINF	REFRIGERATOR REINFORCE							
	CENTER LINE CEILING	FIN GR	FINISH GRADE	LT	LIGHT	REQD	REQUIRED			WOOD				
	CLEAR CENTER MATCHED	FIN WD FIXT	FINISH WOOD FIXTURE	LVDR LVR	LOUVER DOOR LOUVER	RESIL REST	RESILIENT RESTROOM	_						
(CONSTRUCTION MANAGEMENT	FLASH FLDG	FLASHING FOLDING			REV	REVISION RESILIENT FLOORING			PLYWOOD				
	CONCRETE MASONRY UNIT	FLG	FLOORING	MATL	MATERIAL	RH	RIGHT HAND							
		FLMT FLOUR	FLUSH MOUNT FLOURESCENT	MAX MD	MAXIMUM METAL DECK	RHR	RIGHT HAND REVERSE RAILING			STEEL				
NC	COLUMN CONCRETE	FO FOC	FINISHED OPENING FACE OF CONCRETE	ME	MATCH EXISTING	RM RO	ROOM ROUGH OPENING	_						
	CONFERENCE CONTINUE	FOC	FACE OF CONCRETE FACE OF FINISH	MEL MEMB	MELAMINE MEMBRANE	RTF	RUBBER TILE FLOOR			RIGID INSULATION				
NTR	CONTRACTOR	FOM FOS	FACE OF MASONRY FACE OF STUD	MEZZ MFR	MEZZANINE MANUFACTURER	RV	ROOF VENT							
	COORDINATE CORRIDOR	FOW	FACE OF WALL	MGT	MANAGEMENT	S				BATT INSULATION				
	CARPET CERAMIC TILE	FR FRA	FIRE RESISTANT FIRE RATED ASSEMBLY	MICRO MID	MICROWAVE OVEN MIDDLE	S	SOUTH SINGLE ACTING (DOOR)			SAND / E.I.F.S. / PLASTER / STUCCO /	$ \begin{array}{c} \left\{ \begin{array}{c} \left\{ \left\{ \left\{ {{{\left({\left\{ {{\left({{\left({\left\{ {{\left({\left\{ {{\left\{ {$			
3 (CERAMIC TILE BASE	FRP FT	FIBERGLASS REINFORCED PLASTIC FEET	MIN MISC	MINIMUM MISCELLANEOUS	SAT SATC	SUSPENDED ACOUSTICAL TILE SUSPENDED ACOUSTICAL TILE			GYPSUM BOARD				
	CERAMIC TILE FLOOR	FTD	FACIAL TISSUE DISPENSER	MKR	MARKER		CEILING			GRAVEL / STONE				
		FTG FURN	FOOTING FURNITURE	MLWK MO	MILLWORK MASONRY OPENING	SC SCHED	SOLID CORE SCHEDULE			FILL				
6 [DESIGN-BUILD			MOPR	MOP RACK	SCWD SD	SOLID CORE WOOD DOOR SOAP DISPENSER			ACT CEILING				
	DEGREE DEMOLITION	G GA	GAGE	MR MRB	MOISTURE RESISTANT MARBLE BASE	SH	SINGLE HUNG (WINDOW)							
PT [DEPARTMENT	GALV GB	GALVANIZED GRAB BAR	MRF MRT	MARBLE FLOOR MARBLE FHRESHOLD	SIM SLNT	SIMILAR SEALANT			METAL PANEL				
	DESCRIPTION DETAIL	GDR	GUARD RAIL	MS	MOP SINK	SM SND	SHEET METAL SANITARY NAPKIN DISPENSER	_		CEILING				
	DRINKING FOUNTAIN DOUBLE HUNG (DOOR, WINDOW)	GF/CI	GOVERNMENT FURNISHED/CONTRACTOR	MSB MT	MOB SERVICE BASIN METAL THRESHOLD	SPEC	SPECIFICATION			IF SHEET IS LESS T	ΉΔΝ (30"v42") IT I	SΔ		
W [DOUBLE HUNG WINDOWS	GF/GI	INSTALLED GOVERNMENT	MT MTD	MOUNT MOUNTED	SQ SS	SQUARE SERVICE SINK			REDUCED PRINT; S	CALÈ ACCORDIN	GLY	ISSUE DATE:04 MARCH 2024	
	DIAMETER DIAGONAL		FURNISHED/GOVERNMENT	MTG	MOUNTING	SSSMR				NATURAL RESOURCES & SATISFACTO	ENVIRONMENTAL ORY TO DATE	AFFAIRS	P.W. DWG. NO. 28680	CEMS
F [DIFFERENCE	GL GL BLK	GRIDLINE GLASS BLOCK	MTL MTLD	METAL METAL DOOR	SST	STAINLESS STEEL				EPARTMENT		DRAWN BY	www.cems-ae.com PM: Jason Brawley Project: 18154L
P [DISPENSER	GLZ	GLAZING	MTLF	METAL FLASHING	- STC - STD	SOUND TRANSMISSION CLASS STANDARD				EPARTMENT ory to date		M. JOHANNES	DEPARTMENT OF THE NAVY
	DOOR CLOSER DOOR FRAME	GOVT GP	GOVERNMENT GROUP	MTLP MTLR	METAL PARTITION METAL ROOF	SYM	SYMBOL			בוסב הרה	PARTMENT			REPAIR
	DOOR OPENING	GPC	GYPSUM PLASTER CEILING	MULL MULT	MULLION MULTIPLE	SYS	SYSTEM				ORY TO DATE		D. VON TERSCH	
н	DOOR HOLDER	GPM GR FL	GALLONS PER MINUTE GROUND FLOOR	MW	MICROWAVE	– T – TB	TOWEL BAR			PHYSICAL	SECURITY		SUPERVISOR	 ABBREVIATI
	DOOR LOUVER DOOR STOP	GRAN GSB	GRANITE GYPSUM SHEATHING BOARD	MWP	MEMBRANE WATERPROOFING	TD	TRENCH DRAIN				ORY TO DATE		D. VON TERSCH	
[DOWNSPOUT	GT	GROUT		NORTH	TEL TEMP	TELEPHONE TEMPORARY			PUBLIC WORK	SSUPERVISOR		APPROVED DATE	SIZE CODE IDENT. NO.
	DUTCH DOOR DISHWASHER	GUT GWT	GUTTER GLAZED WALL TILE	N NA	NORTH NOT APPLICABLE	TER THK	TERRAZZO THICKNESS			SATISFACT	ORY TO DATE			HQMC PROJ. NO.:
G [DRAWING	GYP	GYPSUM	7		TK BD	TACKBOARD							

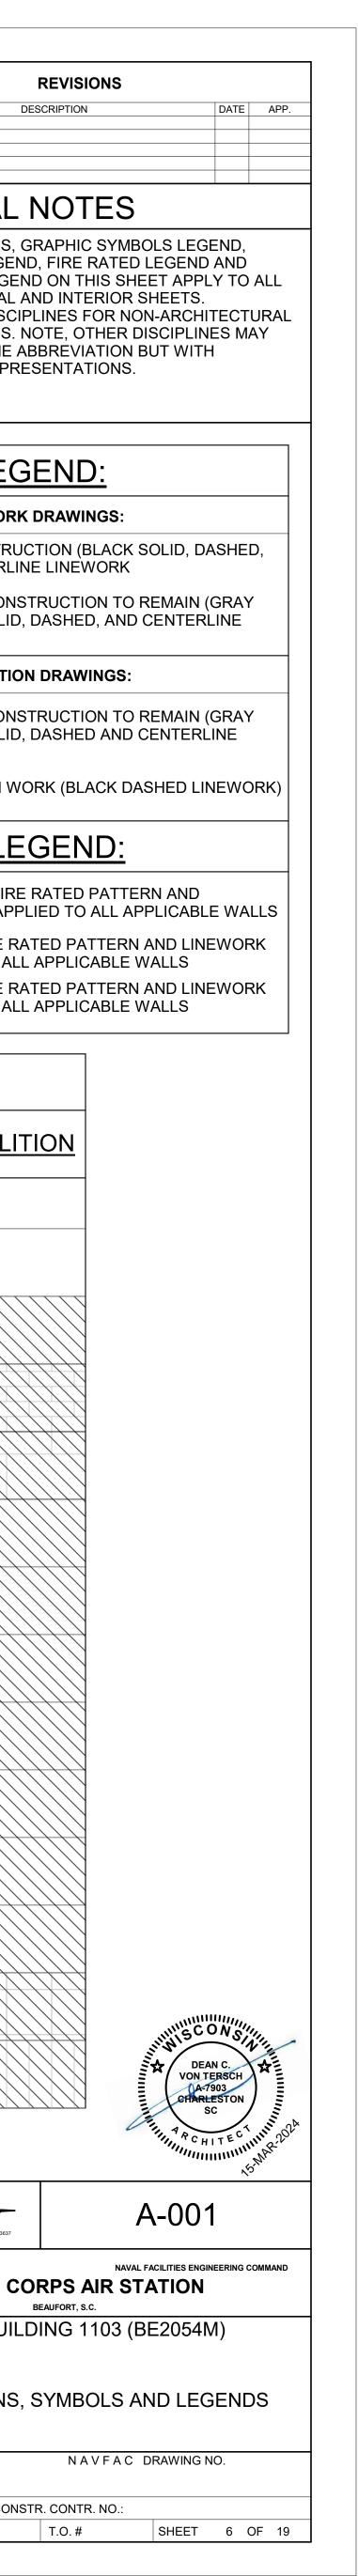

GENERAL DEMOLITION NOTES:

- 1. THE SCOPE OF DEMOLITION WORK INCLUDES, BUT IS NOT LIMITED TO, THE DEMOLITION WORK SHOWN ON THE DRAWINGS. CONTRACTOR SHALL PERFORM ALL DEMOLITION AS REQUIRED TO COMPLETE THE WORK, INCLUDING DEMOLITION THAT IS IMPLIED BUT NOT SPECIFICALLY CALLED OUT ON THE DRAWINGS 2. DEMOLITION SHOWN ON DRAWINGS MAY NOT REPRESENT THE FULL EXTENT OF REQUIRED DEMOLITION OR
- DEMOLITION PERFORMED BY OTHER TRADES. CONTRACTOR SHALL REVIEW ALL OTHER TRADES FOR FULL EXTENT OF DEMOLITION REQUIREMENTS PERTAINING TO EACH TRADE. ITEMS INCLUDED, BUT NOT LIMITED TO, ARE: PLUMBING FIXTURES, MECHANICAL EQUIPMENT, LIGHT FIXTURES, ETC. REMOVE EXISTING MATERIALS COMPLETE DOWN TO ORIGINAL SUBSTRATES. CLEAN AND PREP SUBSTRATES AS
- REQUIRED FOR NEW CONSTRUCTION. 4. ADDITIONAL DEMOLITION MAY BE REQUIRED BEYOND THAT INDICATED ON THE DEMOLITION DRAWINGS TO ACHIEVE
- THE FINAL NEW WORK INDICATED ON THE NEW WORK DRAWINGS. IT SHALL BE THE CONTRACTOR'S RESPONSIBILITY TO DETERMINE THE FINAL EXTENT OF DEMOLITION REQUIRED TO ACHIEVE THE NEW WORK SCOPE AS INDICATED ON THE NEW WORK DRAWINGS. 5. WHERE DEMOLITION WORK IS REQUIRED TO COMPLETE THE NEW WORK INDICATED, THE CONTRACTOR SHALL REMOVE
- SUFFICIENT EXISTING CONSTRUCTION TO COMPLETE THE NEW WORK. IF NEW REPLACEMENT CONSTRUCTION AT THE LOCATION OF DEMOLITION IS NOT INDICATED ON THE DRAWINGS, THE CONTRACTOR SHALL REPLACE THE DEMOLISHED CONSTRUCTION WITH NEW CONSTRUCTION THAT MATCHES THE CONSTRUCTION DEMOLISHED. THE CONTRACTOR WILL NOT BE AWARDED ADDITIONAL COMPENSATION TO DEMOLISH EXISTING CONSTRUCTION TO INCORPORATE NEW WORK INDICATED ON THE DRAWINGS. FURTHERMORE. THE CONTRACTOR WILL NOT BE AWARDED ADDITIONAL COMPENSATION TO REPLACE DEMOLISHED CONSTRUCTION WITH NEW CONSTRUCTION MATCHING EXISTING AT THE **REQUIRED DEMOLITION LOCATIONS.**

GENERAL NOTES

1. THE DRAWINGS INDICATE THE GENERAL EXTENT OF THE WORK. THE DRAWINGS ARE NOT INTENDED TO INDICATE OR DESCRIBE ALL WORK REQUIRED FOR THE FULL PERFORMANCE AND COMPLETION OF THE REQUIREMENTS OF THE CONTRACT DOCUMENTS. THE DRAWINGS INDICATE THE GENERAL INTENT OF THE WORK REQUIRED. 2. THE ENUMERATION OF PARTICULAR ITEMS OF WORK IN ONE PORTION OF THE CONTRACT DOCUMENTS SHALL NOT BE

- CONSTRUED TO EXCLUDE OTHER ITEMS NECESSARY OR IMPLIED. 3. THE CONTRACTOR IS RESPONSIBLE FOR THE COORDINATION OF ALL PARTS OF THE WORK SO THAT NO WORK SHALL BE LEFT IN AN UNFINISHED OR INCOMPLETE CONDITION.
- 4. ALL WORK SHALL CONFORM TO APPLICABLE INDUSTRY AND MANUFACTURER'S PUBLISHED STANDARDS FOR QUALITY OF MATERIALS AND WORKMANSHIP. ANY CONFLICTING REQUIREMENTS OF THE SOURCES LISTED ABOVE SHALL BE BROUGHT TO THE CONTRACTING OFFICER'S ATTENTION PRIOR TO PROCEEDING WITH THE WORK.
- 5. THE CONTRACTOR SHALL PROTECT EXISTING, IN-PLACE, AND NEW WORK. . ALL WORK NOTED "N.I.C." OR "G.F.G.I." IS MEANT TO EXCLUDE THIS SCOPE OF WORK FROM THE CONSTRUCTION CONTRACT.
- 7. THE CONTRACTOR SHALL PAY FOR AND COORDINATE THE COLLECTION, SEPARATION, RECYCLE, REMOVAL AND LEGAL DISPOSAL OF MATERIALS AND RUBBISH.
- 8. THE CONTRACTOR SHALL VERIFY ALL DIMENSIONS AND SHALL VERIFY ALL NEW AND EXISTING CONDITIONS SHOWN. THE CONTRACTOR SHALL NOTIFY THE CONTRACTING OFFICER IN WRITING OF ANY DIFFERING CONDITIONS BEFORE COMMENCEMENT OF WORK. COMMENCEMENT OF WORK SHALL CONSTITUTE ACCEPTANCE OF ALL NEW AND EXISTING CONDITIONS.
- 9. DO NOT SCALE DRAWINGS, DIMENSIONS GOVERN. LARGE SCALE DETAILS GOVERN OVER SMALL SCALE DETAILS. THE CONTRACTOR SHALL NOTIFY THE CONTRACTING OFFICER IN WRITING OF ANY DIFFERING CONDITIONS BEFORE COMMENCEMENT OF WORK.
- 10. UNLESS NOTED OTHERWISE, ALL NEW GYPSUM BOARD SURFACES ARE TO RECEIVE ONE PRIMER COAT AND TWO COATS OF PAINT.
- 11. ALL DIMENSIONS INDICATED ARE NOT TO VARY BY MORE THAN 1/8".
- 12. NFPA 241, STANDARD FOR SAFEGUARDING CONSTRUCTION, ALTERATION, AND DEMOLITION OPERATIONS SHALL BE APPLIED. 13. DIMENSIONS SHOWN TO STRUCTURAL BEAMS AND COLUMNS ARE TO THE CENTERLINE OF THE MEMBER UNLESS SPECIFICALLY NOTED OTHERWISE
- 14. PROVIDE EXPANSION AND CONTROL JOINTS IN ALL WORK AS PER PRODUCT MANUFACTURER'S WRITTEN RECOMMENDATIONS.
- 15. THE CONTRACTOR SHALL PERFORM ALL WORK IN ACCORDANCE WITH ALL APPLICABLE CODES, ORDINANCES AND REGULATORY AGENCIES AND SHALL OBTAIN NECESSARY PERMITS FROM ALL AUTHORITIES HAVING JURISDICTION NECESSARY TO EXECUTE THEIR WORK
- 16. ALL DISSIMILAR METALS SHALL BE ISOLATED FROM EACH OTHER TO AVOID GALVANIC CORROSION 17. NOTES ON ANY ONE SHEET ARE TO BE APPLIED TO RELATED DRAWINGS AND DETAILS ON OTHER SHEETS. 18. ALL FINISH REQUIREMENTS INDICATED SHALL APPLY TO THE ENTIRE LENGTH AND WIDTH OF THE FLOOR AND CEILING INDICATED, AND THE ENTIRE LENGTH AND HEIGHT OF THE WALL INDICATED.
- 19. DETAILS INDICATED FOR CONSTRUCTION ARE TO BE USED FOR ALL LOCATIONS OF SIMILAR CONSTRUCTION. WHERE SPECIFIC DIMENSIONS, DETAILS OR DESIGN INTENT CANNOT BE DETERMINED, CONSULT THE CONTRACTING OFFICER BEFORE PROCEEDING WITH THE WORK.
- 20. THE CONTRACTOR SHALL COORDINATE ALL PENETRATIONS WITH ALL TRADES.
- 21. ALL PIPE DUCTS AND BUS DUCTS THAT PENETRATE ASSEMBLIES SHALL BE INSTALLED IN A MANNER THAT WILL PRESERVE THE MOISTURE RESISTANCE. FIRE RATING. AND STRUCTURAL INTEGRITY OF THE ASSEMBLY. 22. CONTRACTOR SHALL PLAN THEIR WORK TO PROVIDE ADEQUATE PROTECTION FOR PERSONS AND PROPERTY AT ALL TIMES
- AND EXECUTE THE WORK IN SUCH A MANNER TO AVOID ANY HAZARD TO PERSONS AND PROPERTY AS NECESSARY. 23. CONTRACTOR SHALL CONTINUOUSLY COORDINATE PHASING AND CONSTRUCTION WITH THE CONTRACTING OFFICER. 24. EXISTING CONDITIONS AND DIMENSIONS ARE SHOWN PER ORIGINAL DESIGN DRAWINGS AND NON DESTRUCTIVE SITE
- INVESTIGATIONS. CONTRACTOR SHALL VERIFY ALL EXISTING CONDITIONS PRIOR TO START OF DEMOLITION/CONSTRUCTION AND NOTIFY GOVERNMENT PROMPTLY IF ANY DISCREPANCIES EXIST. 25. CONTRACTOR SHALL PROTECT EXISTING TO REMAIN CONSTRUCTION, FINISHES, FIXTURES, FURNITURE, EQUIPMENT, AND SO FORTH FROM DAMAGE DURING CONSTRUCTION. ANY DAMAGED AREAS OR ITEMS ARE TO BE REPAIRED OR REPLACED BY THE CONTRACTOR TO EQUAL OR BETTER CONDITION PRIOR TO BEING DAMAGED. ALL WALLS SCUFFED. MARRED. OR DAMAGED ARE TO BE REPAIRED, AND AT A MINIMUM, REPAINTED CORNER TO CORNER, FLOOR TO CEILING - TOUCH UP
- PAINTING IS NOT PERMITTED. 26. ALL INCIDENTAL DEMOLITION PERFORMED IN PURSUIT OF EXECUTING THE WORK SHALL BE RECONSTRUCTED TO RETURN THE DEMOLISHED WORK TO PRE-DEMOLITION CONDITION. ONLY WORK INDICATED TO BE LEFT IN A PERMANENTLY DEMOLISHED CONDITION SHALL BE LEFT IN A PERMANENTLY DEMOLISHED CONDITION. ALL OTHER DEMOLISHED WORK SHALL BE RETURNED TO A PREDEMOLISHED CONDITION.

PROJECT NOTES:

1. THE CONTRACTOR SHALL THOROUGHLY PHOTOGRAPH EXISTING CONDITIONS OF THE SITE, THE BUILDING EXTERIOR, AND THE BUILDING INTERIOR PRIOR TO START OF ANY CONSTRUCTION ACTIVITIES AND MAKE AVAILABLE THESE PHOTOGRAPHS TO THE GOVERNMENT WITHIN 30 DAYS OF CONTRACT AWARD. 2. ALL CONDITIONS OF THE SITE AND BUILDING THAT ARE INDICATED AS EXISTING TO REMAIN BUT ARE DISTURBED, DAMAGED, OR MODIFIED DURING CONSTRUCTION ACTIVITIES ARE TO BE RETURNED TO PRIOR TO CONSTRUCTION CONDITION. IT SHALL BE THE CONTRACTOR'S RESPONSIBILITY TO PROTECT ALL ASPECTS OF THE SITE AND THE BUILDING THAT ARE NOT INTENDED TO BE MODIFIED AND RETURN ANY SUCH

- MODIFIED ASPECTS TO PRE-MODIFIED CONDITIONS.
- 3. ALL CONDITIONS OFFSITE THAT HAVE BEEN DAMAGED, ALTERED, OR RENDERED IN A CONDITION THAT REDUCES IT'S INTENDED EFFECTIVENESS AS A RESULT OF CONSTRUCTION ACTIVITIES RELATED TO THIS PROJECT SHALL BE REPAIRED OR REPLACED TO IT'S PRE-DAMAGED, ALTERED, OR RENDERED STATE.

HAZARDOUS MATERIALS GENERAL NOTES:

- 1. HANDLING OF ASBESTOS CONTAINING MATERIALS (ACM) AND ABATEMENT OF ACM IS NOT REQUIRED ON THIS PROJECT. ACM HAVE NOT BEEN IDENTIFIED TO BE PRESENT WITHIN THE BUILDING PER AN ASBESTOS SURVEY REPORT BY TERRACON CONSULTANTS, INC. DATED NOVEMBER 30, 2023. HOWEVER IF SUSPECT ACM IS FOUND DURING RENOVATION, STOP ALL WORK AND CONTACT FEAD AND THE MCAS BEAUFORT ASBESTOS PROGRAM MANAGER. ALL SUSPECT ACM SHALL BE ABATED IN STRICT ACCORDANCE WITH STATE AND FEDERAL GUIDELINES BY CERTIFIED ENTITIES.
- 2. HANDLING OF LEAD BASED PAINT (LBP) AND ABATEMENT OF LBP IS NOT REQUIRED ON THIS PROJECT. LBP COATINGS HAVE BEEN IDENTIFIED TO NOT BE PRESENT WITHIN THE BUILDING PER A LIMITED PAINT SAMPLING FOR LEAD-CONTENT ANALYSIS BY TERRACON CONSULTANTS, INC. DATED NOVEMBER 30, 2023. HOWEVER, IF SUSPECT LBP IS FOUND DURING RENOVATION. STOP ALL WORK AND CONTACT FEAD AND THE MCAS BEAUFORT HAZARDOUS MATERIALS PROGRAM MANAGER. ALL SUSPECT LBP SHALL BE ABATED IN STRICT ACCORDANCE WITH STATE AND FEDERAL GUIDELINES BY CERTIFIED ENTITIES.

METAL ROOF PANEL AND ASSOCIATED TRIM GENERAL NOTES

- 1. THE ROOF PANELS SHALL BE STRUCTURAL STANDING SEAM PREFINISHED ALUMINUM WITH A MINIMUM 2 1/2" HIGH ROLL FORMED RIB WITH 180 DEGREE DOUBLE FOLD MECHANICAL CRIMPING SEAMS WITH CONCEALED CLIPS AND FASTENERS. ROOF PANEL THICKNESS SHALL BE NOT LESS THAN THE GREATER OF 0.032 INCH THICKNESS OR THAT DETERMINED FROM CALCULATIONS BASED ON PANEL PROFILE, LOCAL WIND LOADS, AND PANEL ATTACHMENTS. WIND LOAD PRESSURES SHALL BE IN ACCORDANCE WITH ASCE-7. MINIMUM DESIGN LOADS AND ASSOCIATED CRITERIA FOR BUILDINGS AND OTHER STRUCTURES AND AS DETERMINED BASED ON BUILDING LOCATIONS AND CONFIGURATION. ALUMINUM SHEET SHALL CONFORM TO ASTM B209, AA ADM AND AA ASD1. ROOF PANELS TO BE SMOOTH NON-EMBOSSED.
- 2. ROOF PANEL AND FLASHING DETAILS ON THE DRAWINGS ARE GENERAL IN NATURE TO AVOID PROPRIETARY CONFLICTS. IT SHALL BE THE CONTRACTOR'S RESPONSIBILITY TO PROVIDE SPECIFIC DETAILS UNIQUE TO THE SELECTED ROOF PANEL MANUFACTURER THAT MEET THAT ROOF MANUFACTURER'S REQUIREMENTS WHILE ALSO MEETING THE OVERALL INTENT AS INDICATED ON THE DRAWINGS. THE DRAWINGS INDICATE THE OVERALL DESIGN INTENT AND DELIBERATELY AVOID INDICATING SPECIFIC INFORMATION OF ANY ONE ROOF PANEL MANUFACTURER TO ENCOURAGE ROOF PANEL MANUFACTURERS TO PROVIDE THEIR FINAL DESIGN THAT MEETS THE OVERALL INTENT INDICATED. IT SHALL BE THE CONTRACTOR'S RESPONSIBILITY TO PROVIDE THE ADDITIONAL REQUIRED DETAILS AND DESIGN INFORMATION. AS WELL AS ALL THE ROOFING COMPONENTS THAT SUPPORT THEIR DETAILS AND DESIGN INFORMATION, THAT COMPLETES THE OVERALL DESIGN INTENT AS INDICATED ON THE DRAWINGS. 3. IT SHALL BE THE CONTRACTOR'S RESPONSIBILITY DURING THE BIDDING PROCESS TO SECURE ANY ADDITIONAL
- INFORMATION THEY DEEM NECESSARY TO COMPLETE THE DESIGN INTENT AS INDICATED ON THE DRAWINGS. THE CONTRACTOR WILL NOT BE AWARDED ANY ADDITIONAL COMPENSATION AFTER BIDDING IN THEIR PURSUIT TO COMPLETE THE DESIGN OF THE ROOF SYSTEM.
- 4. ALL FLASHING AND TRIM SHALL BE PREFINISHED ALUMINUM. ROOF PANELS ARE TO RECEIVE A FACTORY-APPLIED POLYVINYLIDENE FLUORIDE OF KYNAR 500/HYLAR 5000 FINISH CONSISTING OF A BAKED-ON TOP-COAT WITH A MANUFACTURER'S RECOMMENDED PRIME COAT. PROVIDE COMPATIBLE FASTENERS TO AVOID GALVANIC ACTION AND CORROSION OF DISSIMILAR MATERIALS. COLORS OF PREFINISHED STANDING SEAM ROOF PANELS AND ALL EXPOSED TO VIEW ROOFING RELATED COMPONENTS ARE TO BE PER THE BEAUFORT, SC MARINE CORPS AIR STATION (MCAS) COLOR STANDARDS AND APPROVED BY MCAS PUBLIC WORKS (PW) DEPARTMENT. EXPOSED FASTENERS FOR TRIM AND ALL ASSOCIATED ROOFING ACCESSORIES SHALL BE PREFINISHED. NO ADDITIONAL COMPENSATION WILL BE AWARDED TO THE CONTRACTOR FOR CUSTOM COLORS IN PURSUIT OF MATCHING THE MCAS COLOR STANDARD. FIELD PAINTING OF COMPONENTS INDICATED TO BE PREFINISHED IS NOT ALLOWED. WHERE COLORS ARE NOT SPECIFICALLY INDICATED, THE CONTRACTOR SHALL MAKE AVAILABLE FOR FINAL SELECTION COLORS FROM THE MANUFACTURERS FULL LINE OF STANDARD AND CUSTOM COLORS.
- 5. PREFINISHED ALUMINUM GUTTER AND DOWNSPOUT MINIMUM SIZES ARE INDICATED ON THE DRAWINGS. FINAL GUTTER AND DOWNSPOUT PROFILES AND ROUTING ARE TO BE DETERMINED BY THE ROOF PANEL MANUFACTURER AND PROVIDE NOT LESS THAN THE WATER FLOW AS PROVIDED BY THE GUTTER AND DOWNSPOUT SIZES INDICATED. LOCATIONS OF THE DOWNSPOUTS TO BE AS INDICATED ON THE DRAWINGS.
- 6. REQUESTED DEVIATIONS BY THE CONTRACTOR FROM THE INFORMATION PROVIDED ON THE DRAWINGS MUST BE APPROVED BY THE CONTRACTING OFFICER PRIOR TO THE CONTRACTOR SUBMITTING THEIR BID FOR THE WORK. NO ADDITIONAL COMPENSATION WILL BE AWARDED TO THE CONTRACTOR FOR ANY DESIGN CHANGES IF THOSE
- REQUESTED CHANGES WERE NOT APPROVED DURING THE BIDDING PROCESS. 7. ALL FLASHING, TRIM, ACCESSORIES, AND MISCELLANEOUS ROOFING COMPONENTS SHALL BE APPROVED BY THE ROOF PANEL MANUFACTURER AND INCORPORATED INTO THE DESIGN BY THE ROOF PANEL MANUFACTURER. THE ROOF SYSTEM, FLASHING, TRIM, GUTTER, DOWNSPOUT, AND SO FORTH SHALL BE COMPRISED OF COMPONENTS DESIGNED AND PROVIDED TO THE GREATEST EXTENT POSSIBLE BY THE ROOF PANEL MANUFACTURER.
- ROOF PENETRATIONS ARE NOT PERMITTED EXCEPT FOR THOSE INDICATED ON THE DRAWINGS. 9. THE ROOF PANEL AND ALL ASSOCIATED ROOFING ACCESSORIES SUCH AS FLASHING, TRIM, GUTTER, DOWNSPOUTS, AND SO FOR SHALL BE WARRANTED FOR NOT LESS THAN 20 YEARS. CONTRACTOR TO SUBMIT MANUFACTURER'S STANDARD WARRANTY TO CONTRACTING OFFICER.
- 10. STRUCTURAL STANDING SEAM METAL ROOF MAY BE SHOWN ABBREVIATED AS "SSSMR".

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GENERAL FINISH NOTES:

- 1. ALL GENERAL CONTRACTORS AND SUB CONTRACTORS A DRAWINGS AND SPECIFICATIONS AS WELL AS ENGINEER COORDINATE EACH WITH THEIR SPECIFIC FIELD BEFORE 2. CONTRACTOR SHALL FURNISH AND INSTALL MATERIALS I
- SPECIFICATIONS AND INSTALLATION INSTRUCTIONS. IN THE EVENT ANY FINISH ITEM IS FOUND TO BE DISCONT SHALL NOTIFY THE ARCHITECT IMMEDIATELY. CONTRAC
- REQUIRING FURTHER CLARIFICATION OF FINISH SELECTING 4. CONTRACTOR SHALL FIELD VERIFY ALL DIMENSIONS AND CONFLICTS PRIOR TO ORDERING OF MATERIALS OR INITIA
- ARCHITECTURAL DRAWINGS. REFER TO DIMENSIONED PL 5. CONTRACTOR SHALL PROVIDE TO OWNER ALL MANUFAC INSTRUCTION DOCUMENTS ON ALL FINISH MATERIALS. CO
- DRAWINGS FOR APPROVAL FOR ALL NEW MATERIALS INS 6. INTERIOR CONSTRUCTION REQUIRING FINISH / COLOR SE SHALL BE SUBMITTED TO THE CONTRACTING OFFICER IN AVAILABLE, CLEARLY IDENTIFYING ANY THAT MIGHT BE A
- 7. ALL PRODUCT SPECIFICATIONS ARE GIVEN TO DEFINE DE REQUIRE THE PRIOR APPROVAL OF THE CONTRACTING C ADHERE TO THE INTENT OF THE QUALITY, DESIGN, COLO 8. ALL FINISHES ARE DESIGNATED USING "PLAN NORTH".

DOORS AND DOOR FRAMES:

1. ALL METAL DOORS AND ALL DOOR FRAMES SHALL BE PAIL SEE FINISH SCHEDULE.

ALUMINUM COLUMN COVER NO

- COLUMN COVER THICKNESS SHALL BE NOT LESS THAN T FROM CALCULATIONS BASED ON COVER PROFILE, LOCAL LOAD PRESSURES SHALL BE IN ACCORDANCE WITH ASCE CRITERIA FOR BUILDINGS AND OTHER STRUCTURES AND AND CONFIGURATION.
- 2. COLUMN COVER TO BE SMOOTH NON-EMBOSSED WITH F / HYLAR 5000 RESIN COATING. PAINTING TO BE IN ACCOR INDICATED ON THE DRAWINGS. FINISH WARRANTY TO BE 3. COLUMN COVER TO BE OF ALUMINUM SHEET MEETING AS
- INDICATED ON THE DRAWINGS. COLUMN COVER TO BE SECURED TO STRUCTURAL STEEL
- STANDOFF CONNECTIONS 5. COLUMN COVER TO BE 2-PIECE WITH PREFINISHED REMO
- ACCESS TO COLUMN WRAP FASTENERS. REMOVABLE CH. 6. COLUMN COVER TO BE ONE PIECE FROM TOP OF CONCR SOFFIT. PROVIDE 1/8" GAP BETWEEN COLUMN COVER AN
- BETWEEN COLUMN COVER AND UNDERSIDE OF FINISH SH COME IN CONTACT WITH THE CONCRETE PIER. PROVIDE ALL NECESSARY SHIMS, SPACERS, FASTENERS,
- FORTH FOR A COMPLETE INSTALLATION. 8. INSTALLATION TO BE PER COLUMN COVER MANUFACTUR BE BY INSTALLERS TRAINED AND CERTIFIED BY COLUMN

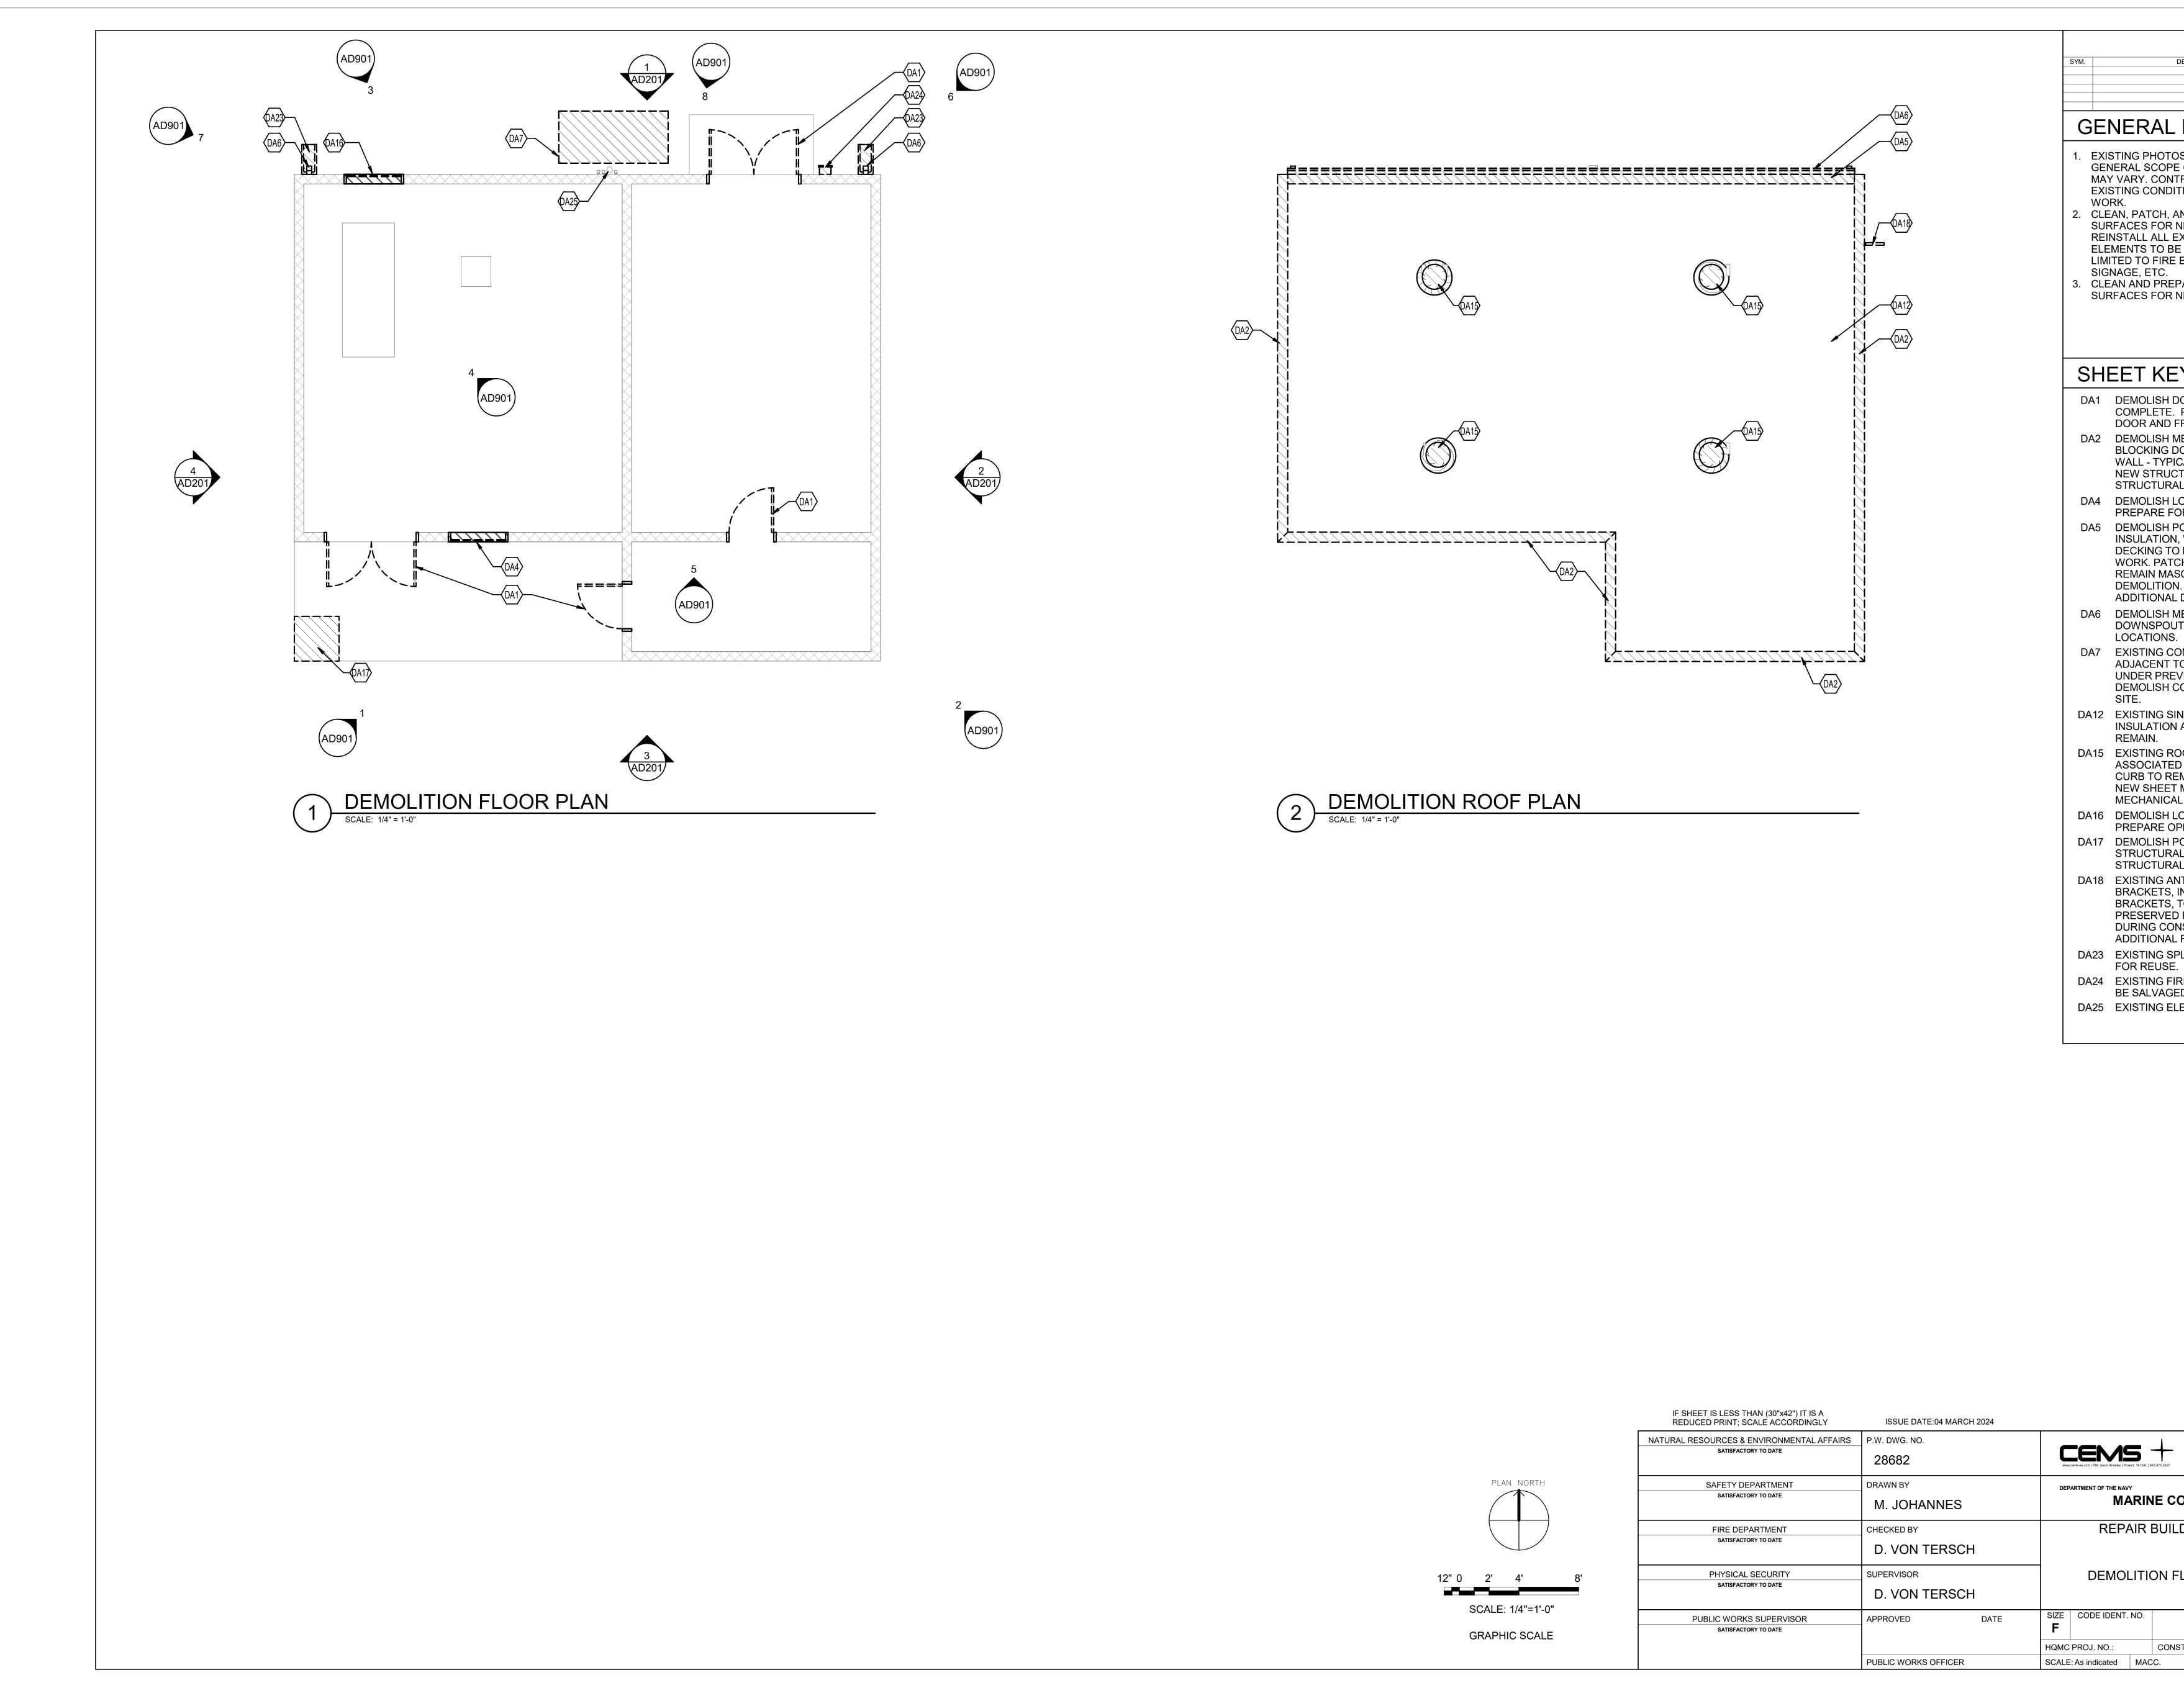
BUILDING PRESSURE WASHING

- 1. ALL EXISTING EXPOSED TO WEATHER EXTERIOR CMU WA ARE TO BE PRESSURE WASHED. NO INTERIOR CMU WALL 2. ALL PRESSURE WASHING SHALL BE CONDUCTED PRIOR 1
- CONSTRUCTION. 3. PRESSURE AND WATER GPM SHALL BE SUFFICIENT TO R ERODE SOUND MORTAR JOINTS.
- 4. AT THE CONCLUSION OF ALL PRESSURE WASHING AND P FINISH MATERIALS. THE CONTRACTOR SHALL NOTIFY THE THE MCAS PW DEPARTMENT CAN PERFORM A VISUAL INS
- 5. UNSOUND MORTAR JOINT MATERIAL REMOVED DURING F THE CONTRACTOR. THE CONTRACTOR SHALL ASSUME TO MORTAR JOINTS.
- 6. THE CONCRETE FLOOR SLAB IN GENERATOR ROOM 101 IS OTHER ROOMS ARE TO HAVE THEIR FLOORS PRESSURE

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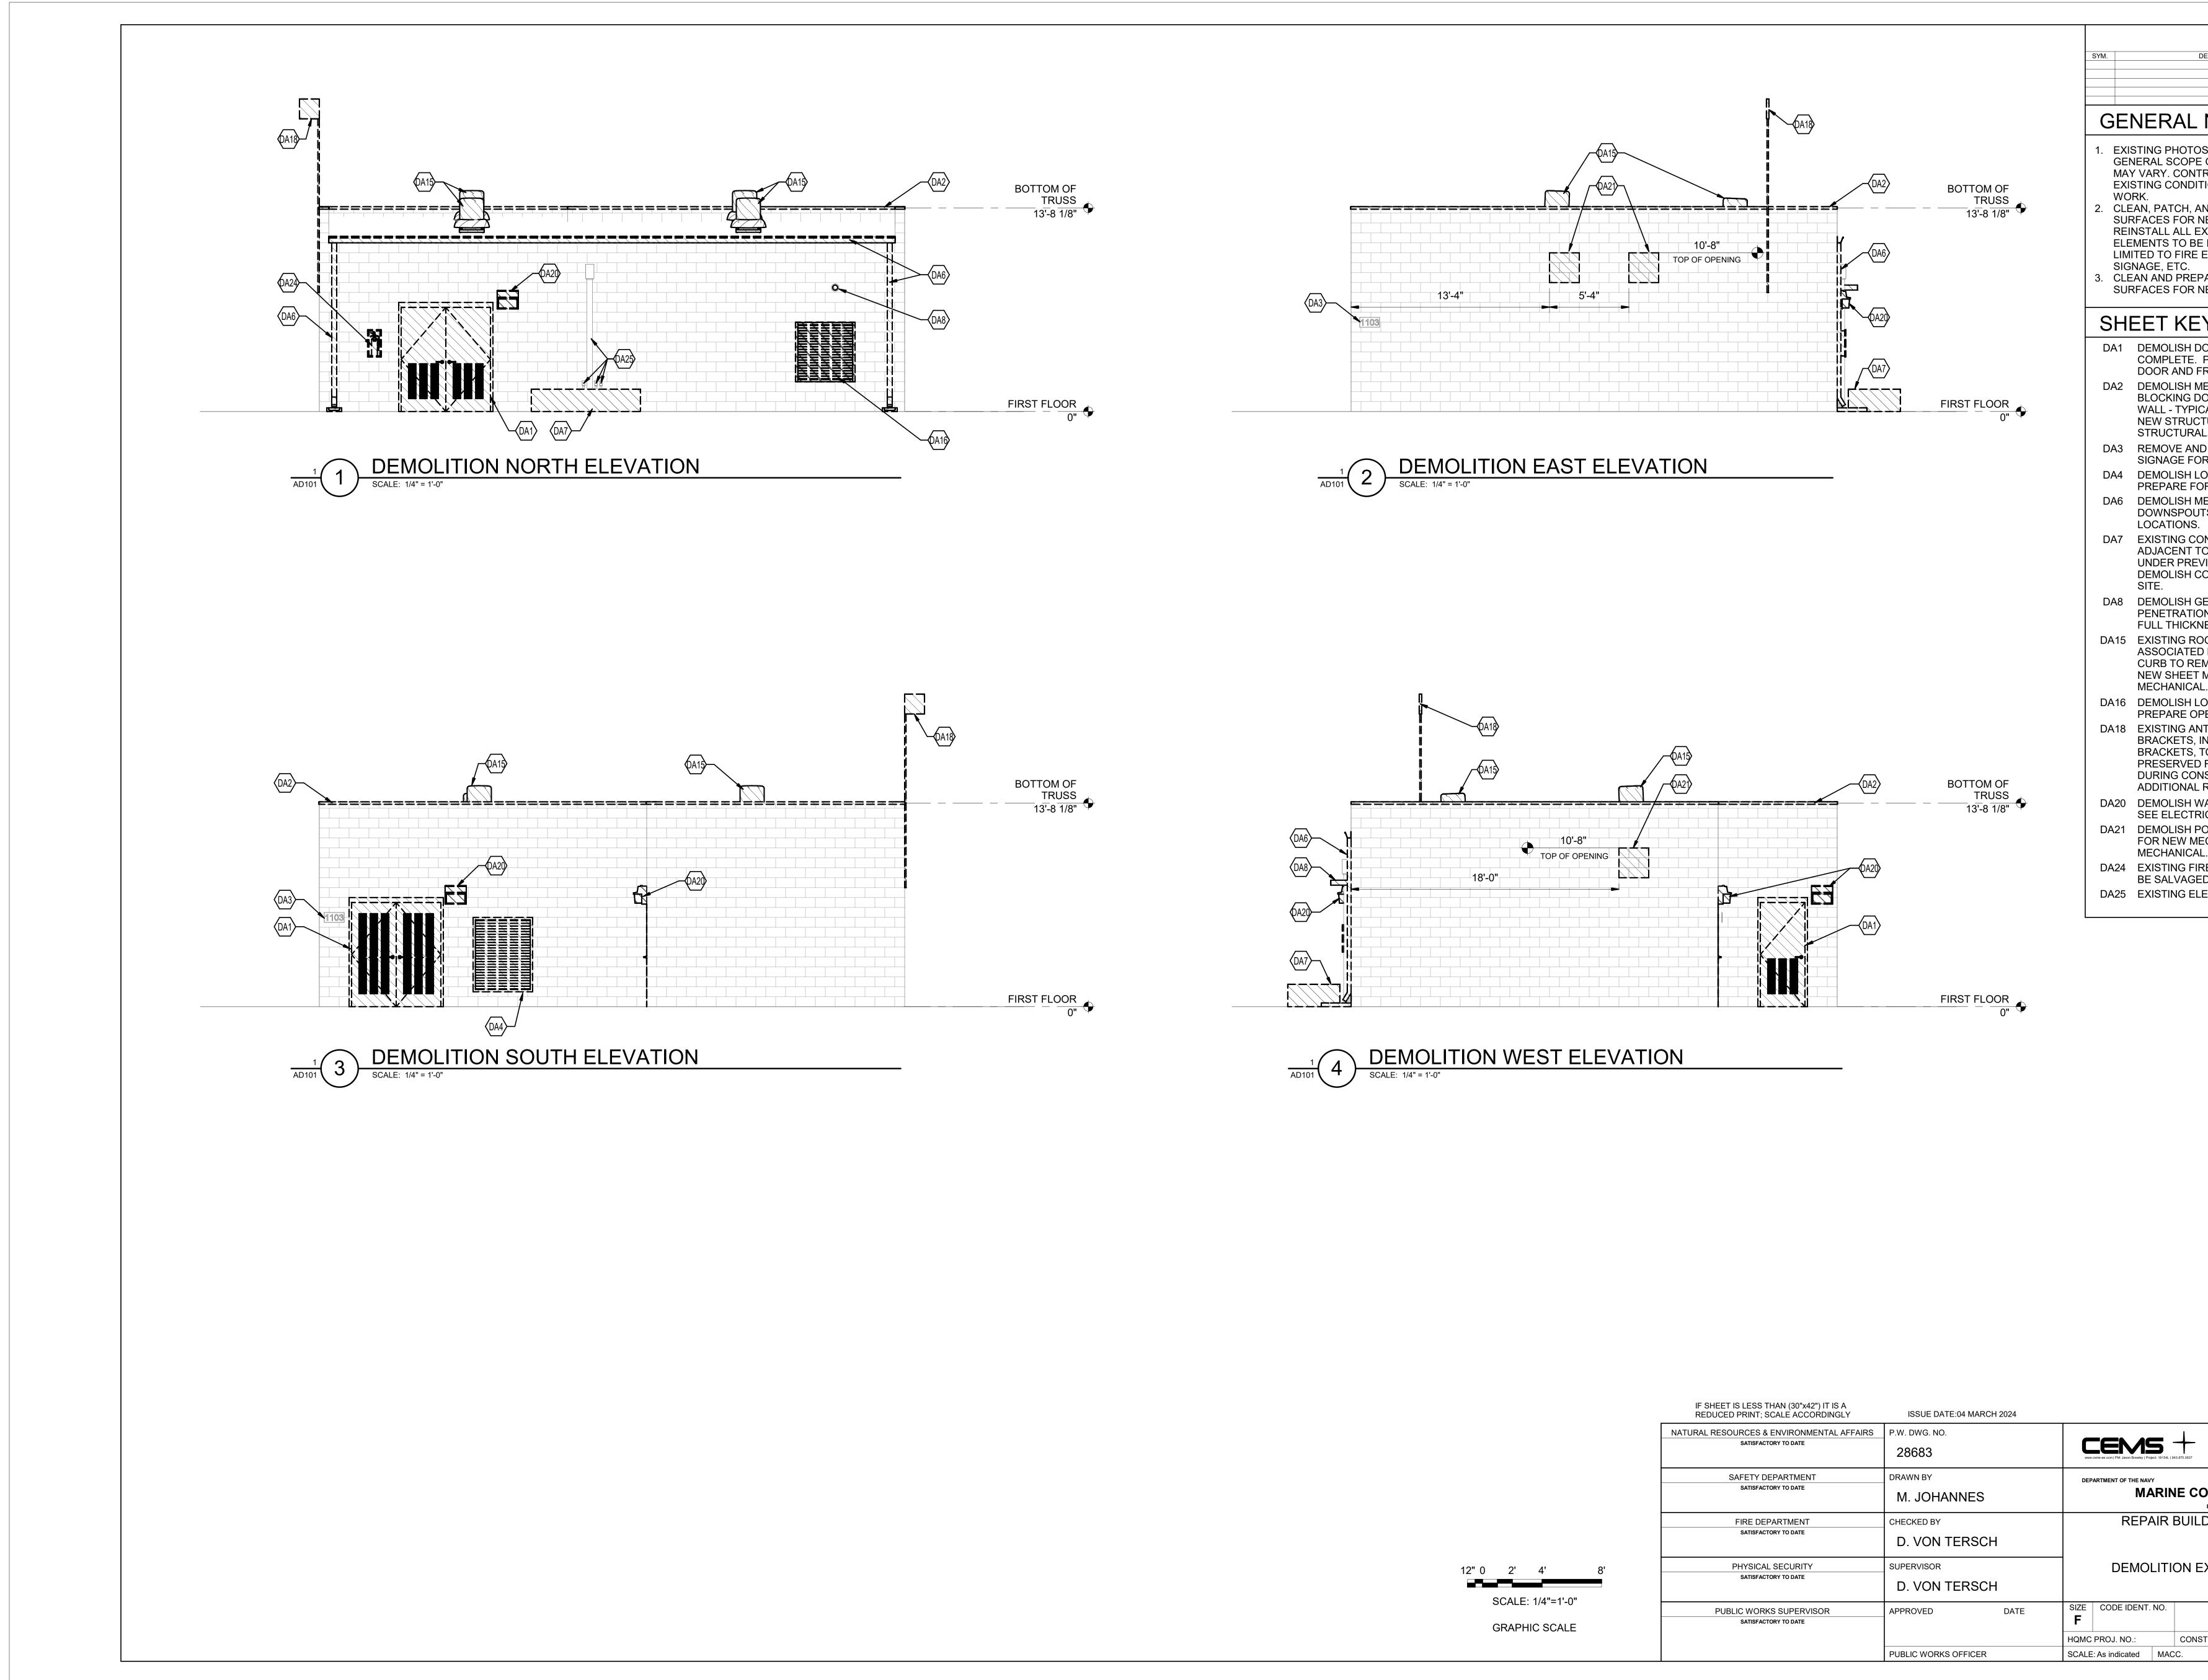
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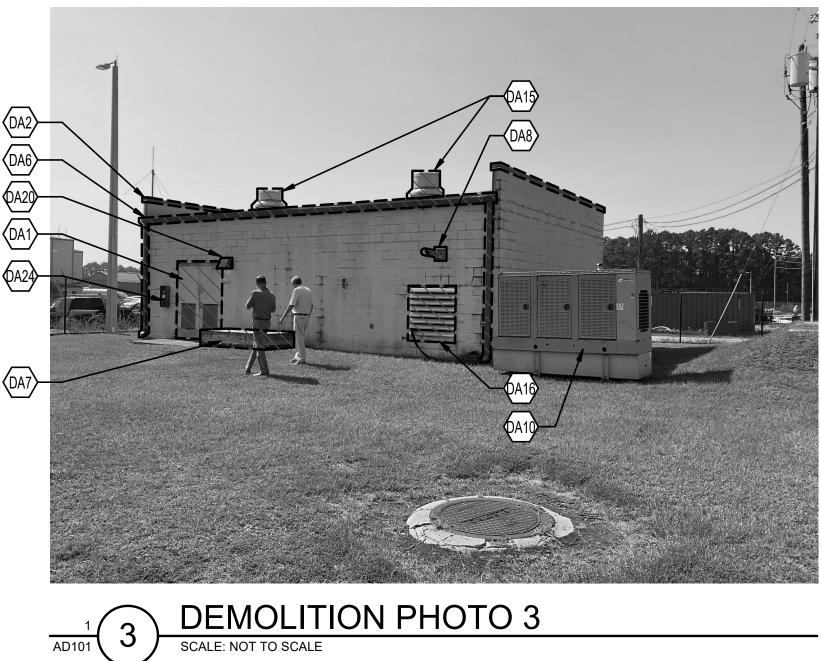
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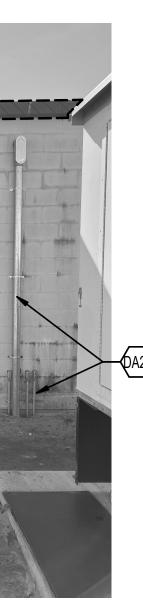
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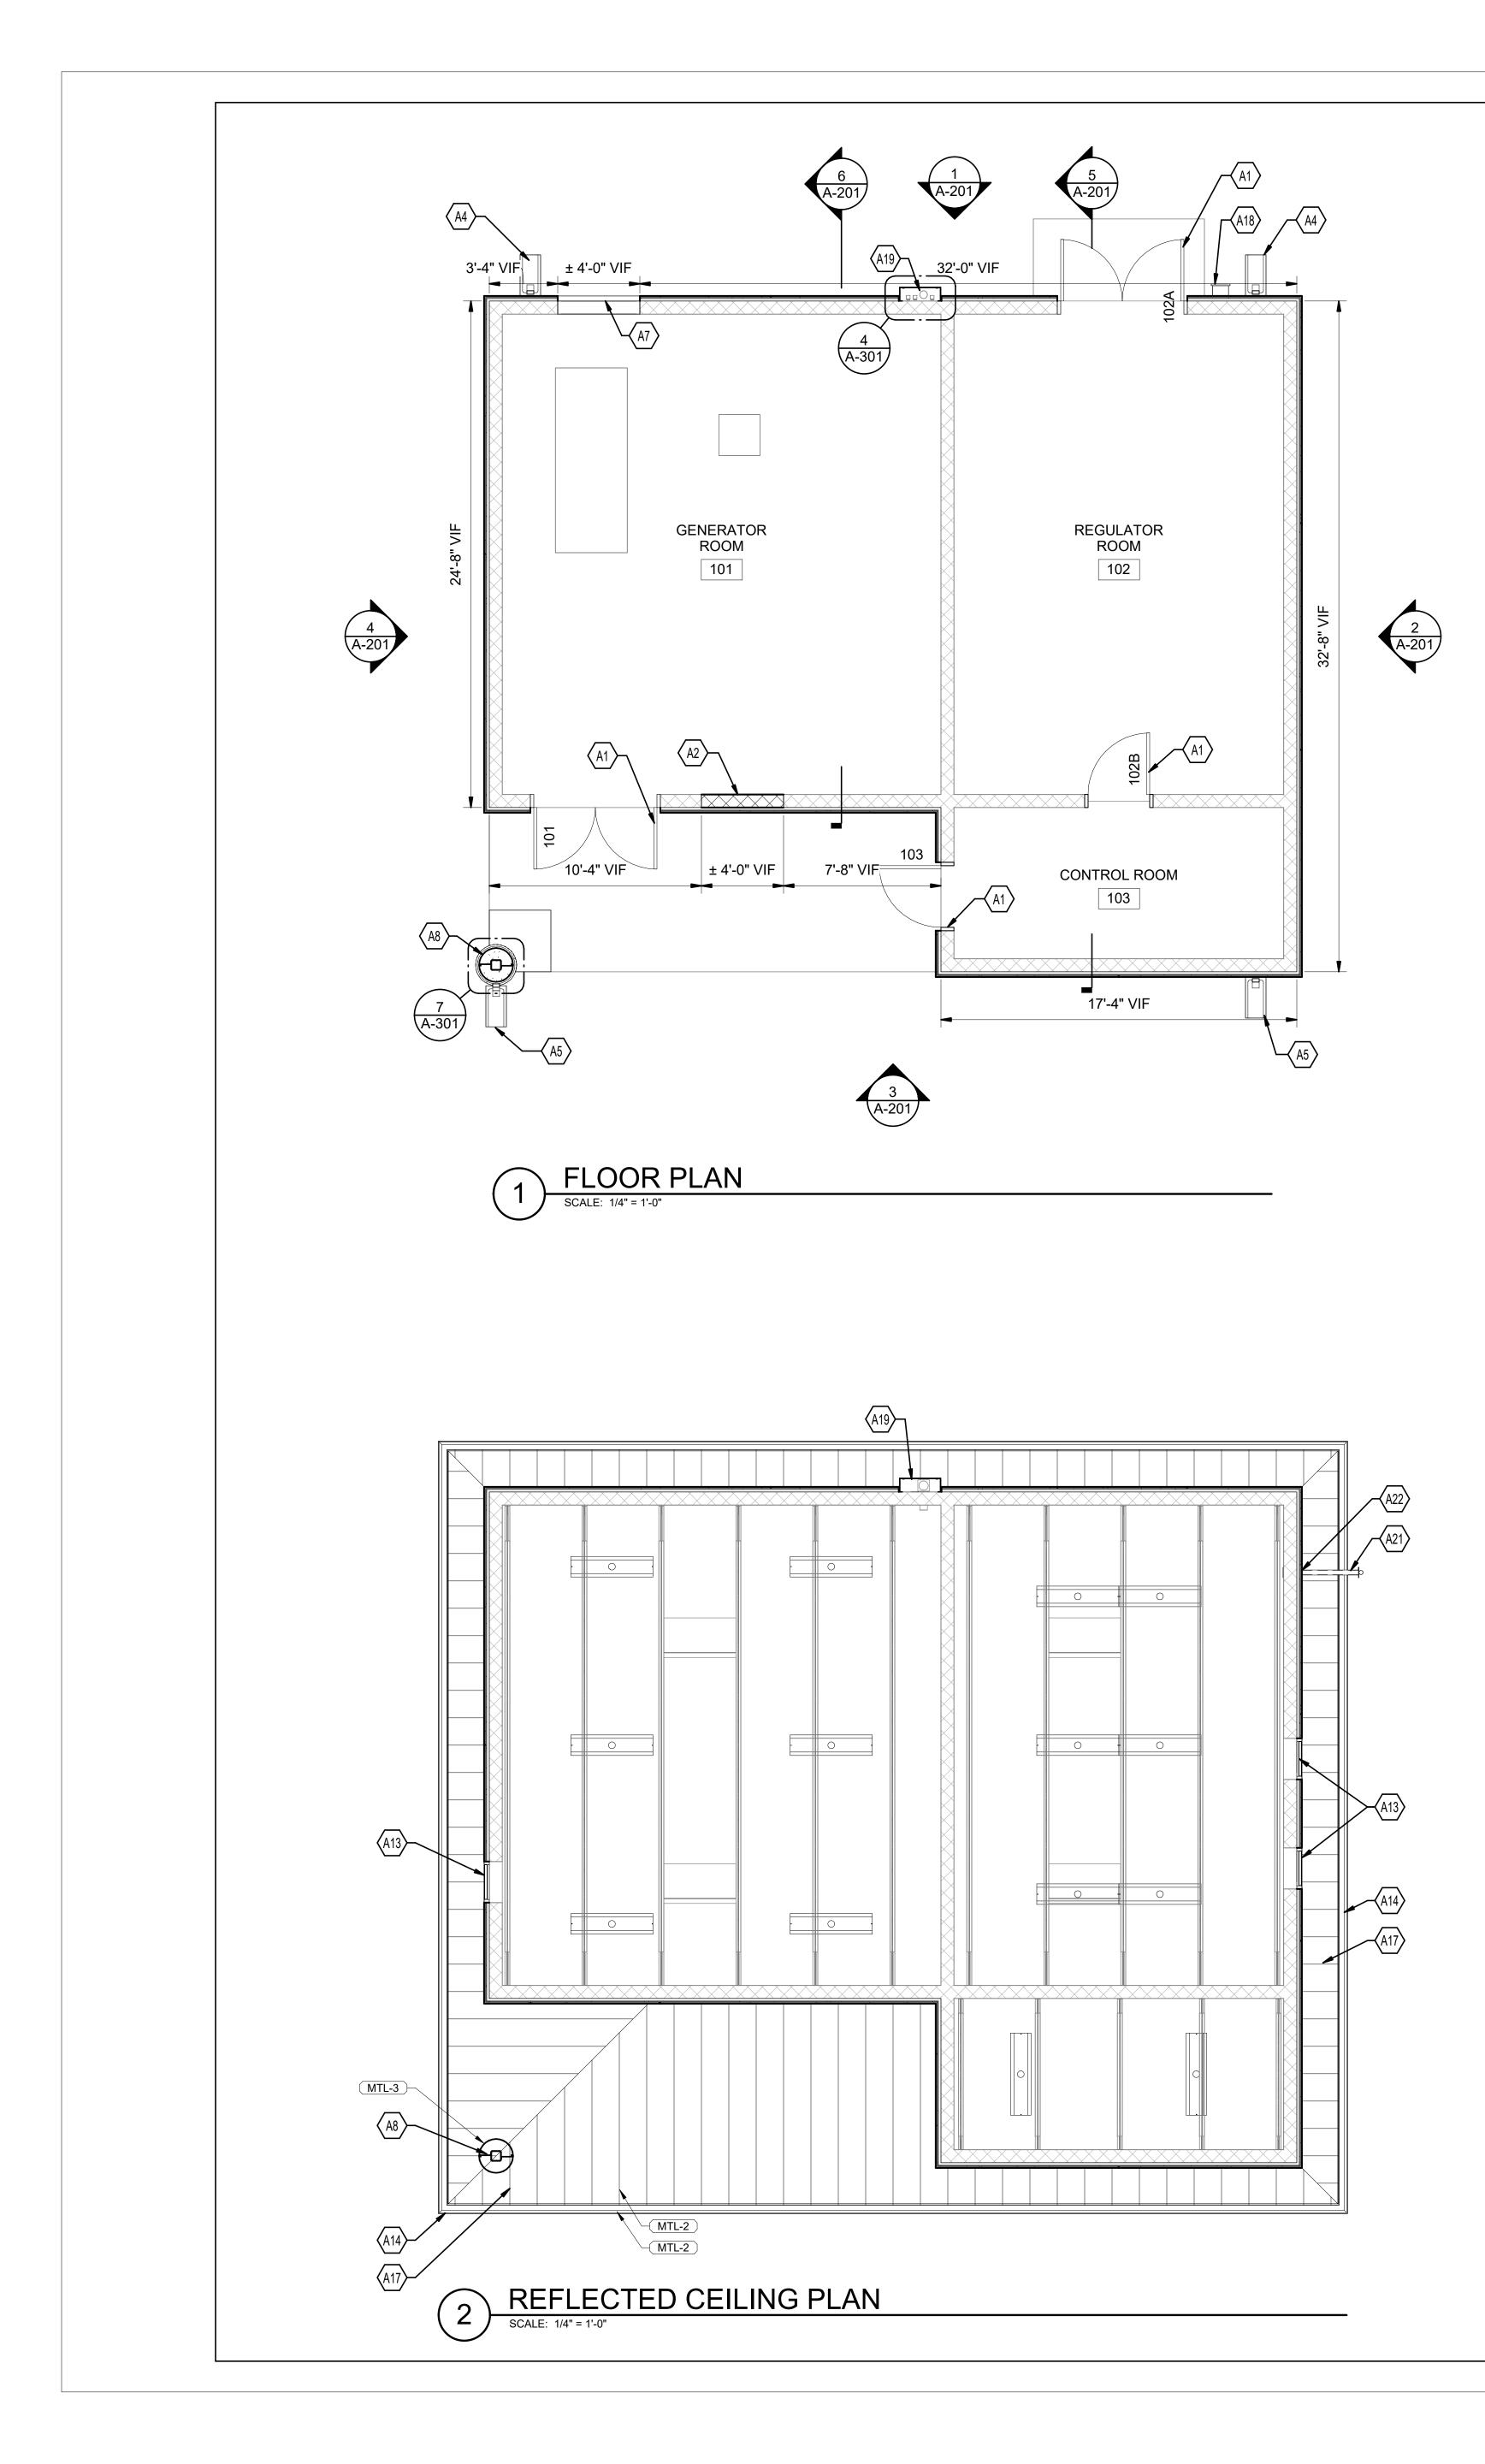


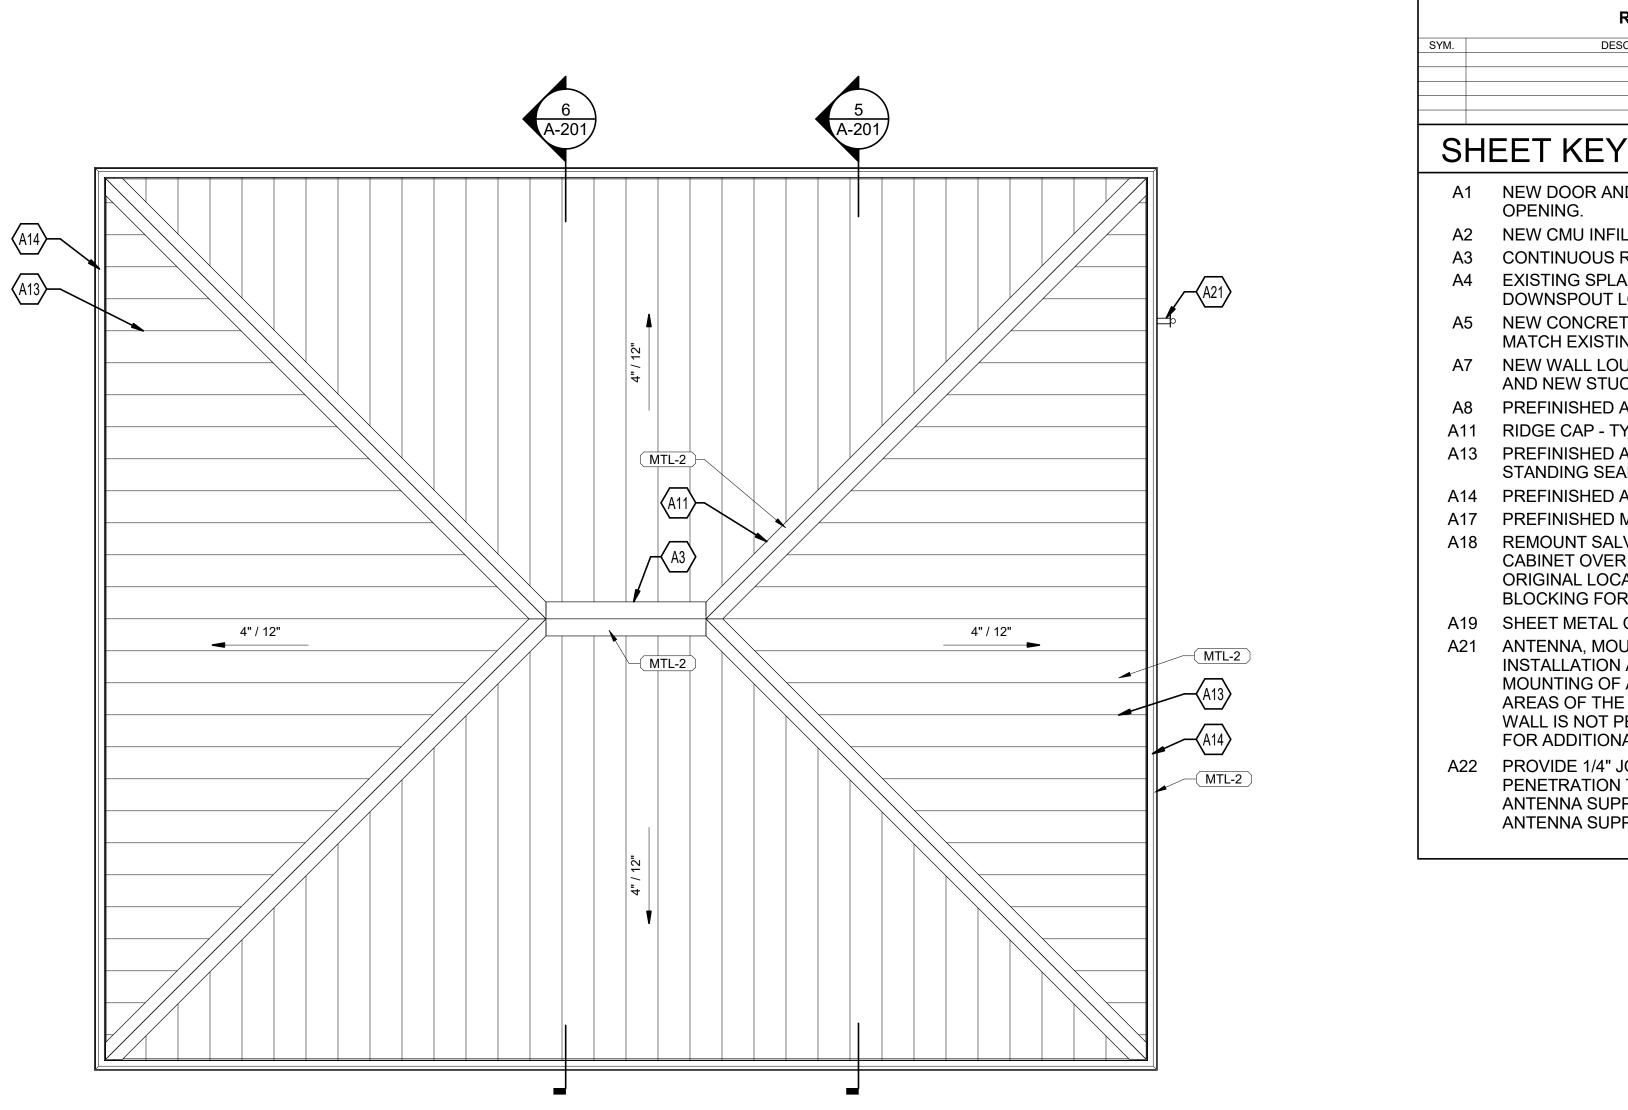
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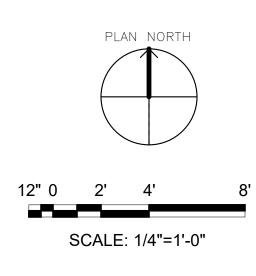






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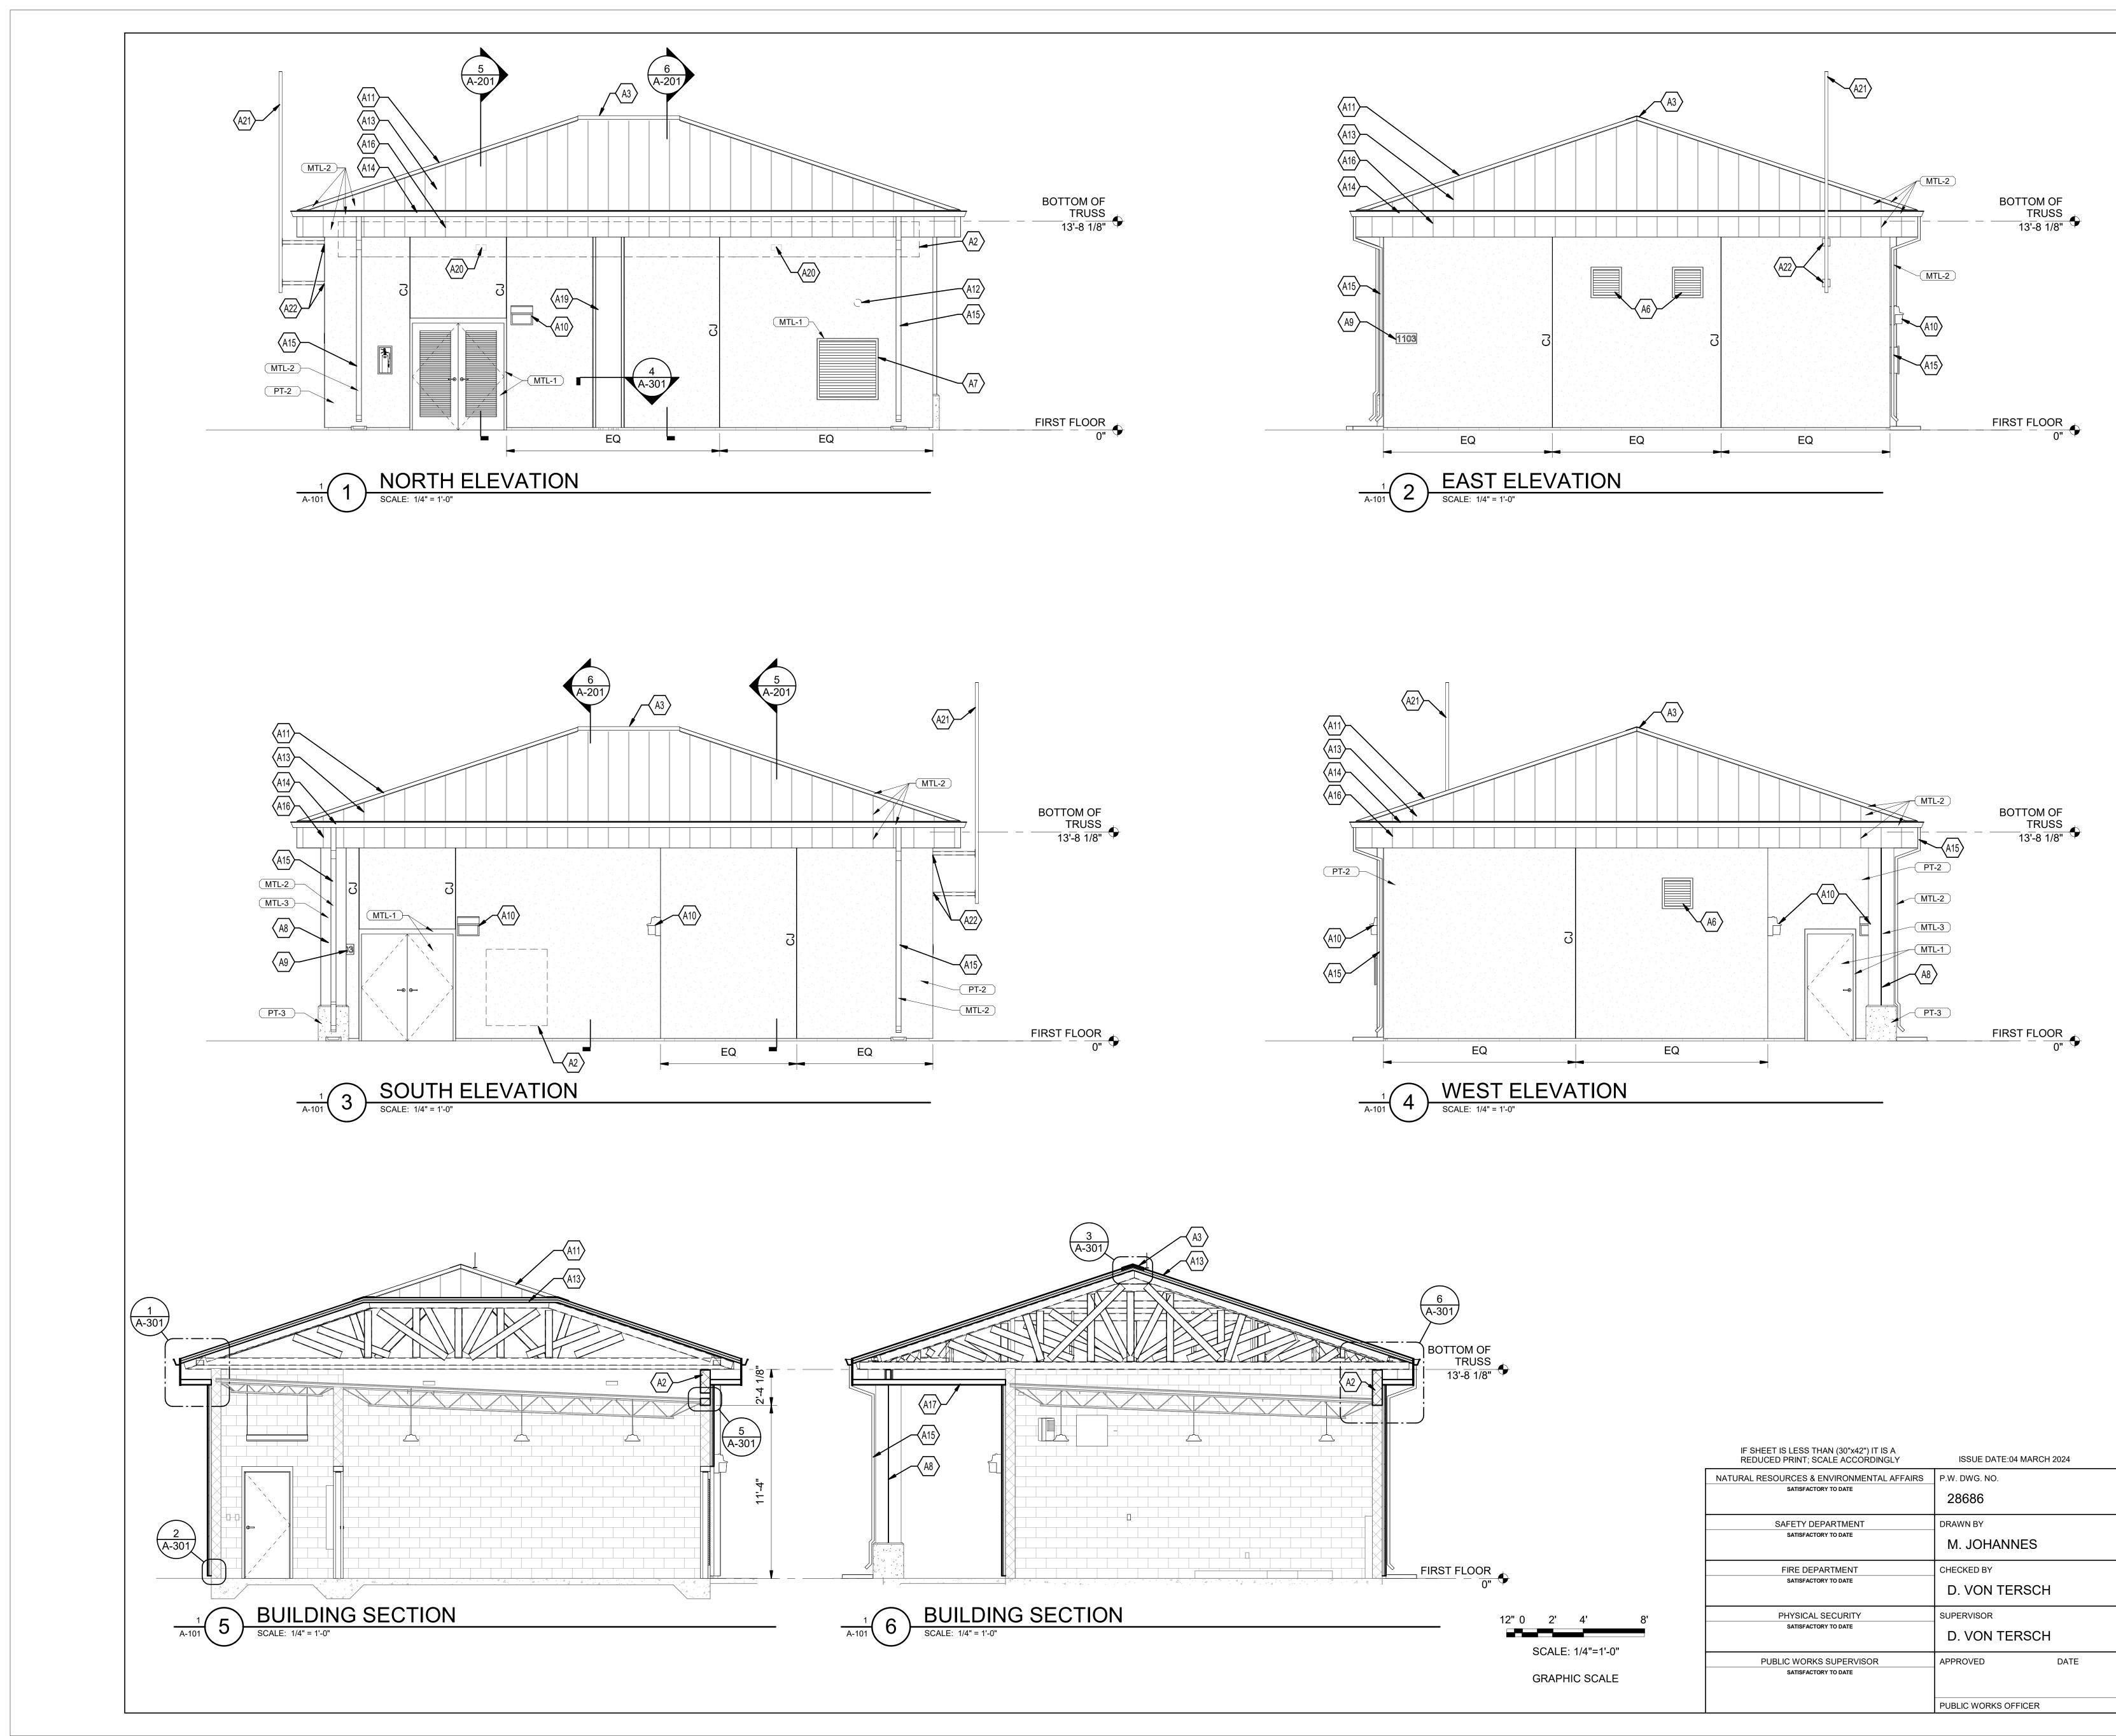
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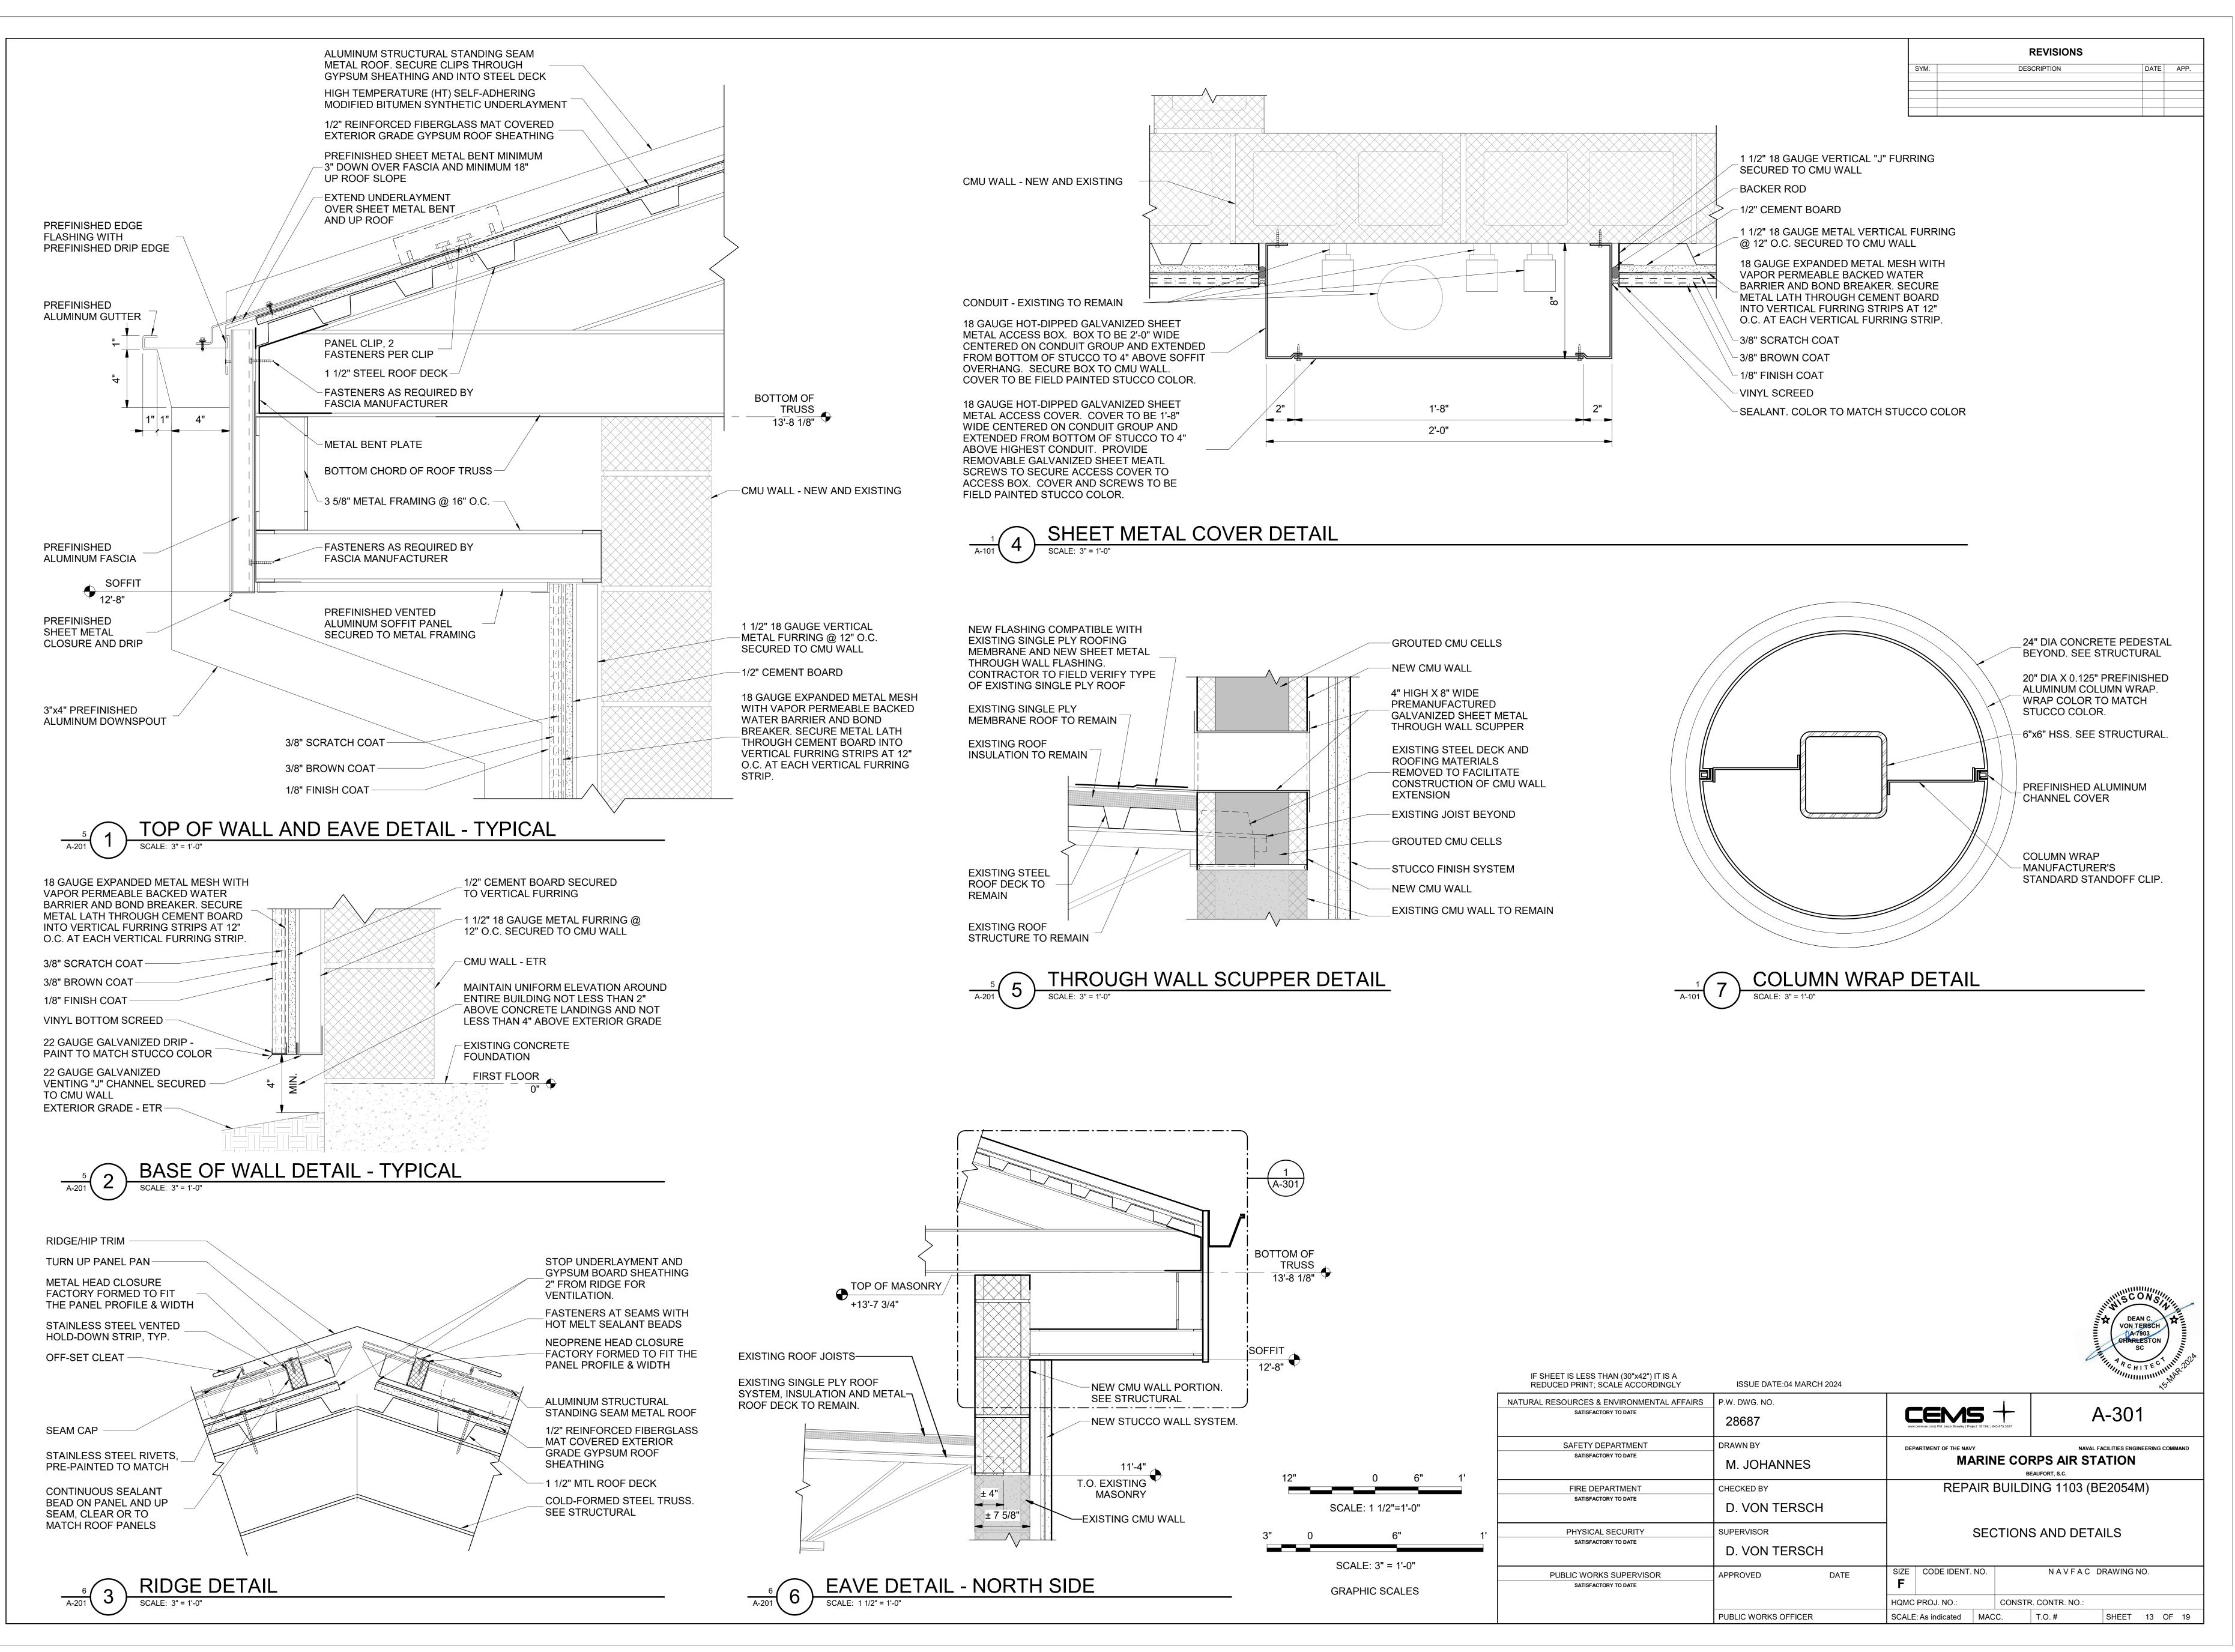
REVISIONS
DESCRIPTION DATE APP.
AND FRAME IN EXISTING MASONRY
NFILL. SEE STRUCTURAL.
JS RIDGE VENT. PLASH BLOCK RELOCATED TO NEW JT LOCATION.
RETE SPLASH BLOCK. NEW TO STING.
LOUVER IN EXISTING CMU OPENING TUCCO OPENING.
ED ALUMINUM COLUMN WRAP. - TYPICAL. ED ALUMINUM STRUCTURAL
SEAM METAL ROOF. ED ALUMINUM GUTTER.
ED METAL PANEL SOFFIT. SALVAGED FIRE EXTINGUISHER AND
VER NEW STUCCO FINISH AT OCATION. PROVIDE METAL FOR CABINET SUPPORT.
AL COVER FOR EXISTING CONDUIT. MOUNTING BRACKETS, AND FINAL
ON AND HOOKUP BY CONTRACTOR. OF ANTENNA TO ADDITIONAL THE BUILDING OTHER THAN THE
OT PERMITTED. SEE ELECTRICAL ONAL INFORMATION.
4" JOINT AT EACH NEW HSS ON THROUGH STUCCO FOR SUPPORT. SEE STRUCTURAL FOR
SUPPORT DETAIL.
STATISCON STATIS
DEAN C. VON TERSCH
SC S
A-101
NAVAL FACILITIES ENGINEERING COMMAND
BEAUFORT, S.C. LDING 1103 (BE2054M)
LECTED CEILING AND ROOF PLAN
N A V F A C DRAWING NO.
ISTR. CONTR. NO.: T.O. # SHEET 11 OF 19



SYM.	
S	HEET KE
A2	NEW CMU INFI
A3	CONTINUOUS
A6	NEW THROUG LOUVER. SEE
A7	NEW WALL LO AND NEW STU
A8	PREFINISHED
A9	REINSTALL EX
A10	LIGHTING FIXT
A11	RIDGE CAP - T
A12	2 INFILL DEMOLI WALL FOR GEI FULL THICKNE
A13	B PREFINISHED SEAM METAL F
A14	PREFINISHED
A15	PREFINISHED
A16	9 PREFINISHED PANEL.
A17	PREFINISHED
A19	SHEET METAL
A20	 NEW 4" HIGH X TYPICAL 2 EG WALL EXTENS DETAIL.
A21	
A22	2 PROVIDE 1/4" PENETRATION SUPPORT. SEE SUPPORT DET

	IF SHEET IS LESS THAN (30"x42") IT IS A REDUCED PRINT; SCALE ACCORDINGLY	ISSUE DATE:04 MARCH 2024	
	NATURAL RESOURCES & ENVIRONMENTAL AFFAIRS SATISFACTORY TO DATE	P.W. DWG. NO. 28686	WW.cerrs-ae.com PM: Jason Brawley Project: 18154L 843.875.3637
	SAFETY DEPARTMENT satisfactory to date	DRAWN BY M. JOHANNES	DEPARTMENT OF THE NAVY
	FIRE DEPARTMENT SATISFACTORY TO DATE	CHECKED BY D. VON TERSCH	REPAIR BUI
8' 	PHYSICAL SECURITY SATISFACTORY TO DATE	SUPERVISOR D. VON TERSCH	EXTERIOR ELE
E	PUBLIC WORKS SUPERVISOR SATISFACTORY TO DATE	APPROVED DATE	SIZE CODE IDENT. NO.
			HQMC PROJ. NO.: COM
		PUBLIC WORKS OFFICER	SCALE: 1/4" = 1'-0" MACC.

	REVISIONS SCRIPTION		DATE	APP.	-
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IED ME	ETAL PANE	L SOFFIT.			
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UILD	ING 1103	(BE2054	M)		
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CONSTF).	R. CONTR. NO. T.O. #		12	OF 19	






	IF SHEET IS LESS THAN (30"x42") IT IS A REDUCED PRINT; SCALE ACCORDINGLY	ISSUE DATE:04 MARCH 2024	
	NATURAL RESOURCES & ENVIRONMENTAL AFFAIRS	P.W. DWG. NO.	
	SATISFACTORY TO DATE	28687	www.ceme-ae.com PM: Jason Brawley Project: 18154L 843.875.3637
	SAFETY DEPARTMENT	DRAWN BY	DEPARTMENT OF THE NAVY
0 6" 1'	SATISFACTORY TO DATE	M. JOHANNES	MARINE C
	FIRE DEPARTMENT	CHECKED BY	REPAIR BUIL
SCALE: 1 1/2"=1'-0"	SATISFACTORY TO DATE	D. VON TERSCH	
0 6" 1'	PHYSICAL SECURITY	SUPERVISOR	SECTIO
	SATISFACTORY TO DATE	D. VON TERSCH	
SCALE: 3" = 1'-0"	PUBLIC WORKS SUPERVISOR	APPROVED DATE	SIZE CODE IDENT. NO.
GRAPHIC SCALES	SATISFACTORY TO DATE		F


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FIRST FL	GEN	ERATOR R			PT									
102 103		ULATOR RO			PT- PT-								·	
										EGENI				
MAR	K		Ν	/IATE	ERIAL				MA	NUFAC	TUF	RER	ST	FYLE
CEILING EXP-1		SED STRU	CTURE											
LOORIN		SED CONC	DETE											
MISC.		JSED CONC												
MTL-1 MTL-2		AL DOORS, F, GUTTERS								CASTLE CASTLE				
MTL-3 PT-2	PREF STUC	INISHED CO	OLUMN	WRAP)									
PT-3	CON	CRETE						_						
VALLS PT-1	INTE	RIOR WALL	PAINT						SHE	RWIN WILLIA	AMS	S	ATIN	
					NI									
		ROOM	LOCA	TIOI	N			0	PEN	NG	D(DOR		
NO. 101	F	ROOM		TC			1PE 2F	0 WIDT 6'-0"		NG IEIGHT 7'-0"		DOR HICKNI 1 3/4"	ESS	M
101 102A 102B			GENE REGU REGU	TC RATOF LATOF LATOF) R ROOM R ROOM R ROOM	2	2F 2FL L	6'-0" 6'-0" 3'-0"		HEIGHT 7'-0" 7'-0" 7'-0"		HCKNI 1 3/4" 1 3/4" 1 3/4"	=	
102A		ROM	GENE REGU REGU	TC RATOF LATOF) R ROOM R ROOM R ROOM	2	2F 2FL	WIDT 6'-0" 6'-0"		HEIGHT 7'-0" 7'-0"		HICKNI 1 3/4" 1 3/4"	=	M/
101 102A 102B		ROM	GENE REGU REGU	TC RATOF LATOF LATOF) R ROOM R ROOM R ROOM	2	2F 2FL L	6'-0" 6'-0" 3'-0"		HEIGHT 7'-0" 7'-0" 7'-0"		HCKNI 1 3/4" 1 3/4" 1 3/4"	=SS	M/
101 102A 102B		ROM OL ROOM	GENE REGU REGU CONT	TC RATOF LATOF ROL R) R ROOM R ROOM R ROOM	2	2F 2FL F	WIDT 6'-0" 3'-0" 3'-0"	H H	HEIGHT 7'-0" 7'-0" 7'-0"	T	HICKNI 1 3/4" 1 3/4" 1 3/4" 1 3/4" RIMETER	DO	
101 102A 102B			GENE REGU REGU CONT	TC RATOF LATOF ROL R) R ROOM R ROOM R ROOM	2	2F 2FL F	6'-0" 6'-0" 3'-0"		HEIGHT 7'-0" 7'-0" 7'-0"	T	HCKN 1 3/4" 1 3/4" 1 3/4" 1 3/4"	DO	
101 102A 102B	CONTR		GENE REGU CONT	TC RATOF LATOF ROL R	CKSET	(EACH)	2F 2FL F CLC	WIDT 6'-0" 3'-0" 3'-0"	H H (EACH)	HEIGHT 7'-0" 7'-0" 7'-0" RESHOLD	(EACH)	HICKNI 1 3/4" 1 3/4" 1 3/4" 1 3/4" RIMETER SASKET	(EACH)	
101 102A 102B 103 SET MA	CONTR	NON-REMOVEABLE PIN SECURITY STUD SECURITY STUD A	GENE REGU CONT	TC RATOF LATOF ROL R	CKSET		2F 2FL F CLC NOEN	WIDT 6'-0" 3'-0" 3'-0"		HEIGHT 7'-0" 7'-0" 7'-0"		HICKNI 1 3/4" 1 3/4" 1 3/4" 1 3/4" RIMETER	OTY (EACH)	
101 102A 102B 103	CONTR	ROM OL ROOM HINGES HINGES NON-KEWONEABLE IN SECURITY STUD NON-RABLE IN A SECURITY STUD NON-RABLE IN A S	GENE REGU CONT	TC RATOF LATOF ROL R	CKSET		2F 2FL F CLC	WIDT 6'-0" 3'-0" 3'-0" OSER OSER	H H (EACH)	HEIGHT 7'-0" 7'-0" 7'-0" RESHOLD	(EACH)	HICKNI 1 3/4" 1 3/4" 1 3/4" 1 3/4" RIMETER SASKET	(EACH)	
101 102A 102B 103 SET MA	CONTR (1.5)	ROM OL ROOM HINGES HINGES NON-KEWONEABLE IN SECURITY STUD NON-RABLE IN A SECURITY STUD NON-RABLE IN A S	GENE REGU REGU CONT	TC RATOF LATOF ROL R	CKSET		2F 2FL L F CLC NO-ODEN No Yes Yes	WIDT 6'-0" 3'-0" 3'-0" OSER OSER	H H TH OTY (EACH) 1	HEIGHT 7'-0" 7'-0" 7'-0" 7'-0" RESHOLD ANSI#		HICKNI 1 3/4" 1 3/4" 1 3/4" 1 3/4" RIMETER SASKET ANSI# R3C266	DO SI (H) A SI SI SI SI SI SI SI SI SI SI SI SI SI	
101 102A 102B 103 SET MA	CONTR (1.5)	ROM OL ROOM HINGES HINGES NON-KEWONEABLE IN SECURITY STUD NON-RABLE IN A SECURITY STUD NON-RABLE IN A S	GENE REGU REGU CONT	TC RATOF LATOF ROL R	CKSET		2F 2FL L F CLC NO-ODEN No Yes Yes	WIDT 6'-0" 3'-0" 3'-0" OSER OSER	H H TH OTY (EACH) 1	HEIGHT 7'-0" 7'-0" 7'-0" 7'-0" RESHOLD ANSI#		HICKNI 1 3/4" 1 3/4" 1 3/4" 1 3/4" 3/4" ANSI# ANSI# R3C266 R3C266 FREE AI LOUVEF	DO SI OLA (EACH)	
101 102A 102B 103 SET MA	CONTR (1.5)	ROM OL ROOM HINGES HINGES NON-KEWONEABLE IN SECURITY STUD NON-RABLE IN A SECURITY STUD NON-RABLE IN A S	GENE REGU REGU CONT	TC RATOF LATOF ROL R LO LO LO	CKSET		2F 2FL L F CLC NO-ODEN No Yes Yes	WIDT 6'-0" 3'-0" 3'-0" OSER OSER	H H TH OTY (EACH) 1	HEIGHT 7'-0" 7'-0" 7'-0" 7'-0" RESHOLD ANSI#		HICKNI 1 3/4" 1 3/4" 1 3/4" 1 3/4" 1 3/4" RIMETER ANSI# ANSI# R3C266 R3C266 R3C266 FREE AI LOUVEF EXCEED	DO SI OLA (EACH)	
101 102A 102B 103 SET MA	CONTR (1.5)	ROM OL ROOM HINGES HINGES NON-KEWONEABLE IN SECURITY STUD NON-RABLE IN A SECURITY STUD NON-RABLE IN A S	ANSI#	TC RATOF LATOF ROL R LO LO	R ROOM R ROOM R ROOM R ROOM COM		2F 2FL L F CLC NO-ODEN No Yes Yes	WIDT 6'-0" 3'-0" 3'-0" OSER OSER	H H TH OTY (EACH) 1	HEIGHT 7'-0" 7'-0" 7'-0" 7'-0" RESHOLD ANSI#		HICKNI 1 3/4" 1 3/4" 1 3/4" 1 3/4" 1 3/4" RIMETER ANSI# ANSI# R3C266 R3C266 R3C266 FREE AI LOUVEF EXCEED	DO SI OLA (EACH)	
101 102A 102B 103 SET MA	CONTR (1.5)	ROM OL ROOM HINGES HINGES NON-KEWONEABLE IN SECURITY STUD NON-RABLE IN A SECURITY STUD NON-RABLE IN A S	ANSI#	TC RATOF LATOF ROL R LO LO LO	R ROOM R ROOM R ROOM R ROOM COM		2F 2FL L F CLC NOEN BACKCHECK	WIDT 6'-0" 3'-0" 3'-0" OSER OSER	H H TH OTY (EACH) 1	HEIGHT 7'-0" 7'-0" 7'-0" 7'-0" RESHOLD ANSI#		HICKNI 1 3/4" 1 3/4" 1 3/4" 1 3/4" 1 3/4" RIMETER ANSI# ANSI# R3C266 R3C266 R3C266 FREE AI LOUVEF EXCEED	DO SI OLA (EACH)	
101 102A 102B 103 SET MA EXTERIOR EX1 EX2 EX3	CONTR (1.5)	ROM OL ROOM HINGES NON-KEWONEABLE IN AUXINON Yes Yes Yes Yes Yes Yes Yes Yes	ANSI#	TC RATOF LATOF ROL R LO LO	CKSET		2F 2FL L F HOPO-DEN No Yes Yes Yes Yes	WIDT 6'-0" 3'-0" 3'-0" OSER OSER		HEIGHT 7'-0" 7'-0" 7'-0" 7'-0" 8 RESHOLD ANSI# J36100 J36130		HICKNI 1 3/4" 1 3/4" 1 3/4" 1 3/4" 1 3/4" RIMETER ANSI# ANSI# ANSI# G FREE AI LOUVEF EXCEED		

	LING AT. NOTES & REMA	ARKS	
	(P-1 ALL EXPOSED STRUCTURE TO BE EX	/D 1	
	(P-1 ALL EXPOSED STRUCTURE TO BE EX		
	(P-1 ALL EXPOSED STRUCTURE TO BE EX		
	AND FINISHES	1	
LE	COLOR	SIZE	COMMENTS
			CLEAN
	DARK BRONZE, BUILDING ENVELOPE #740		SEE COMMENT #1
	DARK BRONZE, BUILDING ENVELOPE #740		SEE COMMENT #1
			SEE COMMENT #1, COMMENT #
	RGB COLOR 211, 188, 162		SEE COMMENT #1
			SEE COMMENT #2
		1	
	SANDBAR 7547		SEE COMMENT #1

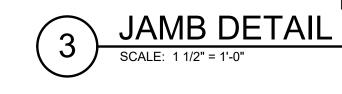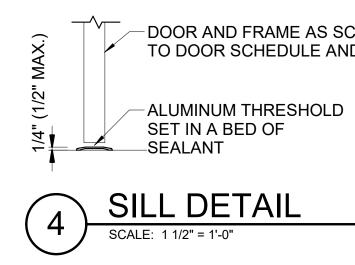IAL SELECTION BY THE CONTRACTOR. THE MANUFACTURERS E ONLY. ALL PRODUCT NAMES AND MANUFACTURERS IF THE PRODUCT MEETS THE SPECIFICATIONS, AND THE FINISH INSURE THE MANUFACTURERS CHOSEN BY THE CONTRACTOR DUCT INDICATED, MEET BUY AMERICA ACT REQUIREMENTS, AND TOR. ALL PROPOSED BUILDING MATERIALS SHALL BE SUBMITTED



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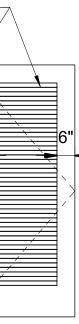



Γ	DOOR	SCHEE	DULE								
RATING (MIN.)				FRAME							
							D	ETAILS			
ATERIAL	FINISH	FIRE	STC	TYPE	MATERIAL	FINISH	HEAD	JAMB	SILL	NO.	HARDWARE
HM	PNT			A	HM	PNT	2/A-601	3/A-601	4/A-601	101	EX3
HM	PNT			A	HM	PNT	2/A-601	3/A-601	4/A-601	102A	EX3
HM	PNT			A	HM	PNT	5/A-601	6/A-601	7/A-601	102B	EX1
HM	PNT			A	HM	PNT	2/A-601	3/A-601	4/A-601	103	EX2

R HARDWARE SET SCHEDULE

CER	EX	IT DEVICE		PUSH		PULL		PLATES		SWEEP	A	STRAGAL	FLU	JSH BOLT	D	RIP EDGE	
	<pre>(SET)</pre>		(EACH)		(EACH)		(EACH)		(EACH)		(EACH)		(EACH)		(SET)		
ISI#	QTY	ANSI#	QTY	ANSI#	QTΥ	ANSI#	QTY	ANSI#	QTY	ANSI#	QTY	ANSI#	QTΥ	ANSI#	QTY	ANSI#	REMARKS
3011	0		0		0		1	J102	1		0		0		0		
	0		0		0		1	J102	1	R3B436	0		0		1	R3Y976 ON	

3011	0	 0	 0	 1	J102	1		0		0		0		
	0	 0	 0	 1	J102	1	R3B436	0		0		1	R3Y976 ON	
													HEAD JAMB	
	0	 0	 0	 2	J102	2	R3B436	1	R3B634	1	L04251 TOP &	1		FLUSH BOLTS ON LHR DOOR
											BOTTOM		HEAD JAMB	




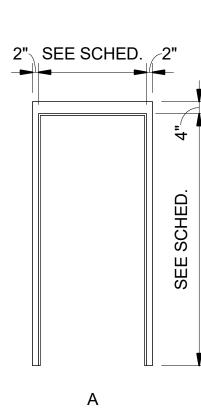

LOUVER)



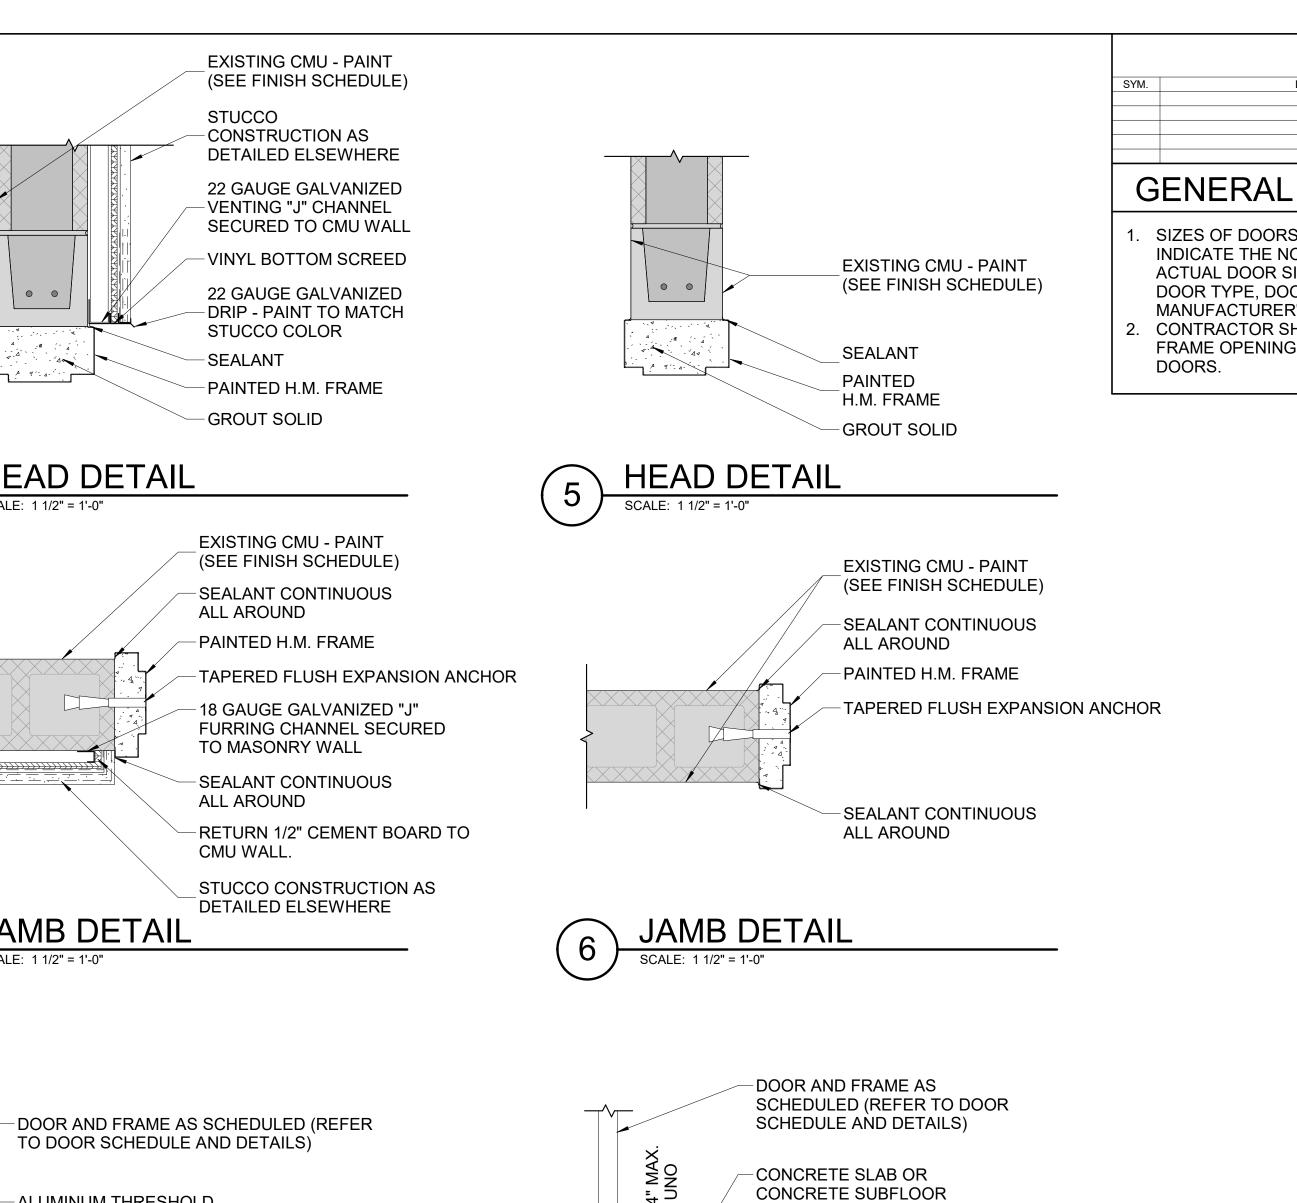12"



SILL DETAIL

SCALE: 1 1/2" = 1'-0"

	REDUCED PRINT; SCALE ACCORDINGLY	ISSUE DATE:04 MARCH 2024	
	NATURAL RESOURCES & ENVIRONMENTAL AFFAIRS SATISFACTORY TO DATE	P.W. DWG. NO. 28688	WW. cerrs-ae.com PM: Jason Brawley Project: 18154L 843.875.3637
	SAFETY DEPARTMENT SATISFACTORY TO DATE	DRAWN BY M. JOHANNES	DEPARTMENT OF THE NAVY
	FIRE DEPARTMENT SATISFACTORY TO DATE	CHECKED BY D. VON TERSCH	REPAIR BUII
	PHYSICAL SECURITY SATISFACTORY TO DATE	SUPERVISOR D. VON TERSCH	SCHEDU
CALE: 1 1/2"=1'-0"	PUBLIC WORKS SUPERVISOR SATISFACTORY TO DATE	APPROVED DATE	SIZE CODE IDENT. NO.

PUBLIC WORKS OFFICER

HQMC PROJ. NO.:

SCALE: As indicated MACC.


IF SHEET IS LESS THAN (30"x42") IT IS A

GRAPHIC SCALE


COMMENTS

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DES	SCRIPTION DATE APP.	
A -		
ALN	NOTES	
OR SIZE	IINAL SIZE OF THE OPENING. THE E WILL VARY DEPENDING ON THE	
URER'S	UNDERCUT, AND MOUNTING HARDWARE.	
OR SHA	LL FIELD VERIFY ALL DOOR AND PRIOR TO FABRICATION OF NEW	
	IN NISCONSTITUTION	
	DEAN C. VON TERSCH	
	CHARLESTON SC	
	DEAN C. VON TERSCH AA7903 CHARLESTON SC HITTEC THINK CHITEC THINK CHITEC THINK CHITEC THINK CHITEC THINK CHITEC THINK CHITEC	
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843.875.3637		
	RPS AIR STATION	
	EAUFORT, S.C.	
В	ING 1103 (BE2054M)	
В		
BUILD		
BUILD	ING 1103 (BE2054M)	
BUILD	ING 1103 (BE2054M)	
BUILD	ING 1103 (BE2054M) ES AND DETAILS	
BUILD	ING 1103 (BE2054M) ES AND DETAILS	

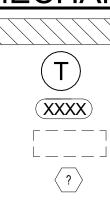MECHANICAL LEGEND:



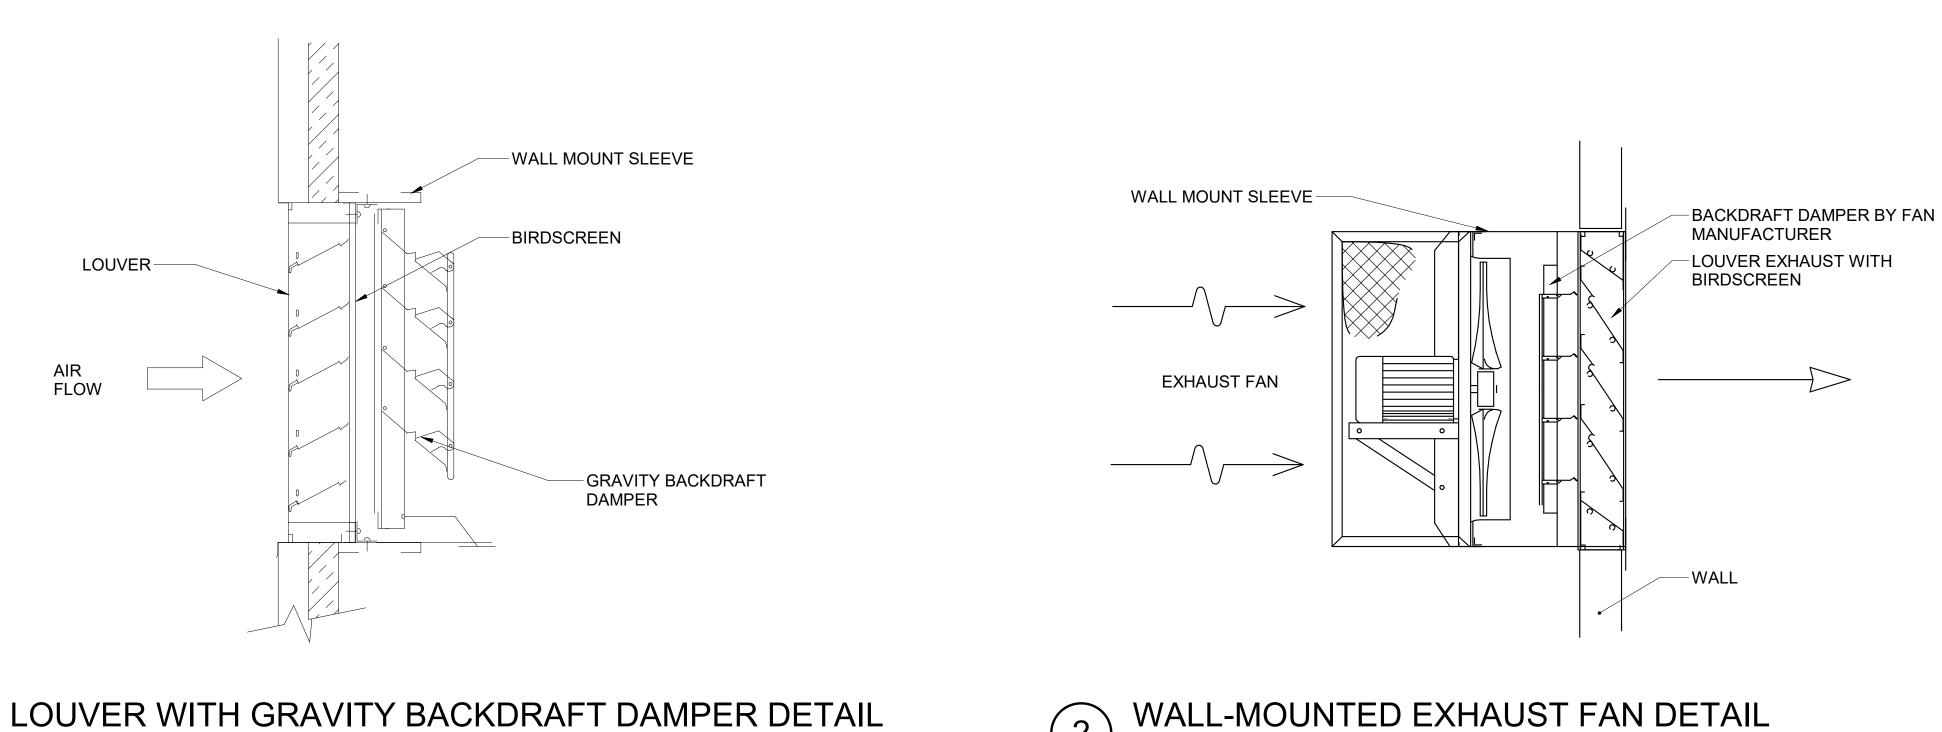TO BE REMOVED/DEMOLISHED THERMOSTAT (T) AIR DISTRIBUTION MARK **REQUIRED EQUIPMENT CLEARANCES** KEYNOTE



(2)

SCALE: NOT TO SCALE

LOUVER WITH GRAVITY BACKDRAFT DAMPER DETAIL SCALE: NOT TO SCALE

ELECTRIC UNIT HEATER SCHEDULE												
			RATED CAPACITY ELECTRICAL									
MARK	TYPE	CFM	(KW)	EAT (°F)	LAT (°F)	MOTOR HP	MCA	V/Ø/HZ				
UH-1	ELECTRIC	160	5	30	95	0.03	19.9	208/1/60				
UH-2	ELECTRIC	130	3	30	95	0.03	11.1	208/1/60				

1. PROVIDE SINGLE POINT POWER CONNECTION. 2. PROVIDE WALL MOUNTED THERMOSTAT AS SHOWN ON SHEET M-101. THERMOSTAT SHALL BE SET AT 55 °F.

	EXHAUST FAN SCHEDULE											
TAG	FAN TYPE	ESP ("W.C.)	CFM	DRIVE	MOTOR HP	V/Φ/HZ	OPENING SIZE					
EF-1	WALL-MOUNTED PROP	0.75	2000	DIRECT	3/4	115/1/60	24X24					
EF-2	WALL-MOUNTED PROP	0.75	2000	DIRECT	3/4	115/1/60	24X24					
EF-3	WALL-MOUNTED PROP	0.75	1050	DIRECT	1/2	115/1/60	24X24					

1. PROVIDE SINGLE POINT POWER CONNECTION.

	ABBREVIATIONS								
(E)	EXISTING								
С	COMMAND (MODULATING CONTROL SIGNAL)								
DDC	DIRECT DIGITAL CONTROLLER								
EA	EXHAUST AIR								
EF	EXHAUST FAN								
NC	NORMALLY CLOSED								
Р	POSITION								
SBC	SYSTEM BUILDING CONTROLLER								
SS	START/STOP COMMAND								
STS	STATUS								
TYP.	TYPICAL								
UH	UNIT HEATER								
W/	WITH								

GENERAL	NOTES:

- 1. DRAWINGS ARE DIAGRAMMATIC IN NATURE AND ARE NOT TO BE SCALED FOR DIMENSIONS, UNLESS
- ADJUSTMENTS AS REQUIRED BASED ON EXISTING CONDITIONS. 2. ALL WORK SHOWN ON THESE DRAWINGS SHALL BE NEW UNLESS NOTED OTHERWISE AS EXISTING.
- 3. ALL EXISTING MECHANICAL SYSTEMS SHALL BE DEMOLISHED AND REMOVED BY THE CONTRACTOR
- SPECIFICATION.
- EXISTING WORK DAMAGED IN THE PERFORMANCE OF DEMOLITION AND/OR NEW WORK. 5. COORDINATE LOCATION OF MECHANICAL WORK WITH OTHER TRADES TO AVOID CONFLICTS AND INTERFERENCES. INSTALL ALL MECHANICAL EQUIPMENT SUCH THAT MANUFACTURER'S MAINTENANCE
- AREA IS CLEAR. 6. FIELD CHECK ALL ROUGH AND/OR FINISH DIMENSIONS FOR ACCURATE FITTING OF EQUIPMENT, NECESSARY FILLERS, SCRIBE STRIPS, PANELS, BASES, OR TRIM TO COMPLETE AND FINISH INSTALLATIONS.


DESIGN CONDITIONS										
OUTDOOR DESIGN CONDITIONS										
SEASON			DB/WI	B (°F)						
SUMMER		92.7/77.7								
WINTER		28								
INDO	OR DES	IGN CO	NDIT	IONS						
SPACE TYPE	SEASON	OCCU	PIED	UNOCCUPIED						
ALL	COOLING	-		88°F						
	HEATING	-		55°F						

DIMENSIONED. ALL EXISTING MECHANICAL EQUIPMENT LOCATIONS AND SIZING BASED ON AS-BUILT DRAWINGS AND FIELD VERIFICATION. CONTRACTOR SHALL BECOME TOTALLY FAMILIARIZED WITH AND VERIFY ALL EXISTING CONDITIONS AND DIMENSIONS THAT AFFECT THIS CONTRACT AND SHALL MAKE

CONTRACTOR SHALL PROVIDE ALL MATERIALS AND LABOR FOR A COMPLETE AND OPERABLE SYSTEM. ALL WORK TO BE PERFORMED SHALL BE PROVIDED BY THE CONTRACTOR UNLESS OTHERWISE NOTED. UNLESS INDICATED OTHERWISE. REMOVAL OF EQUIPMENT, ETC. IS TO INCLUDE ALL ASSOCIATED HANGERS, SUPPORTS, BRACKETS, CONTROLS, AND APPURTENANCES PHYSICALLY ATTACHED AT THE COMMENCEMENT OF DEMOLITION, UNLESS NOTED OTHERWISE. ALL DEMOLITION SHALL BE PER 02 41 00

4. WHEN WORKING IN AND AROUND THE EXISTING BUILDING, EXTREME CARE SHALL BE EXERCISED WITH REGARD TO PROTECTION OF THE EXISTING STRUCTURE AND MECHANICAL AND ELECTRICAL SERVICES WHICH WILL REMAIN. REPAIR, REPLACE, OR RESTORE TO THE SATISFACTION OF THE ENGINEER ALL

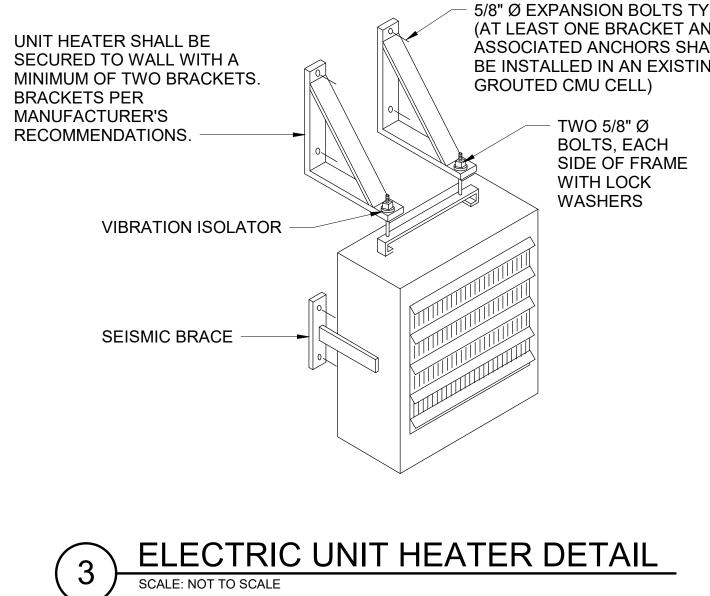CABINETS, COUNTERS, FIXTURES AND ACCESSORIES BEFORE FABRICATION. PROVIDE AND INSTALL ALL



NATURAL RESOURCES & ENVIRONMENTAL AFFAIRS	P.W. DWG. NO.
SATISFACTORY TO DATE	28689

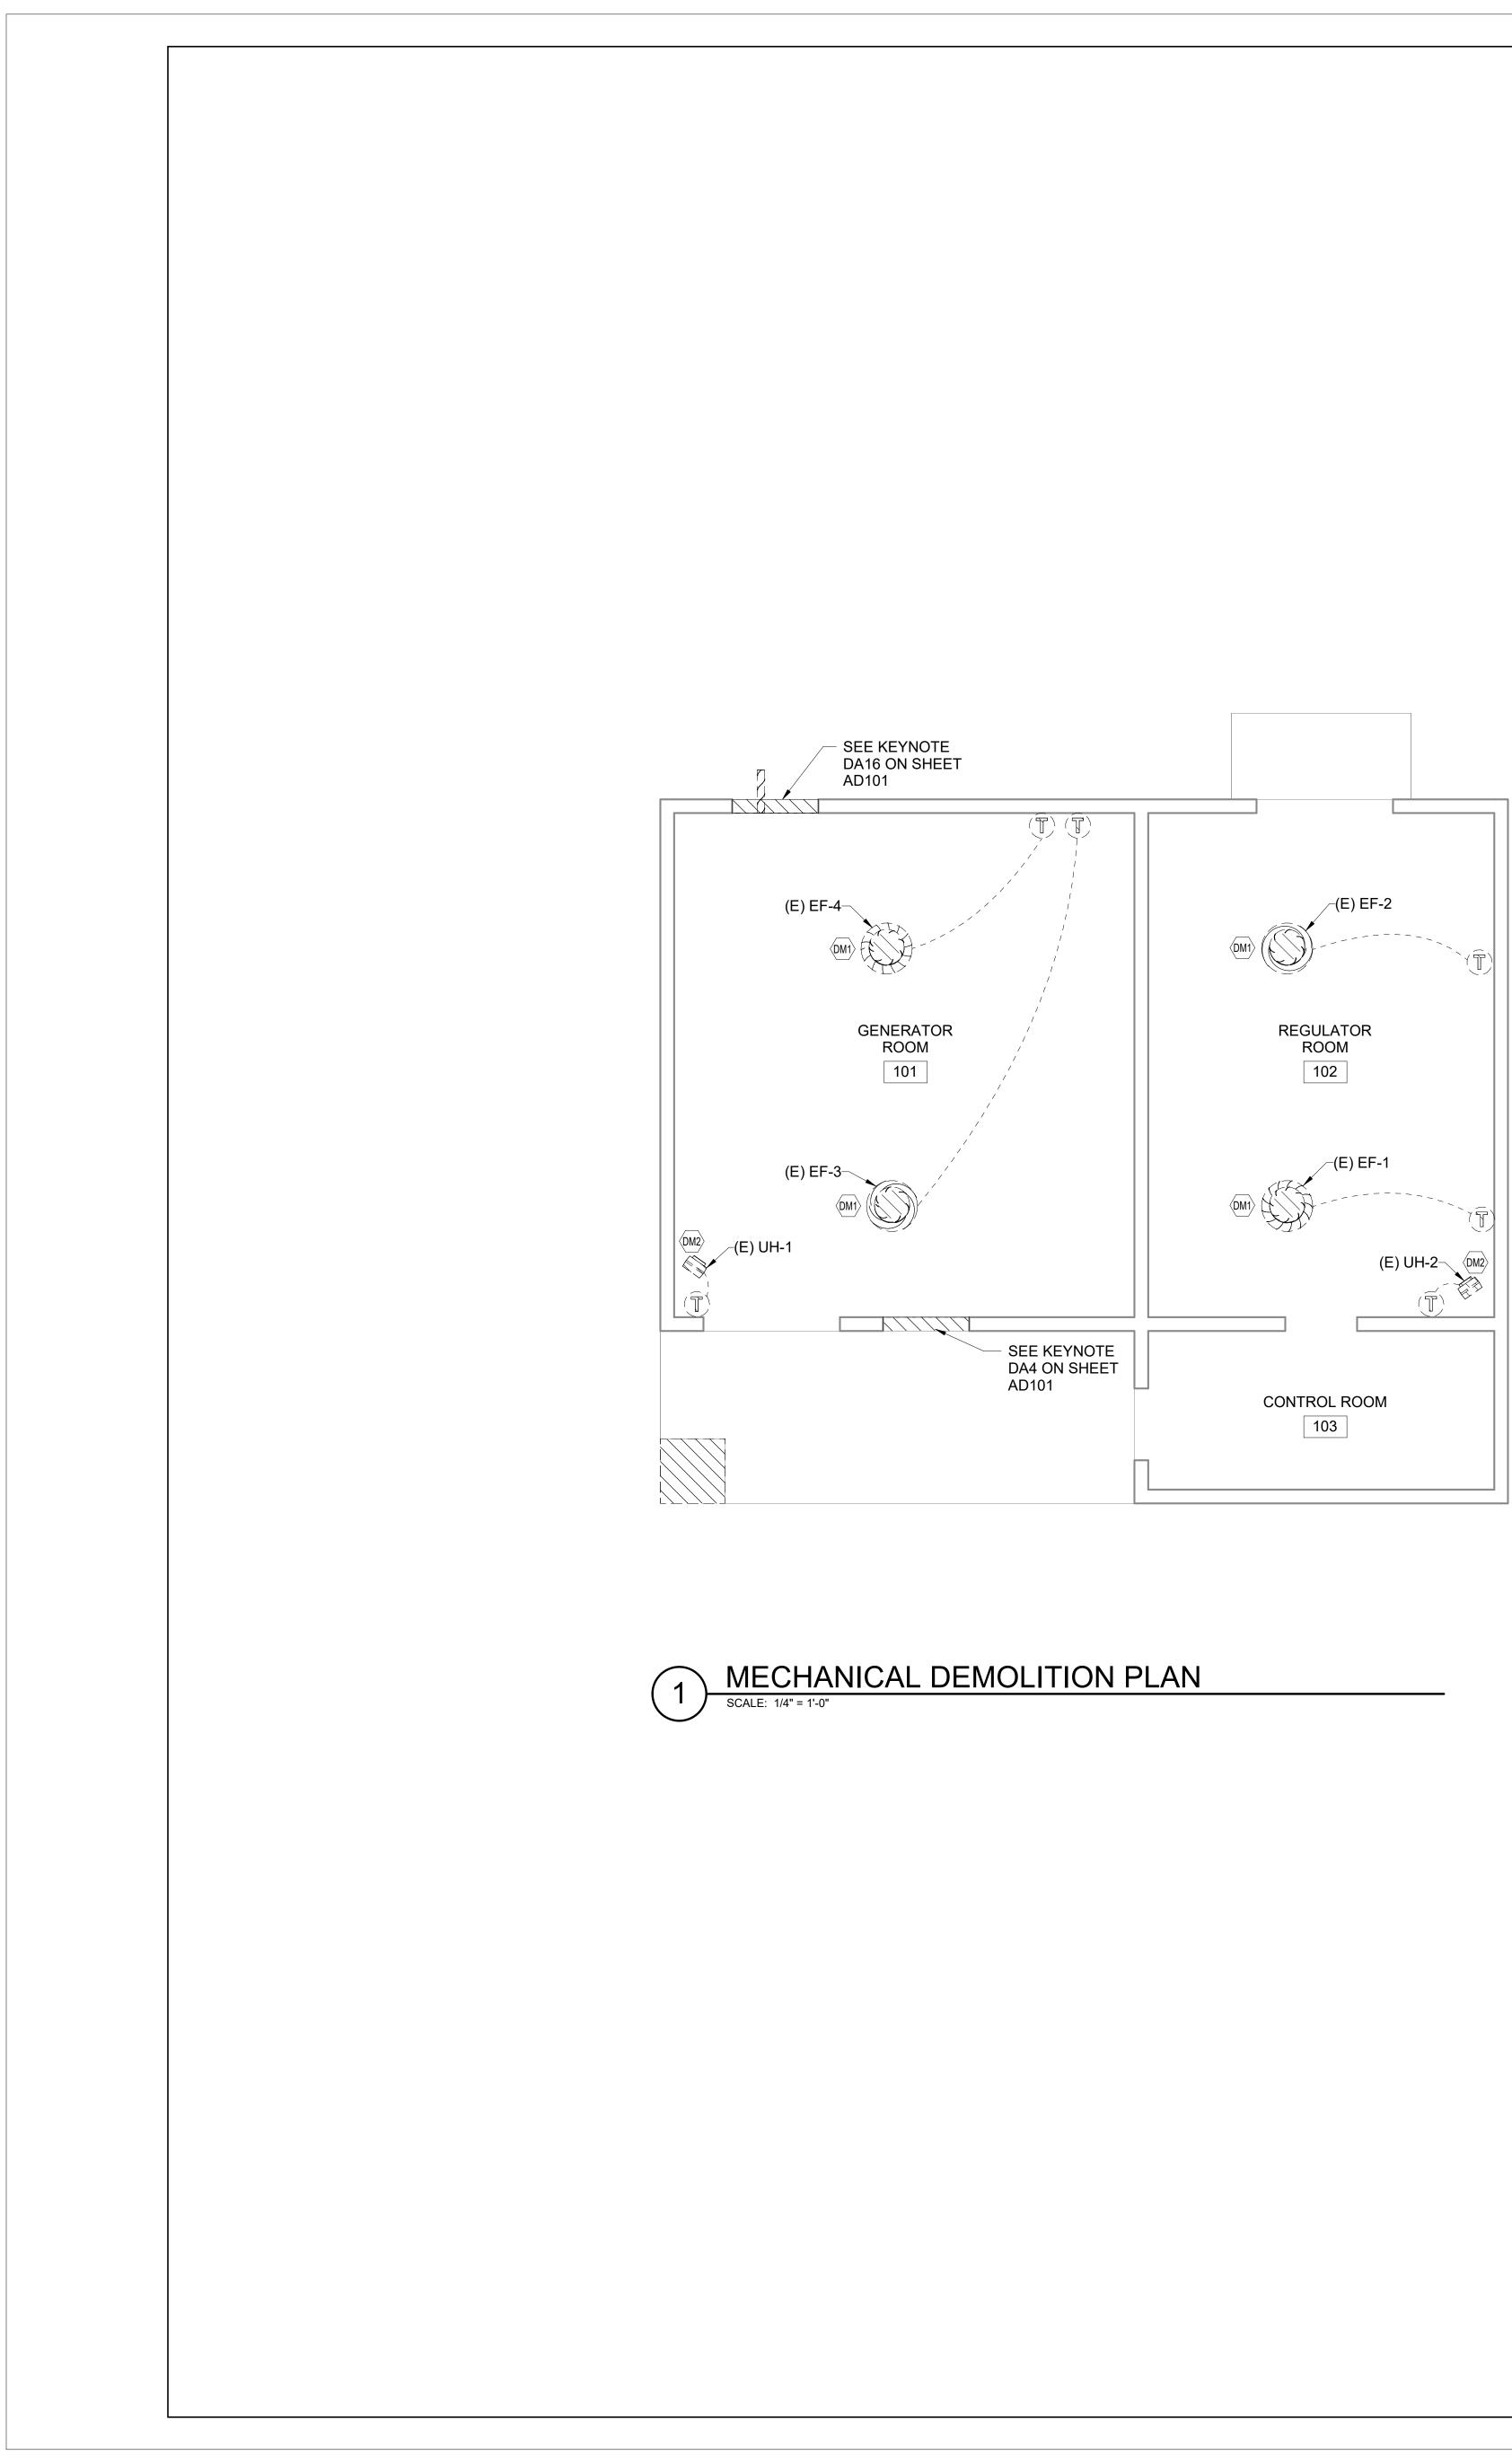
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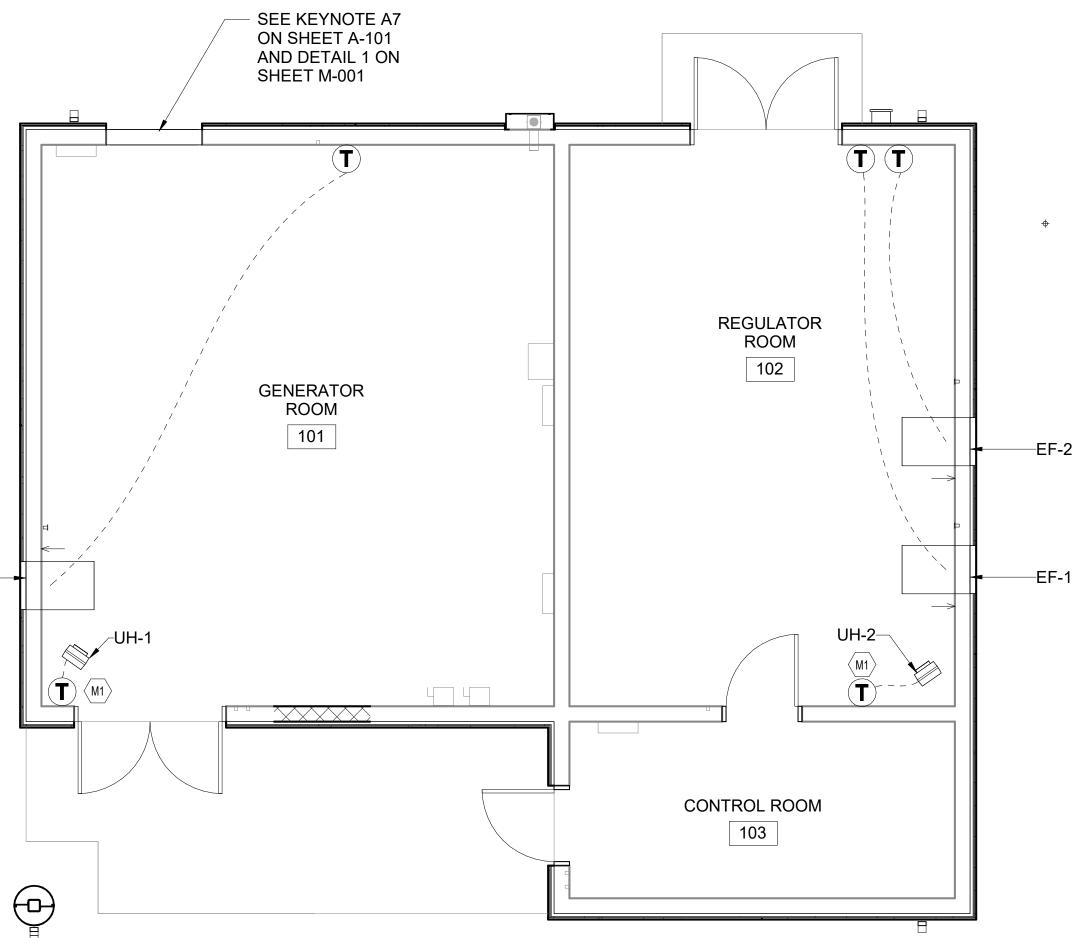
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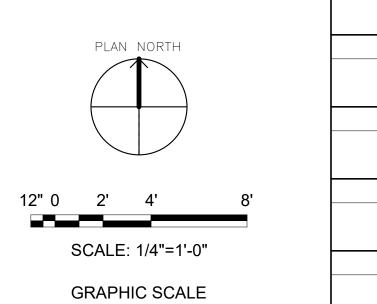
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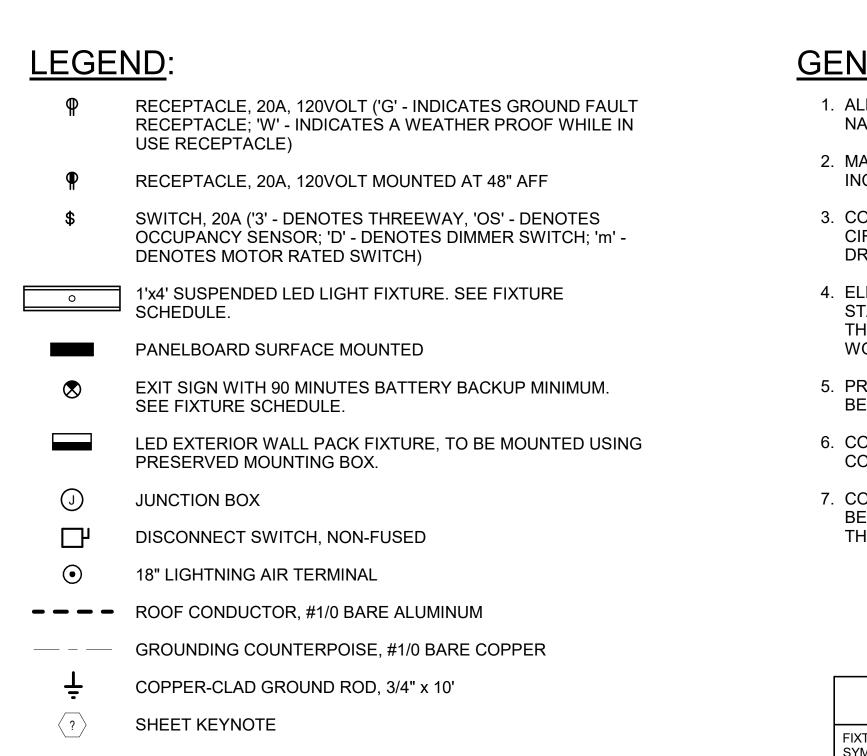






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FIXTURE SYMBOL \mathbb{A} A \triangle

LUMI	NAIRE REQUIREMENTS:	
1.	HOUSING - FIBERGLASS OR FIBERGLASS-REINFORCED POLYESTER OUTER HOUSING, WITH ALUMINUM COMPONENT TRAY AND HEAT SINK. OPTIONAL LENGTHS OF 4FT OR 8FT.	LUMIN
2.	LENS - IMPACT-RESISTANT ACRYLIC OR OPTIONAL POLYCARBONATE, WITH CONTINUOUS CLOSED-CELL POLYURETHANE GASKET, SECURED WITH STAINLESS STEEL OR POLYCARBONATE LATCHES.	1.
3.	LIGHT SOURCE - SOLID STATE LEDS WITH MINIMUM 50K HOURS RATED LIFE AT L70, 3500K CCT UON, MINIMUM 80 CRI, MAXIMUM 4-STEP MCADAM ELLIPSE BINNING TOLERANCE FOR COLOR CONSISTENCY, AND MINIMUM EFFICACY OF 100 LUMENS/WATT. INITIAL LUMEN OUTPUT AS INDICATED IN LUMINAIRE SCHEDULE.	2.
4.	DRIVER - REPLACEABLE, INTEGRAL, HIGH-EFFICIENCY DRIVER WITH MINIMUM 0.9 PF, OPERATING VOLTAGE OF 120-277V, THERMAL MANAGEMENT, < 20% TOTAL HARMONIC DISTORTION. ON-OFF CONTROL, STEP-DIMMABLE OR FULLY DIMMABLE AS INDICATED.	4.
5.	CERTIFICATION - UL 1598, WET LOCATION (IP65, IP66, IP67), DLC QUALIFIED, AND ROHS COMPLIANT. COMPLIES WITH LM79, LM80 AND TM21 TESTING STANDARDS. UL 924 WHEN EQUIPPED WITH EMERGENCY BATTERY BACK-UP.	
6.	MOUNTING - SURFACE-MOUNTED OR SUSPENDED FROM CEILING.	5.
7.	OPTIONS - POWER CORD, INTEGRAL MOTION SENSOR, EMERGENCY BACK-UP.	6.
8.	THIS SKETCH IS A NON-PROPRIETARY GRAPHIC REPRESENTATION OF A LUMINAIRE THAT MAY MEET THE SPECIFICATION REQUIREMENTS. IT IS NOT INTENDED TO INDICATE A CERTAIN MANUFACTURER OR PREFERENCE.	7.
	LED ENCLOSED AND GASKETED	
REVISE	D: APRIL 2016 LIGHTING PLATE: NL-11	REVISED:
		L

<u>GENERAL ELECTRICAL NOTES (APPLIES TO ALL DRAWINGS):</u>

1. ALL ELECTRICAL WORK IS TO BE DONE IN ACCORDANCE WITH THE CURRENT EDITION OF NFPA 70: NATIONAL ELECTRICAL CODE.

2. MATERIALS ARE TO BE NEW AND CONFORM TO THE STANDARDS OF THE UNDERWRITER'S LABORATORIES, INC. (U.L.) AND THE NATIONAL ELECTRICAL MANUFACTURERS ASSOCIATION (NEMA).

3. CONTRACTOR SHALL CONSIDER VOLTAGE DROP WHEN DETERMINING THE EXACT ROUTING OF BRANCH CIRCUIT AND FEEDER WIRING. ADJUST WIRE AND CONDUIT SIZE AS NECESSARY TO PREVENT A VOLTAGE DROP EXCEEDING 3% AT THE FURTHEST DEVICE LOCATION.

4. ELECTRICAL DRAWING IS GENERALLY DIAGRAMMATIC. COORDINATE WORK WITH ALL TRADES PRIOR TO START OF CONSTRUCTION. BRANCH CIRCUIT CONDUIT ROUTING SHALL BE COORDINATED IN THE FIELD BY THE CONTRACTOR TO MEET SPECIFICATIONS, CODE REQUIREMENTS, AND TO PROVIDE A NEAT, WORKMANLIKE, FULLY OPERATIONAL SYSTEM.


5. PROVIDE A TYPED SCHEDULE IN PANELBOARDS CLEARLY DESCRIBING THE LOCATION AND TYPE OF LOAD BEING SERVED FOR ALL CIRCUITS.

6. CONTRACTOR IS TO BE AWARE OF ALL RULES, REGULATIONS, AND CODES REQUIRED FOR SUCCESSFUL COMPLETION OF CONSTRUCTION.

7. COORDINATE WITH THE MECHANICAL PLANS FOR THE EXACT LOCATION OF ALL MECHANICAL EQUIPMENT BEFORE ROUGHING IN. ALL MECHANICAL EQUIPMENT SHALL BE ROUGHED IN AND WIRED ACCORDING TO THE APPROVED SHOP DRAWINGS.

LIGHTING FIXTURE SCHEDULE								
STYLE NO. & TYPE NUMBER AND TYPE VOLTAGE MOUNTING NOTES								
NL-11	54W LED 5700 LUM	MVOLT	SUSPENDED AT 10' 0" AFF					
NL-48	26W LED 2000 LUMENS	MVOLT	WALL MTD.	FIXTURE TO HAVE 100 PERCENT CUTOFF				
NL-63	1.5 W LED RED	MVOLT	UNV MTD.	PROVIDE BATTERY BACKUP DRIVER				

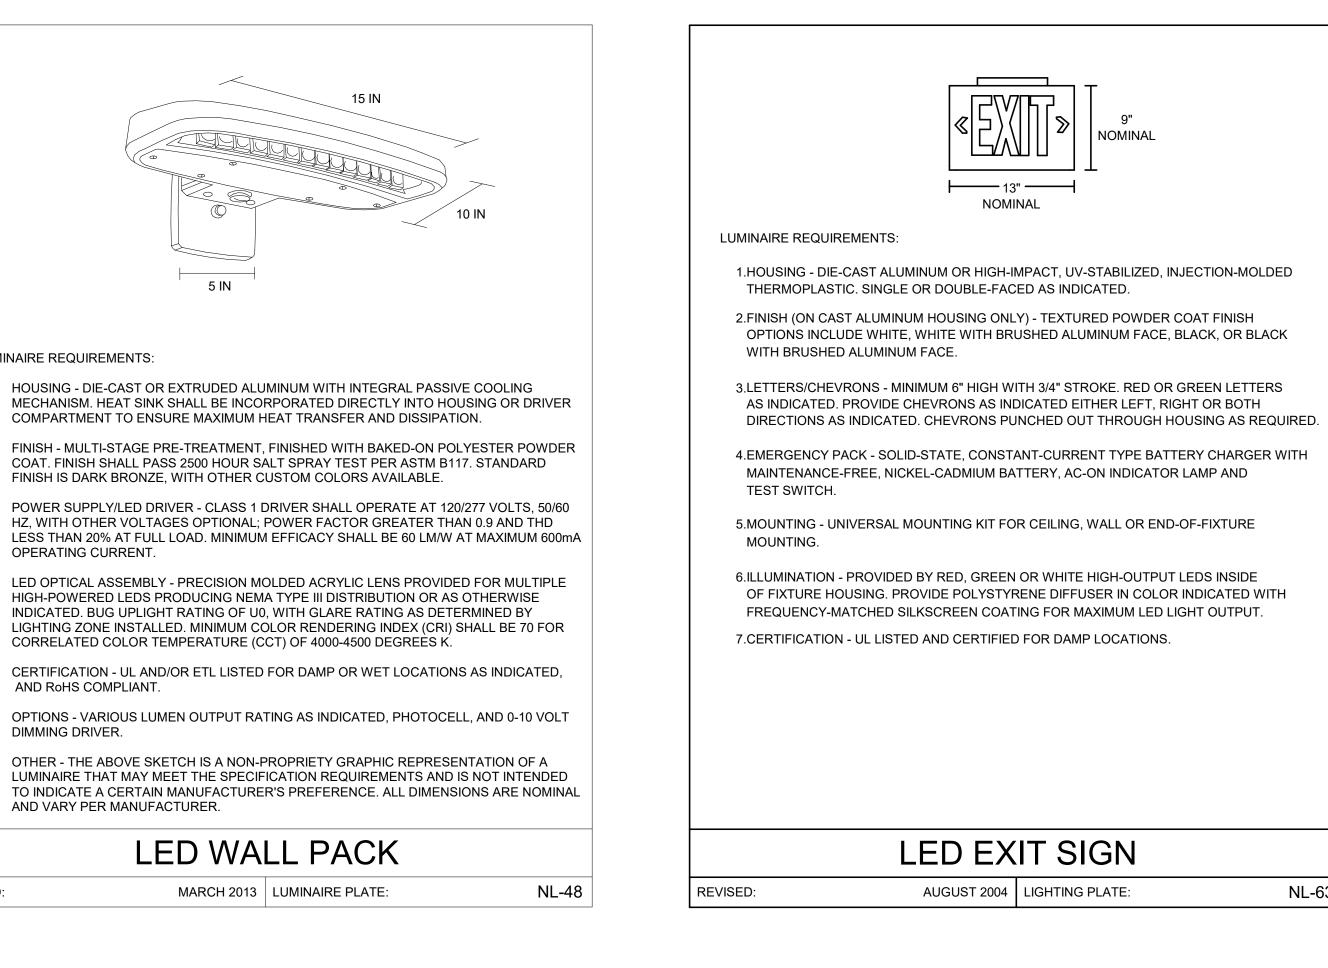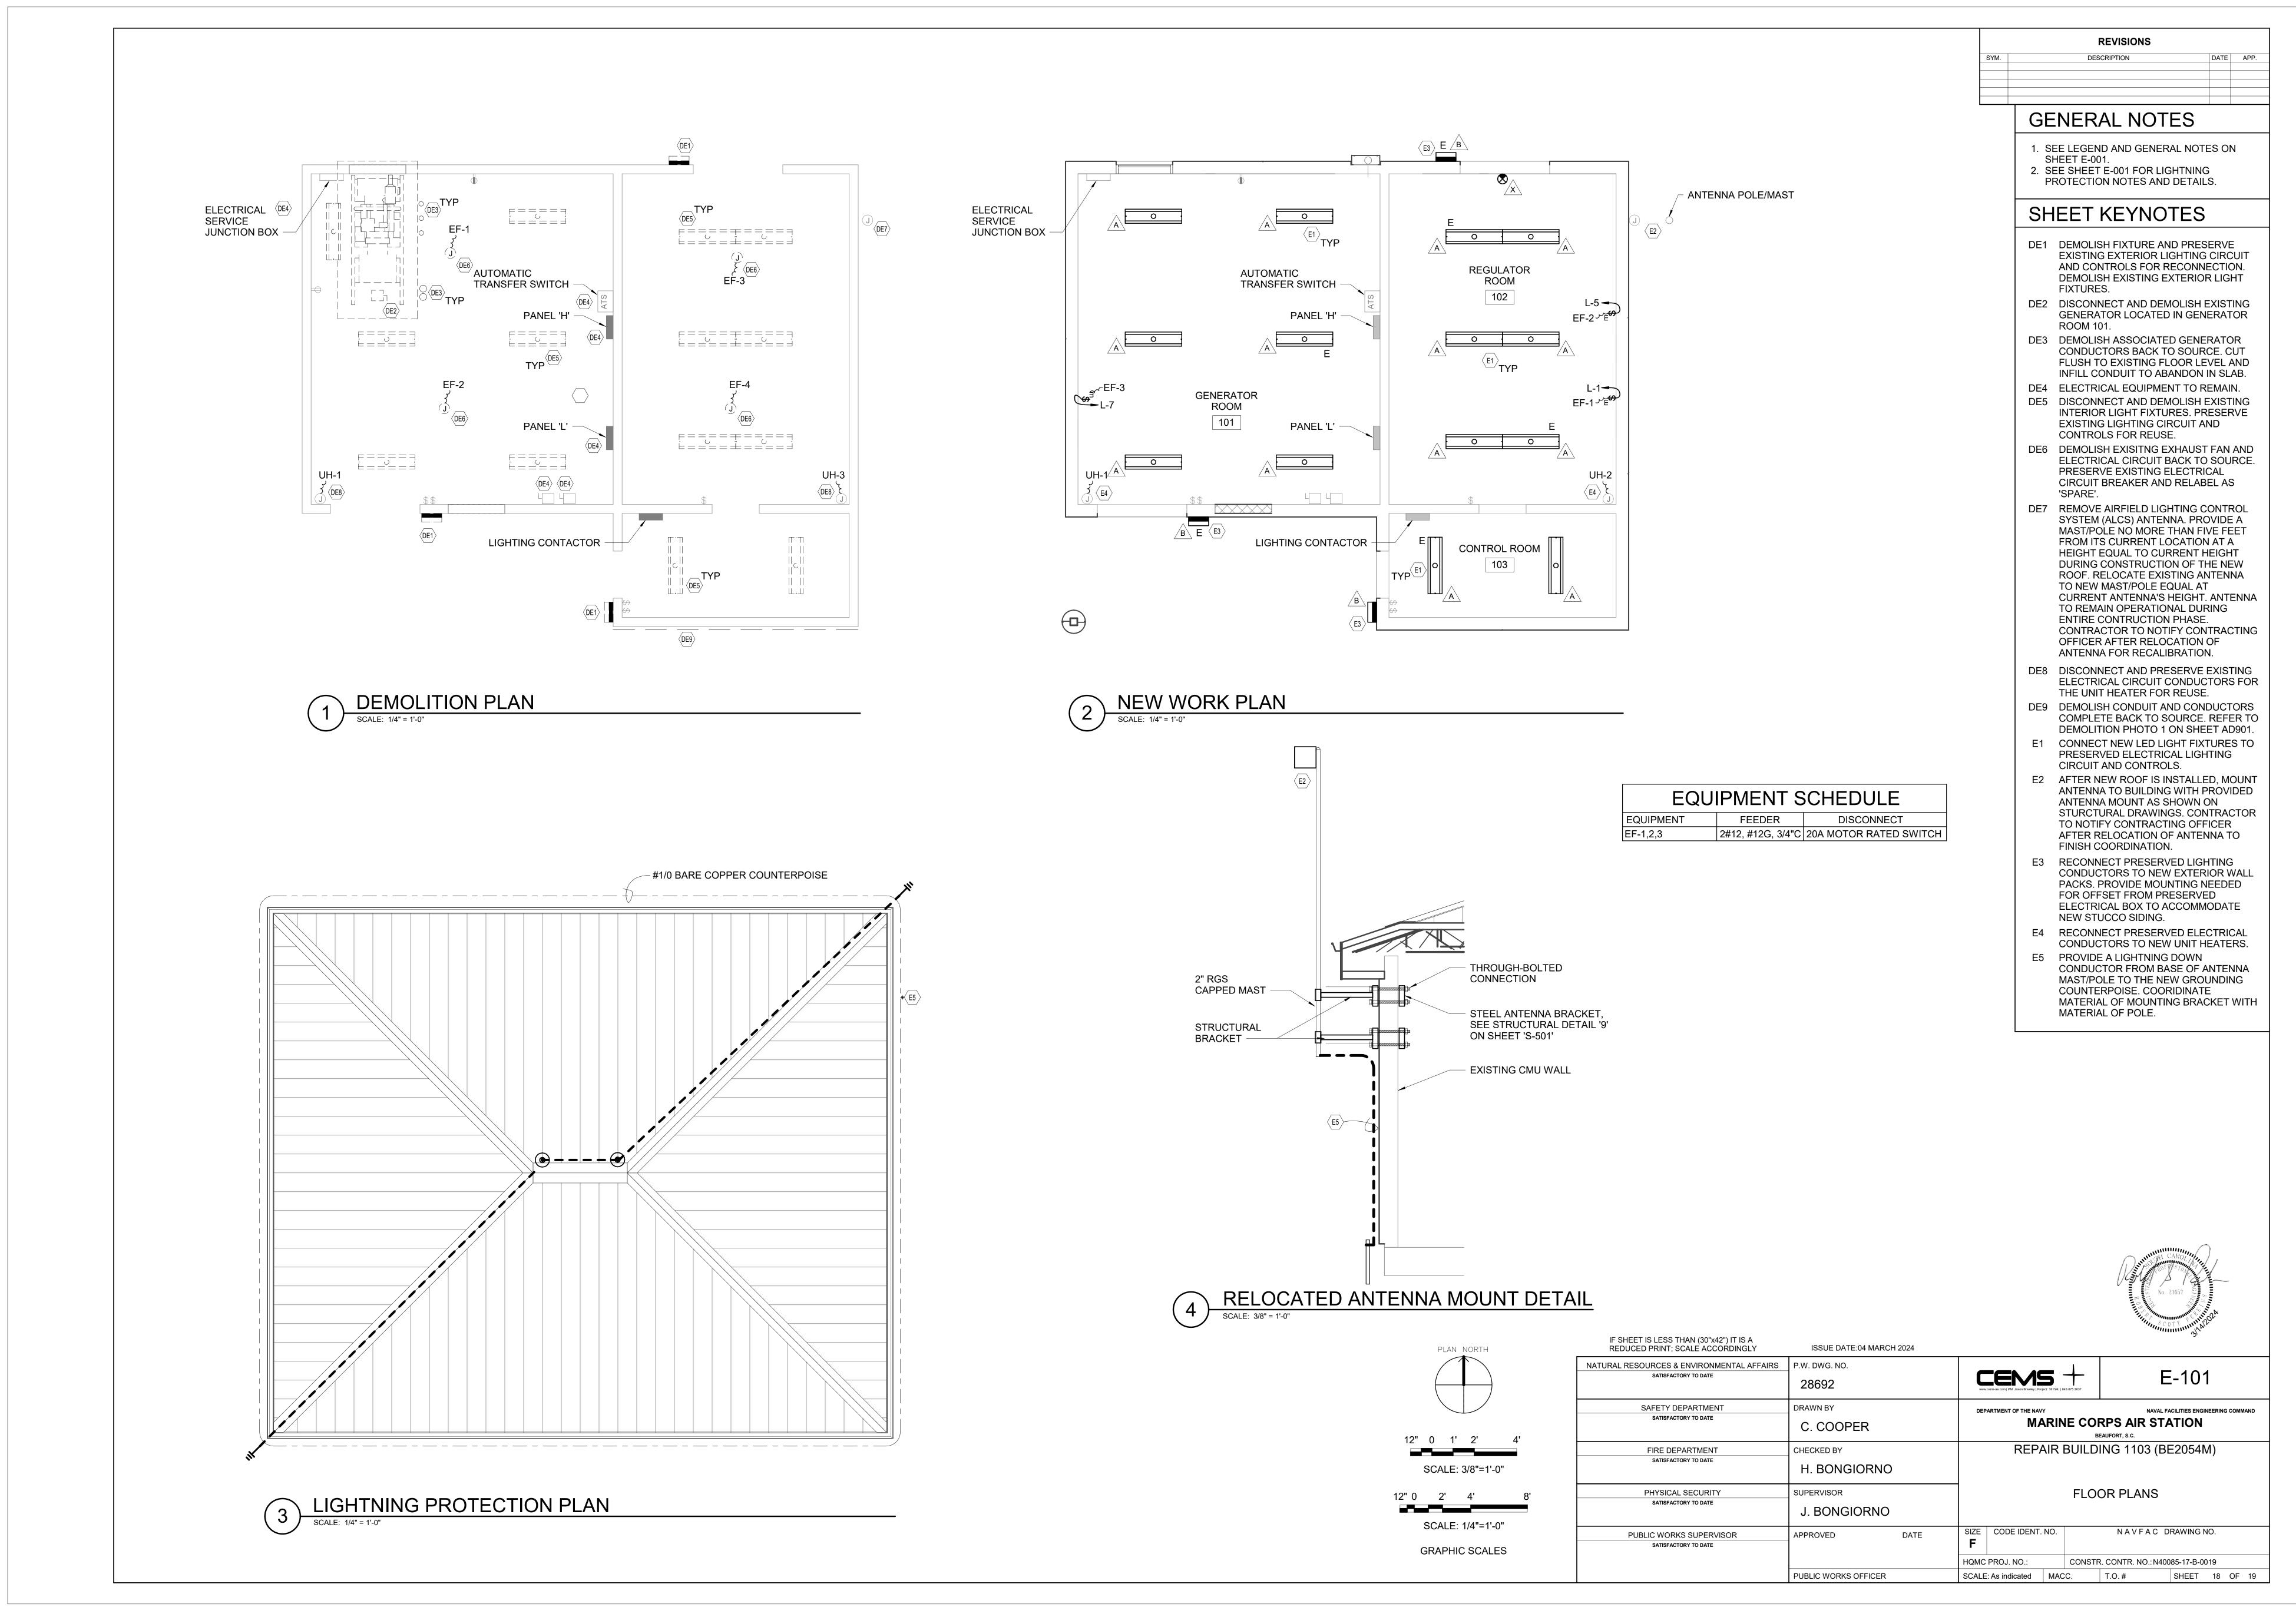
'E' - DENOTES EMERGENCY BATTERY DRIVER FOR 1400 LUMEN OPERATION FOR MINIMUM OF 90 MINUTES



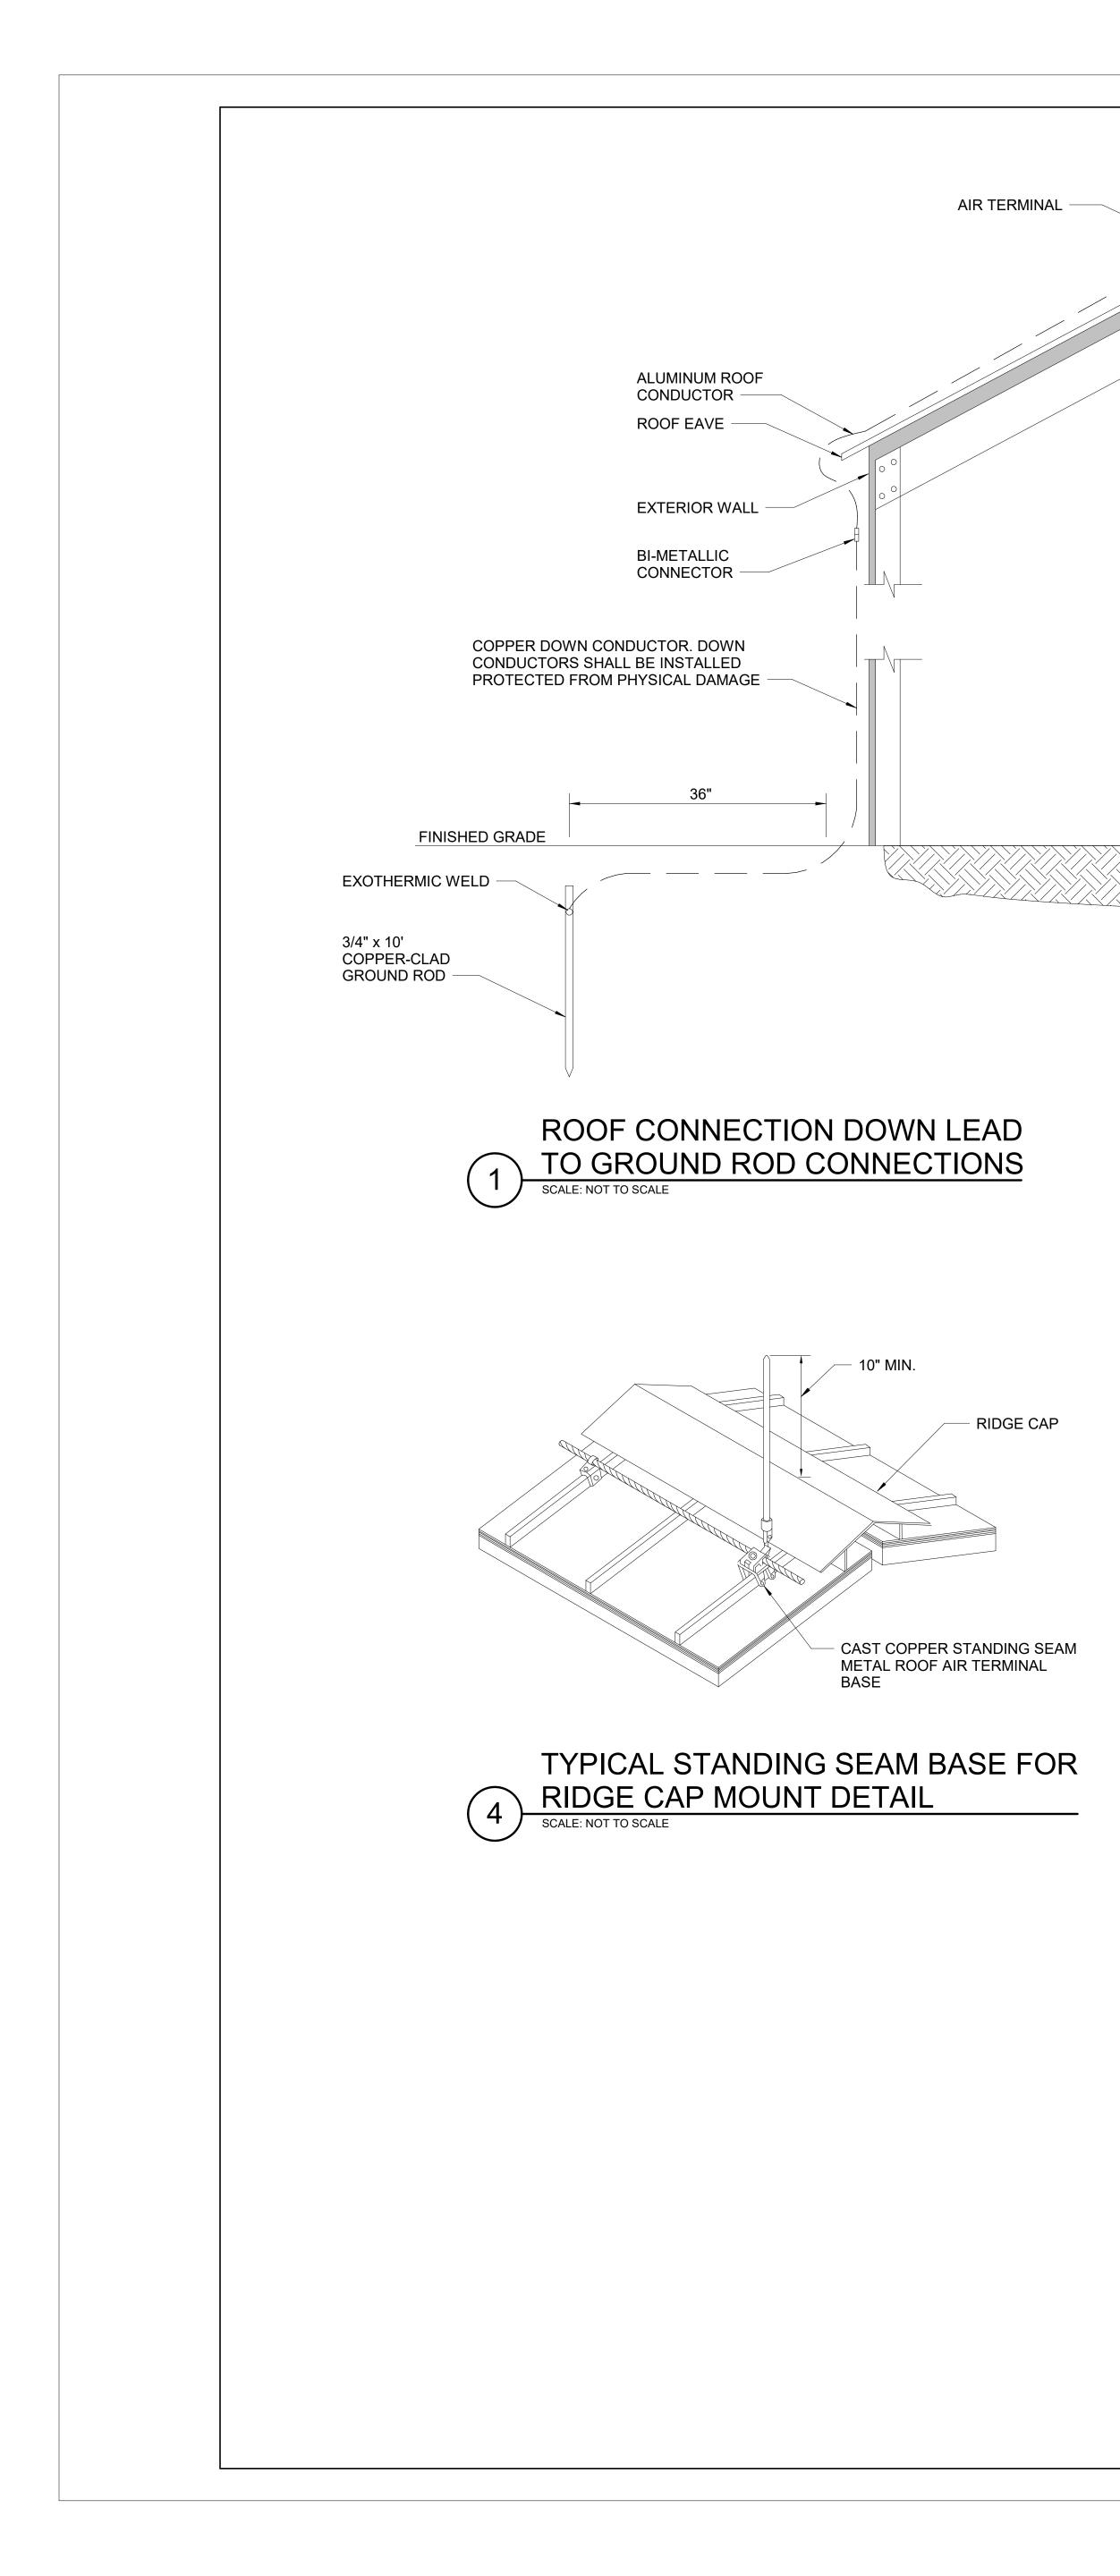
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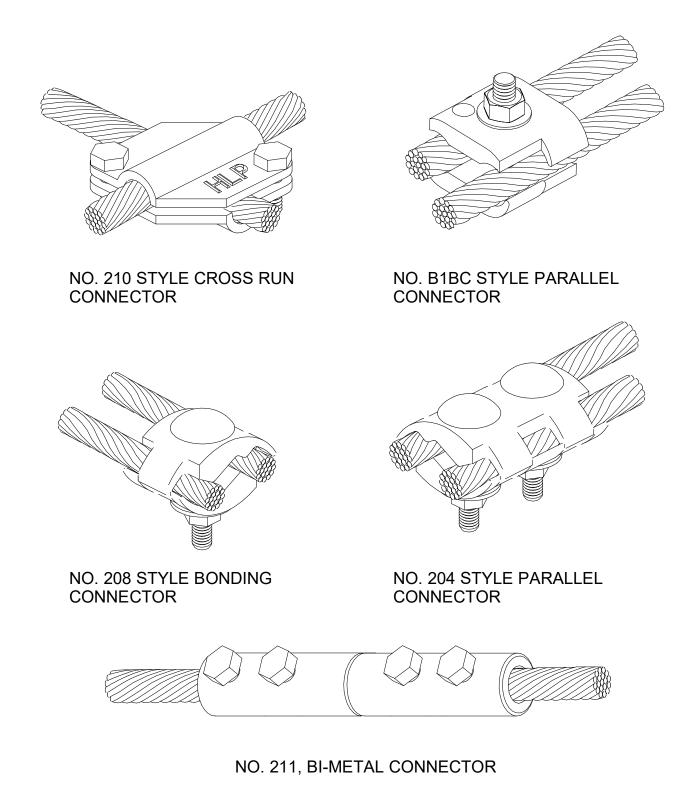
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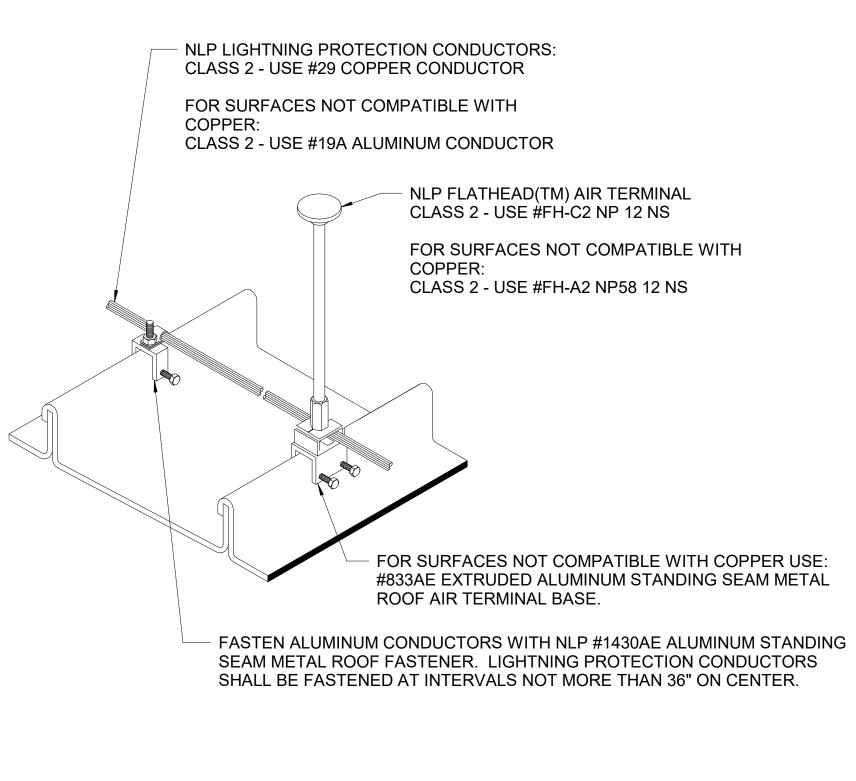


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- NOTES:
- 1. AIR TERMINAL SPACING SHALL CONFORM TO NFPA 780 & UL 96A REQUIREMENTS.
- MATERIAL COMPATIBILITY SHALL CONFORM TO NFPA 780 AND 96A REQUIREMENTS.
 MATERIAL CLSS SHALL CONFORM TO NFPA 780 AND UL 96A REQUIREMENTS.
- 4. AIR TERMINALS SHALL BE UL LISTED AND CAL-OSHA

3 STANDING SEAM ROOF AIR TERMINAL DETAIL

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