

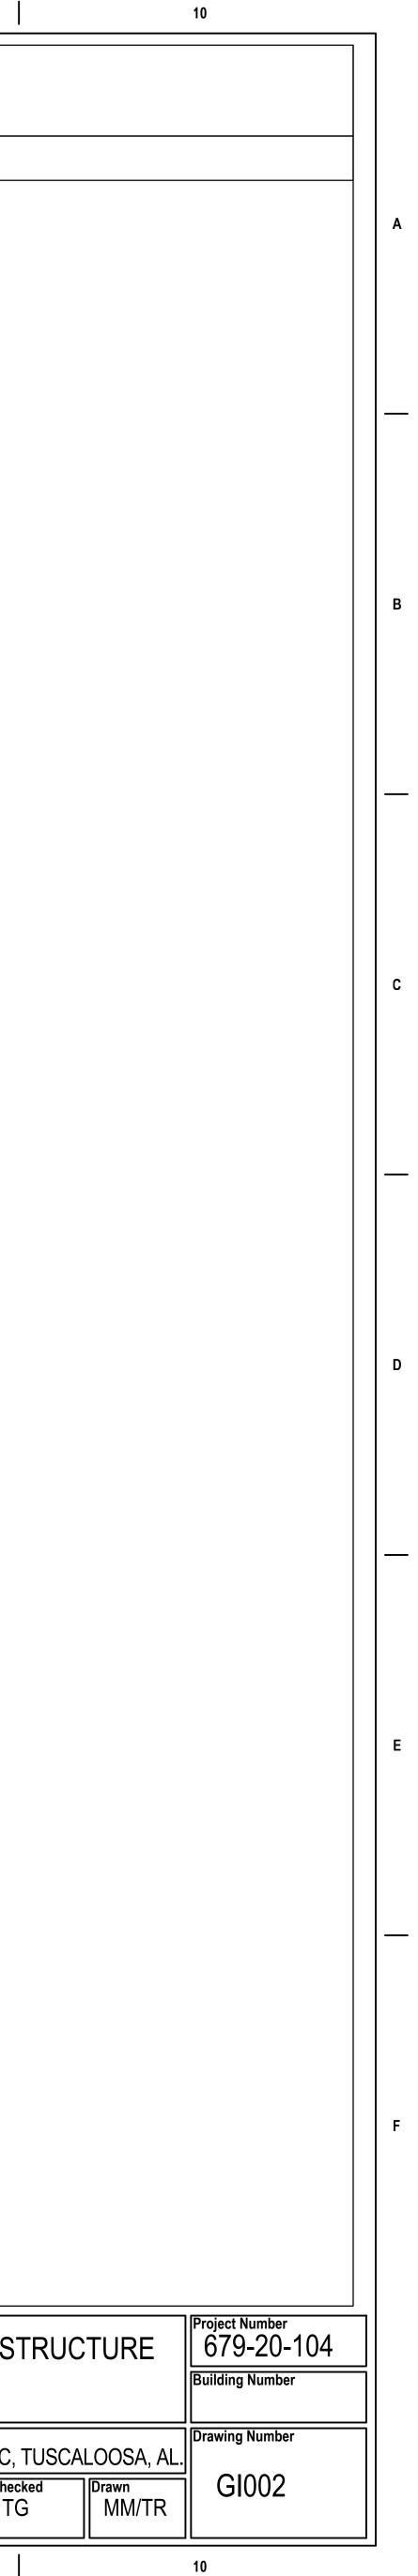
<b>DWG.#</b> GI001 GI002 F-000 F-001.G F-001.G F-001.2 F-001.2 F-001.3 F-001.4 F-002.G F-002.1 F-002.1 F-002.1 F-002.1 F-003.2 F-003.1 F-003.2 F-004.1 F-012.1 F-017.G	DRAWING TITLE <u>GENERAL</u> COVER SHEET SHEET INDEX <u>FIRE PROTECTION</u> FIRE PROTECTION SYMBOLS AND ABBREVIATIONS BUILDING 1 GROUND LEVEL – FIRE PROTECTION BUILDING 1 LEVEL 01 – FIRE PROTECTION BUILDING 1 LEVEL 02 – FIRE PROTECTION BUILDING 1 LEVEL 03 – FIRE PROTECTION BUILDING 1 LEVEL 04 – FIRE PROTECTION BUILDING 2 GROUND LEVEL – FIRE PROTECTION BUILDING 2 LEVEL 01 – FIRE PROTECTION BUILDING 2 LEVEL 02 – FIRE PROTECTION	DWG.#	DRAWING TITLE	DWG.#
GI001 GI002 F-000 F-001.G F-001.1 F-001.2 F-001.3 F-001.4 F-002.G F-002.G F-002.1 F-002.1 F-002.2 F-003.G F-003.1 F-003.2 F-004.1 F-012.1	GENERALCOVER SHEETSHEET INDEXFIRE PROTECTIONFIRE PROTECTION SYMBOLS AND ABBREVIATIONSBUILDING 1 GROUND LEVEL - FIRE PROTECTIONBUILDING 1 LEVEL 01 - FIRE PROTECTIONBUILDING 1 LEVEL 02 - FIRE PROTECTIONBUILDING 1 LEVEL 03 - FIRE PROTECTIONBUILDING 1 LEVEL 04 - FIRE PROTECTIONBUILDING 2 GROUND LEVEL - FIRE PROTECTIONBUILDING 3 LEVEL 04 - FIRE PROTECTIONBUILDING 4 LEVEL 04 - FIRE PROTECTIONBUILDING 5 LEVEL 04 - FIRE PROTECTIONBUILDING 5 LEVEL 01 - FIRE PROTECTIONBUILDING 6 2 LEVEL 01 - FIRE PROTECTION	DWG.#		
GI002 F-000 F-001.G F-001.1 F-001.2 F-001.3 F-001.4 F-002.G F-002.1 F-002.1 F-002.2 F-003.G F-003.1 F-003.2 F-004.1 F-012.1	COVER SHEET SHEET INDEX FIRE PROTECTION FIRE PROTECTION SYMBOLS AND ABBREVIATIONS BUILDING 1 GROUND LEVEL – FIRE PROTECTION BUILDING 1 LEVEL 01 – FIRE PROTECTION BUILDING 1 LEVEL 02 – FIRE PROTECTION BUILDING 1 LEVEL 03 – FIRE PROTECTION BUILDING 1 LEVEL 04 – FIRE PROTECTION BUILDING 2 GROUND LEVEL – FIRE PROTECTION BUILDING 2 LEVEL 01 – FIRE PROTECTION			
GI002 F-000 F-001.G F-001.1 F-001.2 F-001.3 F-001.4 F-002.G F-002.1 F-002.1 F-002.2 F-003.G F-003.1 F-003.2 F-004.1 F-012.1	SHEET INDEX FIRE PROTECTION FIRE PROTECTION SYMBOLS AND ABBREVIATIONS BUILDING 1 GROUND LEVEL – FIRE PROTECTION BUILDING 1 LEVEL 01 – FIRE PROTECTION BUILDING 1 LEVEL 02 – FIRE PROTECTION BUILDING 1 LEVEL 03 – FIRE PROTECTION BUILDING 1 LEVEL 04 – FIRE PROTECTION BUILDING 2 GROUND LEVEL – FIRE PROTECTION BUILDING 2 LEVEL 01 – FIRE PROTECTION			
F-001.G F-001.1 F-001.2 F-001.3 F-001.4 F-002.G F-002.1 F-002.2 F-003.G F-003.1 F-003.2 F-004.1 F-012.1	FIRE PROTECTION SYMBOLS AND ABBREVIATIONS BUILDING 1 GROUND LEVEL – FIRE PROTECTION BUILDING 1 LEVEL 01 – FIRE PROTECTION BUILDING 1 LEVEL 02 – FIRE PROTECTION BUILDING 1 LEVEL 03 – FIRE PROTECTION BUILDING 1 LEVEL 04 – FIRE PROTECTION BUILDING 2 GROUND LEVEL – FIRE PROTECTION BUILDING 2 LEVEL 01 – FIRE PROTECTION			
F-001.1 F-001.2 F-001.3 F-002.G F-002.1 F-002.2 F-003.G F-003.1 F-003.2 F-004.1 F-012.1	BUILDING 1 LEVEL 01 – FIRE PROTECTION BUILDING 1 LEVEL 02 – FIRE PROTECTION BUILDING 1 LEVEL 03 – FIRE PROTECTION BUILDING 1 LEVEL 04 – FIRE PROTECTION BUILDING 2 GROUND LEVEL – FIRE PROTECTION			
F-001.3 F-002.G F-002.1 F-002.2 F-003.G F-003.1 F-003.2 F-004.1 F-012.1	BUILDING 1 LEVEL 03 – FIRE PROTECTION BUILDING 1 LEVEL 04 – FIRE PROTECTION BUILDING 2 GROUND LEVEL – FIRE PROTECTION BUILDING 2 LEVEL 01 – FIRE PROTECTION			
F-001.4 F-002.G F-002.1 F-002.2 F-003.G F-003.1 F-003.2 F-004.1 F-012.1	BUILDING 1 LEVEL 04 – FIRE PROTECTION BUILDING 2 GROUND LEVEL – FIRE PROTECTION BUILDING 2 LEVEL 01 – FIRE PROTECTION			
F-002.1 F-002.2 F-003.G F-003.1 F-003.2 F-004.1 F-012.1	BUILDING 2 LEVEL 01 - FIRE PROTECTION	· · · · · · · · · · · · · · · · · · ·		
F-003.G F-003.1 F-003.2 F-004.1 F-012.1	BOILDING Z LEVEL OZ - TIKE FROTECTION			
F-003.2 F-004.1 F-012.1	BUILDING 3 GROUND LEVEL - FIRE PROTECTION			
F-012.1	BUILDING 3 LEVEL 01 – FIRE PROTECTION BUILDING 3 LEVEL 02 – FIRE PROTECTION			
	BUILDING 4 LEVEL 01 – FIRE PROTECTION BUILDING 12 LEVEL 01 – FIRE PROTECTION			
F-038.G	BUILDING 17 GROUND LEVEL – FIRE PROTECTION BUILDING 38 GROUND LEVEL – FIRE PROTECTION			
F-038.2 F-039.G	BUILDING 38 LEVEL 02 - FIRE PROTECTION BUILDING 39 GROUND LEVEL - FIRE PROTECTION			
F-039.1 F-039.2	BUILDING 39 LEVEL 01 - FIRE PROTECTION BUILDING 39 LEVEL 02 - FIRE PROTECTION			
F—040.B F—040.1	BUILDING 40 BASEMENT LEVEL – FIRE PROTECTION BUILDING 40 LEVEL 01 – FIRE PROTECTION			
F—040.2 F—046.G	BUILDING 40 LEVEL 02 – FIRE PROTECTION BUILDING 46 GROUND LEVEL – FIRE PROTECTION			
F-061.1 F-063.G	BUILDING 61 LEVEL 01 – FIRE PROTECTION BUILDING 63 GROUND LEVEL – FIRE PROTECTION			
F-135.B F-135.G	BUILDING 135 BASEMENT LEVEL – FIRE PROTECTION BUILDING 135 GROUND LEVEL – FIRE PROTECTION			
F-135.1 F-137.1	BUILDING 135 LEVEL 01 - FIRE PROTECTION BUILDING 137 LEVEL 01 - FIRE PROTECTION			
F-137.2 F-137.3	BUILDING 137 LEVEL 02 - FIRE PROTECTION BUILDING 137 LEVEL 03 - FIRE PROTECTION			
F-137.4 F-143.1	BUILDING 137 LEVEL 04 – FIRE PROTECTION BUILDING 143 LEVEL 01 – FIRE PROTECTION			
F-145.B F-145.1	BUILDING 145 BASEMENT LEVEL – FIRE PROTECTION BUILDING 145 LEVEL 01 – FIRE PROTECTION			
F-146.A	BUILDING 146 ATTIC - FIRE PROTECTION			
F-147.A F-149.1	BUILDING 147 ATTIC – FIRE PROTECTION BUILDING 149 LEVEL 01 – FIRE PROTECTION			
F-151.1 F-151.2	FLOOR PLAN – FIRE PROTECTION CLEAN AGENT FLOOR PLAN			
F-151.301	CLEAN AGENT NOTES, TABLE AND RISER DIAGRAM			
	- CONSULTAN	NT	ARCHITECT/ENGINEE	
	- - - Wiley Wilsor	n° SPECIALIZED ENGINEERING SOLUTIONS		
	– Wiley Wilson 127 Nationwide Drive	Specialized Engineering Solutions	BRITT, PETERS Phone: 82	28.315.9962
	Lynchburg, VA 24502	1300 Baxter Street, Suite 355	consulting engineers www.atriaxgroup.com	1629, Hickory, NC 28603       and         228.315.9962       315.9964         eering License No.: P-0214       and

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INDEX OF DRAWINGS

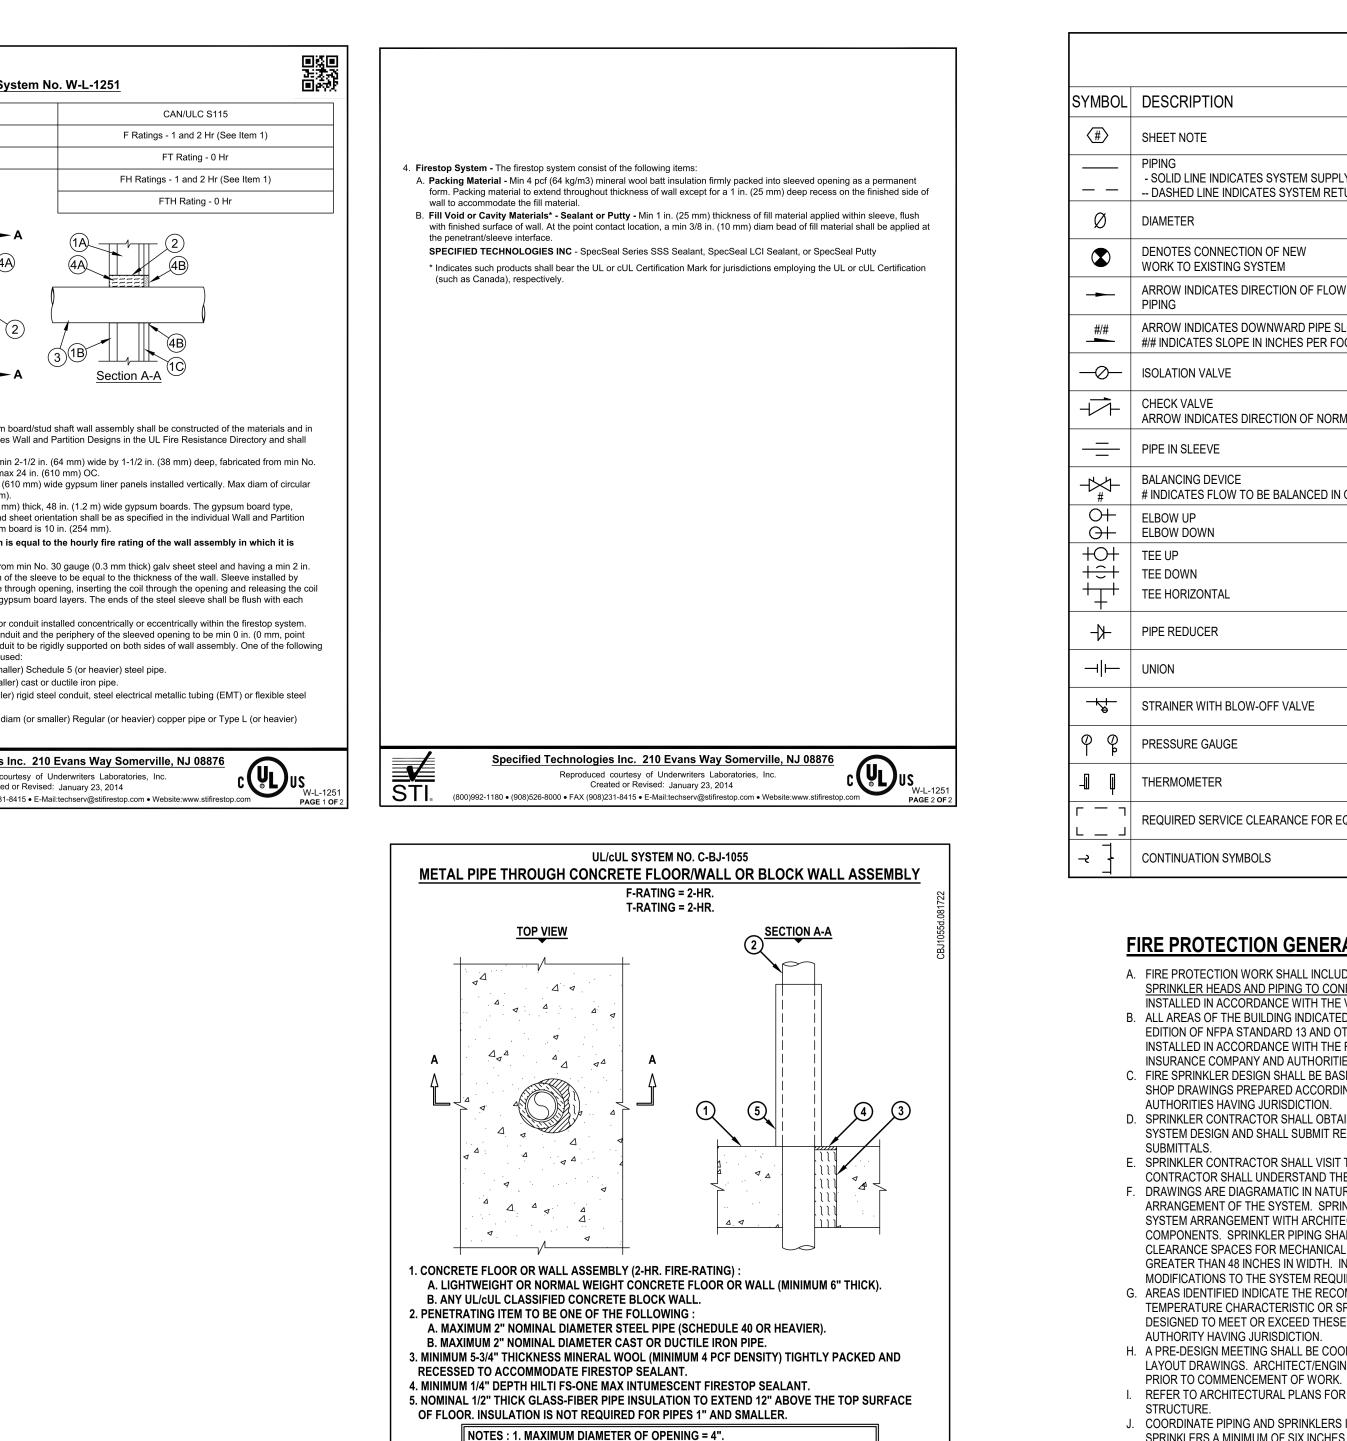
DRAWING TITLE	DWG.#		ORAWING TITLE
fice of INDEX OF DRAWINGS	Phase 100% CONS		EHRM INFRAST
struction FIRE PROTECTION	DOCUMENT	S	UPGRADES
Facilities		<b>.</b>	
agement Approved: Chief Engineer			Location TUSCALOOSA VAMC, TU
S. Department			Issue Date Checked
.S. Department Veterans Affairs			03/08/2024 TG
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			Classified by Underwiters Labo to ANSI/UL 1479	oratories, Inc. 9 (ASTM E814) and CAN/ULC S115 System No. W-L-1257
				ANSI/UL1479 (ASTM E814) F Ratings - 1 and 2 Hr (See Item 1)
				T Rating - 0 Hr
				► A <u>Sec</u>
			the manne	embly - The 1 or 2 hr fire-rated gypsum board/stud shaft wall assen er specified in the individual U400 Series Wall and Partition Design e the following construction features:
			A. Steel S 25 gau B. <b>Gypsu</b>	Studs - "C-H" or "C-T" shaped studs, min 2-1/2 in. (64 mm) wide by ge (0.6 mm thick) galv steel, spaced max 24 in. (610 mm) OC. Im Board* - 1 in. (25 mm) thick, 24 in. (610 mm) wide gypsum line in gypsum liner panel is 10 in. (254 mm).
			C. <b>Gypsu</b> thickne Design	<b>m Board*</b> - 1/2 in. or 5/8 in. (13 or 16 mm) thick, 48 in. (1.2 m) wid ess, number of layers, fastener type and sheet orientation shall be n. Max diam of circular cutout in gypsum board is 10 in. (254 mm). Dourly F Rating of the firestop system is equal to the hourly fire
			installo 2. Metallic S (51 mm) la	ed. Sleeve - Cylindrical sleeve fabricated from min No. 30 gauge (0.3 m ap along the longitudinal seam. Length of the sleeve to be equal to
			to let it un surface of 3. <b>Through</b>	Penetrant One metallic pipe, tube or conduit installed concentri
			contact) to types and	ar space between the pipe, tube or conduit and the periphery of the para 2 in. (51 mm). Pipe, tube or conduit to be rigidly supported o sizes of pipe, tube or conduit may be used: Pipe - Nom 8 in. (203 mm) diam (or smaller) Schedule 5 (or heavie
			B. Iron Pi C. Condu condui	<ul> <li>ipe - Nom 8 in. (203 mm) diam (or smaller) cast or ductile iron pipe</li> <li>iit - Nom 4 in. (102 mm) diam (or smaller) rigid steel conduit, steel</li> <li>t.</li> </ul>
			copper	r Pipe or Tube - Nom 4 in. (102 mm) diam (or smaller) Regular (o tube. Specified Technologies Inc. 210 Evans Way
			STI. «	Specified Technologies Inc. 210 Evans Way Reproduced courtesy of Underwriters Labo Created or Revised: January 23, 20 800)992-1180 • (908)526-8000 • FAX (908)231-8415 • E-Mail:techserv@stifires
			CONSULTANT	
				Specialized
			Wiley Wilson*	SOLUTIONS
		<b> </b>	Wiley Wilson	Specialized Engineering Solutions
			127 Nationwide Drive	1300 Baxter Street, Suite 355
ions:		Date:	127 Nationwide Drive Lynchburg, VA 24502 Phone: 434.947.1901 www.wileywilson.com	1300 Baxter Street, Suite 355 Charlotte, NC 28204



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	3. MINIMUM 1/4" DEPTH HILTI FS-ONE MAX INTUMESCENT FIRESTOP SEALANT AND 1/2" THICK GLASS-FIBER PIPE INSULATION ARE REQUIRED ON BOTH SIDES OF A WALL ASSEMBLY.				
			Sheet	1 of 1	Drawing No.
		HILTI, Inc. Plano, Texas USA (800) 879-8000	Scale	3/16" = 1"	CBJ
Hilti Fire	stop Systems		Date	Aug. 17, 2022	1055d

2. ANNULAR SPACE = MINIMUM 0", MAXIMUM 1-5/8".

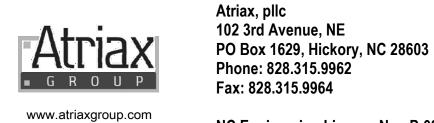
stop Systems	Plano, Texas USA (800) 879-8000	Date	Aug. 17, 2
	es through Innovation and Educ	ation	Aug. 11,1

PANELS

ARCHITECT/ENGINEER OF RECORD	STAMP
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Phone: 828.315.9962

Fax: 828.315.9964



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NC Engineering License No.: P-0214 NC Architectural License No.: 51254

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GENE	RAL SYMBOLS
ON	ADDITIONAL REMARKS
	DENOTES SPECIFIC REQUIREMENT FOR THE SHEET ON WHICH THE NOTE APPEARS AND IS USED TO DESCRIBE WORK THAT IS TOO LENGTHY TO PLACE ON PLAN.
NDICATES SYSTEM SUPPLY E INDICATES SYSTEM RETURN	NUMBER INDICATES NOMINAL DIAMETER IN INCHES, LETTER(S) INDICATES SYSTEM. REFER TO ABBREVIATIONS FOR SYSTEM TYPE.
NECTION OF NEW TING SYSTEM	PROTECT EXISTING SYSTEM FROM ENTRANCE OF FOREIGN DEBRIS DURING WORK
TES DIRECTION OF FLOW IN	
ATES DOWNWARD PIPE SLOPE SLOPE IN INCHES PER FOOT	WHERE PIPING IS NOT MARKED, REFER TO SPECIFICATIONS FOR REQUIREMENTS
VE	REFER TO SPECIFICATIONS FOR TYPE BASED ON SIZE AND SYSTEM
TES DIRECTION OF NORMAL FLOW	REFER TO SPECIFICATIONS FOR TYPE BASED ON SIZE AND SYSTEM
E	REFER TO SPECIFICATIONS FOR TYPE BASED ON SIZE AND SYSTEM
EVICE LOW TO BE BALANCED IN GPM	CIRCUIT SETTER, AUTOFLOW, ETC. REFER TO SPECIFICATIONS FOR TYPE BASED ON SIZE AND SYSTEM
AL	
2	INDICATES POINT WHERE PIPING CHANGES FROM ONE SIZE TO ANOTHER. SMALL POINT OF ARROW INDICATES SMALLER SIZE SIDE OF TRANSITION.
H BLOW-OFF VALVE	REFER TO SPECIFICATIONS FOR TYPE AND ACCESSORIES
UGE	REFER TO SPECIFICATIONS FOR TYPE AND ACCESSORIES
R	REFER TO SPECIFICATIONS FOR TYPE AND ACCESSORIES
RVICE CLEARANCE FOR EQUIPMENT	
N SYMBOLS	FIRST SYMBOL APPLIES TO ROUND DUCT AND PIPING.

SECOND SYMBOL APPLIES TO RECTANGULAR AND OVAL DUCT.

# FIRE PROTECTION GENERAL NOTES:

A. FIRE PROTECTION WORK SHALL INCLUDE, BUT NOT LIMITED TO, THE FOLLOWING: INSTALLATION OF NEW SPRINKLER HEADS AND PIPING TO CONFORM TO NFPA 13 AND LOCAL CODES. ENTIRE SYSTEM SHALL BE INSTALLED IN ACCORDANCE WITH THE VA. B. ALL AREAS OF THE BUILDING INDICATED SHALL BE SPRINKLERED ACCORDING TO THE CURRENTLY ADOPTED EDITION OF NFPA STANDARD 13 AND OTHER NFPA STANDARDS AS REQUIRED. ENTIRE SYSTEM SHALL BE INSTALLED IN ACCORDANCE WITH THE REQUIREMENTS OF THE STATE FIRE MARSHAL OFFICE, OWNER'S INSURANCE COMPANY AND AUTHORITIES HAVING JURISDICTION. C. FIRE SPRINKLER DESIGN SHALL BE BASED ON HYDRAULIC CALCULATIONS ACCORDING TO NFPA 13, WITH SHOP DRAWINGS PREPARED ACCORDING TO THE REQUIREMENTS OF THE STATE FIRE MARSHAL AND AUTHORITIES HAVING JURISDICTION. D. SPRINKLER CONTRACTOR SHALL OBTAIN STATIC AND RESIDUAL WATER PRESSURE AND FLOW PRIOR TO SYSTEM DESIGN AND SHALL SUBMIT RECENT HYDRANT FLOW TEST DATA WITH SHOP DRAWING E. SPRINKLER CONTRACTOR SHALL VISIT THE SITE PRIOR TO PRICING SCOPE OF WORK. SPRINKLER

CONTRACTOR SHALL UNDERSTAND THE SCOPE OF NEW WORK THEY SHOULD PRICE AND PERFORM. F. DRAWINGS ARE DIAGRAMATIC IN NATURE, INTENDED TO CONVEY THE SCOPE OF WORK AND GENERAL ARRANGEMENT OF THE SYSTEM. SPRINKLER SYSTEM INSTALLING CONTRACTOR SHALL COORDINATE SYSTEM ARRANGEMENT WITH ARCHITECTURAL, STRUCTURAL, MECHANICAL AND ELECTRICAL COMPONENTS. SPRINKLER PIPING SHALL NOT BE INSTALLED BELOW MECHANICAL EQUIPMENT OR WITHIN CLEARANCE SPACES FOR MECHANICAL EQUIPMENT. PROVIDE SPRINKLER PROTECTION BELOW ALL DUCTS GREATER THAN 48 INCHES IN WIDTH. INSTALLING CONTRACTOR SHALL BE RESPONSIBLE FOR ANY MODIFICATIONS TO THE SYSTEM REQUIRED TO AVOID CONFLICTS. G. AREAS IDENTIFIED INDICATE THE RECOMMENDED MINIMUM OCCUPANCY CLASSIFICATION, SPRINKLER TEMPERATURE CHARACTERISTIC OR SPRINKLER TYPES TO BE INSTALLED. SPRINKLER SYSTEM SHALL BE DESIGNED TO MEET OR EXCEED THESE RECOMMENDATIONS AND SHALL BE SUBJECT TO APPROVAL BY THE AUTHORITY HAVING JURISDICTION. H. A PRE-DESIGN MEETING SHALL BE COORDINATED WITH THE ARCHITECT PRIOR TO SUBMITTAL OF PIPING LAYOUT DRAWINGS. ARCHITECT/ENGINEER SHALL ISSUE COMMENTS CONCERNING SUBMITTAL PACKAGE

I. REFER TO ARCHITECTURAL PLANS FOR SPECIFIC CEILING TYPES AND HEIGHTS, AND AREAS OF EXPOSED J. COORDINATE PIPING AND SPRINKLERS IN EXPOSED AREAS TO MINIMIZE APPEARANCE. INSTALL SPRINKLERS A MINIMUM OF SIX INCHES FROM DIFFUSERS, GRILLES AND LIGHT FIXTURES. INSTALL SPRINKLERS IN LAY-IN CEILINGS WITHIN THREE INCHES OF THE CENTER OF CEILING TILE. K. COORDINATE INSTALLATION OF SPRINKLERS AND PIPING SYSTEMS TO AVOID FREEZING CONDITIONS. NOTIFY ARCHITECT OF AREAS WHERE SYSTEM MAY BE EXPOSED TO FREEZING. INSTALL DRY SIDEWALL SPRINKLERS IN ROOMS INDICATED WHERE ROOMS MAY BE UNCONDITIONED OR EXPOSED TO FREEZING CONDITIONS. PROVIDE AUXILIARY DRAINS WHERE REQUIRED. L. EXPOSED SPRINKLER PIPING, EXCEPT IN MECHANICAL AND STORAGE ROOMS, SHALL BE CLEANED, PRIMED AND PAINTED PER FACILITY STANDARDS. M. WHERE SPRINKLER PIPING SYSTEM PENETRATES FIRE RESISTIVE RATED ASSEMBLIES, SEAL OPENINGS WITH APPROVED CONSTRUCTION METHODS AND MATERIALS. N. AVOID ROUTING SPRINKLER PIPING MAINS ABOVE ELECTRICAL, DATA, IT ROOMS AND COMMUNICATION

O. COVER SHEET GENERAL NOTES APPLY TO ALL SHEETS. P. THE OWNER AND ENGINEER ARE NOT RESPONSIBLE FOR THE CONTRACTOR'S SAFETY PRECAUTIONS OR FOR THE MEANS, METHODS, TECHNIQUES, CONSTRUCTION SEQUENCES, OR PROCEDURES REQUIRED TO PERFORM THIS WORK.

Q. SPRINKLER CONTRACTOR SHALL VERIFY FM GLOBAL REQUIREMENTS PRIOR TO DESIGN OF THE SPRINKLER SYSTEM AND COMPONENTS. R. ALL NEW SPRINKLER HEADS SHALL BE QUICK RESPONSE TYPE HEADS. S. SPRINKLER SYSTEM IS A WET PIPE SYSTEM UNLESS NOTED OTHERWISE.

T. ALL CLEAN AGENT SYSTEM INSTALLATIONS SHALL MEET VA STANDARDS AND NFPA 75.

	FIRE PROTECTION ABBREVIATIO				
	NOT ALL ABBREVIATIONS APPL	Y TO THIS SET OF DOCUMENTS			
ABBREVIATION	DESCRIPTION	ABBREVIATION	DES		
BFP DP	BACK FLOW PREVENTER DRY PIPE FIRE PROTECTION	FPTH FS	FIRE F		
F	FIRE PROTECTION	PIV	POST		
FDC	FIRE DEPARTMENT CONNECTION	SPR	SPRIN		
FDV	FIRE DEPARTMENT VALVE				

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GENERAL ABBREVIATIONS						
NOT ALL ABBREVIATIONS APPLY TO THIS SET OF DOCUMENTS						
ABBREVIATION	DESCRIPTION	ABBREVIATION	DESCRIPTION			
AD	ACCESS DOOR/PANEL	MAX	MAXIMUM			
AFF	ABOVE FINISHED FLOOR	MC	MECHANICAL CONTRACTOR			
AMB	AMBIENT	MFR	MANUFACTURER			
BOB	BOTTOM OF BEAM	MIN	MINIMUM			
DIA	DIAMETER	NIC	NOT IN CONTRACT			
DN	DOWN	NTS	NOT TO SCALE			
E	EXISTING	PC	PLUMBING CONTRACTOR			
EC	ELECTRICAL CONTRACTOR	PSIG	POUNDS PER SQUARE INCH GAL			
EFF	EFFICIENCY	RPM	<b>REVOLUTIONS PER MINUTE</b>			
FPM	FEET PER MINUTE	SHT	SHEET			
FPS	FEET PER SECOND	TOB	TOP OF BEAM			
GC	GENERAL CONTRACTOR	TOS	TOP OF STEEL			
GPM	GALLONS PER MINUTE	VEL	VELOCITY			
L	LENGTH	VFD	VARIABLE FREQUENCY DRIVE			
LF	LINEAR FEET					

	TECTION SYMBOLS	
SYMBOL	DESCRIPTION	ADDITIONAL REMARKS
- <del>\</del>	FLOW SWITCH	COORDINATE INTERFACE WITH FIRE A
— F —	FIRE PIPE	
_ <del></del> ₽	FIRE DEPARTMENT CONNECTION	MOUNT BETWEEN 18" AND 48" ABOVE
	O.S. & Y. VALVE	
	SHUT-OFF VALVE WITH TAMPER SWITCH	
	SPRINKLER EXISTING SPRINKLER EXISTING SPRINKLER TO BE REMOVED	REFER TO SPECIFICATIONS FOR TYPE PENDANT REFERS TO FULL, SEMI-REC FOR EACH ARE INDICATED IN THE SPE
$\bigtriangledown$	SIDEWALL SPRINKLER EXISTING SIDEWALL SPRINKLER	-

SPRINKLER FLOW DENSITIES				
HAZARD	AREA (SF)	GPM/SF		
LIGHT HAZARD	1500	0.10		
ORDINARY HAZARD I	1500	0.15		
ORDINARY HAZARD II	1500	0.20		

	SPRINKLER HAZ
•	GHT HAZARD: PATIENT ROOMS CORRIDORS OFFICES CHAPELS DINING AREAS
0.	SOILED UTILITY ROOMS CLEAN UTILITY ROOMS
0 •	RDINARY HAZARD, GROUP 2: STORAGE ROOMS (CEILING HE SOILED LINEN ROOMS
	MEETING THE CRITERIA FOR QU RDINARY, GROUP 1 HAZARD.

of ction lities	Drawing Title FIRE PROTECTION SYMBOLS AND ABBREVIATIONS		Phase 100% CONSTRUCTION DOCUMENTS		Project Title EHRM INFRASTRUCTURE	
ment	Approved:				Location TUSCALOOSA VAMC	, TUSC
epartment rans Affairs			FULLY SPRINK	LERED	Issue Date 03/08/2024	Checked JKK
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### ONS

### SCRIPTION

E PUMP TEST HEADER OW SWITCH ST INDICATOR VALVE RINKLER

# SCRIPTION

XIMUM ECHANICAL CONTRACTOR ANUFACTURER INIMUM OT IN CONTRACT OT TO SCALE UMBING CONTRACTOR OUNDS PER SQUARE INCH GAUGE EVOLUTIONS PER MINUTE HEET OP OF BEAM OP OF STEEL ELOCITY

E ALARM SYSTEM CONTRACTOR

/E FINISHED GRADE

YPES AND FINISHES. ECESSED AND RECESSED TYPES. LOCATIONS PECIFICATIONS OR ON THE PLANS.

ZARD CLASSIFICATION

IEIGHT 8 FEET OR LESS) 1

ASSIFICATION WILL DEPEND ON THE AMOUNTS STIBLE LIQUIDS USED AND STORED IN THE

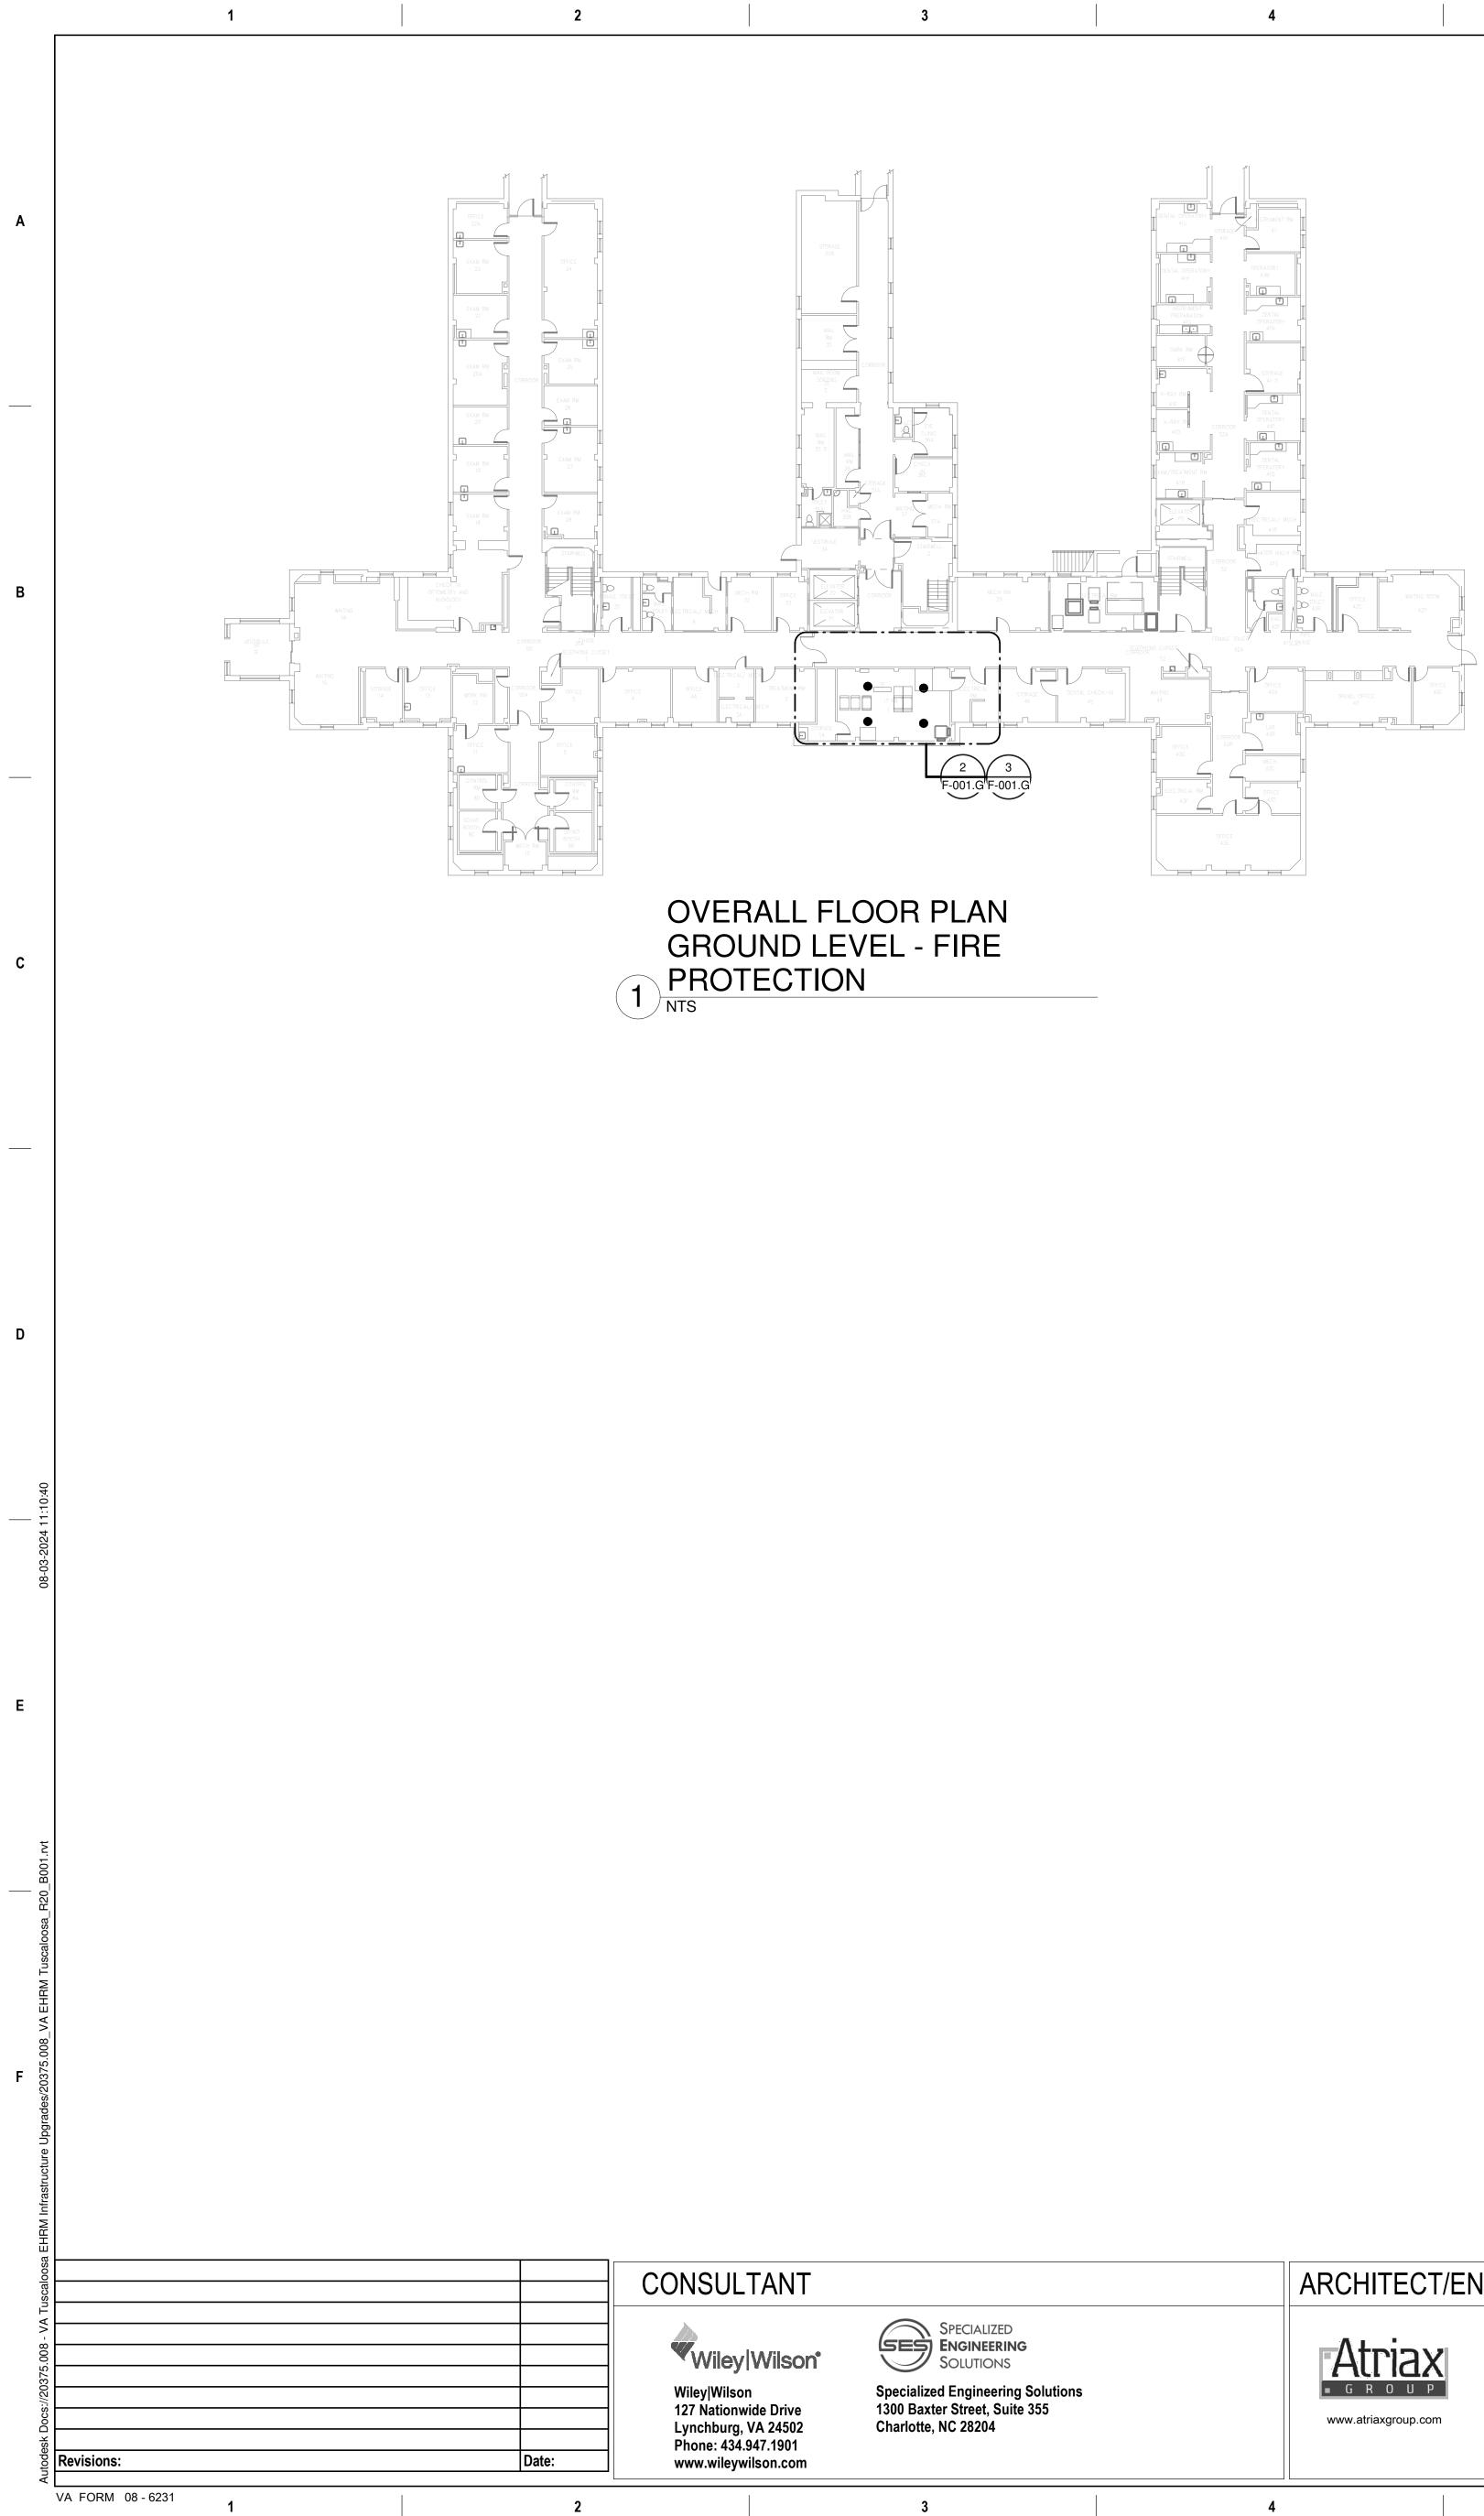
IEIGHT 12 FEET OR LESS) 1

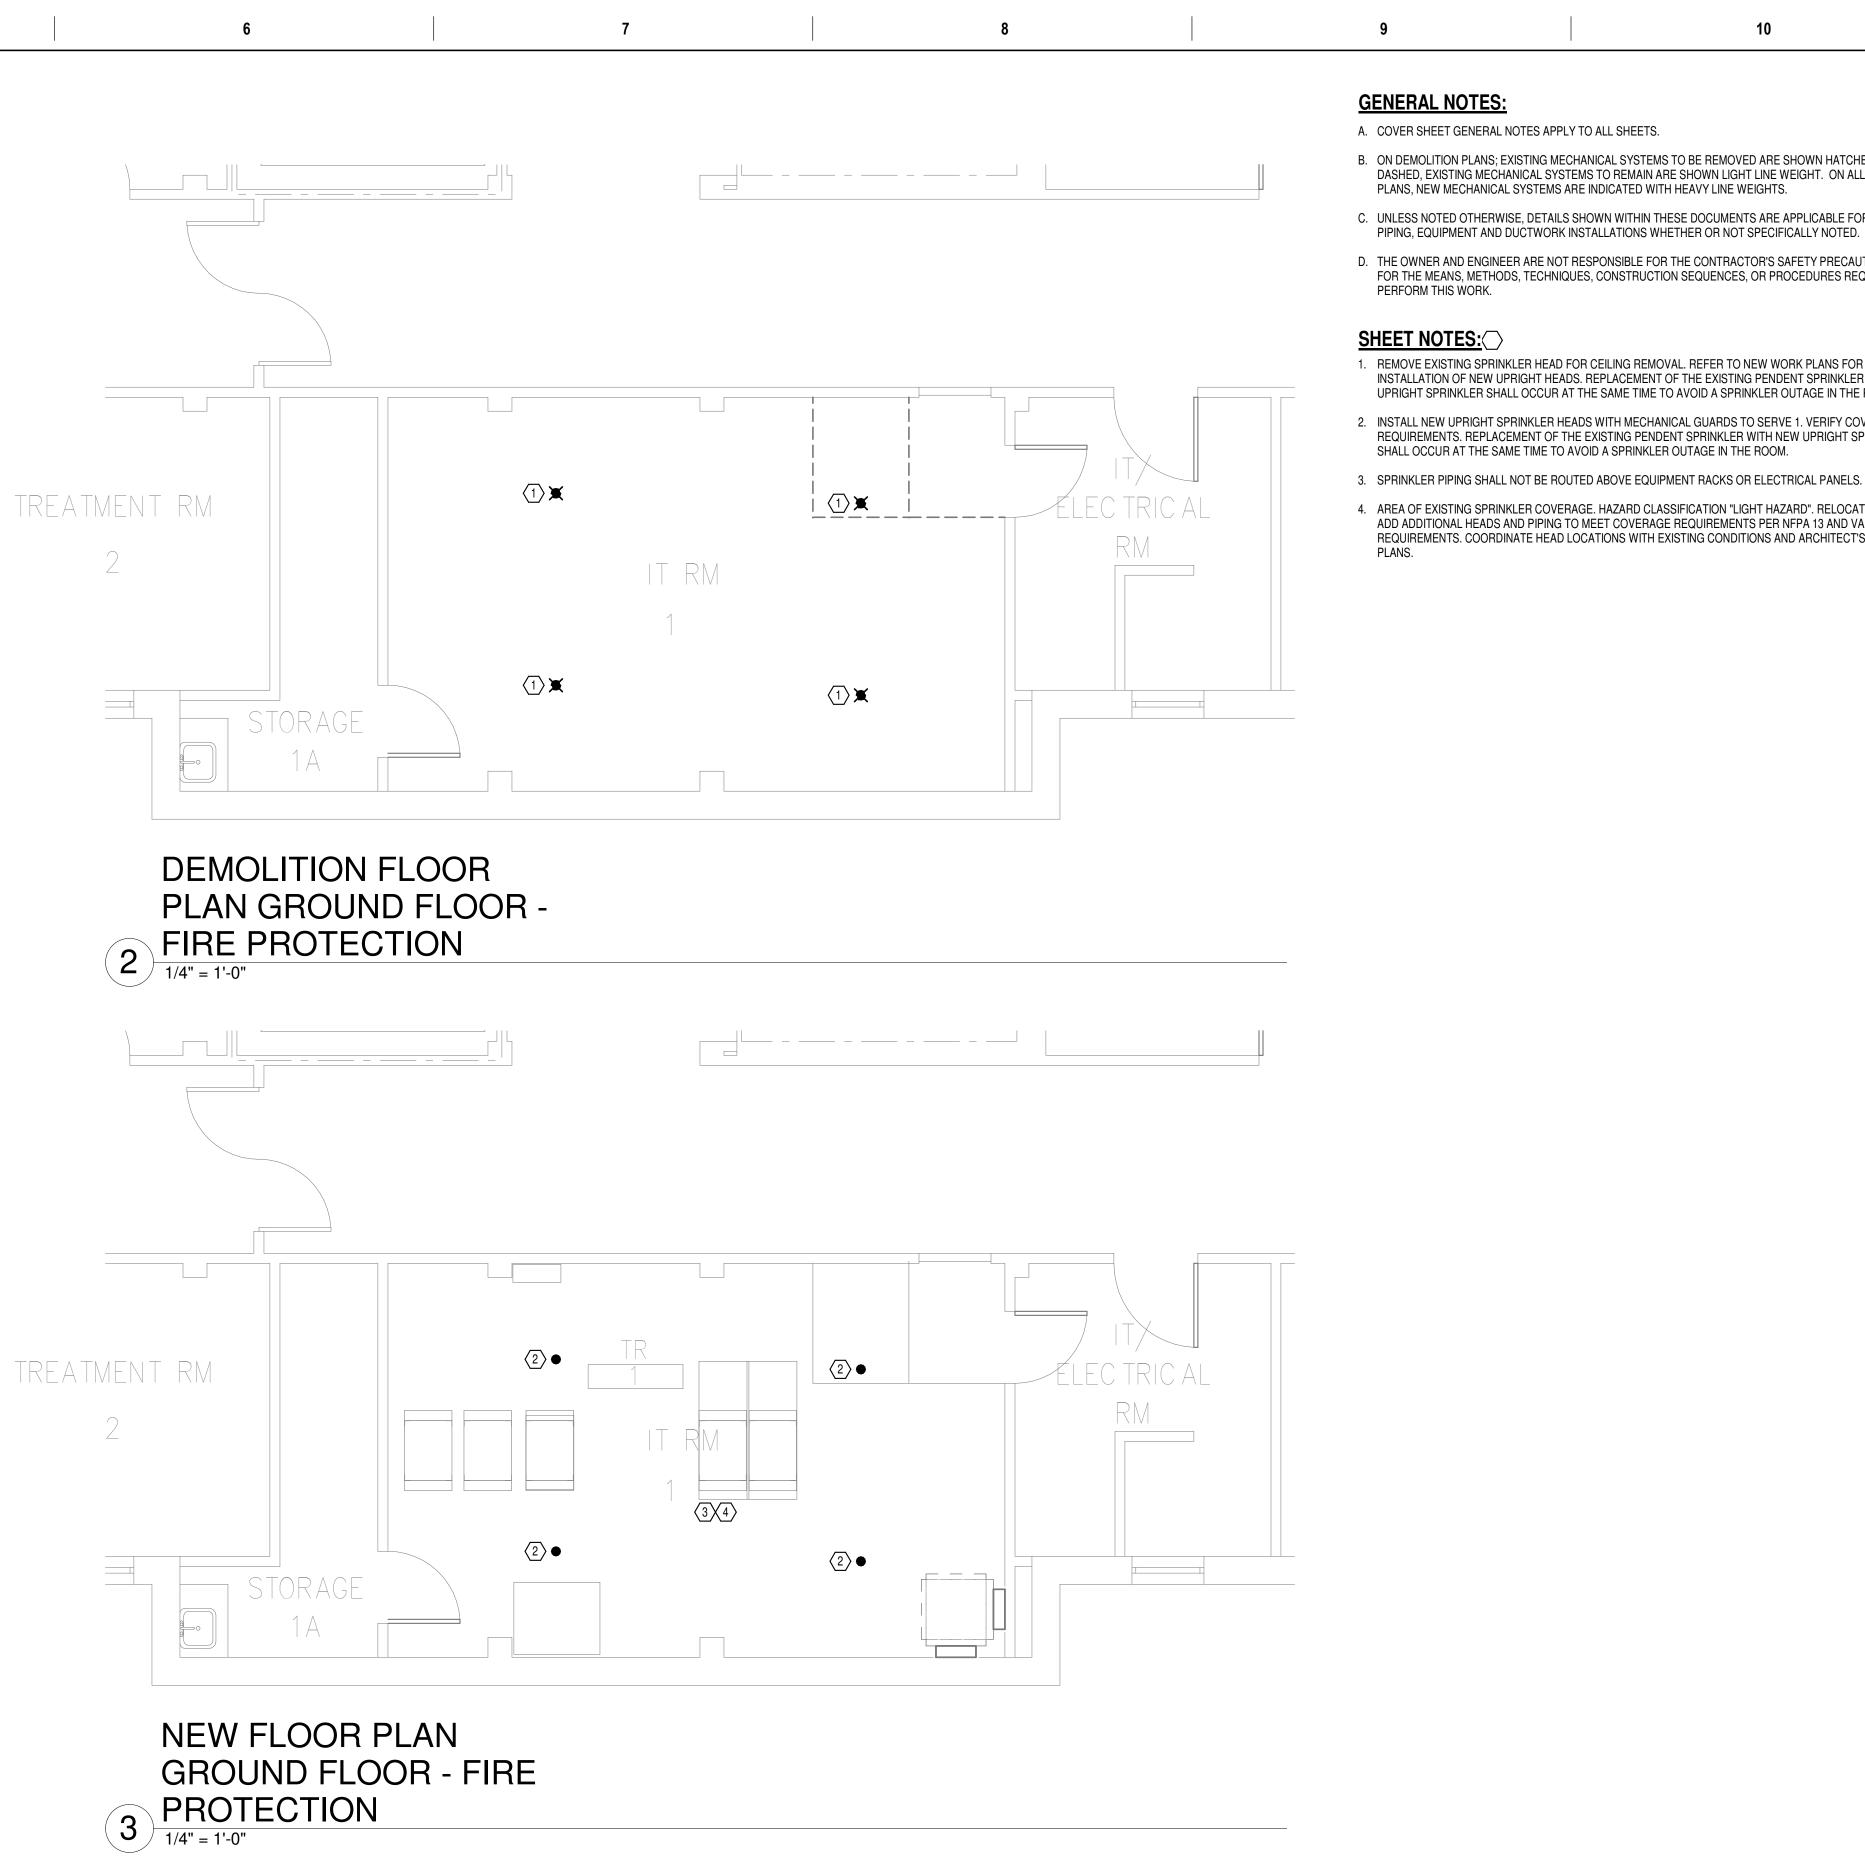
UANTITY/COMBUSTIBILITY OF CONTENTS FOR AN

	Project Number
E UPGRADES	679-20-104
	Building Number

aloosa, al.		
d Drawn		
	PCM	

Drawing Number





# ARCHITECT/ENGINEER OF RECORD STAMP

Atriax, pllc 102 3rd Avenue, NE PO Box 1629, Hickory, NC 28603 Phone: 828.315.9962 Fax: 828.315.9964

NC Engineering License No.: P-0214 NC Architectural License No.: 51254

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TH CARO A FESSIO SEAL 045127 03/08/2024 CAC G. SHERMAN



VA U.S. Depa of Veterar

				PLAN
of ction lities	Drawing Title BUILDING 1 GROUND LEVEL - FIRE PROTECTION	Phase 100% CONSTRUCTION DOCUMENTS	Project Title EHRM INFRASTF	RUCTURE U
ment	Approved:		Location TUSCALOOSA VAI	MC, TUSCAI
epartment erans Affairs		FULLY SPRINKLERED	Issue Date 03/08/2024	Checked JKK
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B. ON DEMOLITION PLANS; EXISTING MECHANICAL SYSTEMS TO BE REMOVED ARE SHOWN HATCHED AND/OR DASHED, EXISTING MECHANICAL SYSTEMS TO REMAIN ARE SHOWN LIGHT LINE WEIGHT. ON ALL OTHER C. UNLESS NOTED OTHERWISE, DETAILS SHOWN WITHIN THESE DOCUMENTS ARE APPLICABLE FOR ALL PIPING, EQUIPMENT AND DUCTWORK INSTALLATIONS WHETHER OR NOT SPECIFICALLY NOTED. D. THE OWNER AND ENGINEER ARE NOT RESPONSIBLE FOR THE CONTRACTOR'S SAFETY PRECAUTIONS OR FOR THE MEANS, METHODS, TECHNIQUES, CONSTRUCTION SEQUENCES, OR PROCEDURES REQUIRED TO

1. REMOVE EXISTING SPRINKLER HEAD FOR CEILING REMOVAL. REFER TO NEW WORK PLANS FOR INSTALLATION OF NEW UPRIGHT HEADS. REPLACEMENT OF THE EXISTING PENDENT SPRINKLER WITH NEW UPRIGHT SPRINKLER SHALL OCCUR AT THE SAME TIME TO AVOID A SPRINKLER OUTAGE IN THE ROOM. 2. INSTALL NEW UPRIGHT SPRINKLER HEADS WITH MECHANICAL GUARDS TO SERVE 1. VERIFY COVERAGE REQUIREMENTS. REPLACEMENT OF THE EXISTING PENDENT SPRINKLER WITH NEW UPRIGHT SPRINKLER

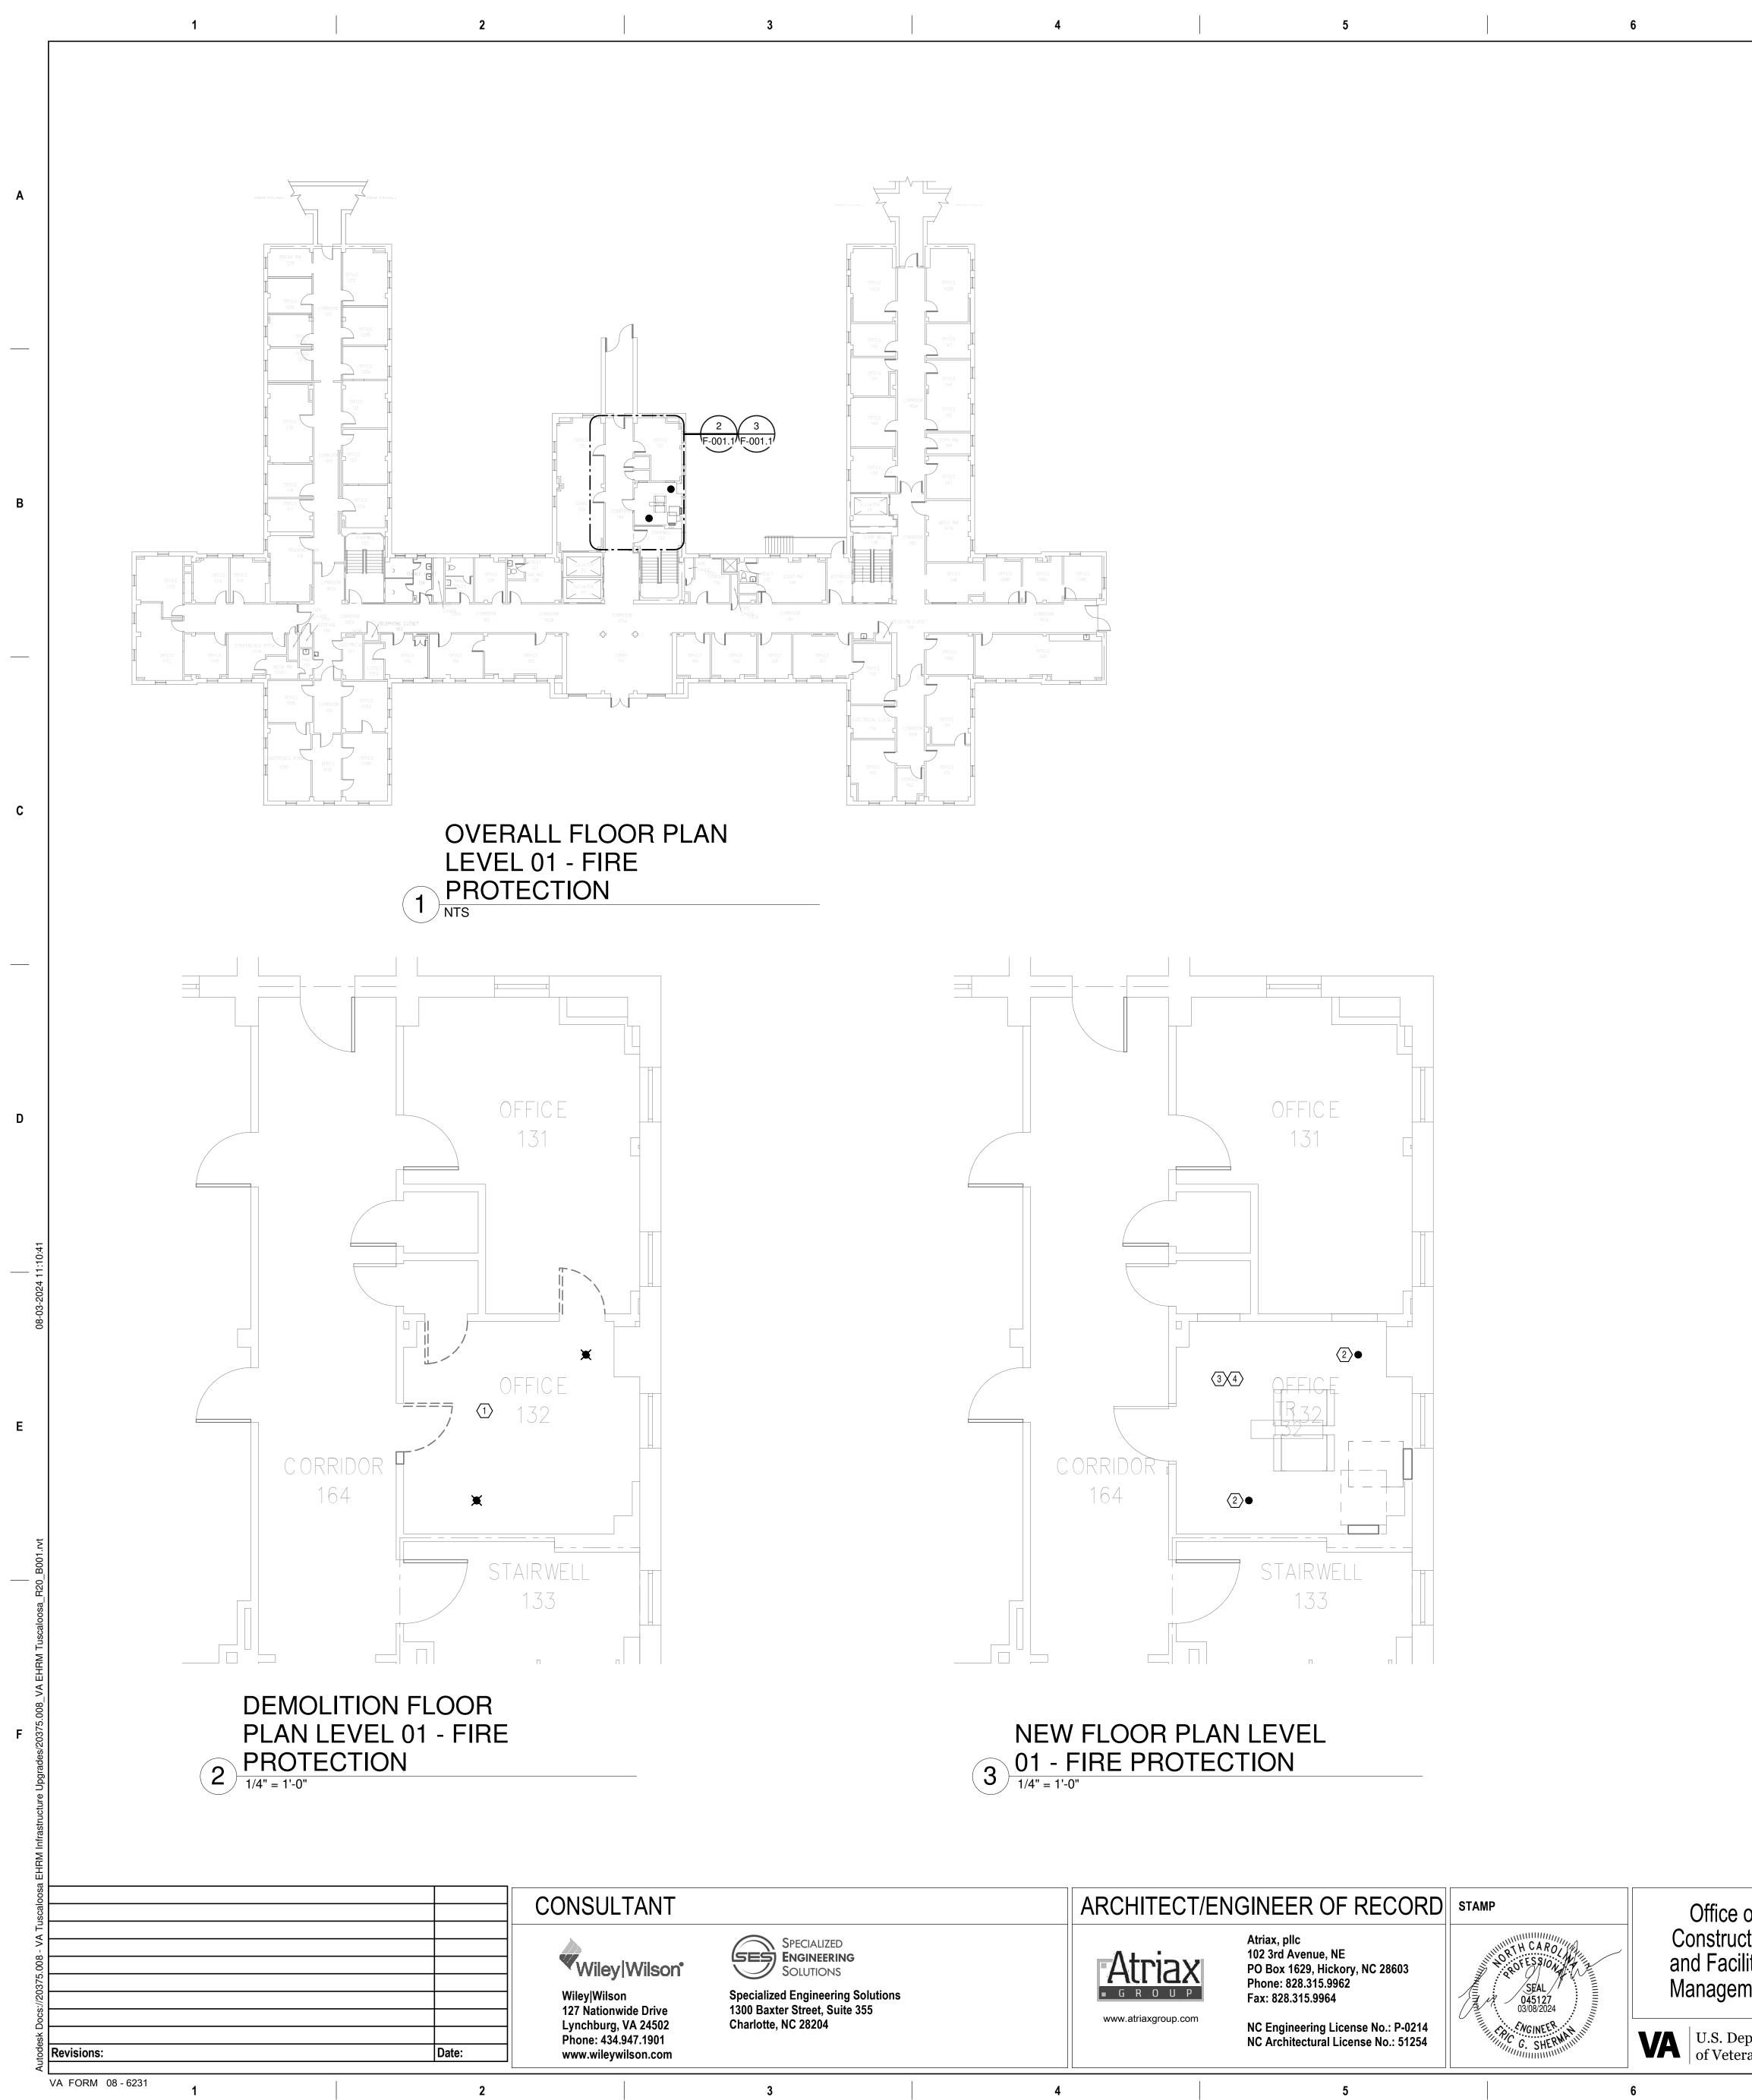
4. AREA OF EXISTING SPRINKLER COVERAGE. HAZARD CLASSIFICATION "LIGHT HAZARD". RELOCATE AND/OR ADD ADDITIONAL HEADS AND PIPING TO MEET COVERAGE REQUIREMENTS PER NFPA 13 AND VA REQUIREMENTS. COORDINATE HEAD LOCATIONS WITH EXISTING CONDITIONS AND ARCHITECT'S CEILING

R

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٩N		TRUE
UPGRADES		Project Number 679-20-104
		Building Number
CALOOSA, AL.		Drawing Number
d	Drawn PCM	F-001.G



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# **GENERAL NOTES:**

- A. COVER SHEET GENERAL NOTES APPLY TO ALL SHEETS.
- PLANS, NEW MECHANICAL SYSTEMS ARE INDICATED WITH HEAVY LINE WEIGHTS.
- PERFORM THIS WORK.

### <u>SHEET NOTES:</u>

- SHALL OCCUR AT THE SAME TIME TO AVOID A SPRINKLER OUTAGE IN THE ROOM.
- PLANS.

						PLAN
e of uction cilities	Drawing Title BUILDING 1 LEVEL PROTECTION	01 - FIRE	Phase 100% C DOCUN	CONSTRUCTION MENTS	Project Title EHRM INFRA	STRUCTURE UI
ement	Approved:				Location TUSCALOOSA	VAMC, TUSCAL
Department terans Affairs			FULLY	' SPRINKLERED	Issue Date 03/08/2024	Checked JKK
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B. ON DEMOLITION PLANS; EXISTING MECHANICAL SYSTEMS TO BE REMOVED ARE SHOWN HATCHED AND/OR DASHED, EXISTING MECHANICAL SYSTEMS TO REMAIN ARE SHOWN LIGHT LINE WEIGHT. ON ALL OTHER C. UNLESS NOTED OTHERWISE, DETAILS SHOWN WITHIN THESE DOCUMENTS ARE APPLICABLE FOR ALL PIPING, EQUIPMENT AND DUCTWORK INSTALLATIONS WHETHER OR NOT SPECIFICALLY NOTED. D. THE OWNER AND ENGINEER ARE NOT RESPONSIBLE FOR THE CONTRACTOR'S SAFETY PRECAUTIONS OR FOR THE MEANS, METHODS, TECHNIQUES, CONSTRUCTION SEQUENCES, OR PROCEDURES REQUIRED TO

1. REMOVE EXISTING SPRINKLER HEAD FOR CEILING REMOVAL. REFER TO NEW WORK PLANS FOR INSTALLATION OF NEW UPRIGHT HEADS. REPLACEMENT OF THE EXISTING PENDENT SPRINKLER WITH NEW UPRIGHT SPRINKLER SHALL OCCUR AT THE SAME TIME TO AVOID A SPRINKLER OUTAGE IN THE ROOM. 2. INSTALL NEW UPRIGHT SPRINKLER HEADS WITH MECHANICAL GUARDS TO SERVE 132. VERIFY COVERAGE REQUIREMENTS. REPLACEMENT OF THE EXISTING PENDENT SPRINKLER WITH NEW UPRIGHT SPRINKLER 3. SPRINKLER PIPING SHALL NOT BE ROUTED ABOVE EQUIPMENT RACKS OR ELECTRICAL PANELS.

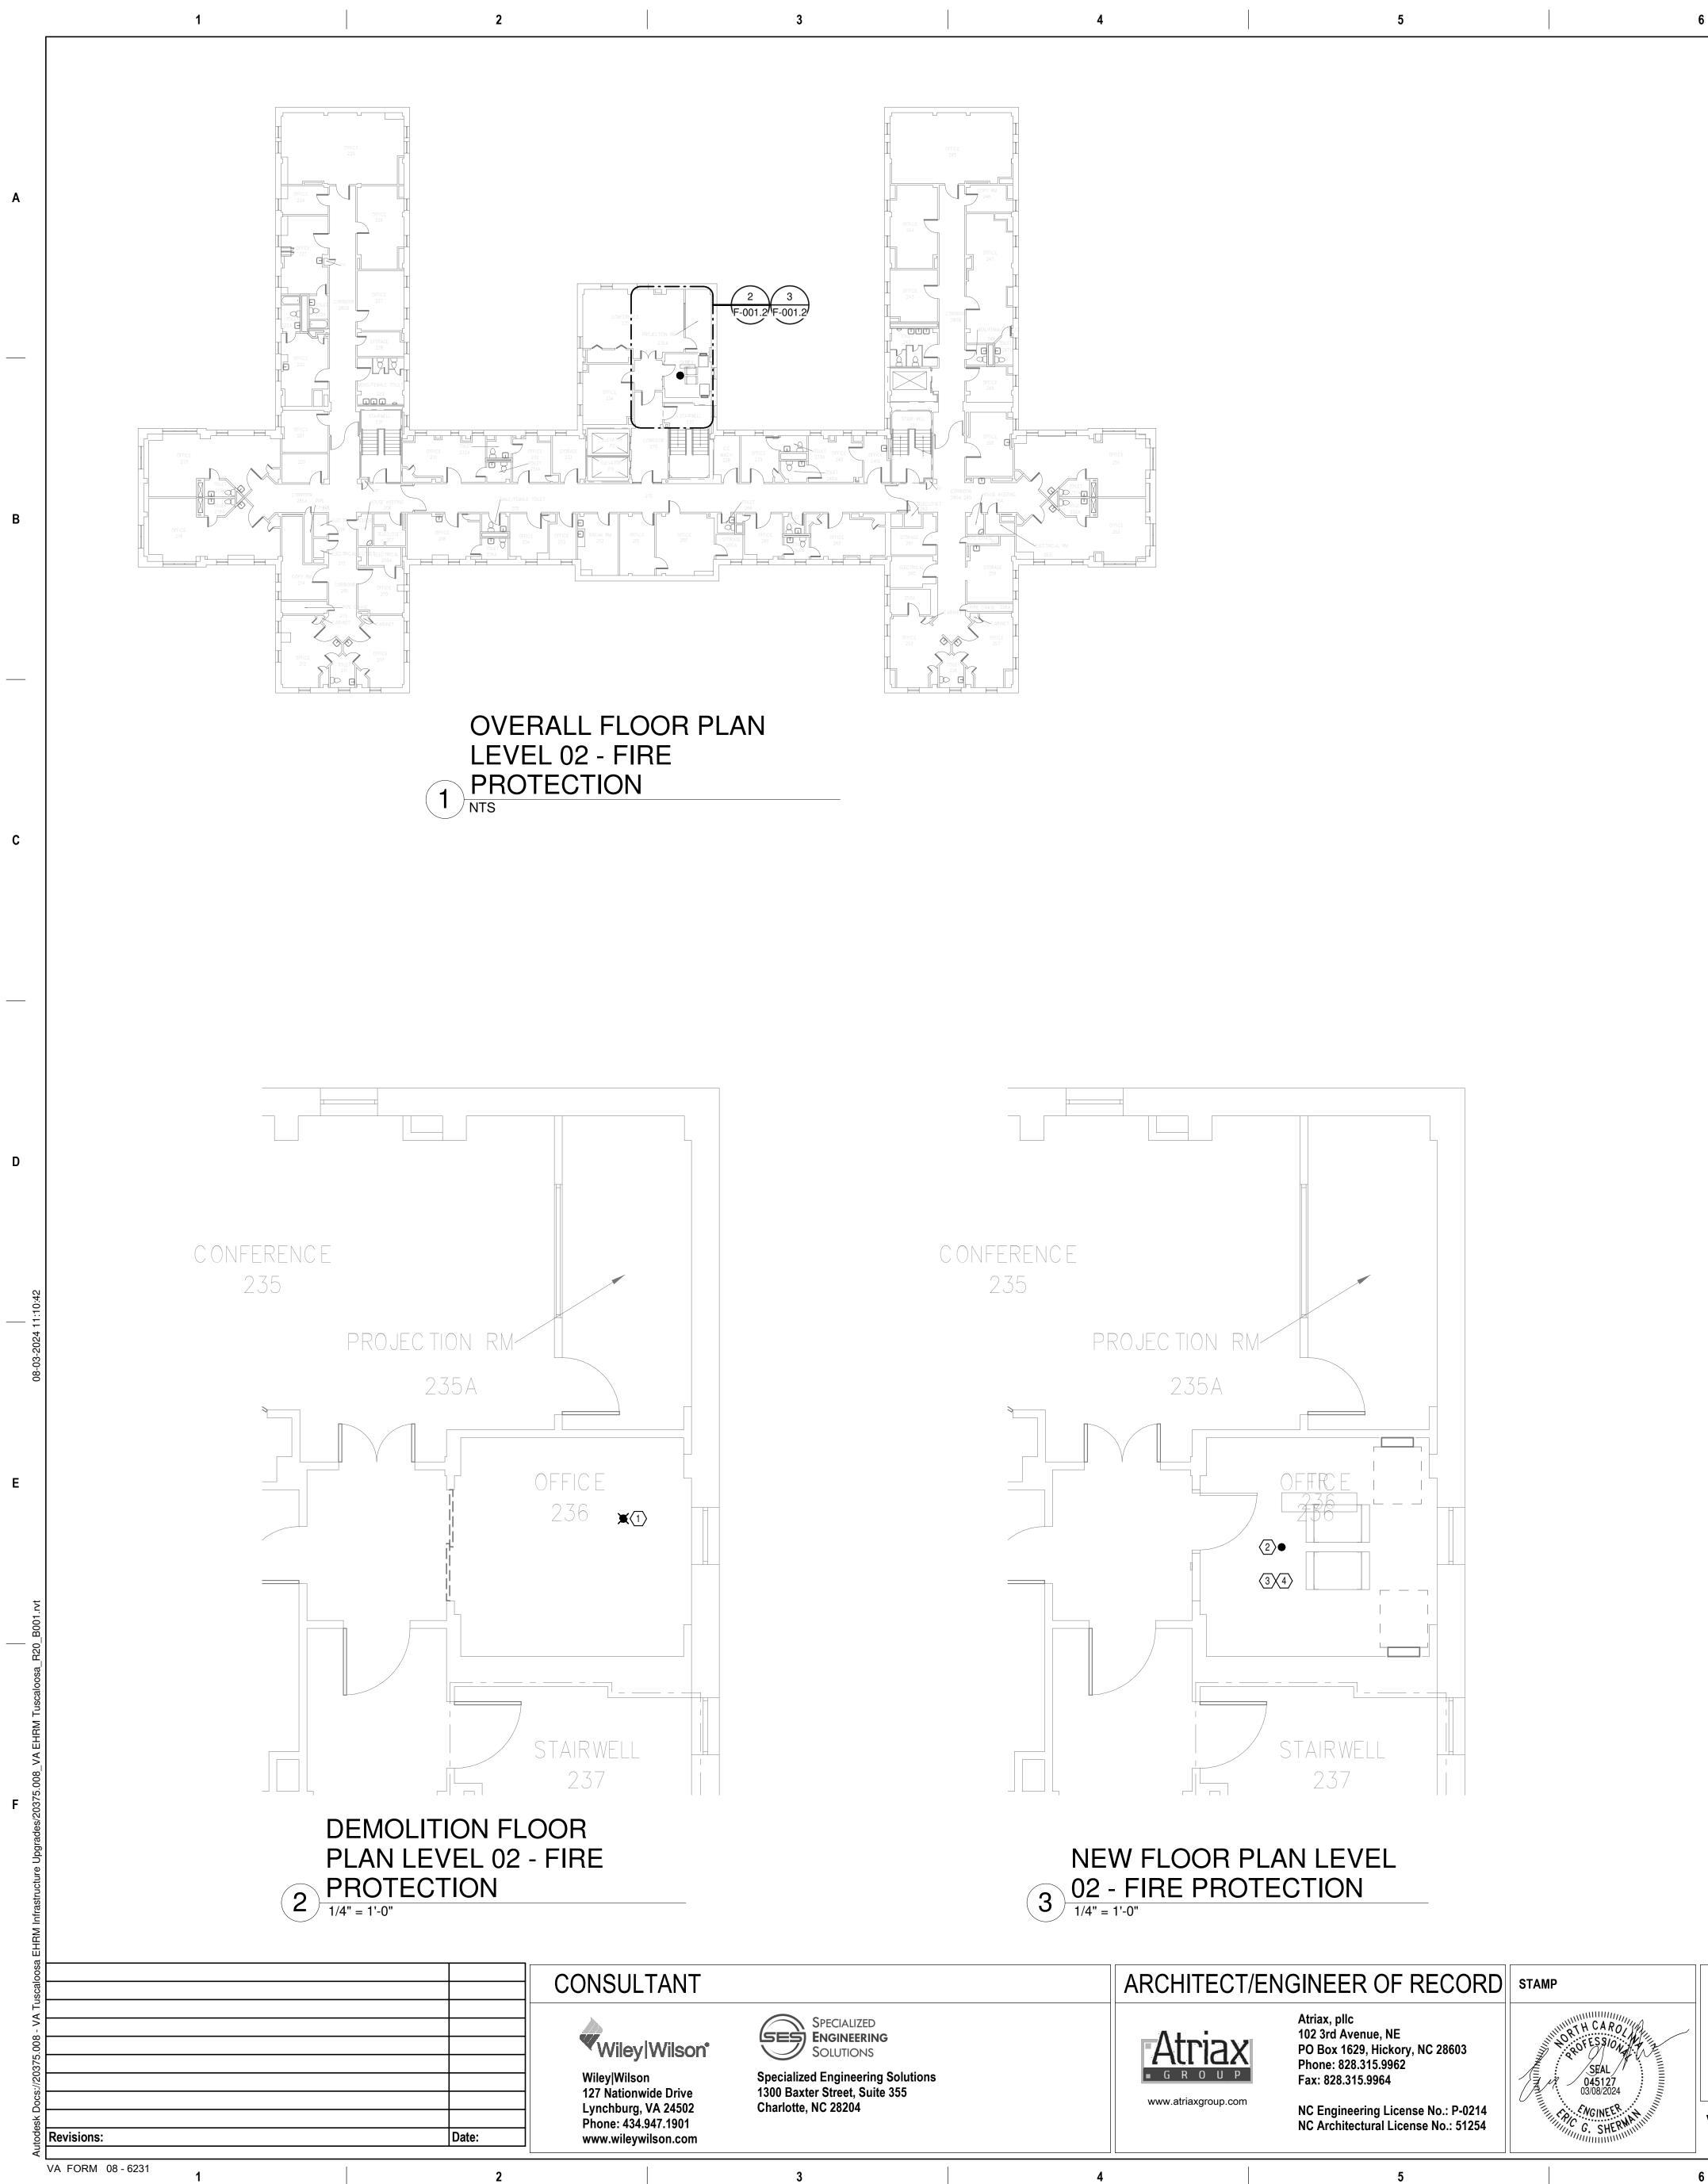
4. AREA OF EXISTING SPRINKLER COVERAGE. HAZARD CLASSIFICATION "LIGHT HAZARD". RELOCATE AND/OR ADD ADDITIONAL HEADS AND PIPING TO MEET COVERAGE REQUIREMENTS PER NFPA 13 AND VA REQUIREMENTS. COORDINATE HEAD LOCATIONS WITH EXISTING CONDITIONS AND ARCHITECT'S CEILING

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UPGRADES	Project Number 679-20-104 Building Number 1
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### **GENERAL NOTES:**

- A. COVER SHEET GENERAL NOTES APPLY TO ALL SHEETS.
- PLANS, NEW MECHANICAL SYSTEMS ARE INDICATED WITH HEAVY LINE WEIGHTS.
- PERFORM THIS WORK.

### <u>SHEET NOTES:</u>

- SPRINKLER OUTAGE IN THE ROOM.
- ROOM.
- PLANS.

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B. ON DEMOLITION PLANS; EXISTING MECHANICAL SYSTEMS TO BE REMOVED ARE SHOWN HATCHED AND/OR DASHED, EXISTING MECHANICAL SYSTEMS TO REMAIN ARE SHOWN LIGHT LINE WEIGHT. ON ALL OTHER C. UNLESS NOTED OTHERWISE, DETAILS SHOWN WITHIN THESE DOCUMENTS ARE APPLICABLE FOR ALL PIPING, EQUIPMENT AND DUCTWORK INSTALLATIONS WHETHER OR NOT SPECIFICALLY NOTED. D. THE OWNER AND ENGINEER ARE NOT RESPONSIBLE FOR THE CONTRACTOR'S SAFETY PRECAUTIONS OR FOR THE MEANS, METHODS, TECHNIQUES, CONSTRUCTION SEQUENCES, OR PROCEDURES REQUIRED TO

1. DEMOLISH EXISTING SPRINKLER HEAD FOR CEILING REMOVAL AND SPRINKLER PIPE TO POINT INDICATED. REFER TO NEW WORK PLANS FOR INSTALLATION OF NEW UPRIGHT HEADS. REPLACEMENT OF THE EXISTING PENDENT SPRINKLER WITH NEW UPRIGHT SPRINKLER SHALL OCCUR AT THE SAME TIME TO AVOID A

2. ROUTE NEW SPRINKLER PIPE TO INSTALL NEW UPRIGHT SPRINKLER HEADS WITH MECHANICAL GUARDS TO SERVE 236. VERIFY COVERAGE REQUIREMENTS. REPLACEMENT OF THE EXISTING PENDENT SPRINKLER WITH NEW UPRIGHT SPRINKLER SHALL OCCUR AT THE SAME TIME TO AVOID A SPRINKLER OUTAGE IN THE

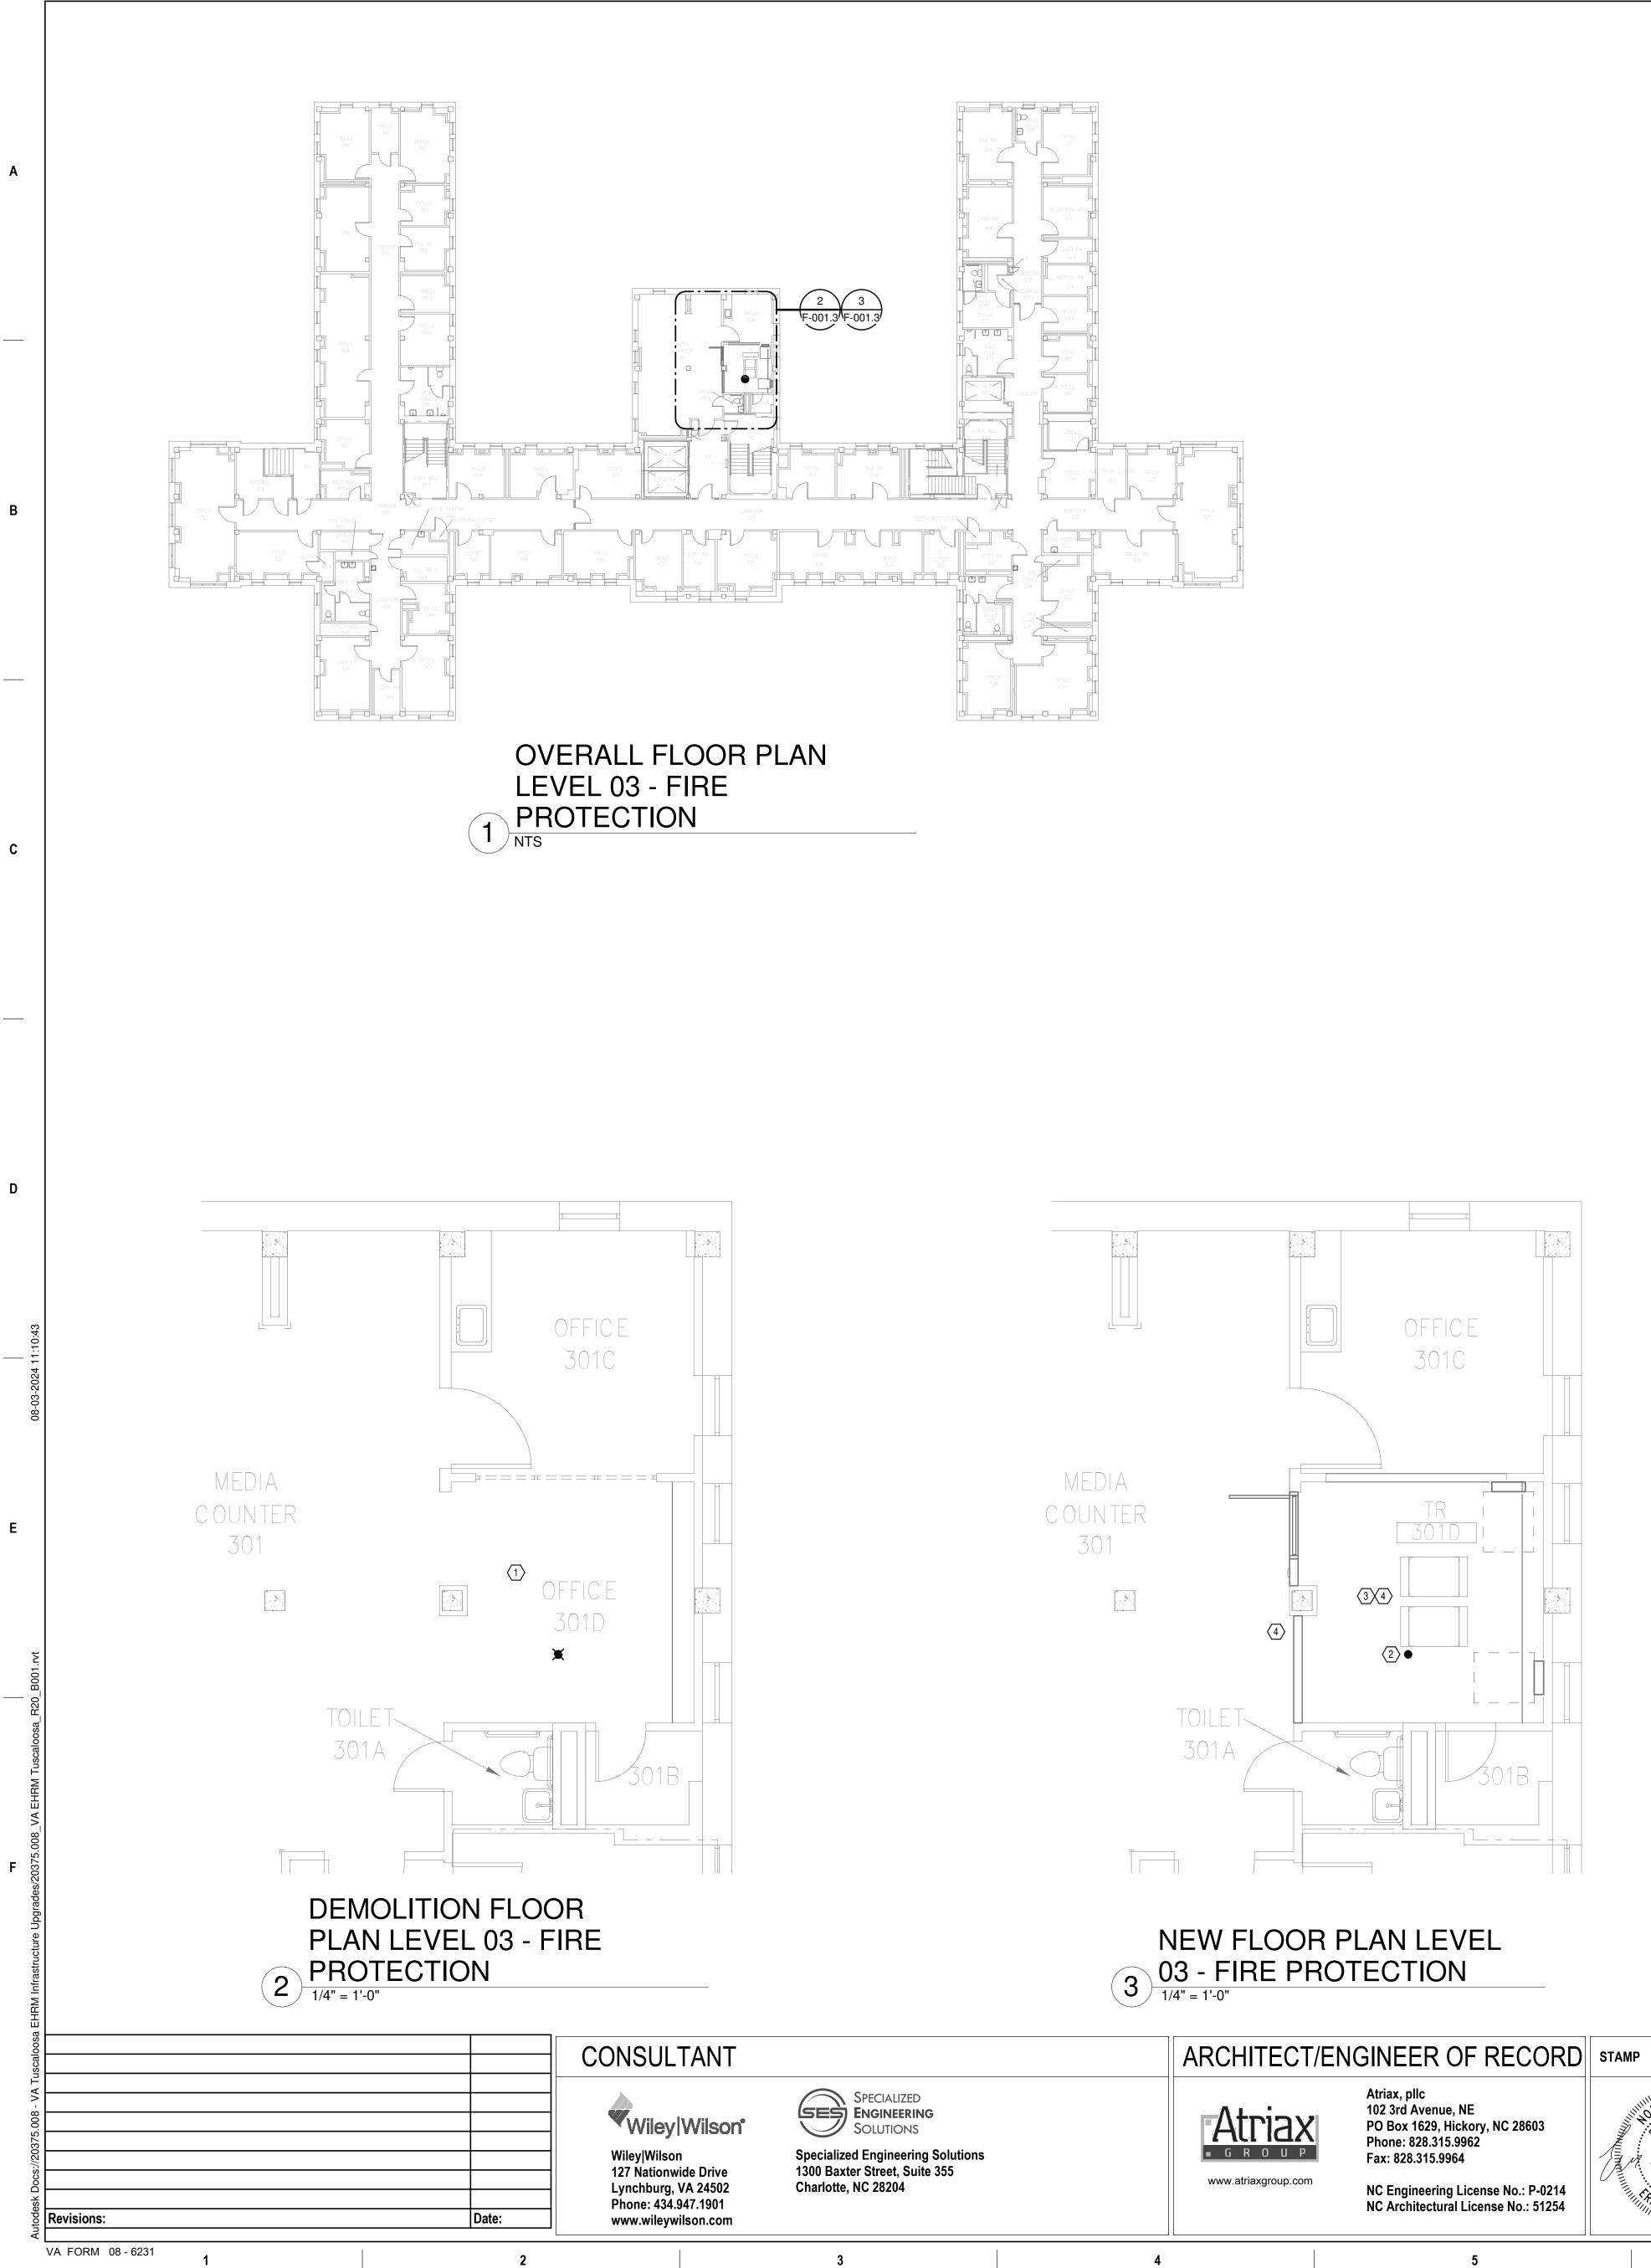
3. SPRINKLER PIPING SHALL NOT BE ROUTED ABOVE EQUIPMENT RACKS OR ELECTRICAL PANELS. 4. AREA OF EXISTING SPRINKLER COVERAGE. HAZARD CLASSIFICATION "LIGHT HAZARD". RELOCATE AND/OR ADD ADDITIONAL HEADS AND PIPING TO MEET COVERAGE REQUIREMENTS PER NFPA 13 AND VA REQUIREMENTS. COORDINATE HEAD LOCATIONS WITH EXISTING CONDITIONS AND ARCHITECT'S CEILING

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### **GENERAL NOTES:**

- A. COVER SHEET GENERAL NOTES APPLY TO ALL SHEETS.
- PLANS, NEW MECHANICAL SYSTEMS ARE INDICATED WITH HEAVY LINE WEIGHTS.
- PERFORM THIS WORK.

# SHEET NOTES:

- OUTAGE IN THE ROOM.
- SHALL OCCUR AT THE SAME TIME TO AVOID A SPRINKLER OUTAGE IN THE ROOM. 3. SPRINKLER PIPING SHALL NOT BE ROUTED ABOVE EQUIPMENT RACKS OR ELECTRICAL PANELS.
- PLANS.

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B. ON DEMOLITION PLANS; EXISTING MECHANICAL SYSTEMS TO BE REMOVED ARE SHOWN HATCHED AND/OR DASHED, EXISTING MECHANICAL SYSTEMS TO REMAIN ARE SHOWN LIGHT LINE WEIGHT. ON ALL OTHER C. UNLESS NOTED OTHERWISE, DETAILS SHOWN WITHIN THESE DOCUMENTS ARE APPLICABLE FOR ALL PIPING, EQUIPMENT AND DUCTWORK INSTALLATIONS WHETHER OR NOT SPECIFICALLY NOTED. D. THE OWNER AND ENGINEER ARE NOT RESPONSIBLE FOR THE CONTRACTOR'S SAFETY PRECAUTIONS OR FOR THE MEANS, METHODS, TECHNIQUES, CONSTRUCTION SEQUENCES, OR PROCEDURES REQUIRED TO

1. REMOVE EXISTING SPRINKLER HEAD FOR CEILING REMOVAL. REPLACEMENT OF THE EXISTING PENDENT SPRINKLER WITH NEW UPRIGHT SPRINKLER SHALL OCCUR AT THE SAME TIME TO AVOID A SPRINKLER

2. INSTALL NEW UPRIGHT SPRINKLER HEADS WITH MECHANICAL GUARDS TO SERVE 301. VERIFY COVERAGE REQUIREMENTS. REPLACEMENT OF THE EXISTING PENDENT SPRINKLER WITH NEW UPRIGHT SPRINKLER

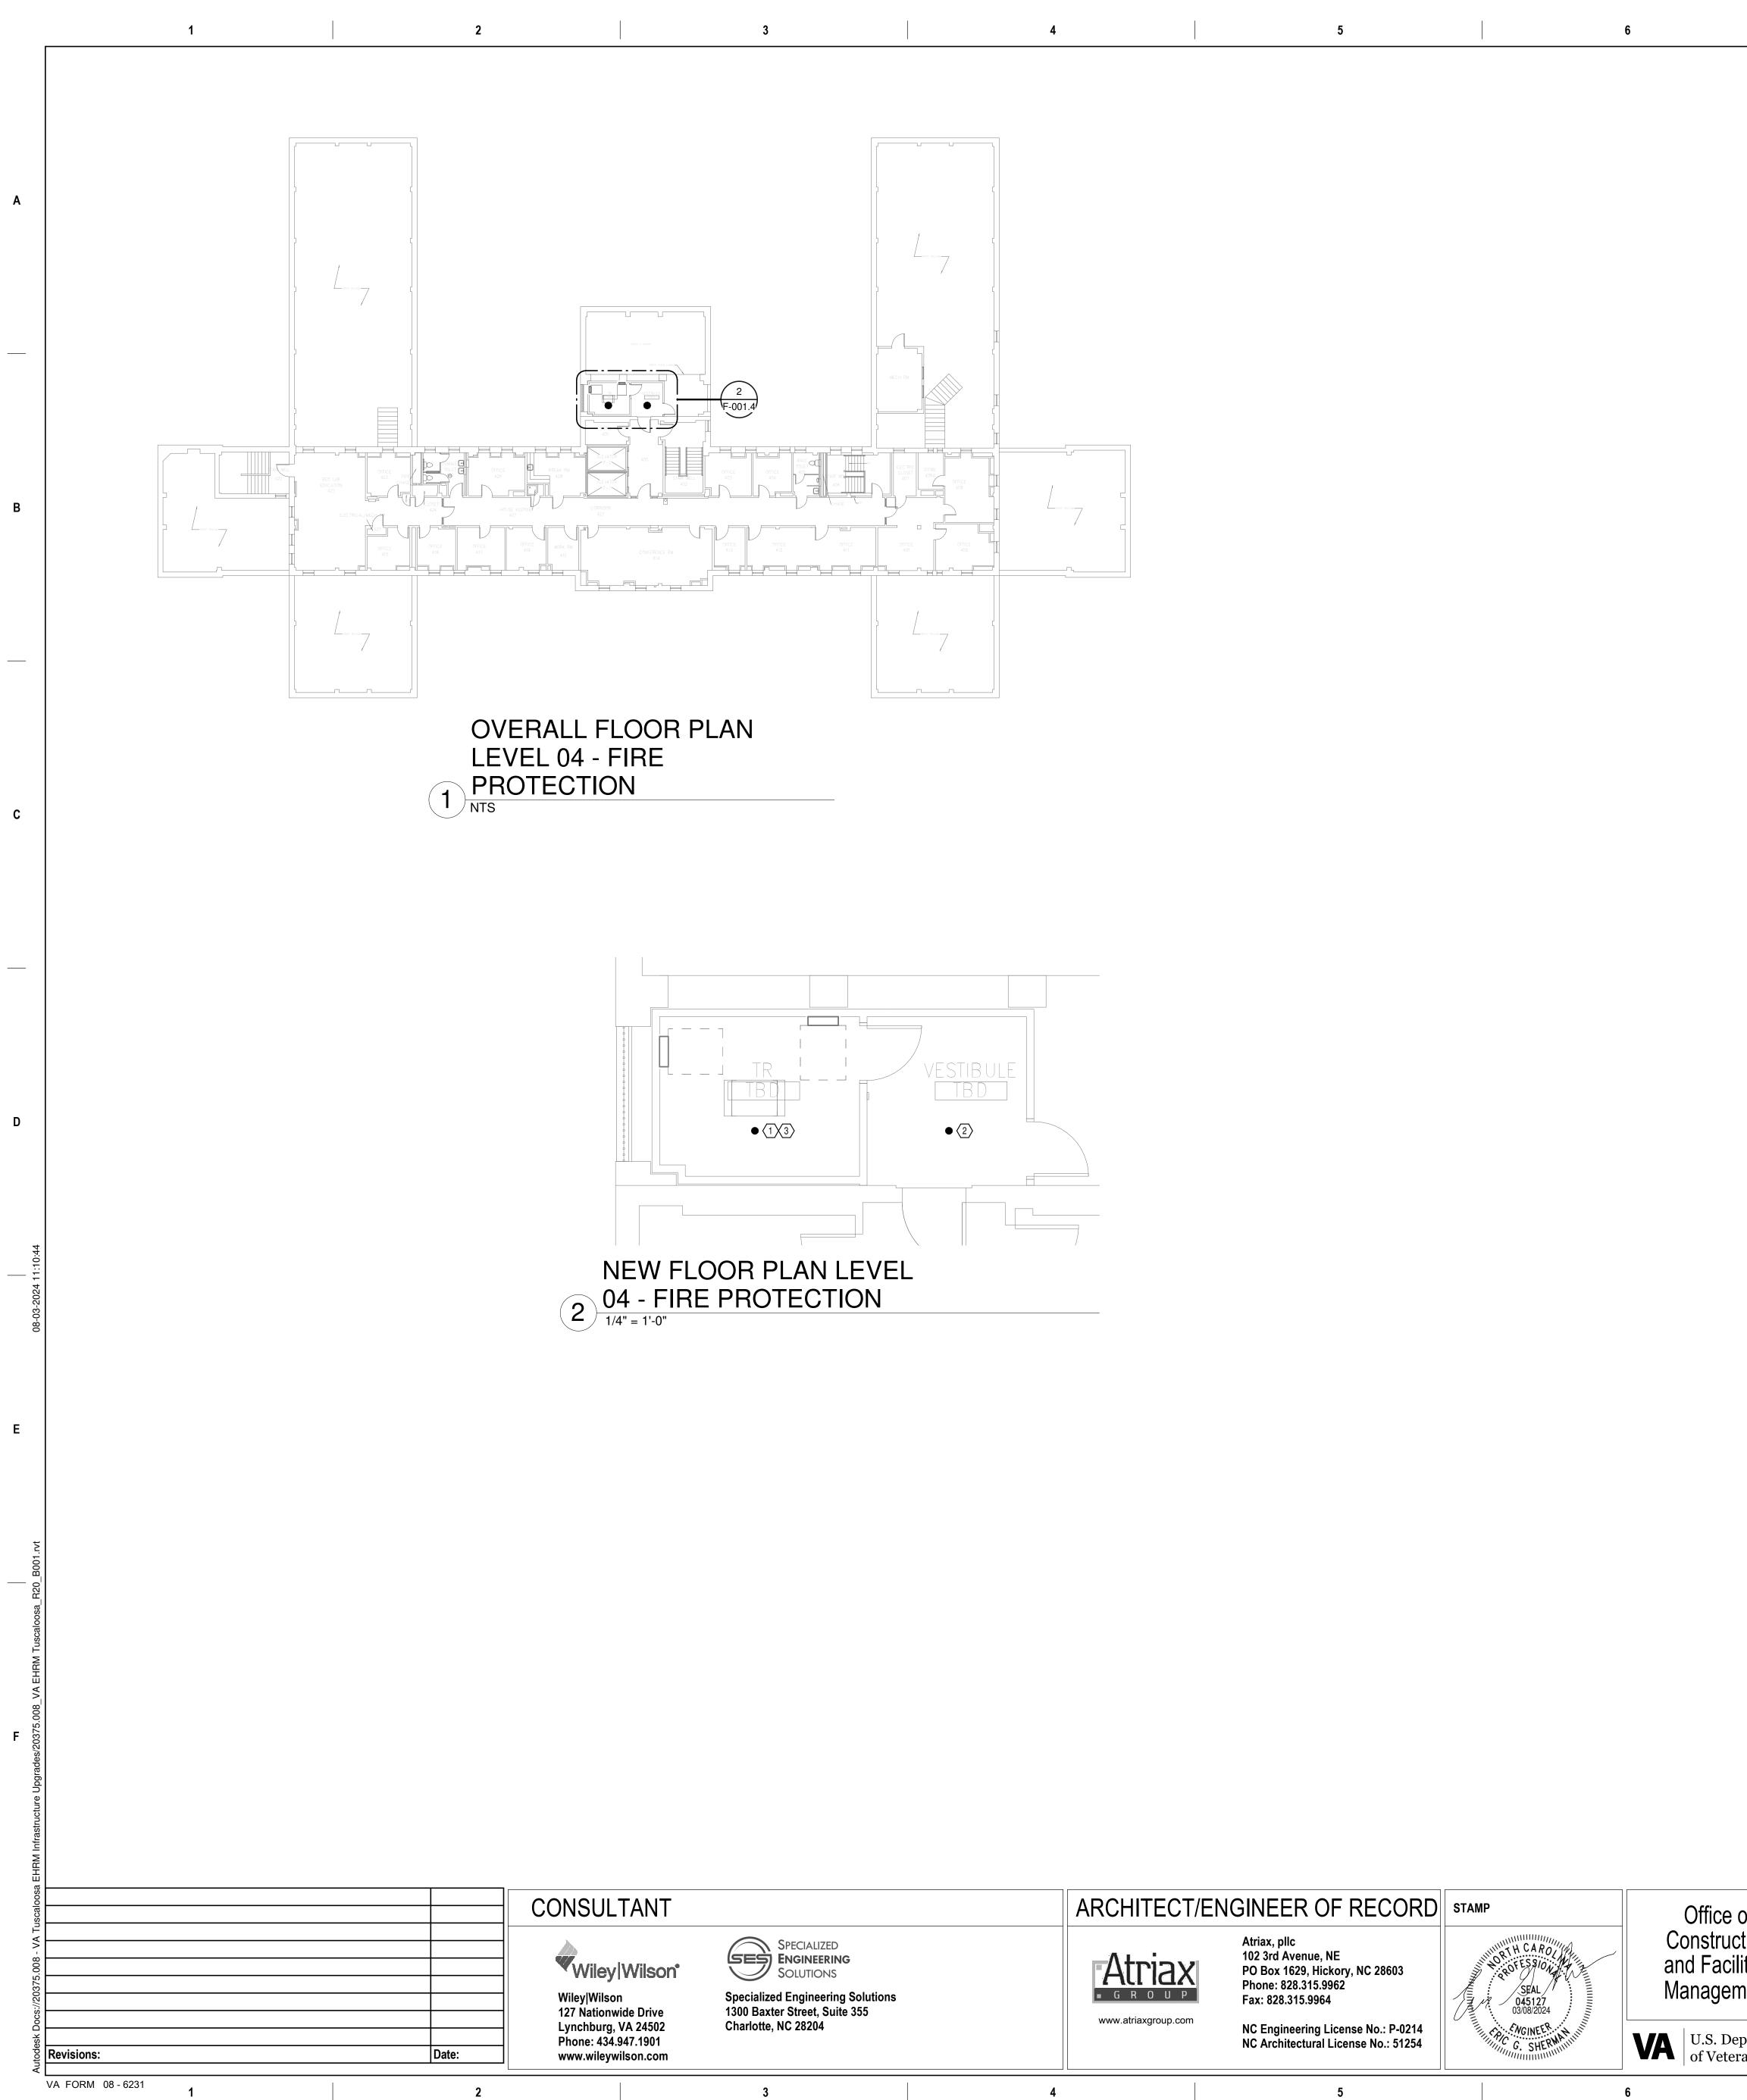
4. AREA OF EXISTING SPRINKLER COVERAGE. HAZARD CLASSIFICATION "LIGHT HAZARD". RELOCATE AND/OR ADD ADDITIONAL HEADS AND PIPING TO MEET COVERAGE REQUIREMENTS PER NFPA 13 AND VA REQUIREMENTS. COORDINATE HEAD LOCATIONS WITH EXISTING CONDITIONS AND ARCHITECT'S CEILING

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URE UPGR	ADES	Project Number 679-20-104
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# **GENERAL NOTES:**

- A. COVER SHEET GENERAL NOTES APPLY TO ALL SHEETS.
- PLANS, NEW MECHANICAL SYSTEMS ARE INDICATED WITH HEAVY LINE WEIGHTS.
- D. THE OWNER AND ENGINEER ARE NOT RESPONSIBLE FOR THE CONTRACTOR'S SAFETY PRECAUTIONS OR FOR THE MEANS, METHODS, TECHNIQUES, CONSTRUCTION SEQUENCES, OR PROCEDURES REQUIRED TO PERFORM THIS WORK.

### SHEET NOTES:

- EXISTING CONDITIONS AND ARCHITECT'S CEILING PLANS.
- REQUIREMENTS PER NFPA 13 AND VA REQUIREMENTS. COORDINATE HEAD LOCATIONS WITH EXISTING CONDITIONS AND ARCHITECT'S CEILING PLANS.

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B. ON DEMOLITION PLANS; EXISTING MECHANICAL SYSTEMS TO BE REMOVED ARE SHOWN HATCHED AND/OR DASHED, EXISTING MECHANICAL SYSTEMS TO REMAIN ARE SHOWN LIGHT LINE WEIGHT. ON ALL OTHER C. UNLESS NOTED OTHERWISE, DETAILS SHOWN WITHIN THESE DOCUMENTS ARE APPLICABLE FOR ALL PIPING, EQUIPMENT AND DUCTWORK INSTALLATIONS WHETHER OR NOT SPECIFICALLY NOTED.

1. INSTALL NEW UPRIGHT SPRINKLER HEADS WITH MECHANICAL GUARDS TO SERVE TR. VERIFY COVERAGE REQUIREMENTS. HAZARD CLASSIFICATION "LIGHT HAZARD". ADD ADDITIONAL HEADS AND PIPING TO MEET COVERAGE REQUIREMENTS PER NFPA 13 AND VA REQUIREMENTS. COORDINATE HEAD LOCATIONS WITH 2. INSTALL NEW PENDANT SPRINKLER HEADS TO SERVE VESTIBULE. VERIFY COVERAGE REQUIREMENTS. HAZARD CLASSIFICATION "LIGHT HAZARD". ADD ADDITIONAL HEADS AND PIPING TO MEET COVERAGE

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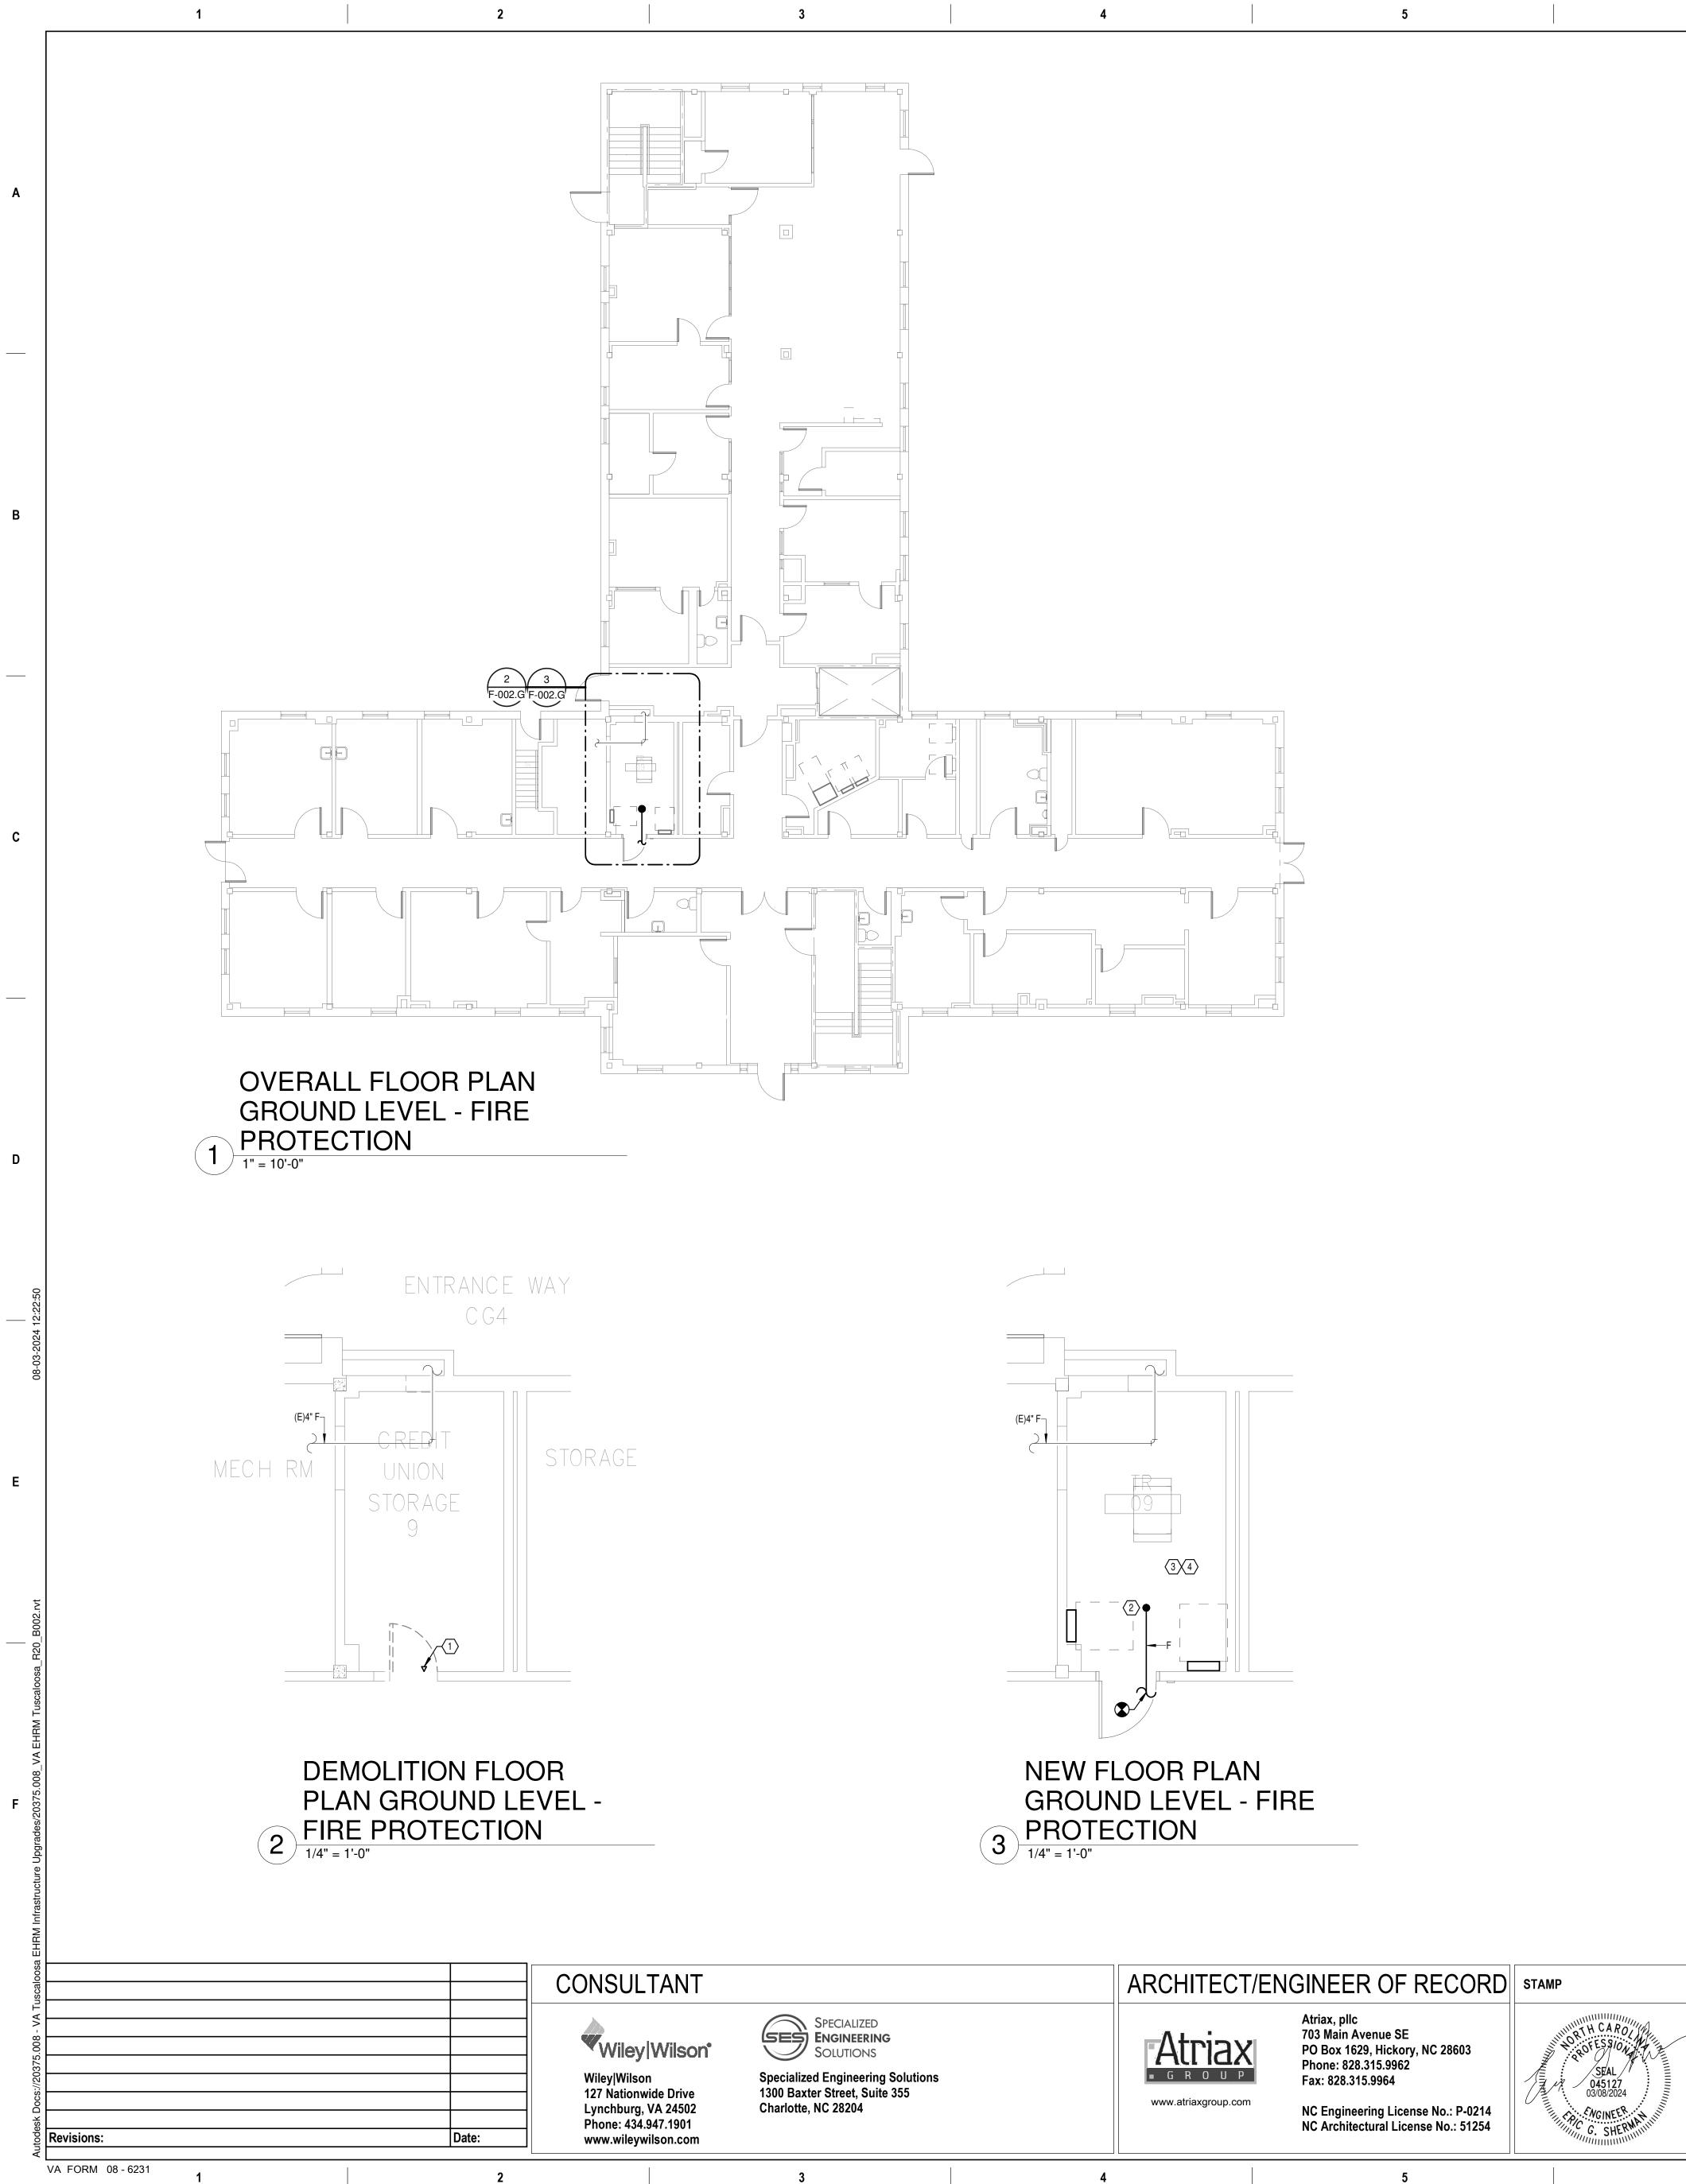
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3. SPRINKLER PIPING SHALL NOT BE ROUTED ABOVE EQUIPMENT RACKS OR ELECTRICAL PANELS.

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Project Number 679-20-104 Building Number
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Drawing Number
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### **GENERAL NOTES:**

- A. COVER SHEET GENERAL NOTES APPLY TO ALL SHEETS.
- PLANS, NEW MECHANICAL SYSTEMS ARE INDICATED WITH HEAVY LINE WEIGHTS.
- PERFORM THIS WORK.

### SHEET NOTES:

- SAME TIME TO AVOID A SPRINKLER OUTAGE IN THE ROOM.
- SHALL OCCUR AT THE SAME TIME TO AVOID A SPRINKLER OUTAGE IN THE ROOM.
- PLANS.

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B. ON DEMOLITION PLANS; EXISTING MECHANICAL SYSTEMS TO BE REMOVED ARE SHOWN HATCHED AND/OR DASHED, EXISTING MECHANICAL SYSTEMS TO REMAIN ARE SHOWN LIGHT LINE WEIGHT. ON ALL OTHER C. UNLESS NOTED OTHERWISE, DETAILS SHOWN WITHIN THESE DOCUMENTS ARE APPLICABLE FOR ALL PIPING, EQUIPMENT AND DUCTWORK INSTALLATIONS WHETHER OR NOT SPECIFICALLY NOTED. D. THE OWNER AND ENGINEER ARE NOT RESPONSIBLE FOR THE CONTRACTOR'S SAFETY PRECAUTIONS OR FOR THE MEANS, METHODS, TECHNIQUES, CONSTRUCTION SEQUENCES, OR PROCEDURES REQUIRED TO

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REQUIREMENTS. REPLACEMENT OF THE EXISTING PENDENT SPRINKLER WITH NEW UPRIGHT SPRINKLER 3. SPRINKLER PIPING SHALL NOT BE ROUTED ABOVE EQUIPMENT RACKS OR ELECTRICAL PANELS.

4. AREA OF EXISTING SPRINKLER COVERAGE. HAZARD CLASSIFICATION "LIGHT HAZARD". RELOCATE AND/OR ADD ADDITIONAL HEADS AND PIPING TO MEET COVERAGE REQUIREMENTS PER NFPA 13 AND VA REQUIREMENTS. COORDINATE HEAD LOCATIONS WITH EXISTING CONDITIONS AND ARCHITECT'S CEILING

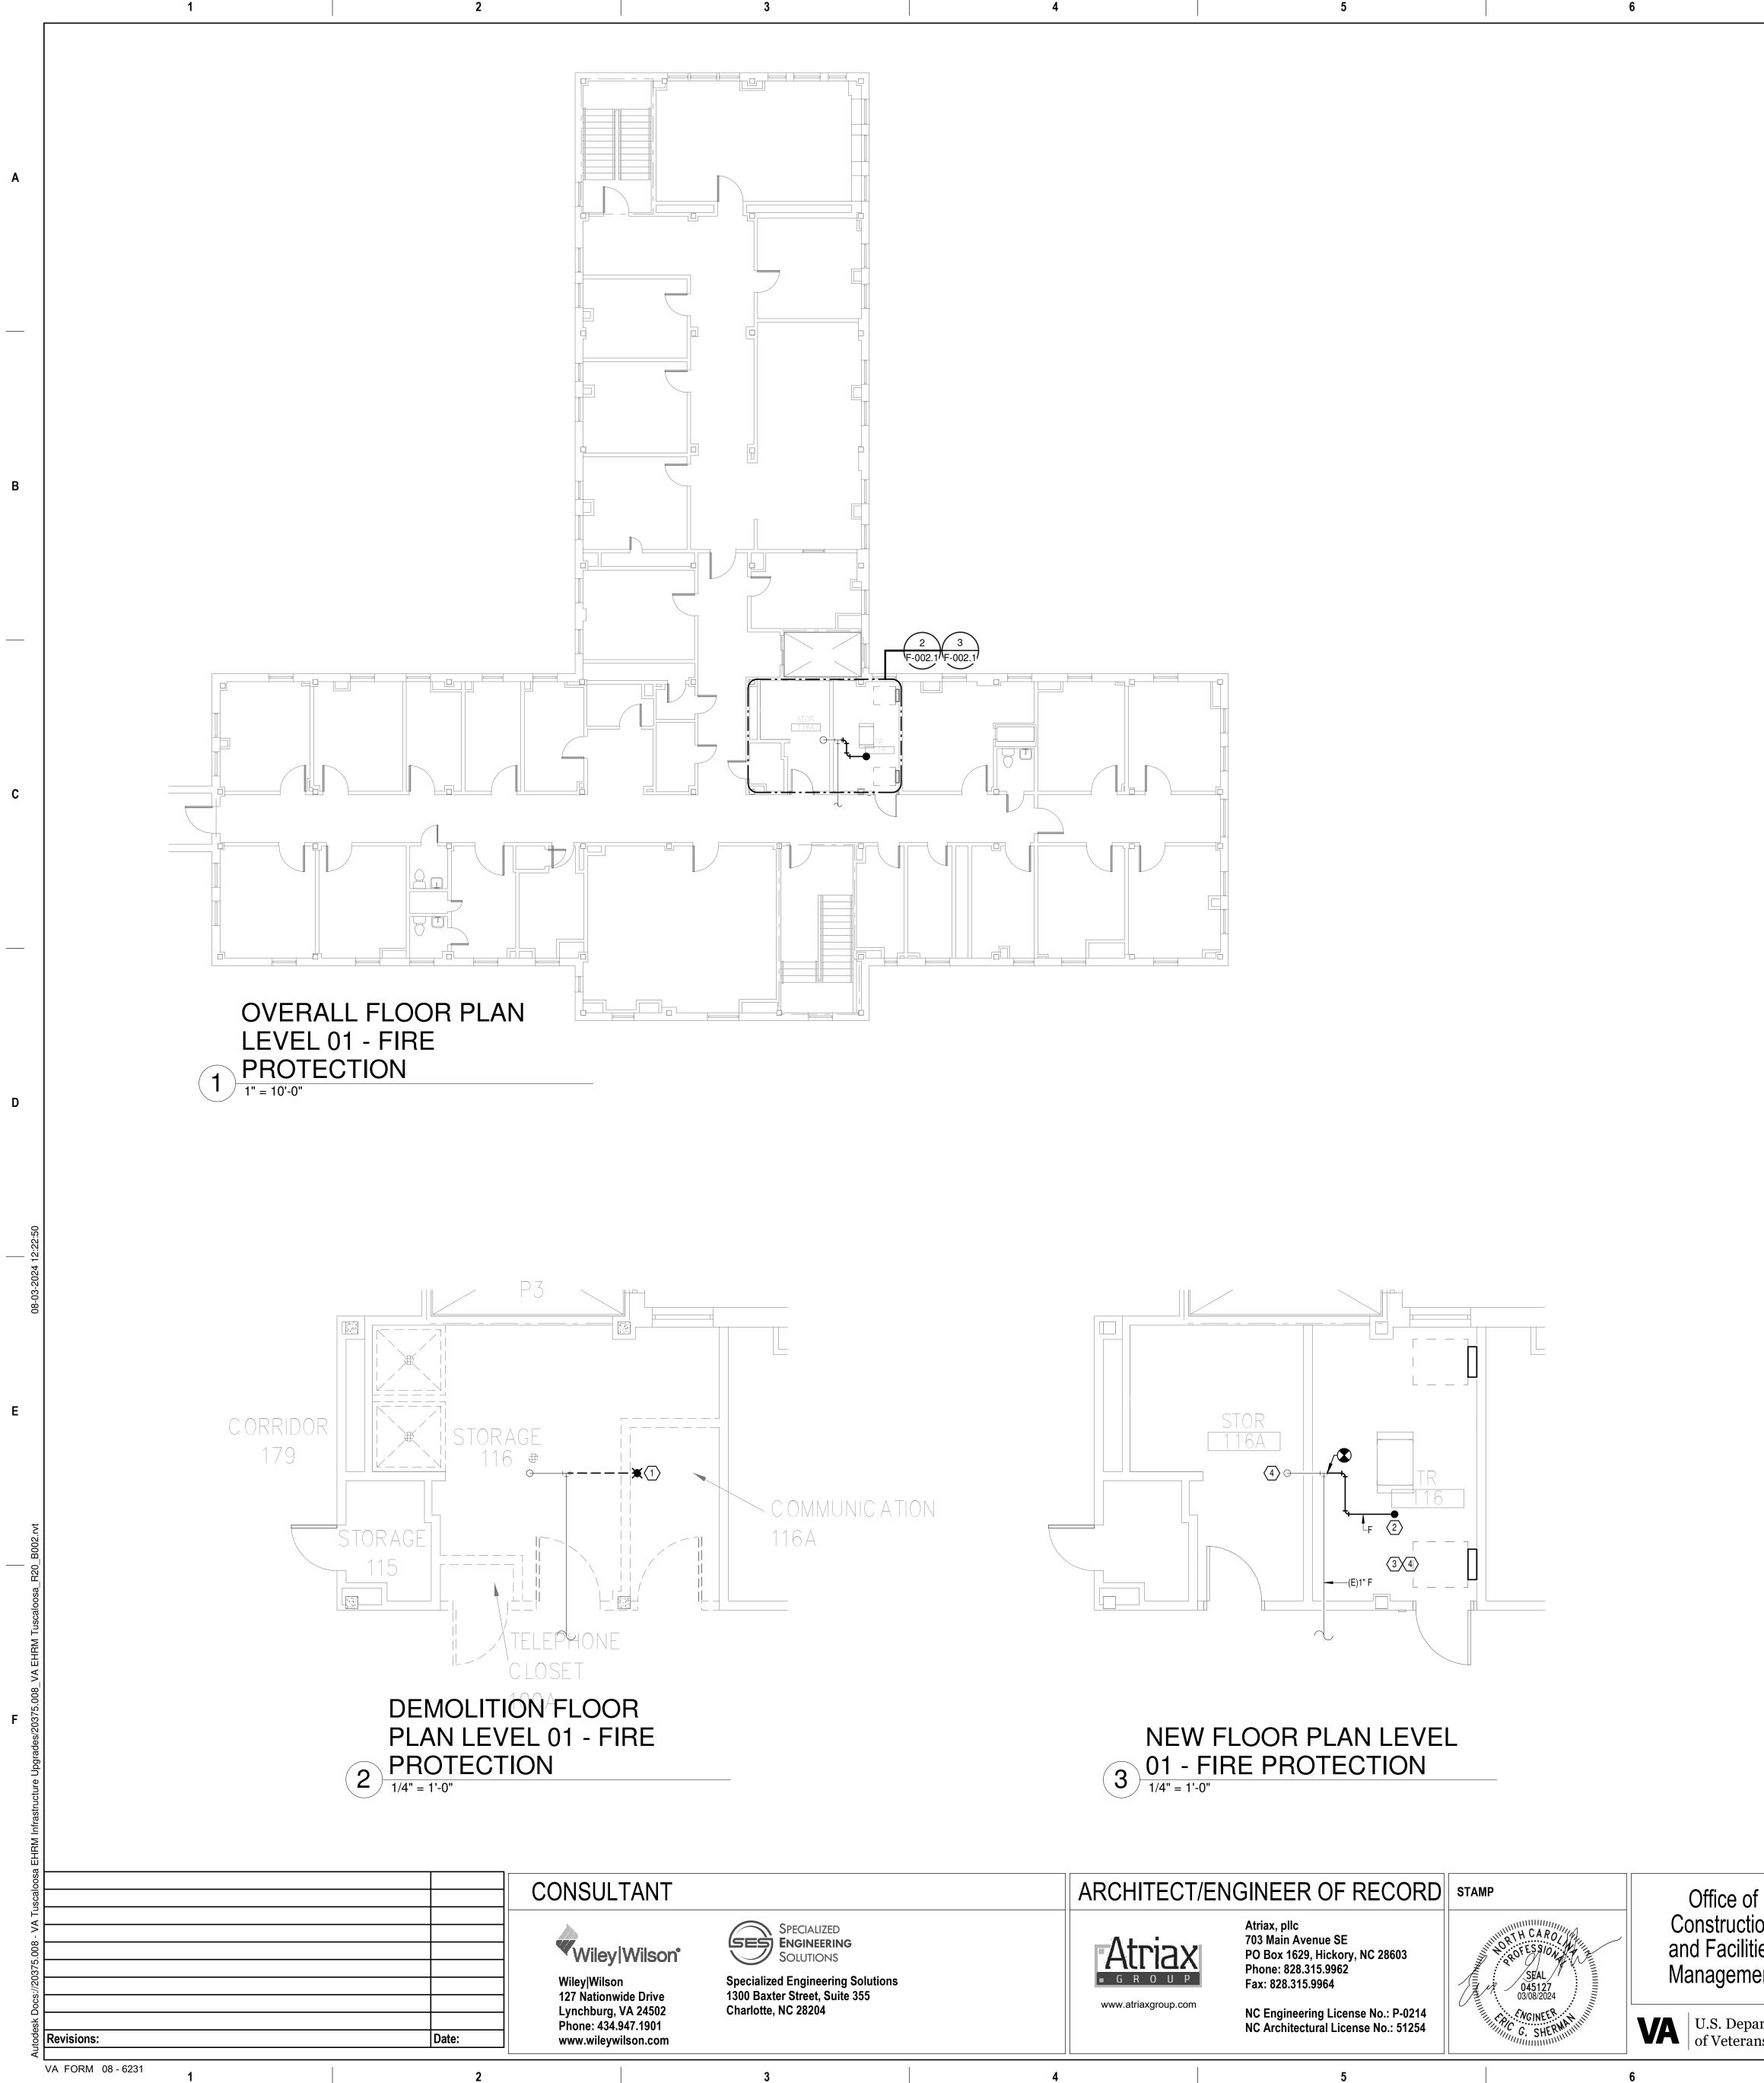
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# **GENERAL NOTES:**

- A. COVER SHEET GENERAL NOTES APPLY TO ALL SHEETS.
- PLANS, NEW MECHANICAL SYSTEMS ARE INDICATED WITH HEAVY LINE WEIGHTS.
- PERFORM THIS WORK.

### SHEET NOTES:

- SPRINKLER OUTAGE IN THE ROOM.
- SHALL OCCUR AT THE SAME TIME TO AVOID A SPRINKLER OUTAGE IN THE ROOM.
- ADD ADDITIONAL HEADS AND PIPING TO MEET COVERAGE REQUIREMENTS PER NFPA 13 AND VA REQUIREMENTS. COORDINATE HEAD LOCATIONS WITH EXISTING CONDITIONS AND ARCHITECT'S CEILING PLANS.

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2. INSTALL NEW UPRIGHT SPRINKLER HEADS WITH MECHANICAL GUARDS TO SERVE 116. VERIFY COVERAGE REQUIREMENTS. REPLACEMENT OF THE EXISTING PENDENT SPRINKLER WITH NEW UPRIGHT SPRINKLER 3. SPRINKLER PIPING SHALL NOT BE ROUTED ABOVE EQUIPMENT RACKS OR ELECTRICAL PANELS. 4. AREA OF EXISTING SPRINKLER COVERAGE. HAZARD CLASSIFICATION "LIGHT HAZARD". RELOCATE AND/OR

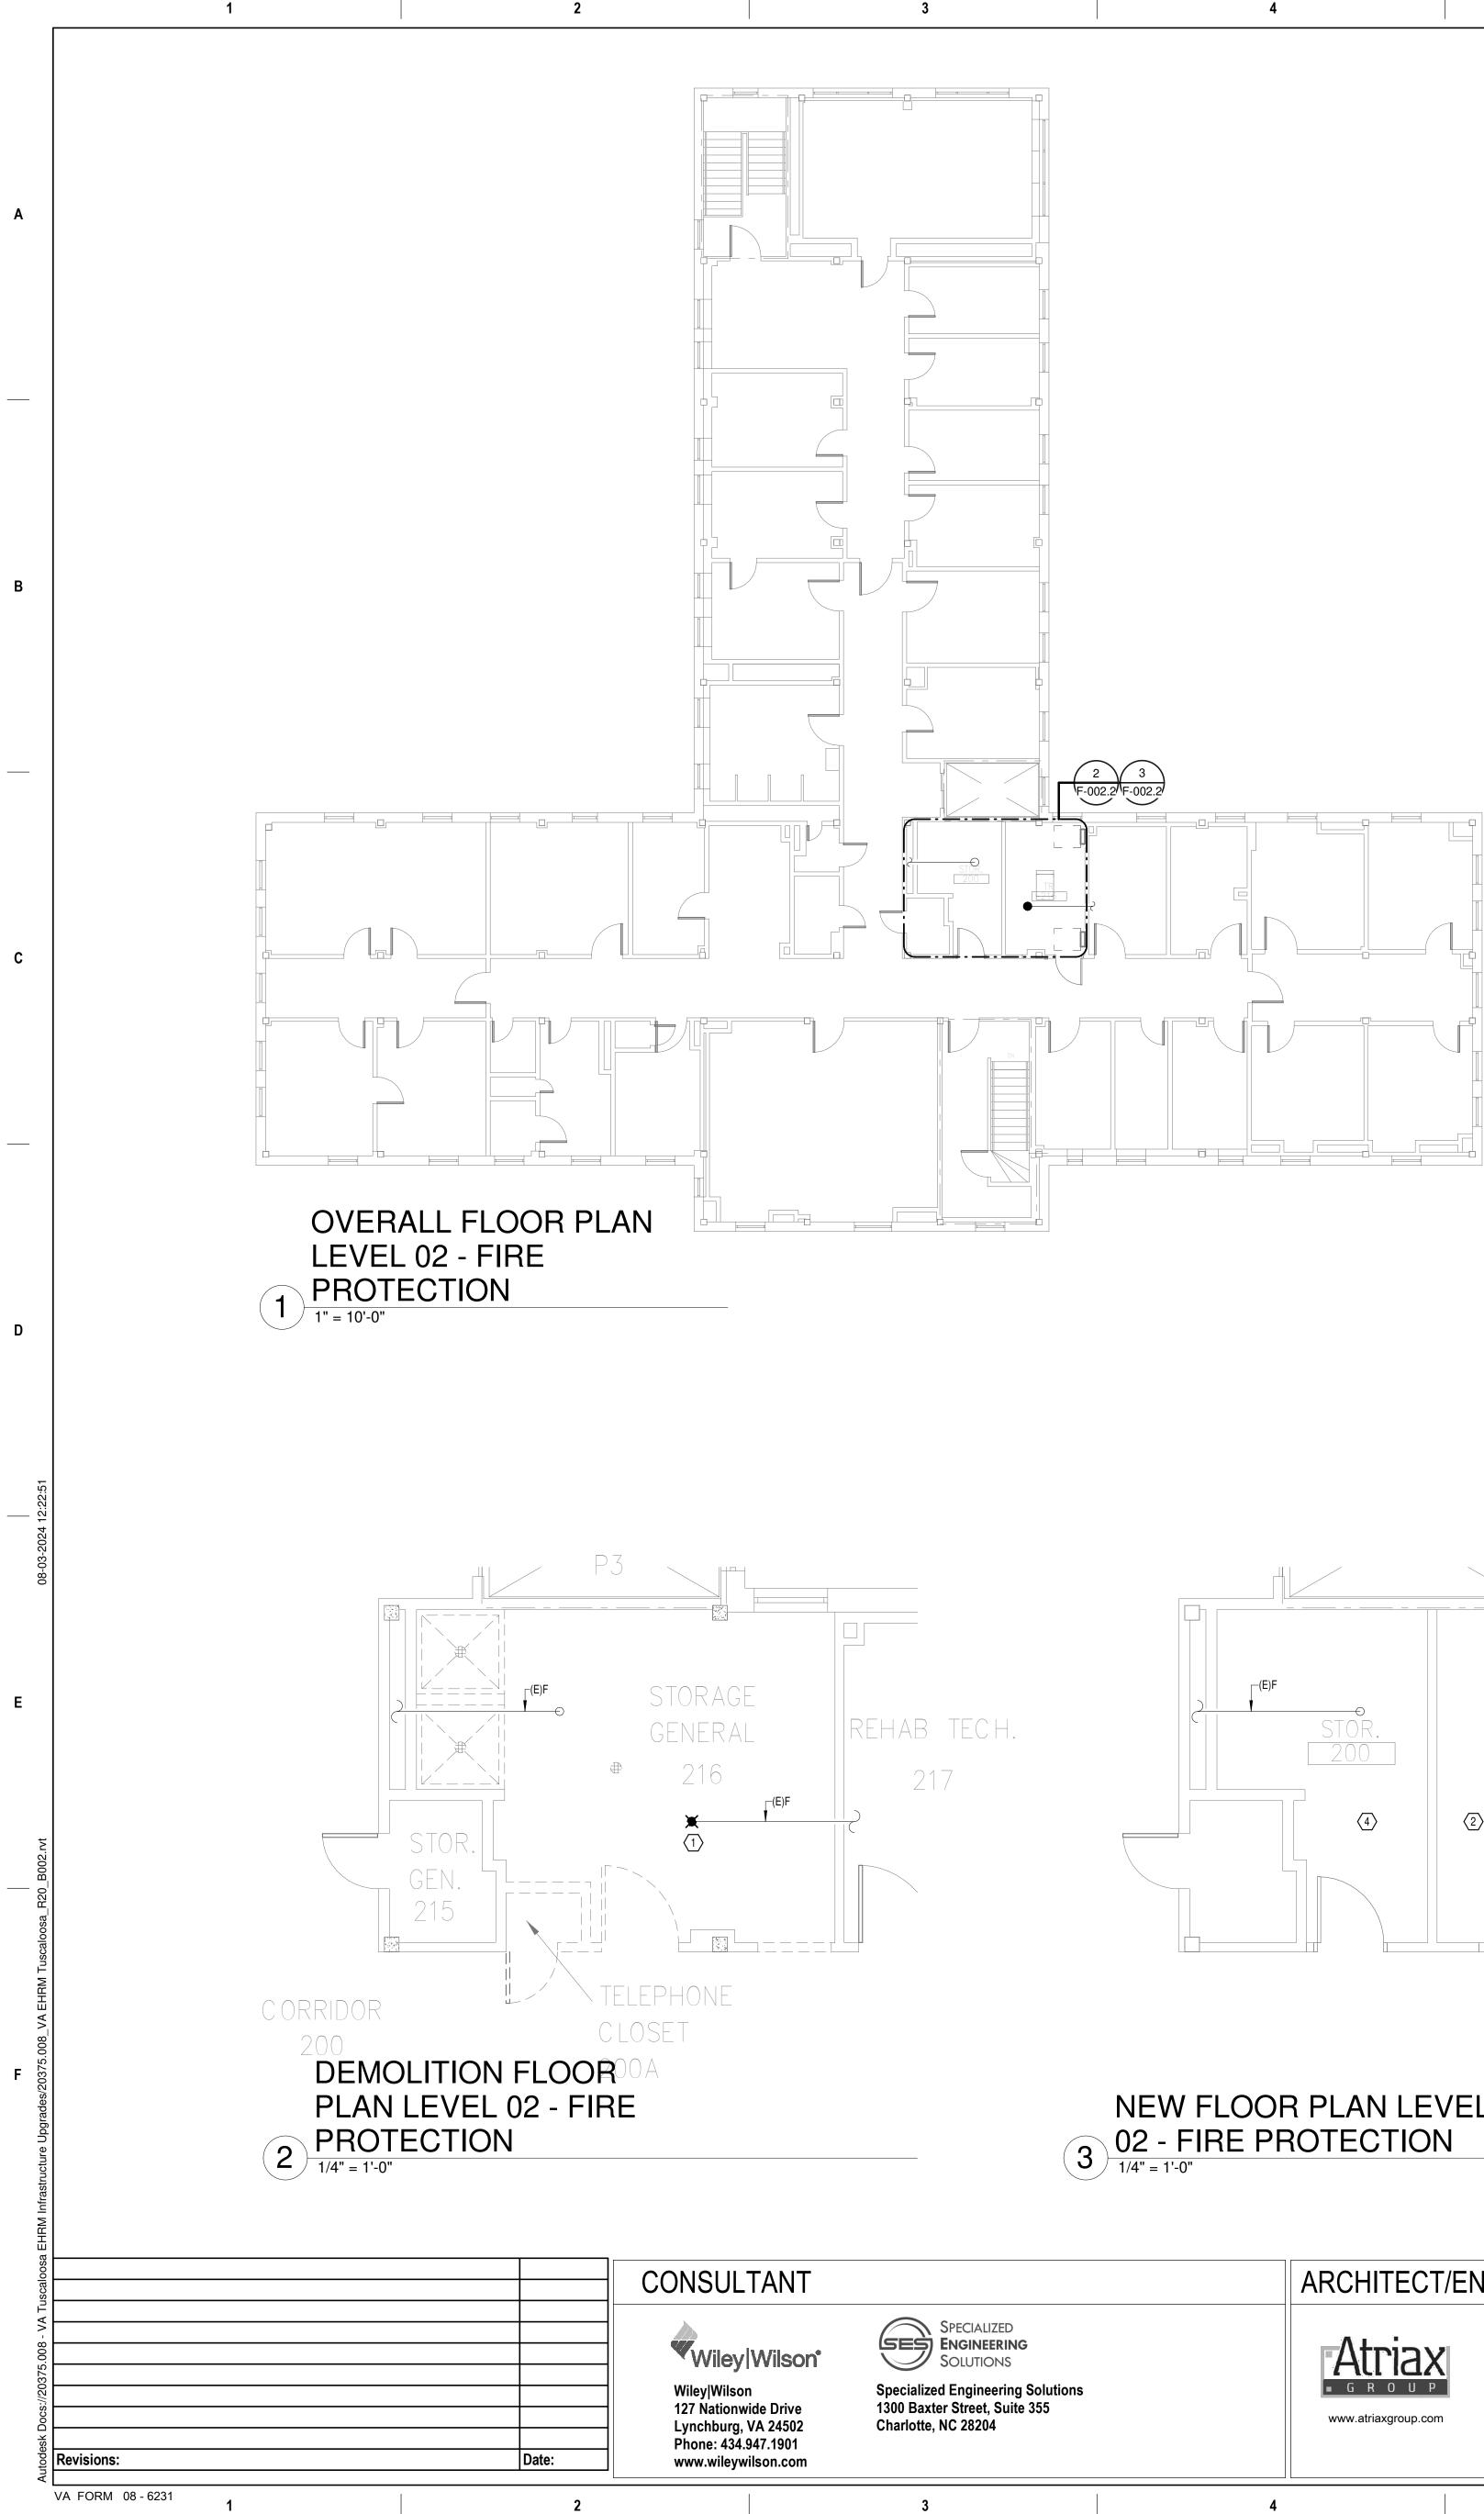
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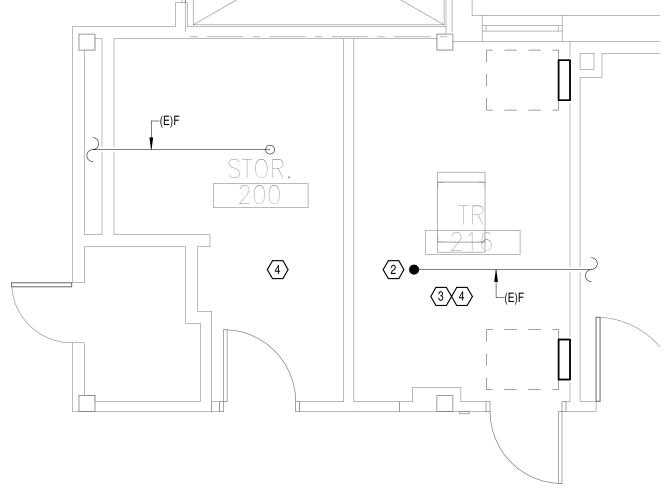
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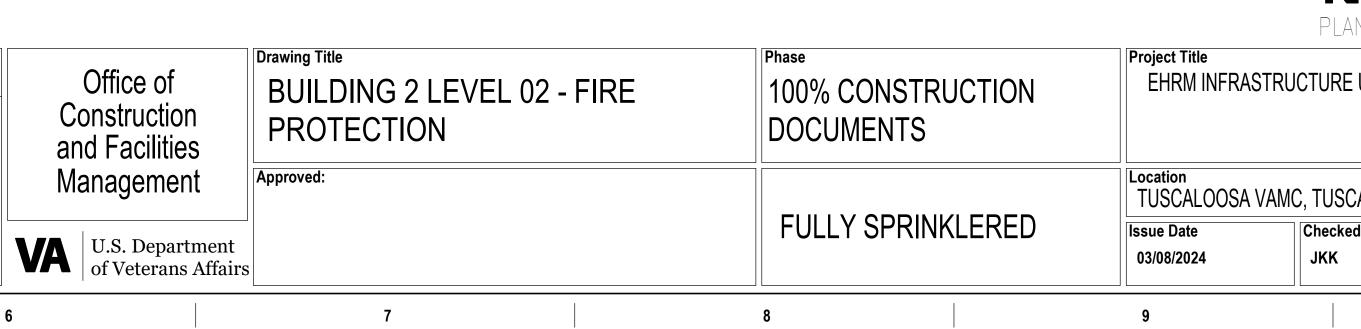
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# **GENERAL NOTES:**

- A. COVER SHEET GENERAL NOTES APPLY TO ALL SHEETS.
- PLANS, NEW MECHANICAL SYSTEMS ARE INDICATED WITH HEAVY LINE WEIGHTS.
- PERFORM THIS WORK.

### SHEET NOTES:

- OUTAGE IN THE ROOM.
- SHALL OCCUR AT THE SAME TIME TO AVOID A SPRINKLER OUTAGE IN THE ROOM. 3. SPRINKLER PIPING SHALL NOT BE ROUTED ABOVE EQUIPMENT RACKS OR ELECTRICAL PANELS.
- PLANS.



B. ON DEMOLITION PLANS; EXISTING MECHANICAL SYSTEMS TO BE REMOVED ARE SHOWN HATCHED AND/OR DASHED, EXISTING MECHANICAL SYSTEMS TO REMAIN ARE SHOWN LIGHT LINE WEIGHT. ON ALL OTHER C. UNLESS NOTED OTHERWISE, DETAILS SHOWN WITHIN THESE DOCUMENTS ARE APPLICABLE FOR ALL PIPING, EQUIPMENT AND DUCTWORK INSTALLATIONS WHETHER OR NOT SPECIFICALLY NOTED. D. THE OWNER AND ENGINEER ARE NOT RESPONSIBLE FOR THE CONTRACTOR'S SAFETY PRECAUTIONS OR FOR THE MEANS, METHODS, TECHNIQUES, CONSTRUCTION SEQUENCES, OR PROCEDURES REQUIRED TO

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2. INSTALL NEW UPRIGHT SPRINKLER HEADS WITH MECHANICAL GUARDS TO SERVE 216. VERIFY COVERAGE REQUIREMENTS. REPLACEMENT OF THE EXISTING PENDENT SPRINKLER WITH NEW UPRIGHT SPRINKLER

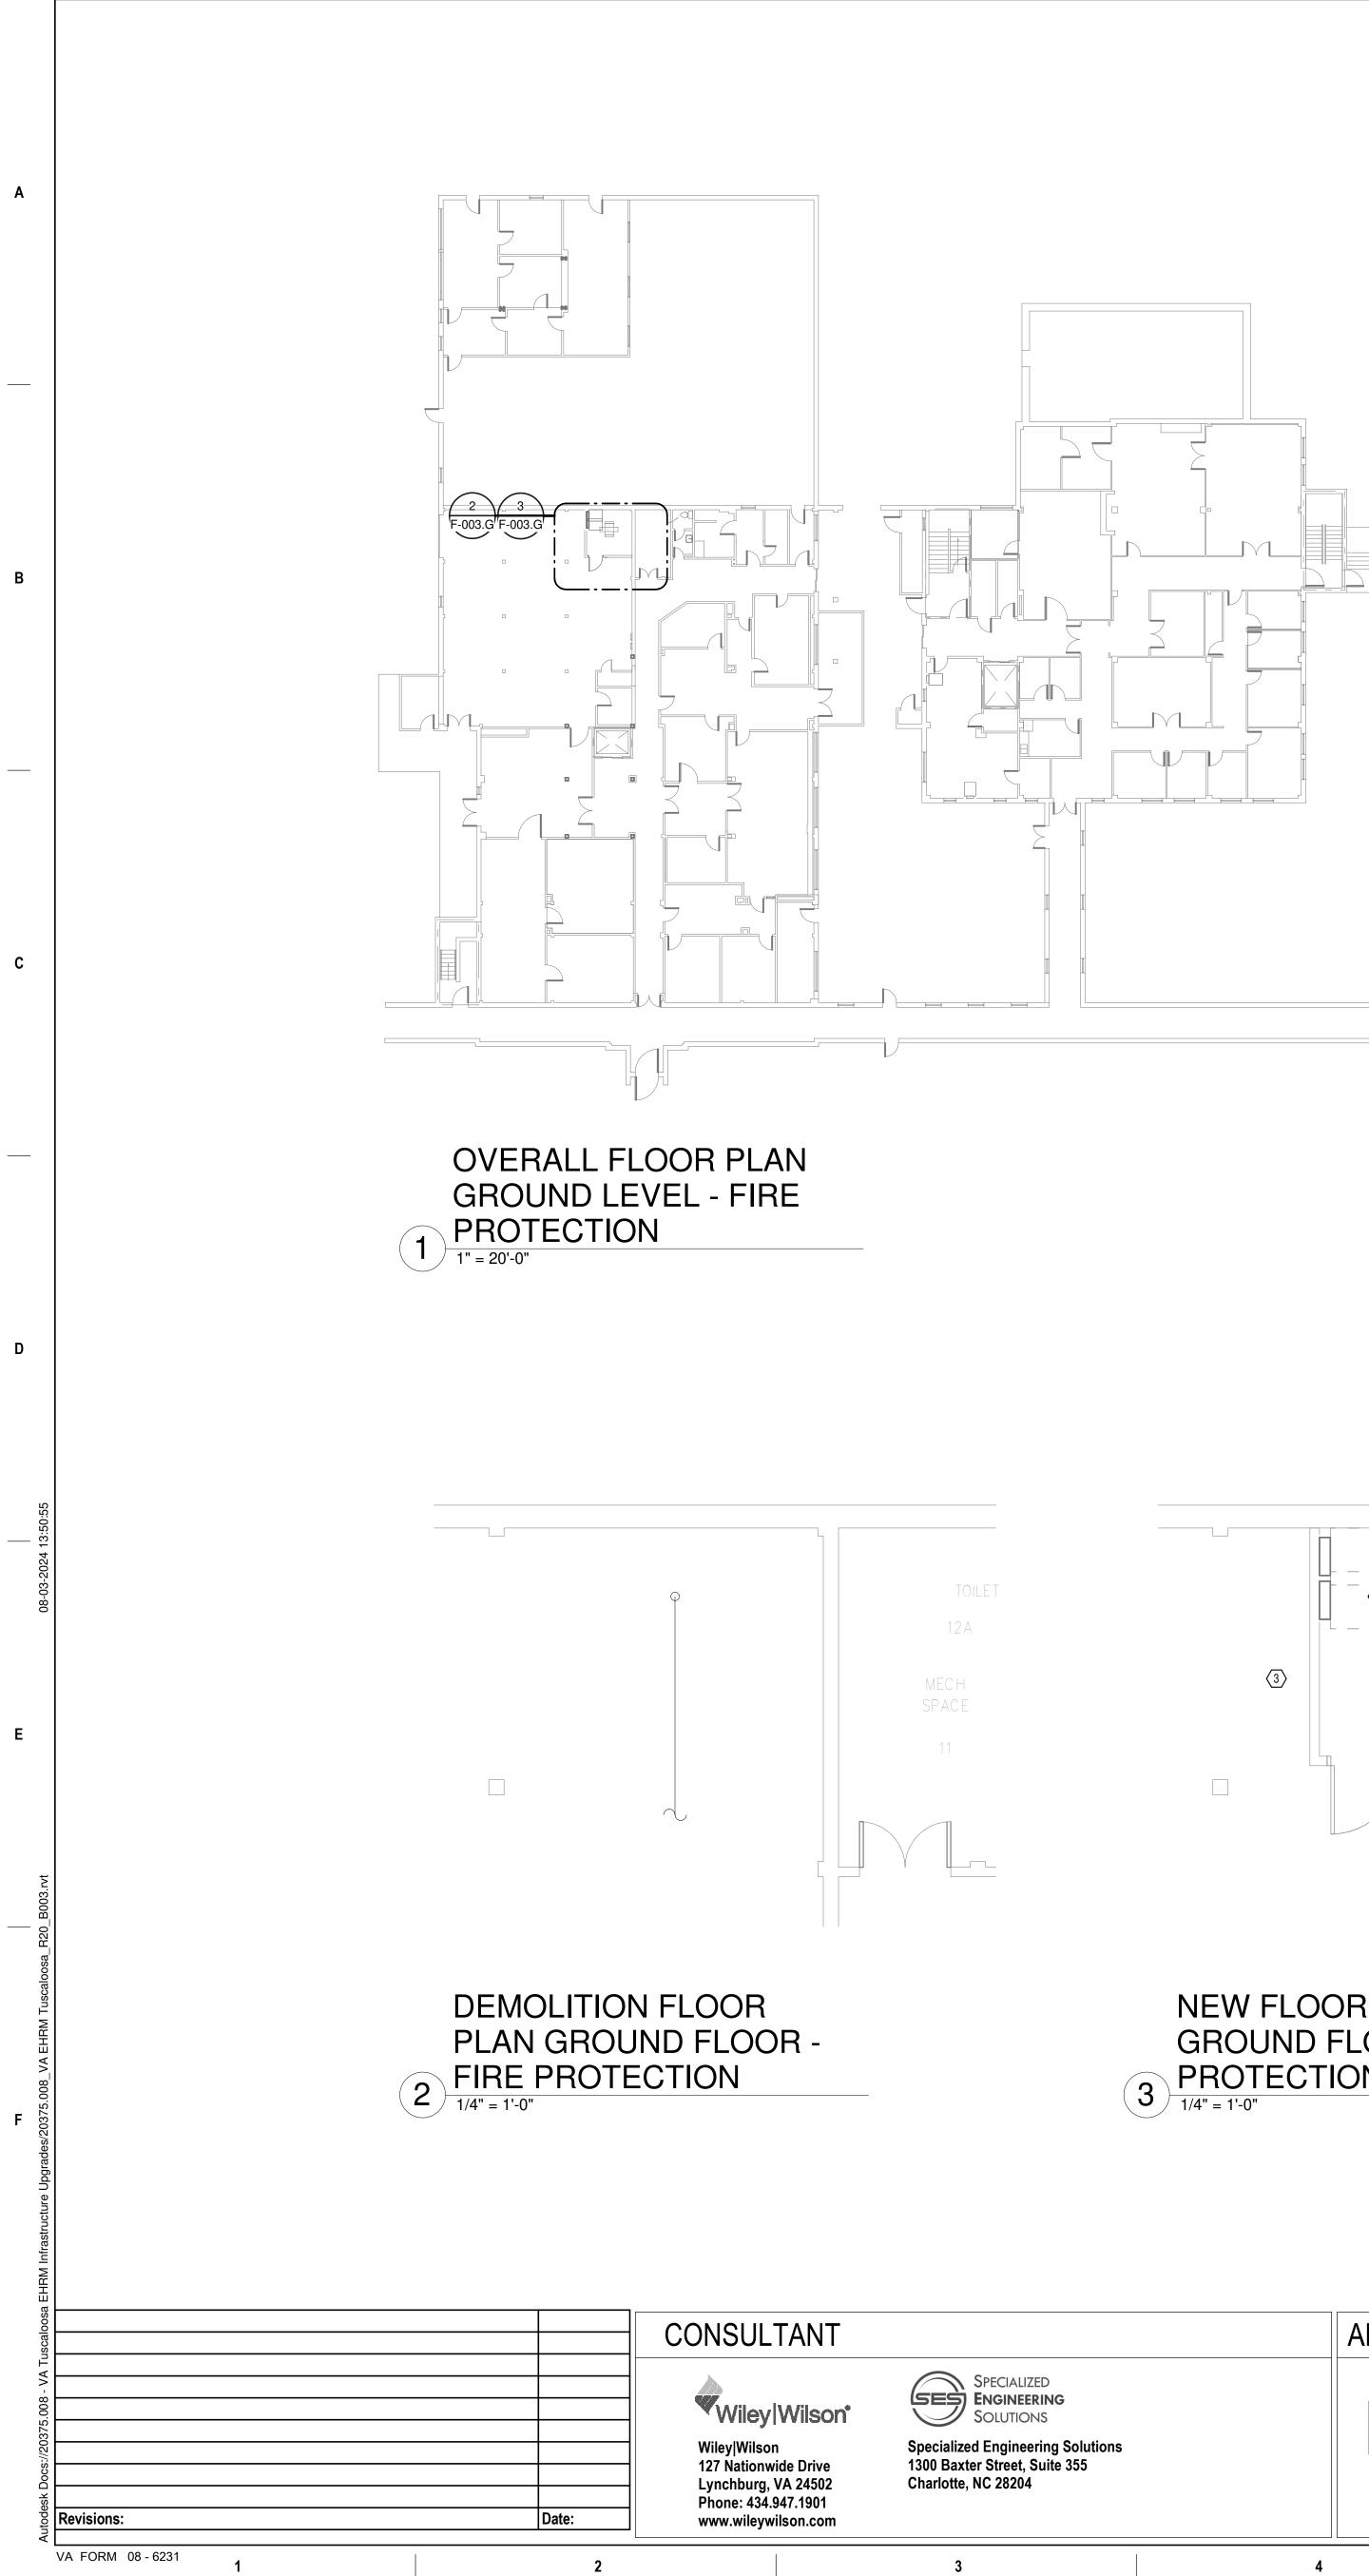
4. AREA OF EXISTING SPRINKLER COVERAGE. HAZARD CLASSIFICATION "LIGHT HAZARD". RELOCATE AND/OR ADD ADDITIONAL HEADS AND PIPING TO MEET COVERAGE REQUIREMENTS PER NFPA 13 AND VA REQUIREMENTS. COORDINATE HEAD LOCATIONS WITH EXISTING CONDITIONS AND ARCHITECT'S CEILING

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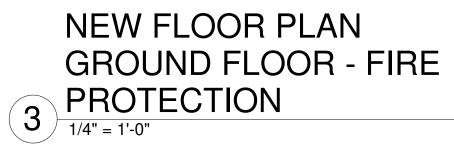
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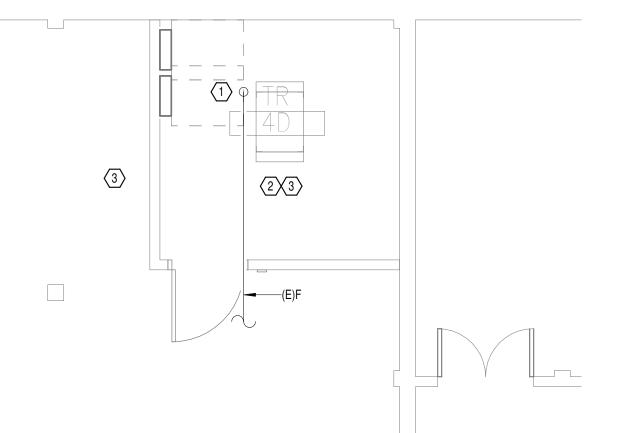
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Atriax G R O U P www.atriaxgroup.com	Atriax, pllc 102 3rd Avenue, NE PO Box 1629, Hickory, NC 28603 Phone: 828.315.9962 Fax: 828.315.9964 NC Engineering License No.: P-0214 NC Architectural License No.: 51254	SEAL 045127 03/08/2024	Const and Fa Manag





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# **GENERAL NOTES:**

- A. COVER SHEET GENERAL NOTES APPLY TO ALL SHEETS.
- PLANS, NEW MECHANICAL SYSTEMS ARE INDICATED WITH HEAVY LINE WEIGHTS.
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### SHEET NOTES:

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- REQUIREMENTS.

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www.atriaxgroup.com	NC Engineering License No.: P-0214 NC Architectural License No.: 51254	G. SHERMAN	<b>VA</b> U.S. Department of Veterans Affairs		FULLY SPRINKLERED	lss 03
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B. ON DEMOLITION PLANS; EXISTING MECHANICAL SYSTEMS TO BE REMOVED ARE SHOWN HATCHED AND/OR DASHED, EXISTING MECHANICAL SYSTEMS TO REMAIN ARE SHOWN LIGHT LINE WEIGHT. ON ALL OTHER C. UNLESS NOTED OTHERWISE, DETAILS SHOWN WITHIN THESE DOCUMENTS ARE APPLICABLE FOR ALL PIPING, EQUIPMENT AND DUCTWORK INSTALLATIONS WHETHER OR NOT SPECIFICALLY NOTED.

1. EXISTING SPRINKLER HEAD SHALL REMAIN. INSTALL NEW MECHANICAL GUARDS. VERIFY COVERAGE

2. SPRINKLER PIPING SHALL NOT BE ROUTED ABOVE EQUIPMENT RACKS OR ELECTRICAL PANELS. 3. AREA OF EXISTING SPRINKLER COVERAGE. HAZARD CLASSIFICATION "LIGHT HAZARD". RELOCATE AND/OR ADD ADDITIONAL HEADS AND PIPING TO MEET COVERAGE REQUIREMENTS PER NFPA 13 AND VA REQUIREMENTS. COORDINATE HEAD LOCATIONS WITH EXISTING CONDITIONS AND ARCHITECT'S CEILING

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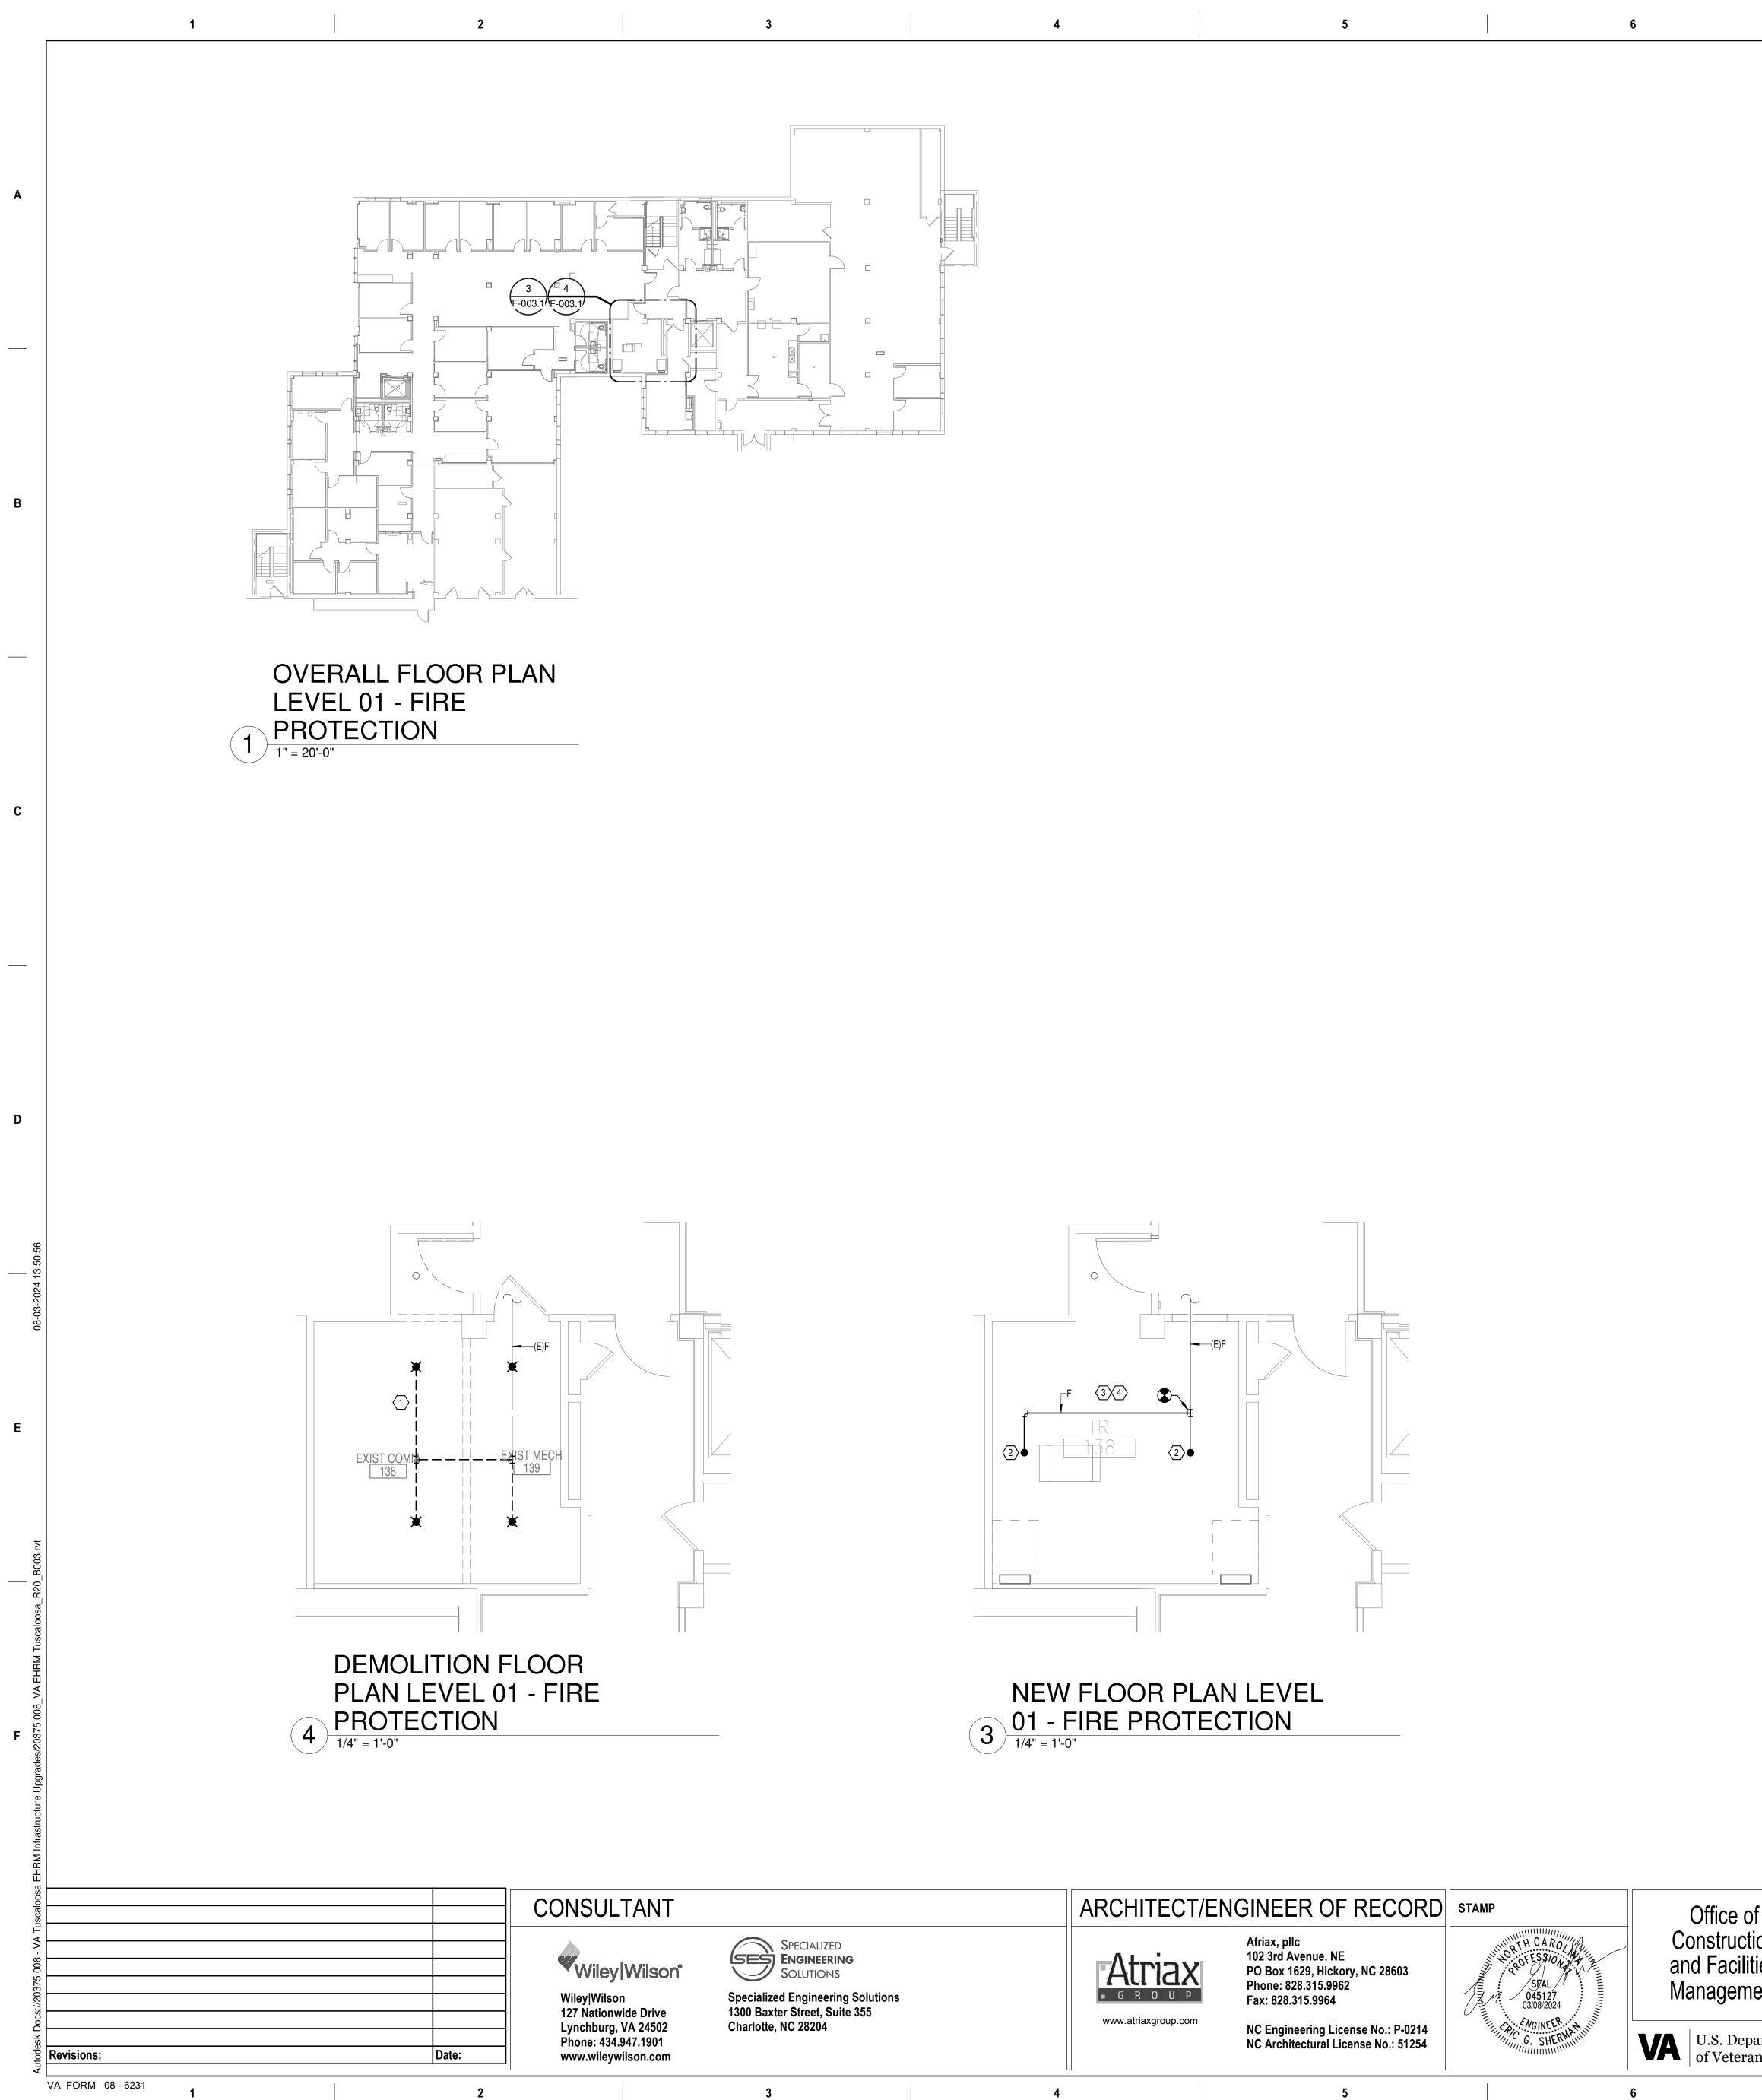
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# **GENERAL NOTES:**

- A. COVER SHEET GENERAL NOTES APPLY TO ALL SHEETS.
- PLANS, NEW MECHANICAL SYSTEMS ARE INDICATED WITH HEAVY LINE WEIGHTS.
- PERFORM THIS WORK.

### SHEET NOTES:

- SPRINKLER OUTAGE IN THE ROOM.
- SHALL OCCUR AT THE SAME TIME TO AVOID A SPRINKLER OUTAGE IN THE ROOM.
- ADD ADDITIONAL HEADS AND PIPING TO MEET COVERAGE REQUIREMENTS PER NFPA 13 AND VA REQUIREMENTS. COORDINATE HEAD LOCATIONS WITH EXISTING CONDITIONS AND ARCHITECT'S CEILING PLANS.



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2. INSTALL NEW UPRIGHT SPRINKLER HEADS WITH MECHANICAL GUARDS TO SERVE 138. VERIFY COVERAGE REQUIREMENTS. REPLACEMENT OF THE EXISTING PENDENT SPRINKLER WITH NEW UPRIGHT SPRINKLER 3. SPRINKLER PIPING SHALL NOT BE ROUTED ABOVE EQUIPMENT RACKS OR ELECTRICAL PANELS. 4. AREA OF EXISTING SPRINKLER COVERAGE. HAZARD CLASSIFICATION "LIGHT HAZARD". RELOCATE AND/OR

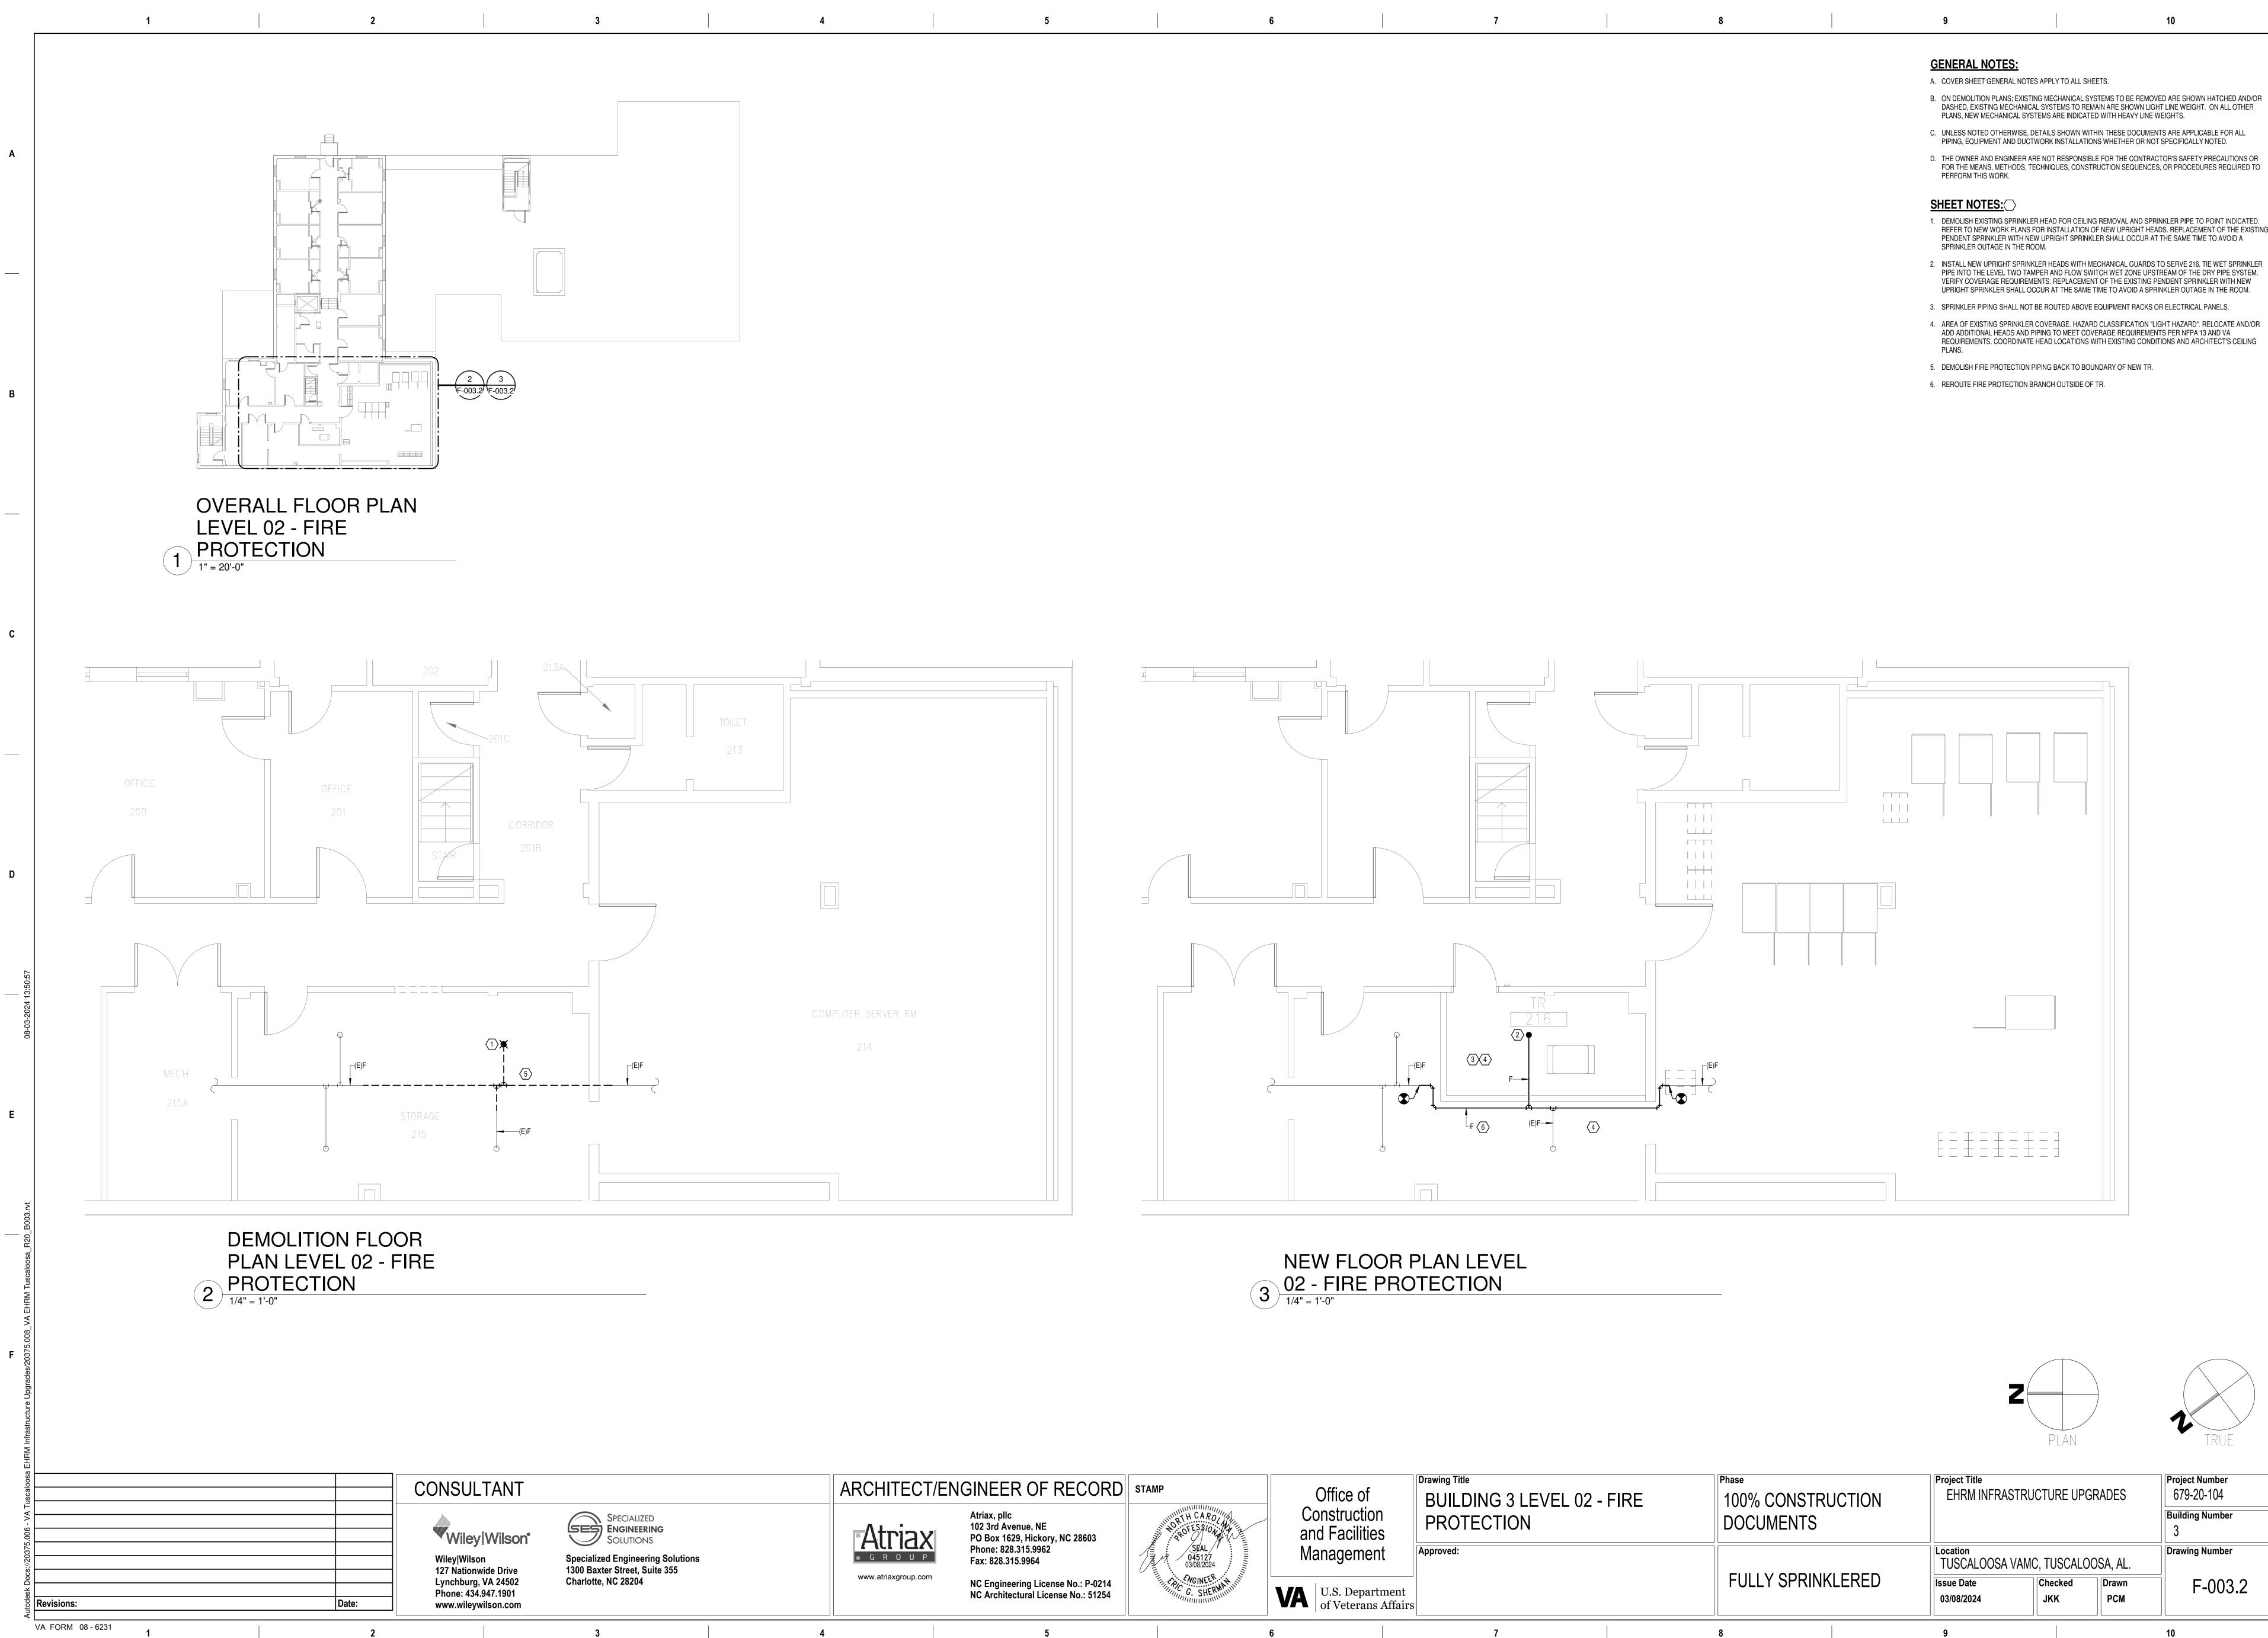
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- PLANS, NEW MECHANICAL SYSTEMS ARE INDICATED WITH HEAVY LINE WEIGHTS.

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DASHED, EXISTING MECHANICAL SYSTEMS TO REMAIN ARE SHOWN LIGHT LINE WEIGHT. ON ALL OTHER C. UNLESS NOTED OTHERWISE, DETAILS SHOWN WITHIN THESE DOCUMENTS ARE APPLICABLE FOR ALL PIPING, EQUIPMENT AND DUCTWORK INSTALLATIONS WHETHER OR NOT SPECIFICALLY NOTED. D. THE OWNER AND ENGINEER ARE NOT RESPONSIBLE FOR THE CONTRACTOR'S SAFETY PRECAUTIONS OR FOR THE MEANS, METHODS, TECHNIQUES, CONSTRUCTION SEQUENCES, OR PROCEDURES REQUIRED TO

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2. INSTALL NEW UPRIGHT SPRINKLER HEADS WITH MECHANICAL GUARDS TO SERVE 216. TIE WET SPRINKLER PIPE INTO THE LEVEL TWO TAMPER AND FLOW SWITCH WET ZONE UPSTREAM OF THE DRY PIPE SYSTEM. VERIFY COVERAGE REQUIREMENTS. REPLACEMENT OF THE EXISTING PENDENT SPRINKLER WITH NEW UPRIGHT SPRINKLER SHALL OCCUR AT THE SAME TIME TO AVOID A SPRINKLER OUTAGE IN THE ROOM. 3. SPRINKLER PIPING SHALL NOT BE ROUTED ABOVE EQUIPMENT RACKS OR ELECTRICAL PANELS.

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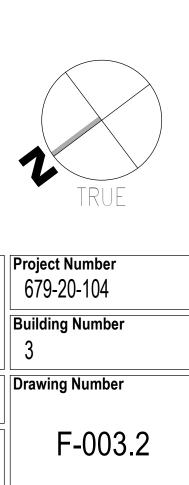
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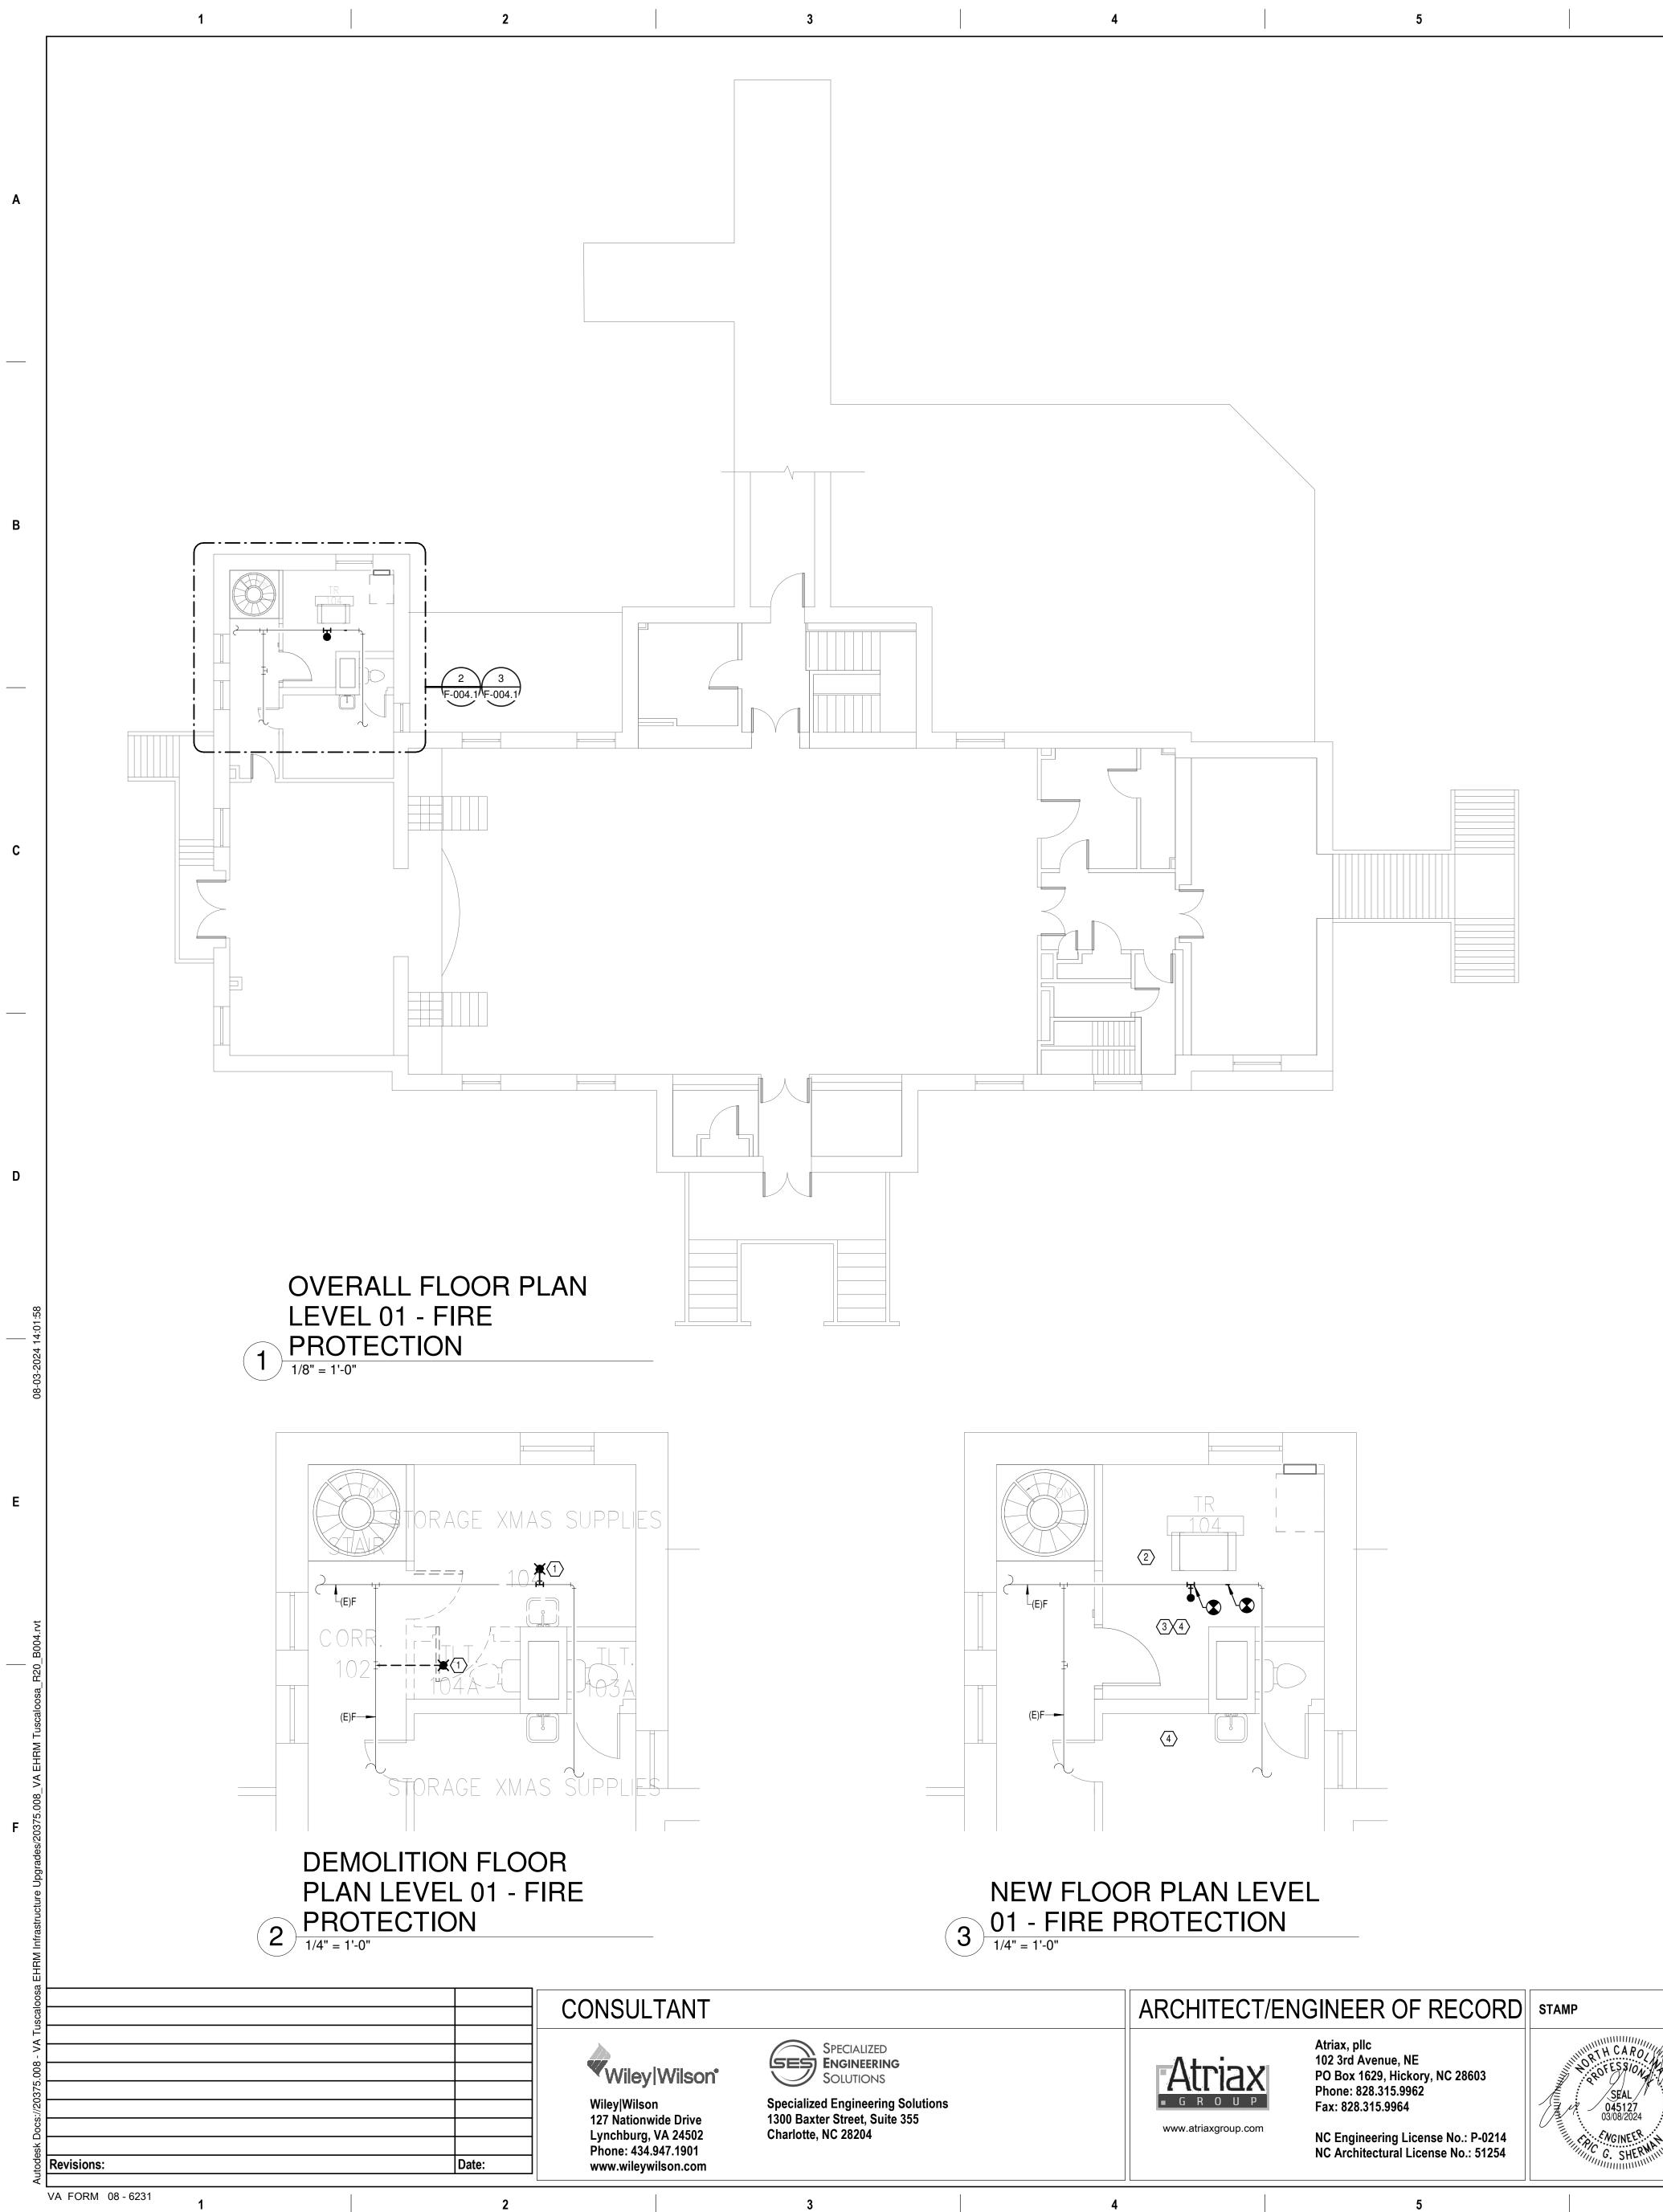
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# **GENERAL NOTES:**

- A. COVER SHEET GENERAL NOTES APPLY TO ALL SHEETS.
- PLANS, NEW MECHANICAL SYSTEMS ARE INDICATED WITH HEAVY LINE WEIGHTS.
- PERFORM THIS WORK.

### SHEET NOTES:

- SPRINKLER OUTAGE IN THE ROOM.
- SHALL OCCUR AT THE SAME TIME TO AVOID A SPRINKLER OUTAGE IN THE ROOM.
- ADD ADDITIONAL HEADS AND PIPING TO MEET COVERAGE REQUIREMENTS PER NFPA 13 AND VA REQUIREMENTS. COORDINATE HEAD LOCATIONS WITH EXISTING CONDITIONS AND ARCHITECT'S CEILING PLANS.

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ment	Approved:			LOOSA VAMC, TUSC
epartment erans Affairs		FULLY SPRINKL	ERED Issue Date 03/08/202	
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B. ON DEMOLITION PLANS; EXISTING MECHANICAL SYSTEMS TO BE REMOVED ARE SHOWN HATCHED AND/OR DASHED, EXISTING MECHANICAL SYSTEMS TO REMAIN ARE SHOWN LIGHT LINE WEIGHT. ON ALL OTHER C. UNLESS NOTED OTHERWISE, DETAILS SHOWN WITHIN THESE DOCUMENTS ARE APPLICABLE FOR ALL PIPING, EQUIPMENT AND DUCTWORK INSTALLATIONS WHETHER OR NOT SPECIFICALLY NOTED. D. THE OWNER AND ENGINEER ARE NOT RESPONSIBLE FOR THE CONTRACTOR'S SAFETY PRECAUTIONS OR FOR THE MEANS, METHODS, TECHNIQUES, CONSTRUCTION SEQUENCES, OR PROCEDURES REQUIRED TO

1. DEMOLISH EXISTING SPRINKLER HEAD FOR CEILING REMOVAL AND SPRINKLER PIPE TO POINT INDICATED. REFER TO NEW WORK PLANS FOR INSTALLATION OF NEW UPRIGHT HEADS. REPLACEMENT OF THE EXISTING PENDENT SPRINKLER WITH NEW UPRIGHT SPRINKLER SHALL OCCUR AT THE SAME TIME TO AVOID A

2. INSTALL NEW UPRIGHT SPRINKLER HEADS WITH MECHANICAL GUARDS TO SERVE 104. VERIFY COVERAGE REQUIREMENTS. REPLACEMENT OF THE EXISTING PENDENT SPRINKLER WITH NEW UPRIGHT SPRINKLER 3. SPRINKLER PIPING SHALL NOT BE ROUTED ABOVE EQUIPMENT RACKS OR ELECTRICAL PANELS. 4. AREA OF EXISTING SPRINKLER COVERAGE. HAZARD CLASSIFICATION "LIGHT HAZARD". RELOCATE AND/OR

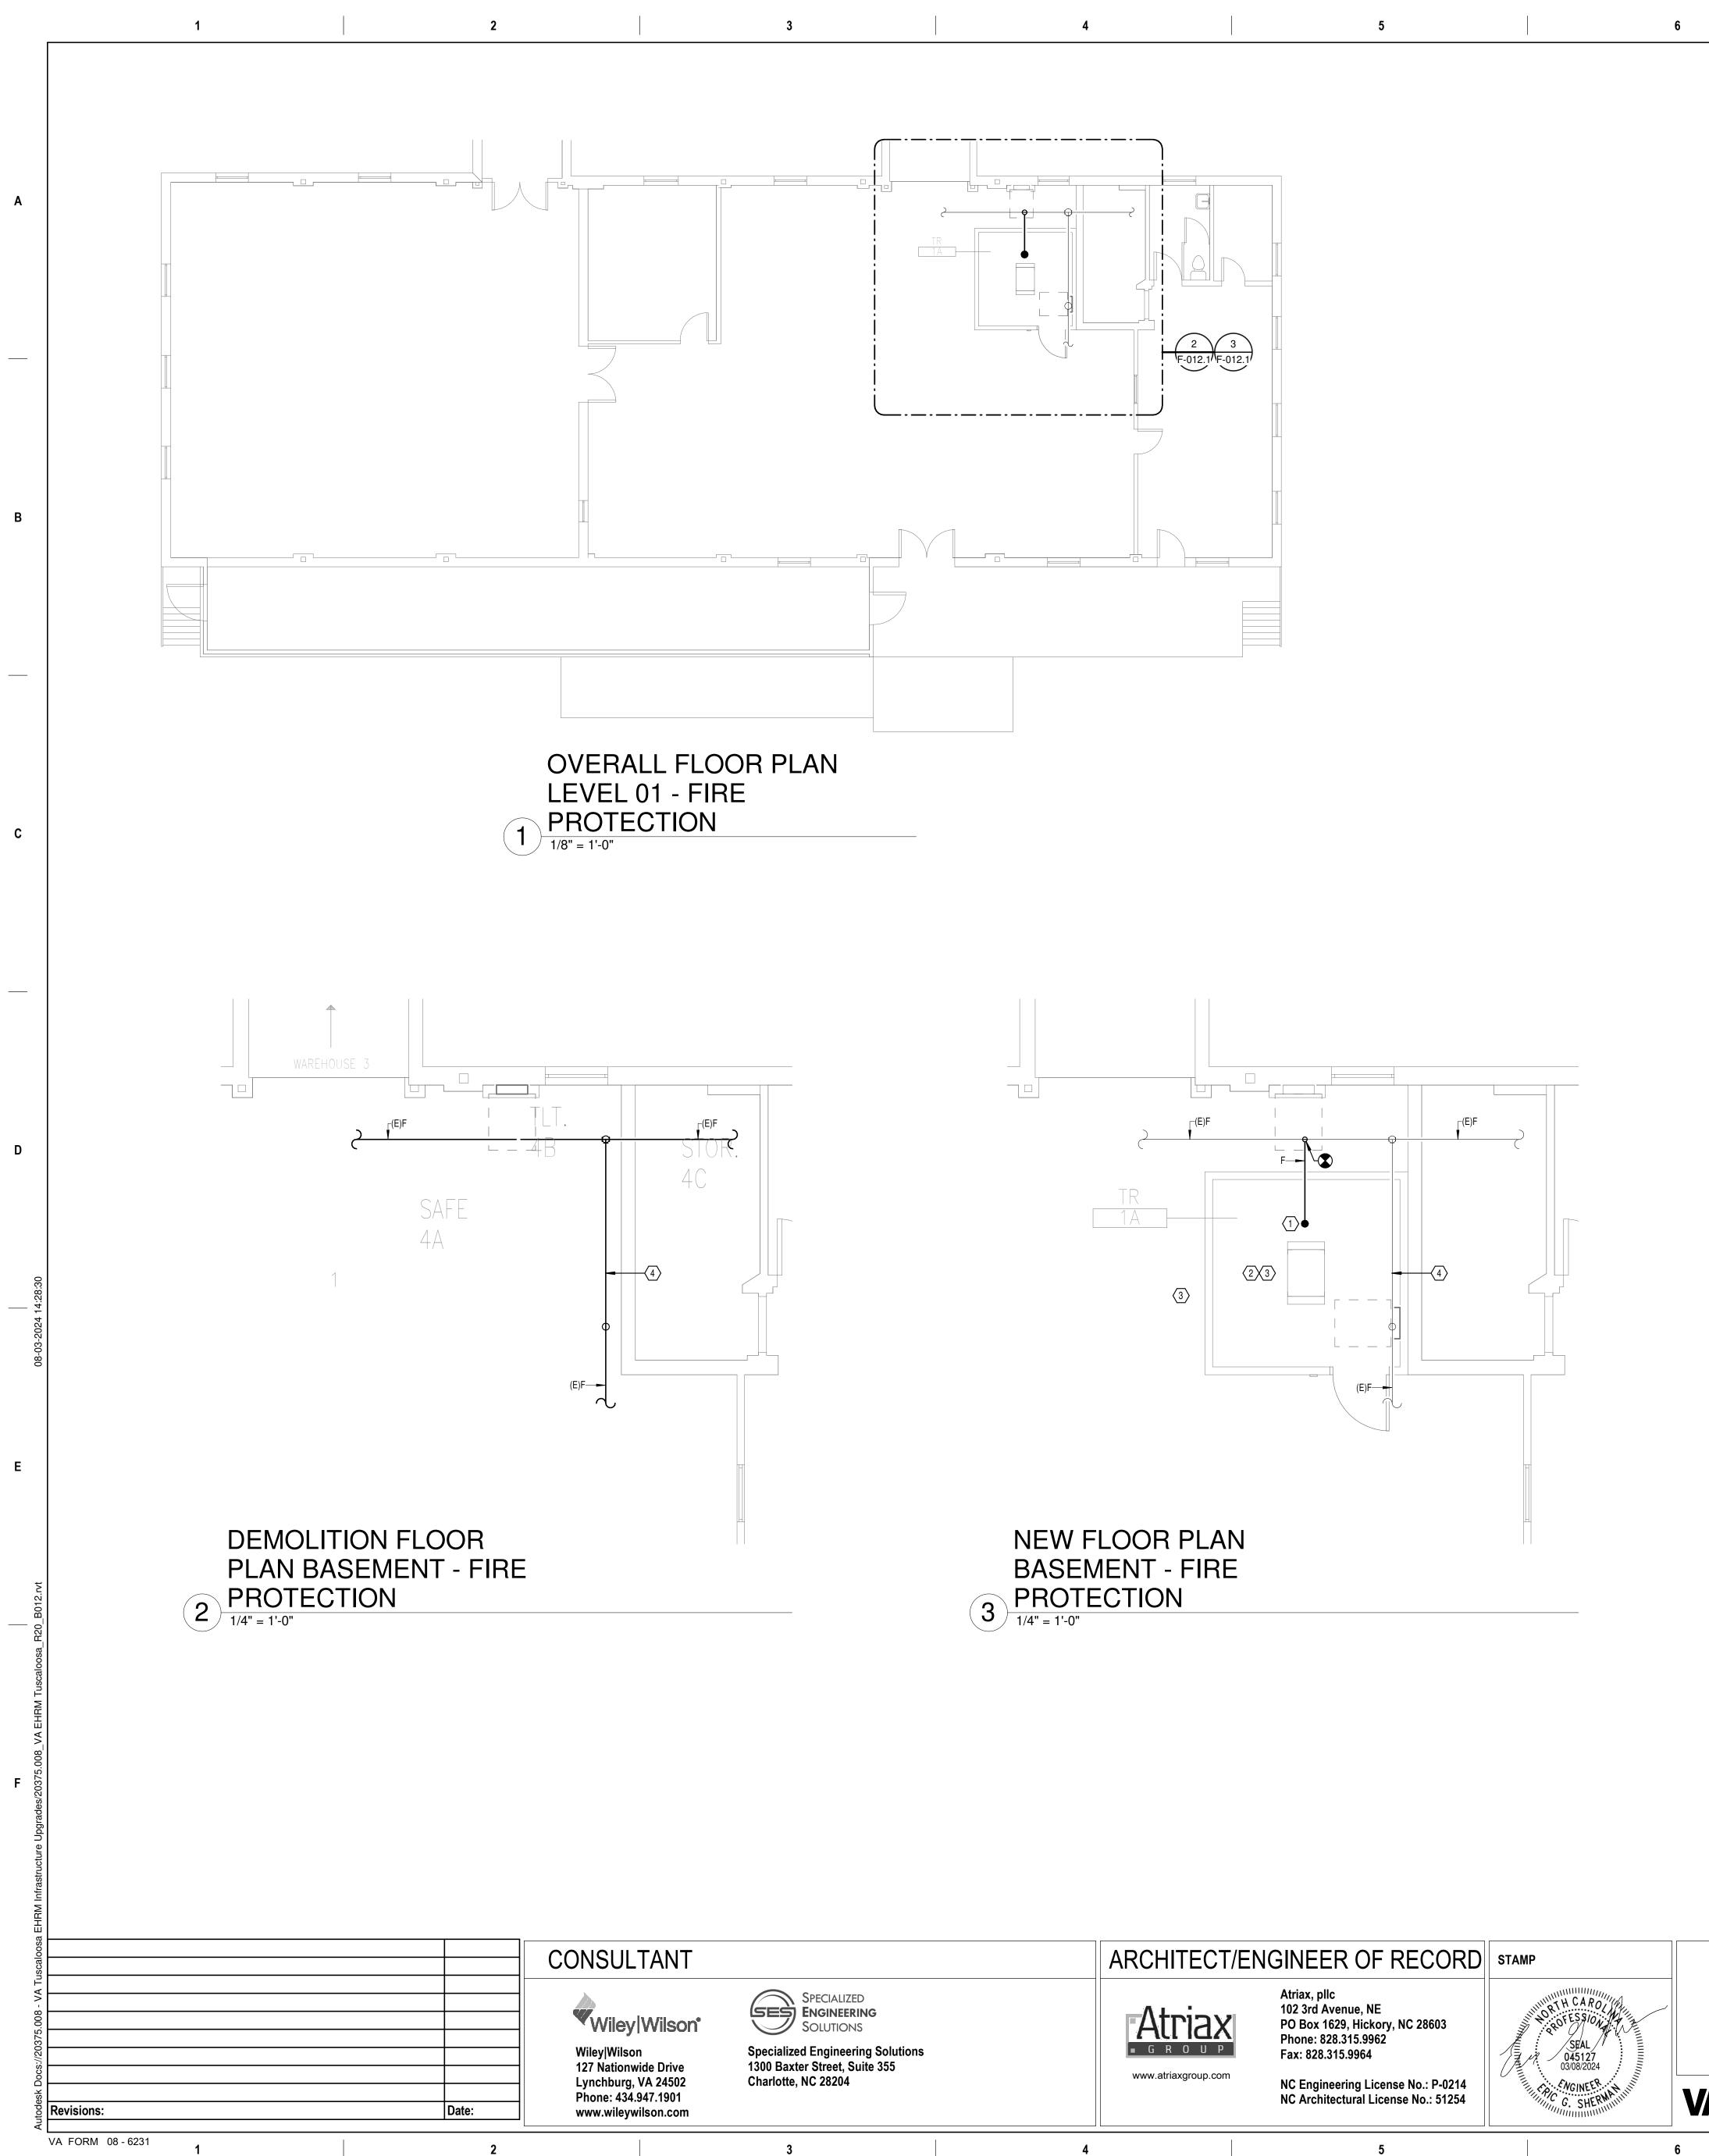
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	www.atriaxgroup.com	NC Engineering License No.: P-0214 NC Architectural License No.: 51254	C. SHERMANIUM	VA U.S. Dep of Vetera
		Atriax, pllc 102 3rd Avenue, NE PO Box 1629, Hickory, NC 28603 Phone: 828.315.9962 Fax: 828.315.9964	SEAL 045127 03/08/2024	Construct and Facili Managem
	ARCHITECT/E	NGINEER OF RECORD	STAMP	Office o

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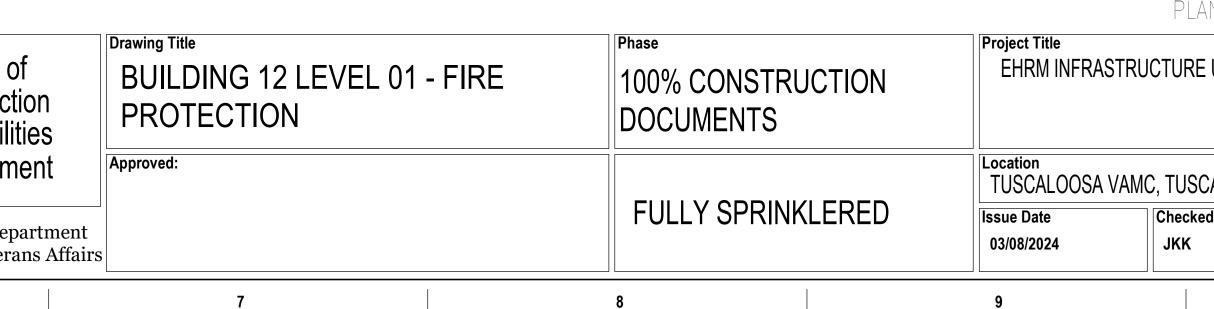
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# **GENERAL NOTES:**

- A. COVER SHEET GENERAL NOTES APPLY TO ALL SHEETS.
- PLANS, NEW MECHANICAL SYSTEMS ARE INDICATED WITH HEAVY LINE WEIGHTS.
- D. THE OWNER AND ENGINEER ARE NOT RESPONSIBLE FOR THE CONTRACTOR'S SAFETY PRECAUTIONS OR FOR THE MEANS, METHODS, TECHNIQUES, CONSTRUCTION SEQUENCES, OR PROCEDURES REQUIRED TO PERFORM THIS WORK.

### SHEET NOTES:

- REQUIREMENTS.
- PLANS.
- 4. EXISTING SPRINKLER PIPING IS ROUTED TIGHT TO STRUCTURE ABOVE.



B. ON DEMOLITION PLANS; EXISTING MECHANICAL SYSTEMS TO BE REMOVED ARE SHOWN HATCHED AND/OR DASHED, EXISTING MECHANICAL SYSTEMS TO REMAIN ARE SHOWN LIGHT LINE WEIGHT. ON ALL OTHER C. UNLESS NOTED OTHERWISE, DETAILS SHOWN WITHIN THESE DOCUMENTS ARE APPLICABLE FOR ALL PIPING, EQUIPMENT AND DUCTWORK INSTALLATIONS WHETHER OR NOT SPECIFICALLY NOTED.

1. INSTALL NEW UPRIGHT SPRINKLER HEADS WITH MECHANICAL GUARDS TO SERVE 1A. VERIFY COVERAGE

2. SPRINKLER PIPING SHALL NOT BE ROUTED ABOVE EQUIPMENT RACKS OR ELECTRICAL PANELS.

3. AREA OF EXISTING SPRINKLER COVERAGE. HAZARD CLASSIFICATION "LIGHT HAZARD". RELOCATE AND/OR ADD ADDITIONAL HEADS AND PIPING TO MEET COVERAGE REQUIREMENTS PER NFPA 13 AND VA REQUIREMENTS. COORDINATE HEAD LOCATIONS WITH EXISTING CONDITIONS AND ARCHITECT'S CEILING

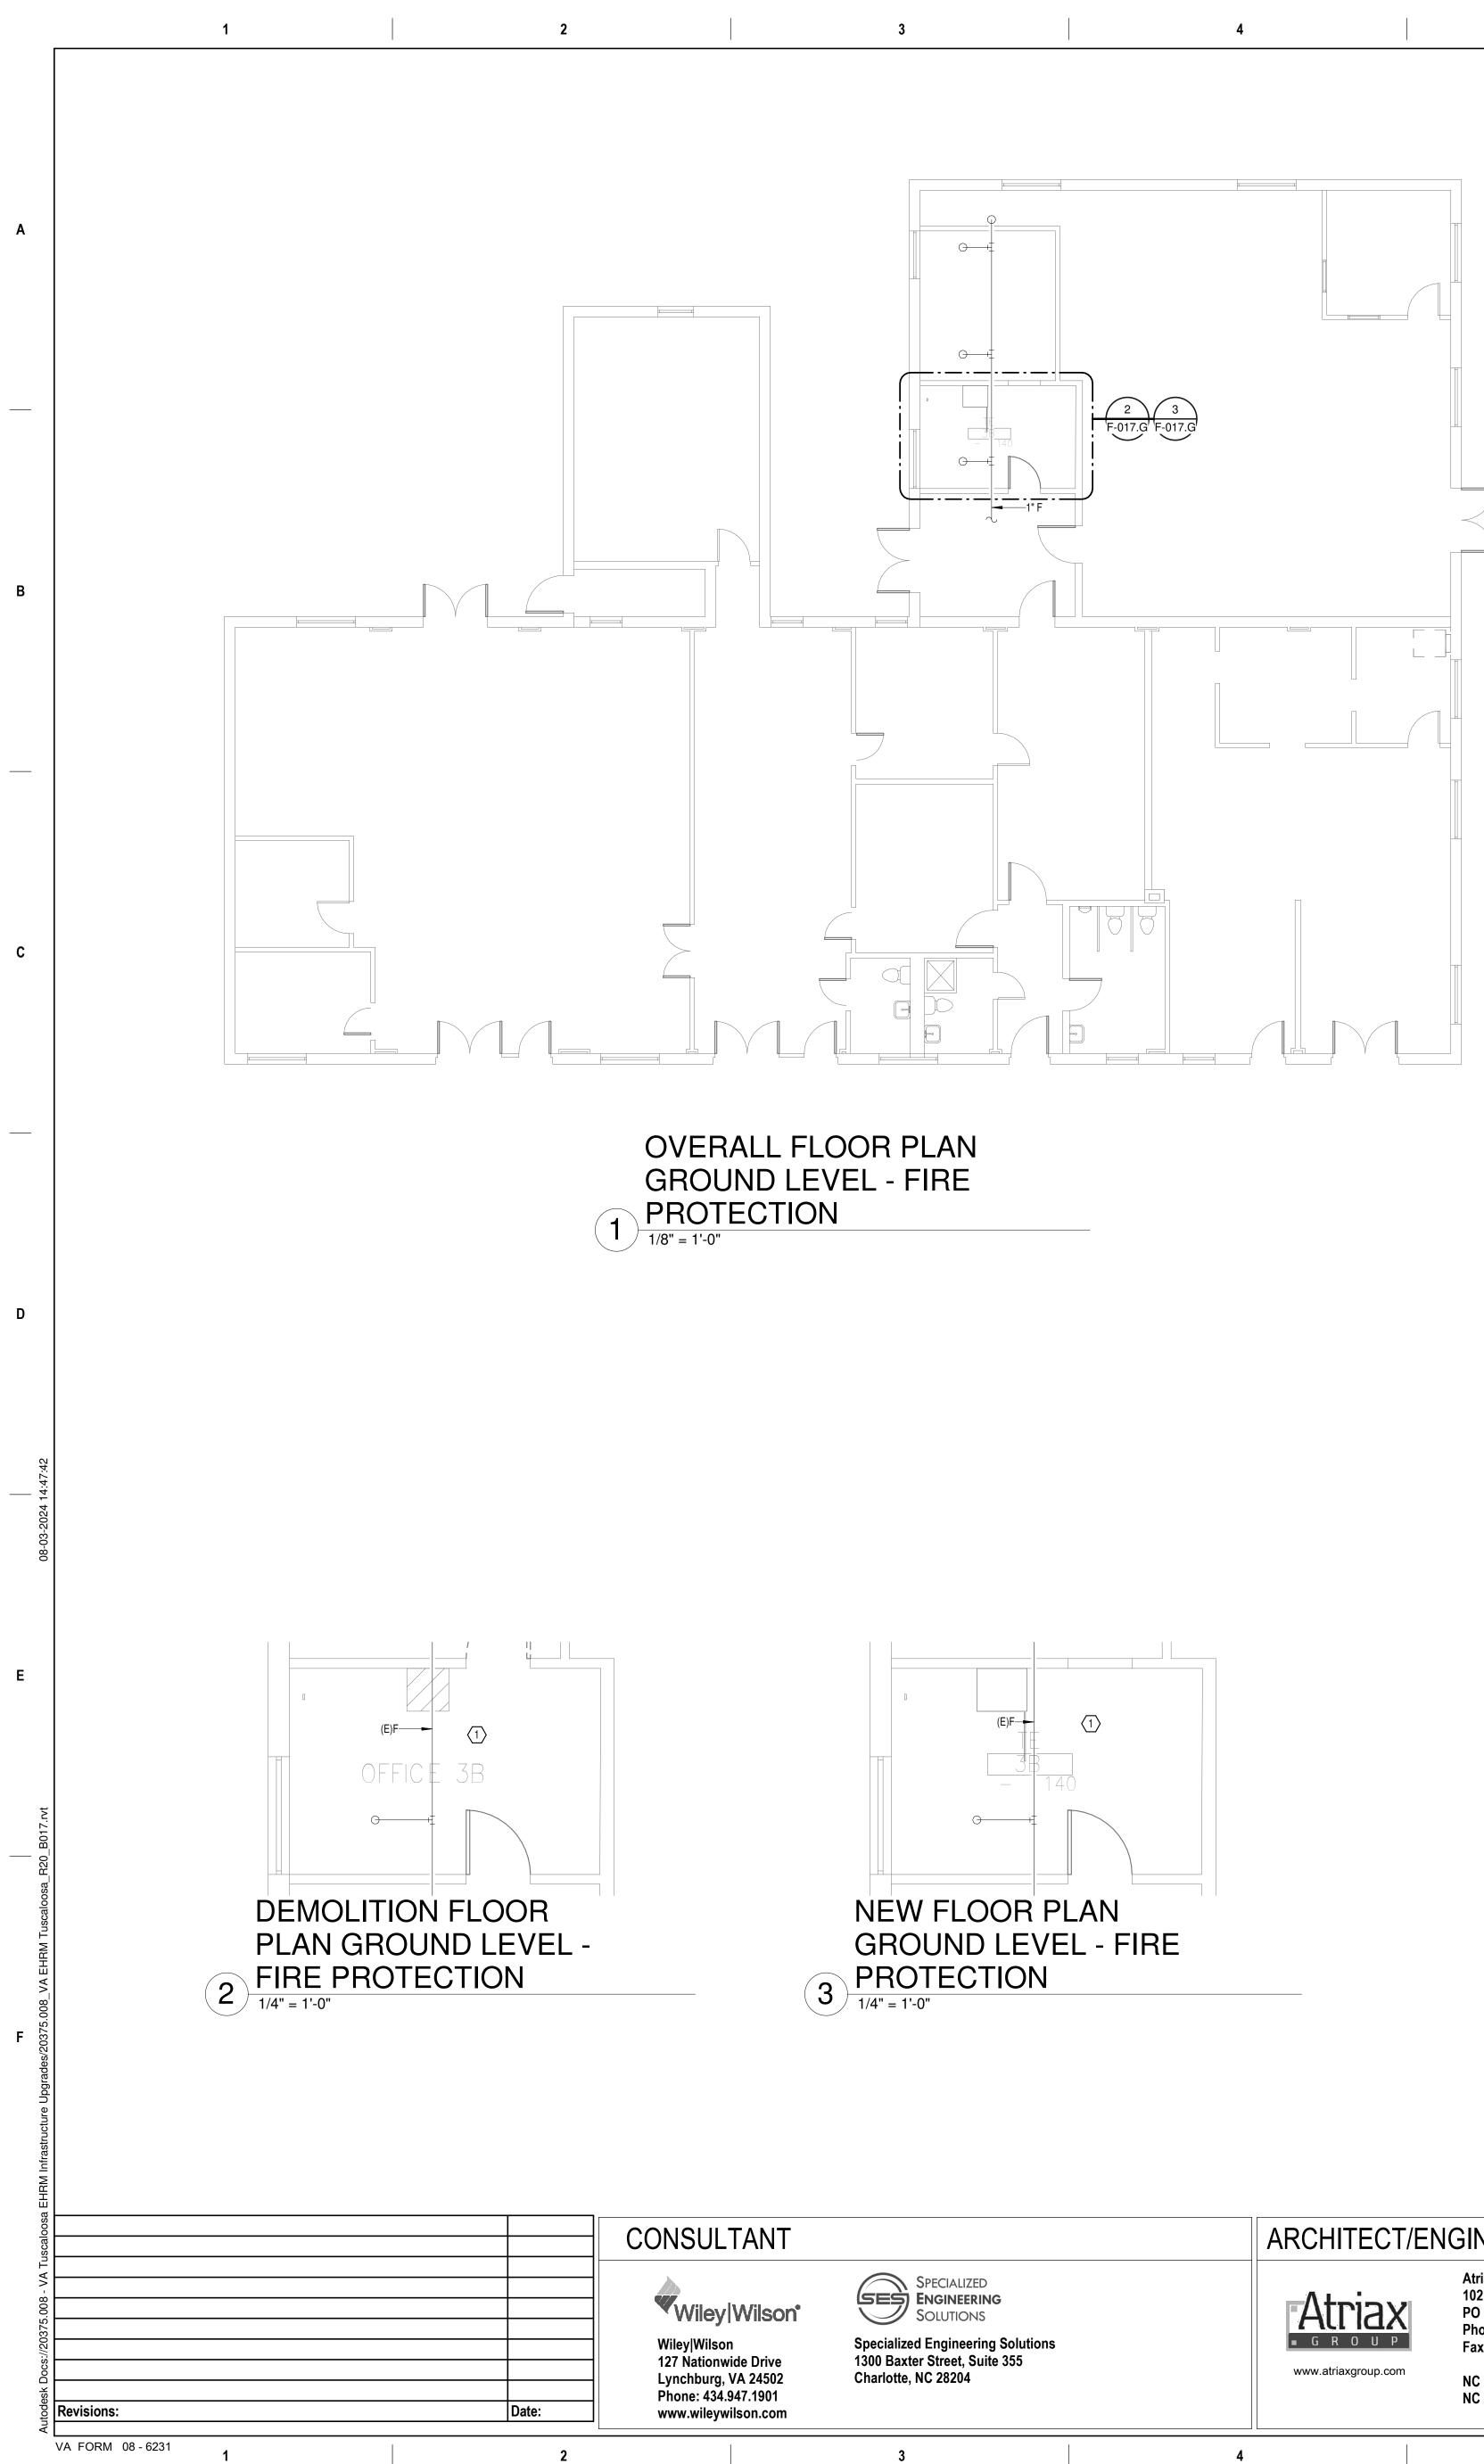
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USCALOO	SA, AL.	Drawing Number		
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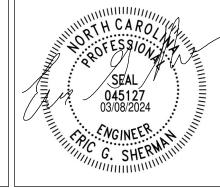


# ARCHITECT/ENGINEER OF RECORD STAMP

Atriax, pllc 102 3rd Avenue, NE PO Box 1629, Hickory, NC 28603 Phone: 828.315.9962 Fax: 828.315.9964

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NC Engineering License No.: P-0214 NC Architectural License No.: 51254

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# **GENERAL NOTES:**

- A. COVER SHEET GENERAL NOTES APPLY TO ALL SHEETS.
- PLANS, NEW MECHANICAL SYSTEMS ARE INDICATED WITH HEAVY LINE WEIGHTS.
- PERFORM THIS WORK.

SHEET NOTES:

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/	Office of Construction and Facilities	Drawing Title BUILDING 17 GF FIRE PROTECTI	Phase 100% C DOCUM	ONSTRUCTION IENTS	Project Title EHRM INFRAST	RUCTURE UP
	ManagementVAU.S. Department of Veterans Affairs	Approved:	FULLY	SPRINKLERED	Location TUSCALOOSA V/ Issue Date 03/08/2024	AMC, TUSCAL Checked јкк
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B. ON DEMOLITION PLANS; EXISTING MECHANICAL SYSTEMS TO BE REMOVED ARE SHOWN HATCHED AND/OR DASHED, EXISTING MECHANICAL SYSTEMS TO REMAIN ARE SHOWN LIGHT LINE WEIGHT. ON ALL OTHER C. UNLESS NOTED OTHERWISE, DETAILS SHOWN WITHIN THESE DOCUMENTS ARE APPLICABLE FOR ALL PIPING, EQUIPMENT AND DUCTWORK INSTALLATIONS WHETHER OR NOT SPECIFICALLY NOTED. D. THE OWNER AND ENGINEER ARE NOT RESPONSIBLE FOR THE CONTRACTOR'S SAFETY PRECAUTIONS OR FOR THE MEANS, METHODS, TECHNIQUES, CONSTRUCTION SEQUENCES, OR PROCEDURES REQUIRED TO

1. AREA OF EXISTING SPRINKLER COVERAGE. HAZARD CLASSIFICATION "LIGHT HAZARD". RELOCATE AND/OR ADD ADDITIONAL HEADS AND PIPING TO MEET COVERAGE REQUIREMENTS PER NFPA 13 AND VA REQUIREMENTS. COORDINATE HEAD LOCATIONS WITH EXISTING CONDITIONS AND ARCHITECT'S CEILING

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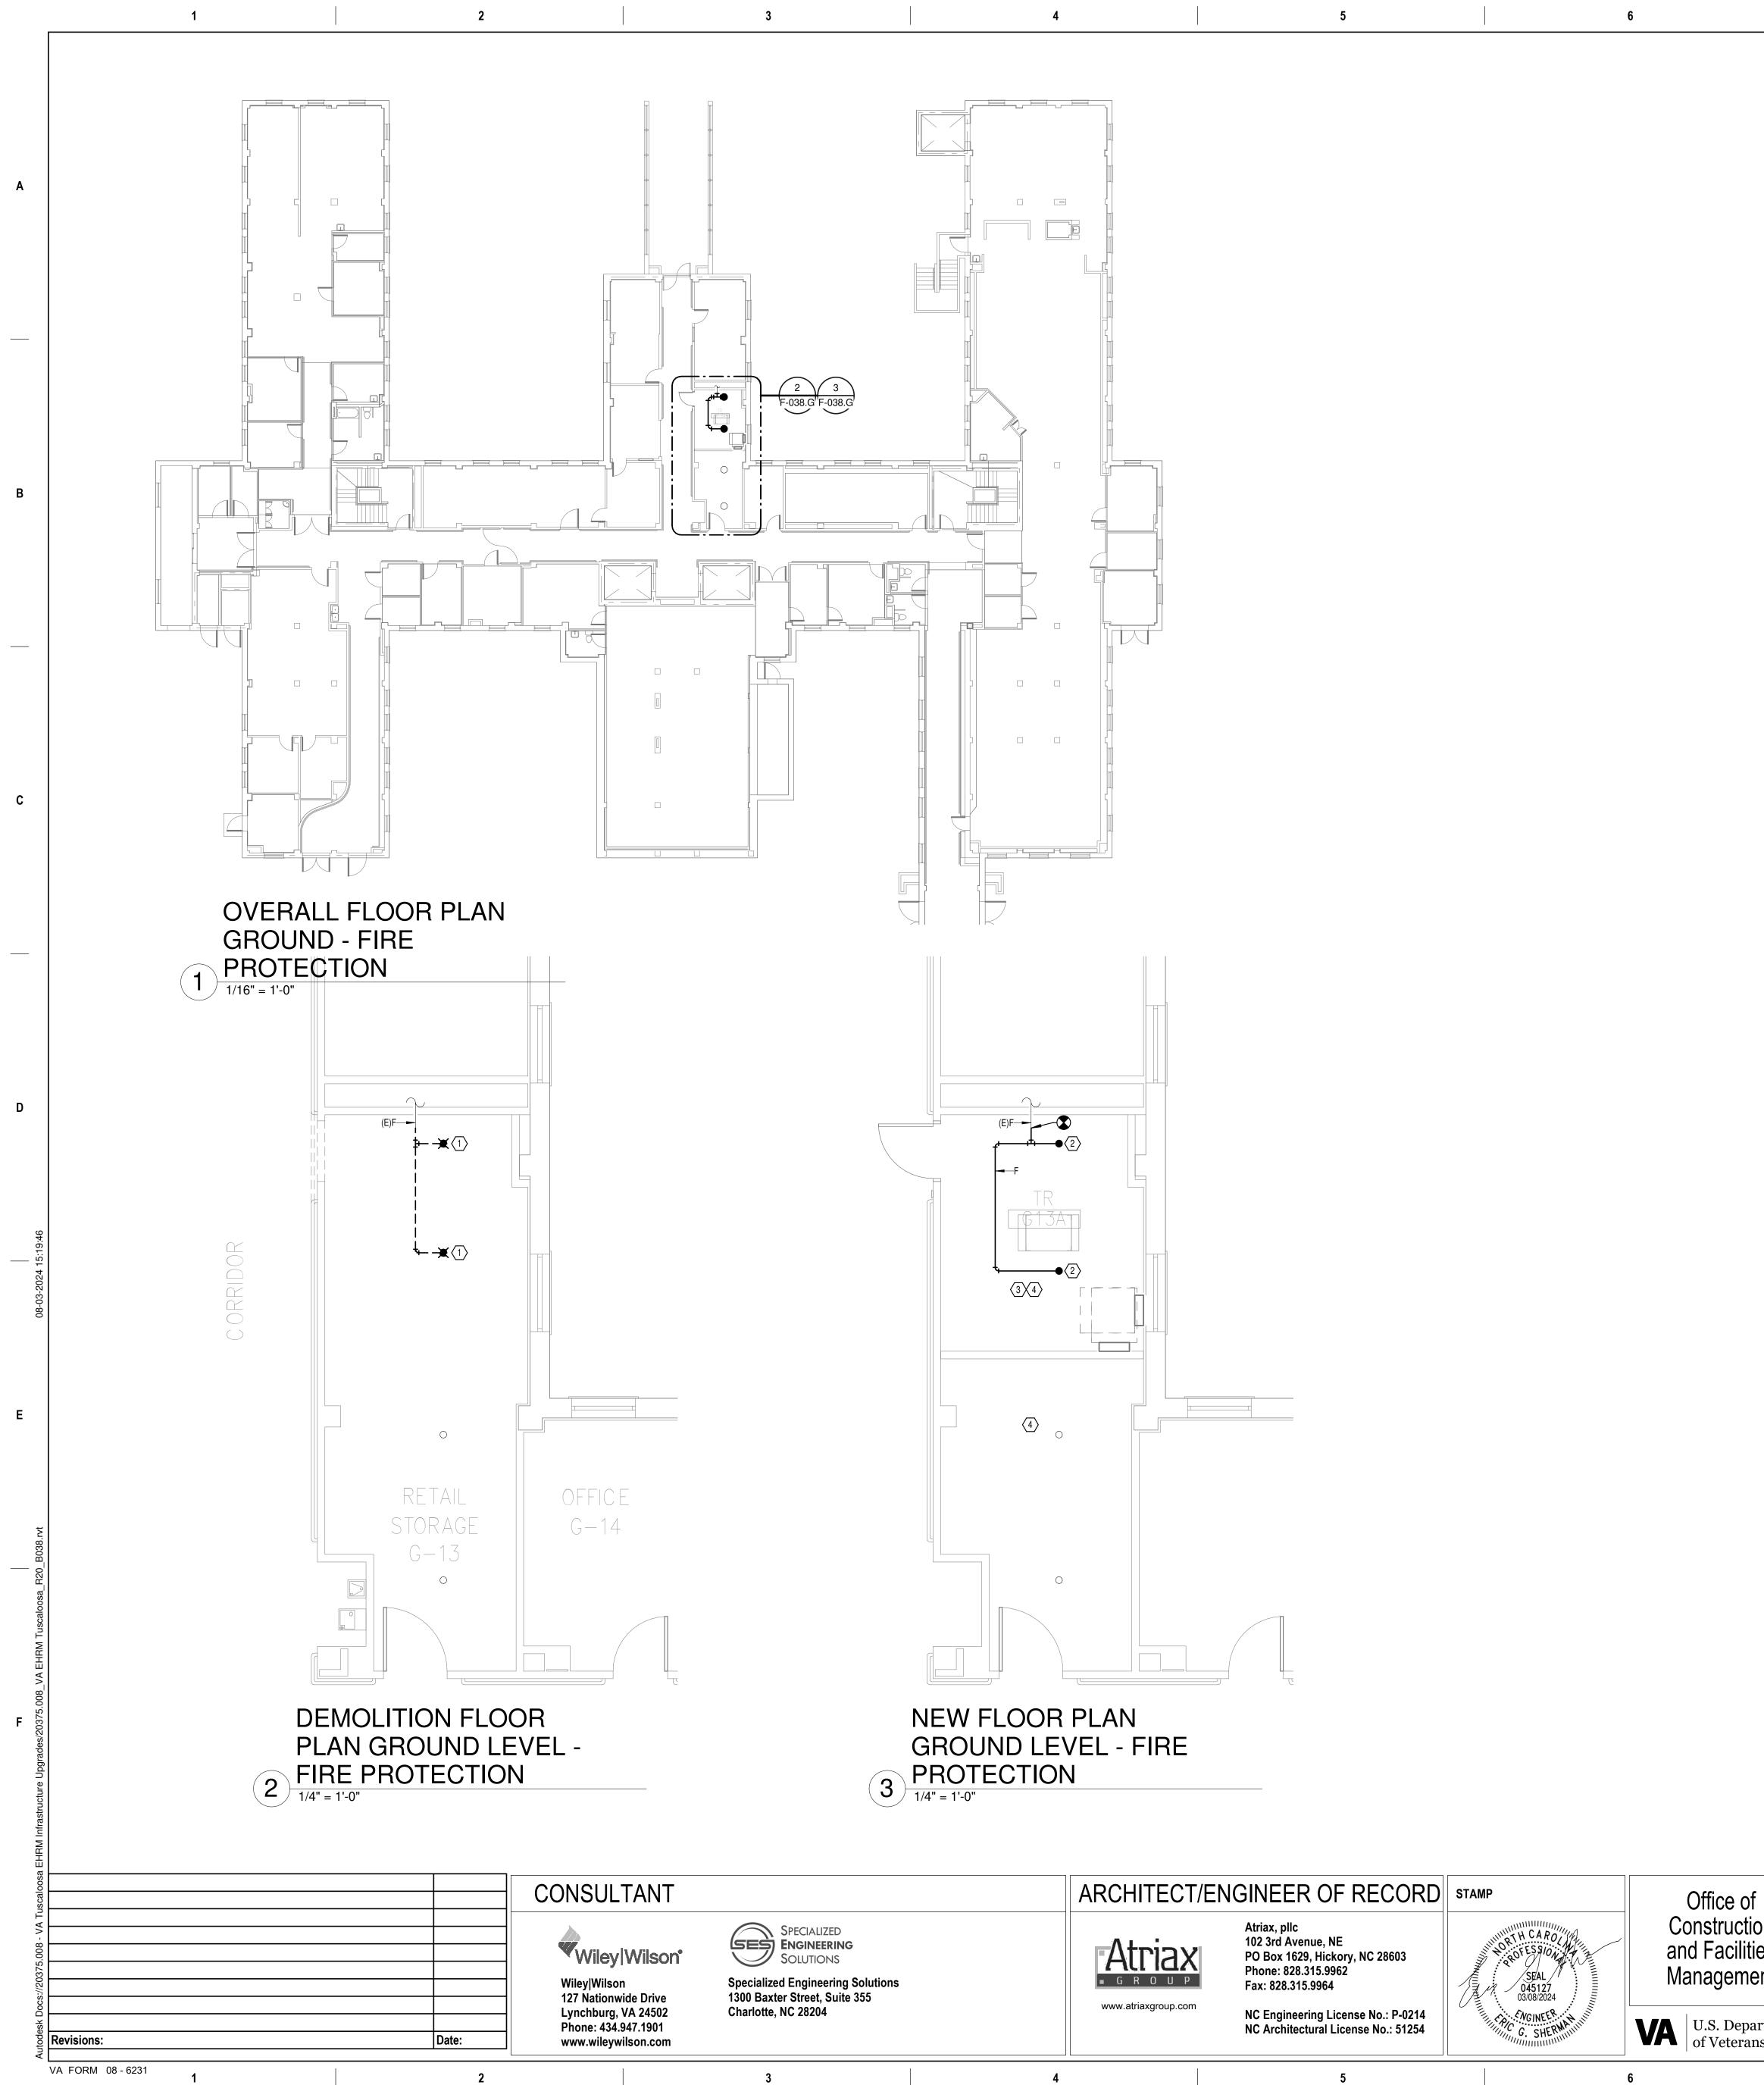
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URE UPGR	ADES	Project Number 179-20-104
		Building Number 17
USCALOO	SA, AL.	Drawing Number
ecked KK	Drawn PCM	F-017.G



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# **GENERAL NOTES:**

- A. COVER SHEET GENERAL NOTES APPLY TO ALL SHEETS.
- PLANS, NEW MECHANICAL SYSTEMS ARE INDICATED WITH HEAVY LINE WEIGHTS.
- PERFORM THIS WORK.

### SHEET NOTES:

- SPRINKLER OUTAGE IN THE ROOM.
- SHALL OCCUR AT THE SAME TIME TO AVOID A SPRINKLER OUTAGE IN THE ROOM.
- PLANS.

				PLAN
of tion ties	Drawing Title BUILDING 38 GROUND LEVEL - FIRE PROTECTION	Phase 100% CONSTRUCTION DOCUMENTS	Project Title EHRM INFRAS	
nent	Approved:		Location TUSCALOOSA	VAMC, TUSCAL
oartment ans Affairs		FULLY SPRINKLERED	Issue Date 03/08/2024	Checked JKK
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B. ON DEMOLITION PLANS; EXISTING MECHANICAL SYSTEMS TO BE REMOVED ARE SHOWN HATCHED AND/OR DASHED, EXISTING MECHANICAL SYSTEMS TO REMAIN ARE SHOWN LIGHT LINE WEIGHT. ON ALL OTHER C. UNLESS NOTED OTHERWISE, DETAILS SHOWN WITHIN THESE DOCUMENTS ARE APPLICABLE FOR ALL PIPING, EQUIPMENT AND DUCTWORK INSTALLATIONS WHETHER OR NOT SPECIFICALLY NOTED. D. THE OWNER AND ENGINEER ARE NOT RESPONSIBLE FOR THE CONTRACTOR'S SAFETY PRECAUTIONS OR FOR THE MEANS, METHODS, TECHNIQUES, CONSTRUCTION SEQUENCES, OR PROCEDURES REQUIRED TO

1. DEMOLISH EXISTING SPRINKLER HEAD FOR CEILING REMOVAL AND SPRINKLER PIPE TO POINT INDICATED. REFER TO NEW WORK PLANS FOR INSTALLATION OF NEW UPRIGHT HEADS. REPLACEMENT OF THE EXISTING PENDENT SPRINKLER WITH NEW UPRIGHT SPRINKLER SHALL OCCUR AT THE SAME TIME TO AVOID A

2. INSTALL NEW UPRIGHT SPRINKLER HEADS WITH MECHANICAL GUARDS TO SERVE G13A. VERIFY COVERAGE REQUIREMENTS. REPLACEMENT OF THE EXISTING PENDENT SPRINKLER WITH NEW UPRIGHT SPRINKLER 3. SPRINKLER PIPING SHALL NOT BE ROUTED ABOVE EQUIPMENT RACKS OR ELECTRICAL PANELS.

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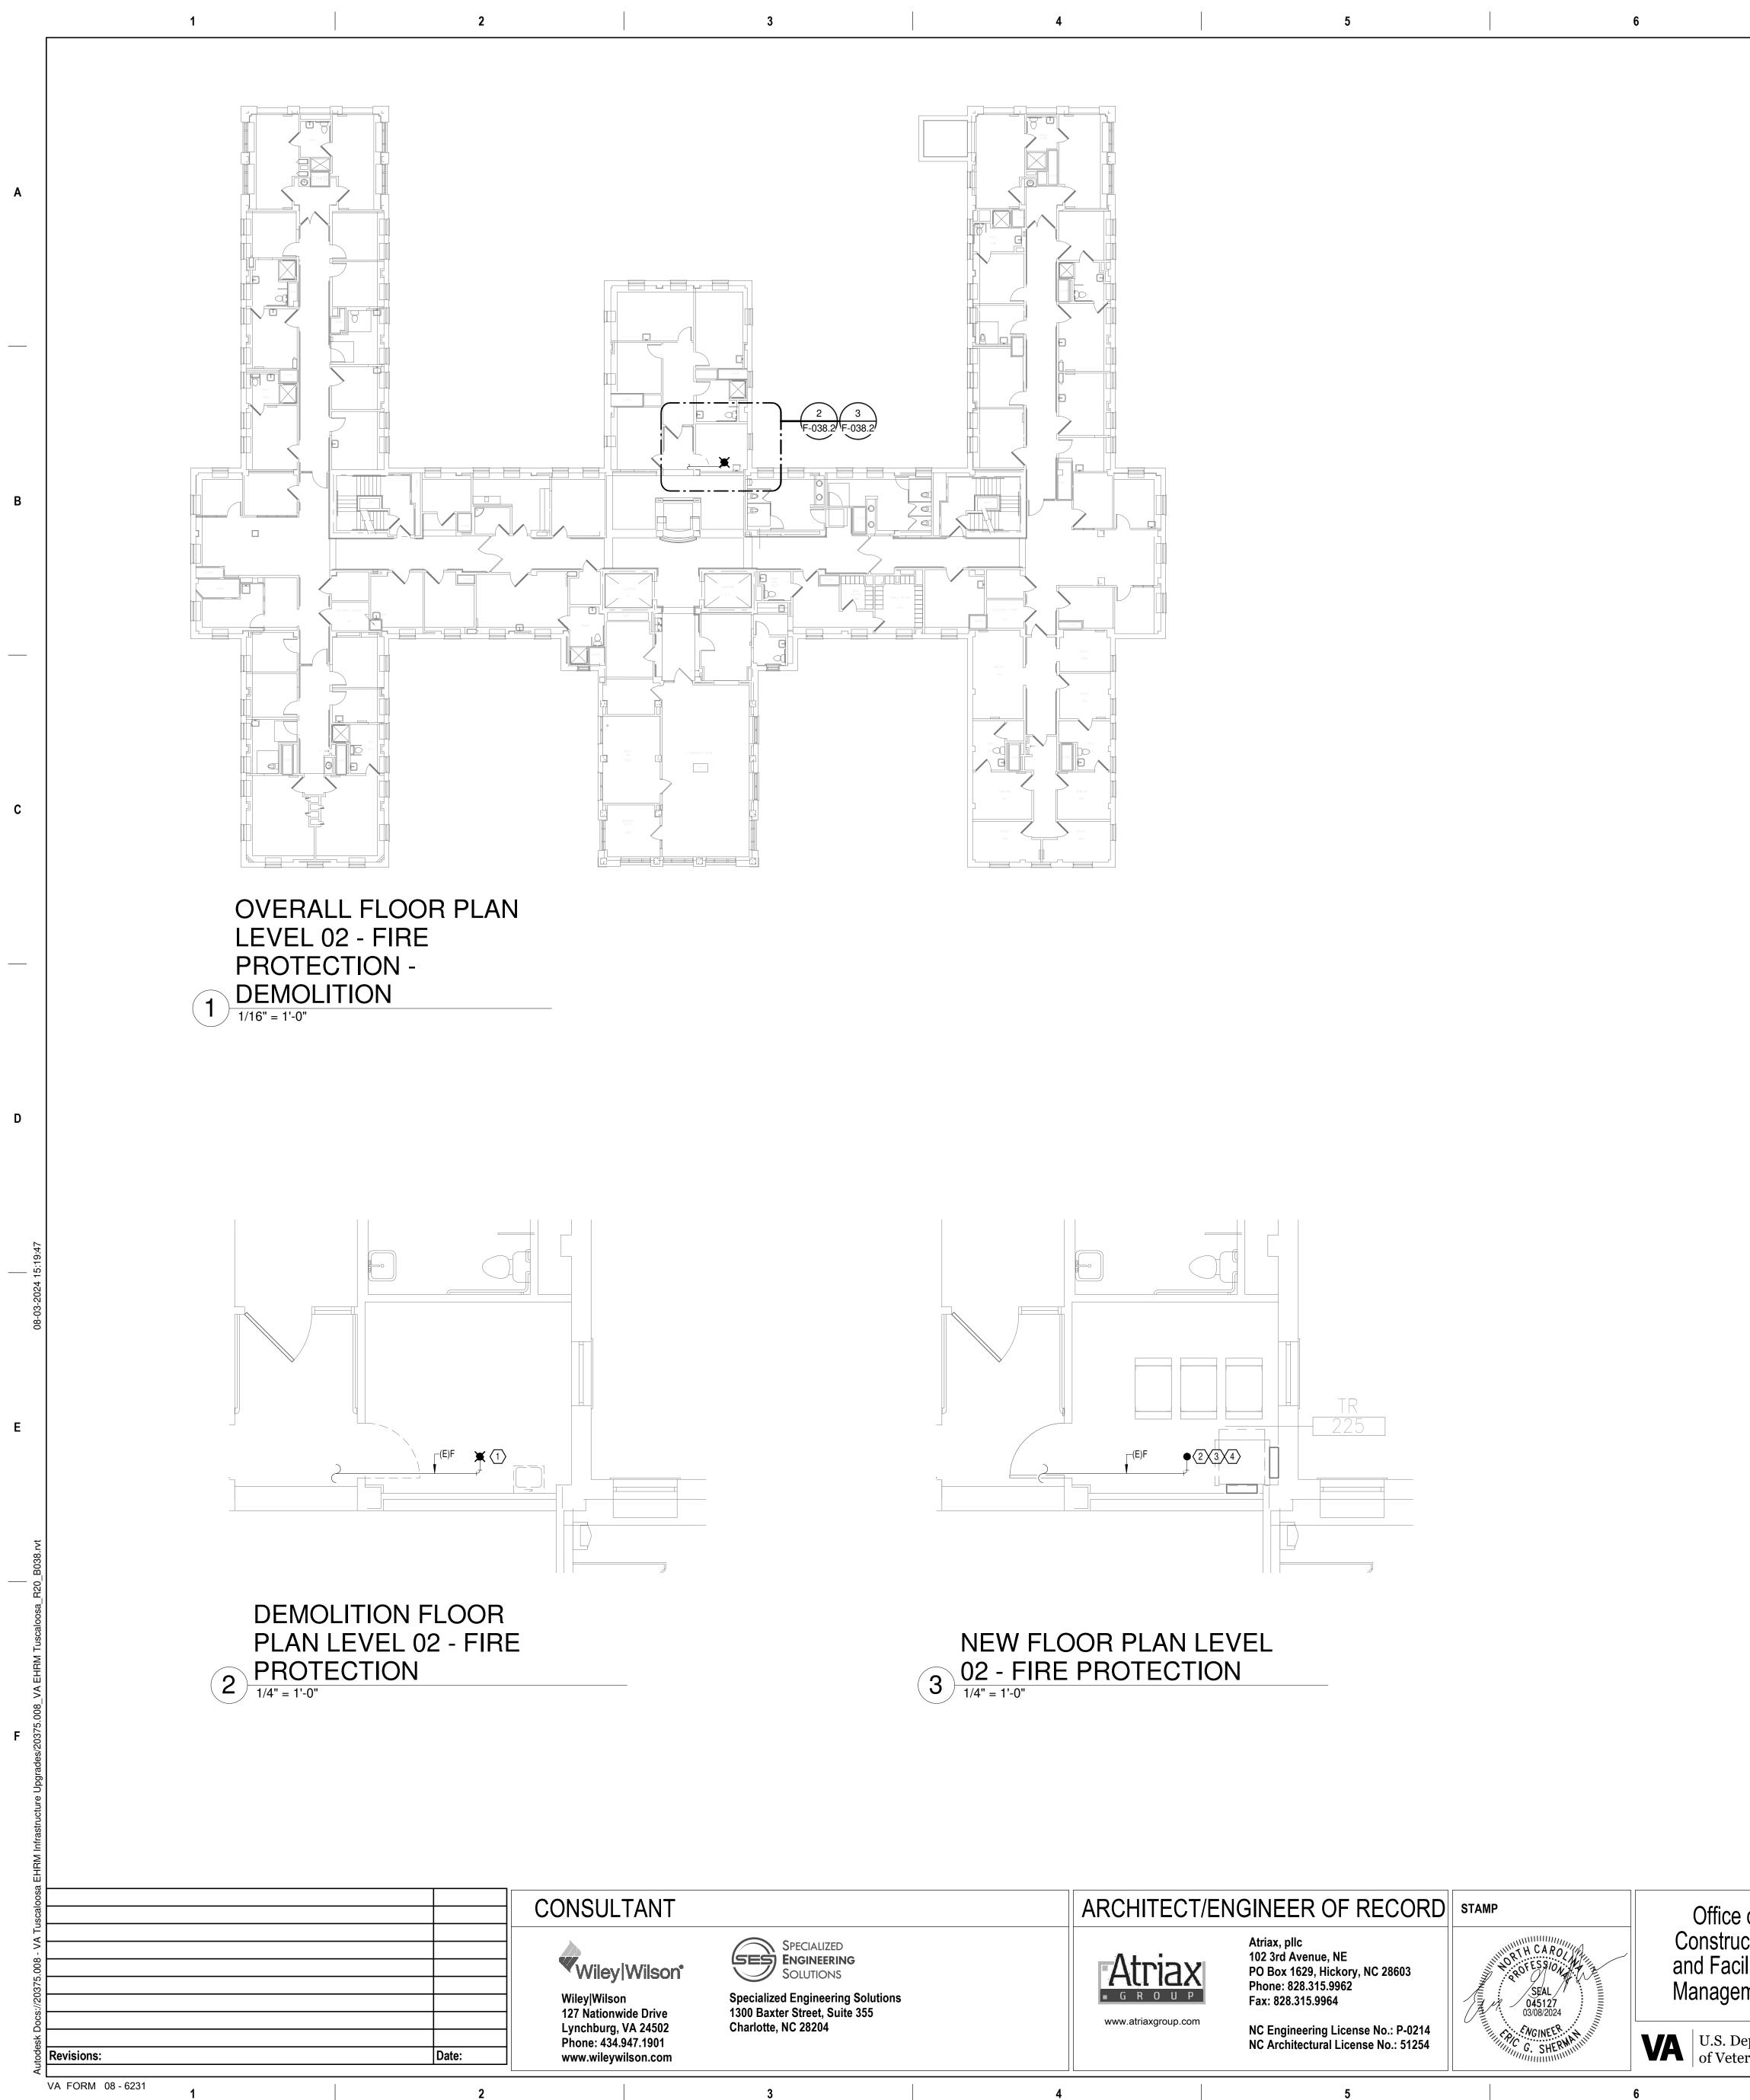
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4. AREA OF EXISTING SPRINKLER COVERAGE. HAZARD CLASSIFICATION "LIGHT HAZARD". RELOCATE AND/OR ADD ADDITIONAL HEADS AND PIPING TO MEET COVERAGE REQUIREMENTS PER NFPA 13 AND VA REQUIREMENTS. COORDINATE HEAD LOCATIONS WITH EXISTING CONDITIONS AND ARCHITECT'S CEILING

N PLAN		TRUE
RUCTURE UPGR	ADES	Project Number 679-20-104
		Building Number 38
MC, TUSCALOOS	SA, AL.	Drawing Number
Checked JKK	Drawn PCM	F-038.G



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### **GENERAL NOTES:**

- A. COVER SHEET GENERAL NOTES APPLY TO ALL SHEETS.
- PLANS, NEW MECHANICAL SYSTEMS ARE INDICATED WITH HEAVY LINE WEIGHTS.
- PERFORM THIS WORK.

### SHEET NOTES:

- SHALL OCCUR AT THE SAME TIME TO AVOID A SPRINKLER OUTAGE IN THE ROOM.
- PLANS.

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e of uction cilities	Drawing Title BUILDING 38 LEVEL 02 - PROTECTION	FIRE	<sup>Phase</sup> 100% CONSTRU DOCUMENTS		Project Title EHRM INFRASTRUC	,
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B. ON DEMOLITION PLANS; EXISTING MECHANICAL SYSTEMS TO BE REMOVED ARE SHOWN HATCHED AND/OR DASHED, EXISTING MECHANICAL SYSTEMS TO REMAIN ARE SHOWN LIGHT LINE WEIGHT. ON ALL OTHER C. UNLESS NOTED OTHERWISE, DETAILS SHOWN WITHIN THESE DOCUMENTS ARE APPLICABLE FOR ALL PIPING, EQUIPMENT AND DUCTWORK INSTALLATIONS WHETHER OR NOT SPECIFICALLY NOTED. D. THE OWNER AND ENGINEER ARE NOT RESPONSIBLE FOR THE CONTRACTOR'S SAFETY PRECAUTIONS OR FOR THE MEANS, METHODS, TECHNIQUES, CONSTRUCTION SEQUENCES, OR PROCEDURES REQUIRED TO

1. REMOVE EXISTING SPRINKLER HEAD FOR CEILING REMOVAL. REFER TO NEW WORK PLANS FOR INSTALLATION OF NEW UPRIGHT HEADS. REPLACEMENT OF THE EXISTING PENDENT SPRINKLER WITH NEW UPRIGHT SPRINKLER SHALL OCCUR AT THE SAME TIME TO AVOID A SPRINKLER OUTAGE IN THE ROOM. 2. INSTALL NEW UPRIGHT SPRINKLER HEADS WITH MECHANICAL GUARDS TO SERVE 225. VERIFY COVERAGE REQUIREMENTS. REPLACEMENT OF THE EXISTING PENDENT SPRINKLER WITH NEW UPRIGHT SPRINKLER 3. SPRINKLER PIPING SHALL NOT BE ROUTED ABOVE EQUIPMENT RACKS OR ELECTRICAL PANELS.

4. AREA OF EXISTING SPRINKLER COVERAGE. HAZARD CLASSIFICATION "LIGHT HAZARD". RELOCATE AND/OR ADD ADDITIONAL HEADS AND PIPING TO MEET COVERAGE REQUIREMENTS PER NFPA 13 AND VA REQUIREMENTS. COORDINATE HEAD LOCATIONS WITH EXISTING CONDITIONS AND ARCHITECT'S CEILING

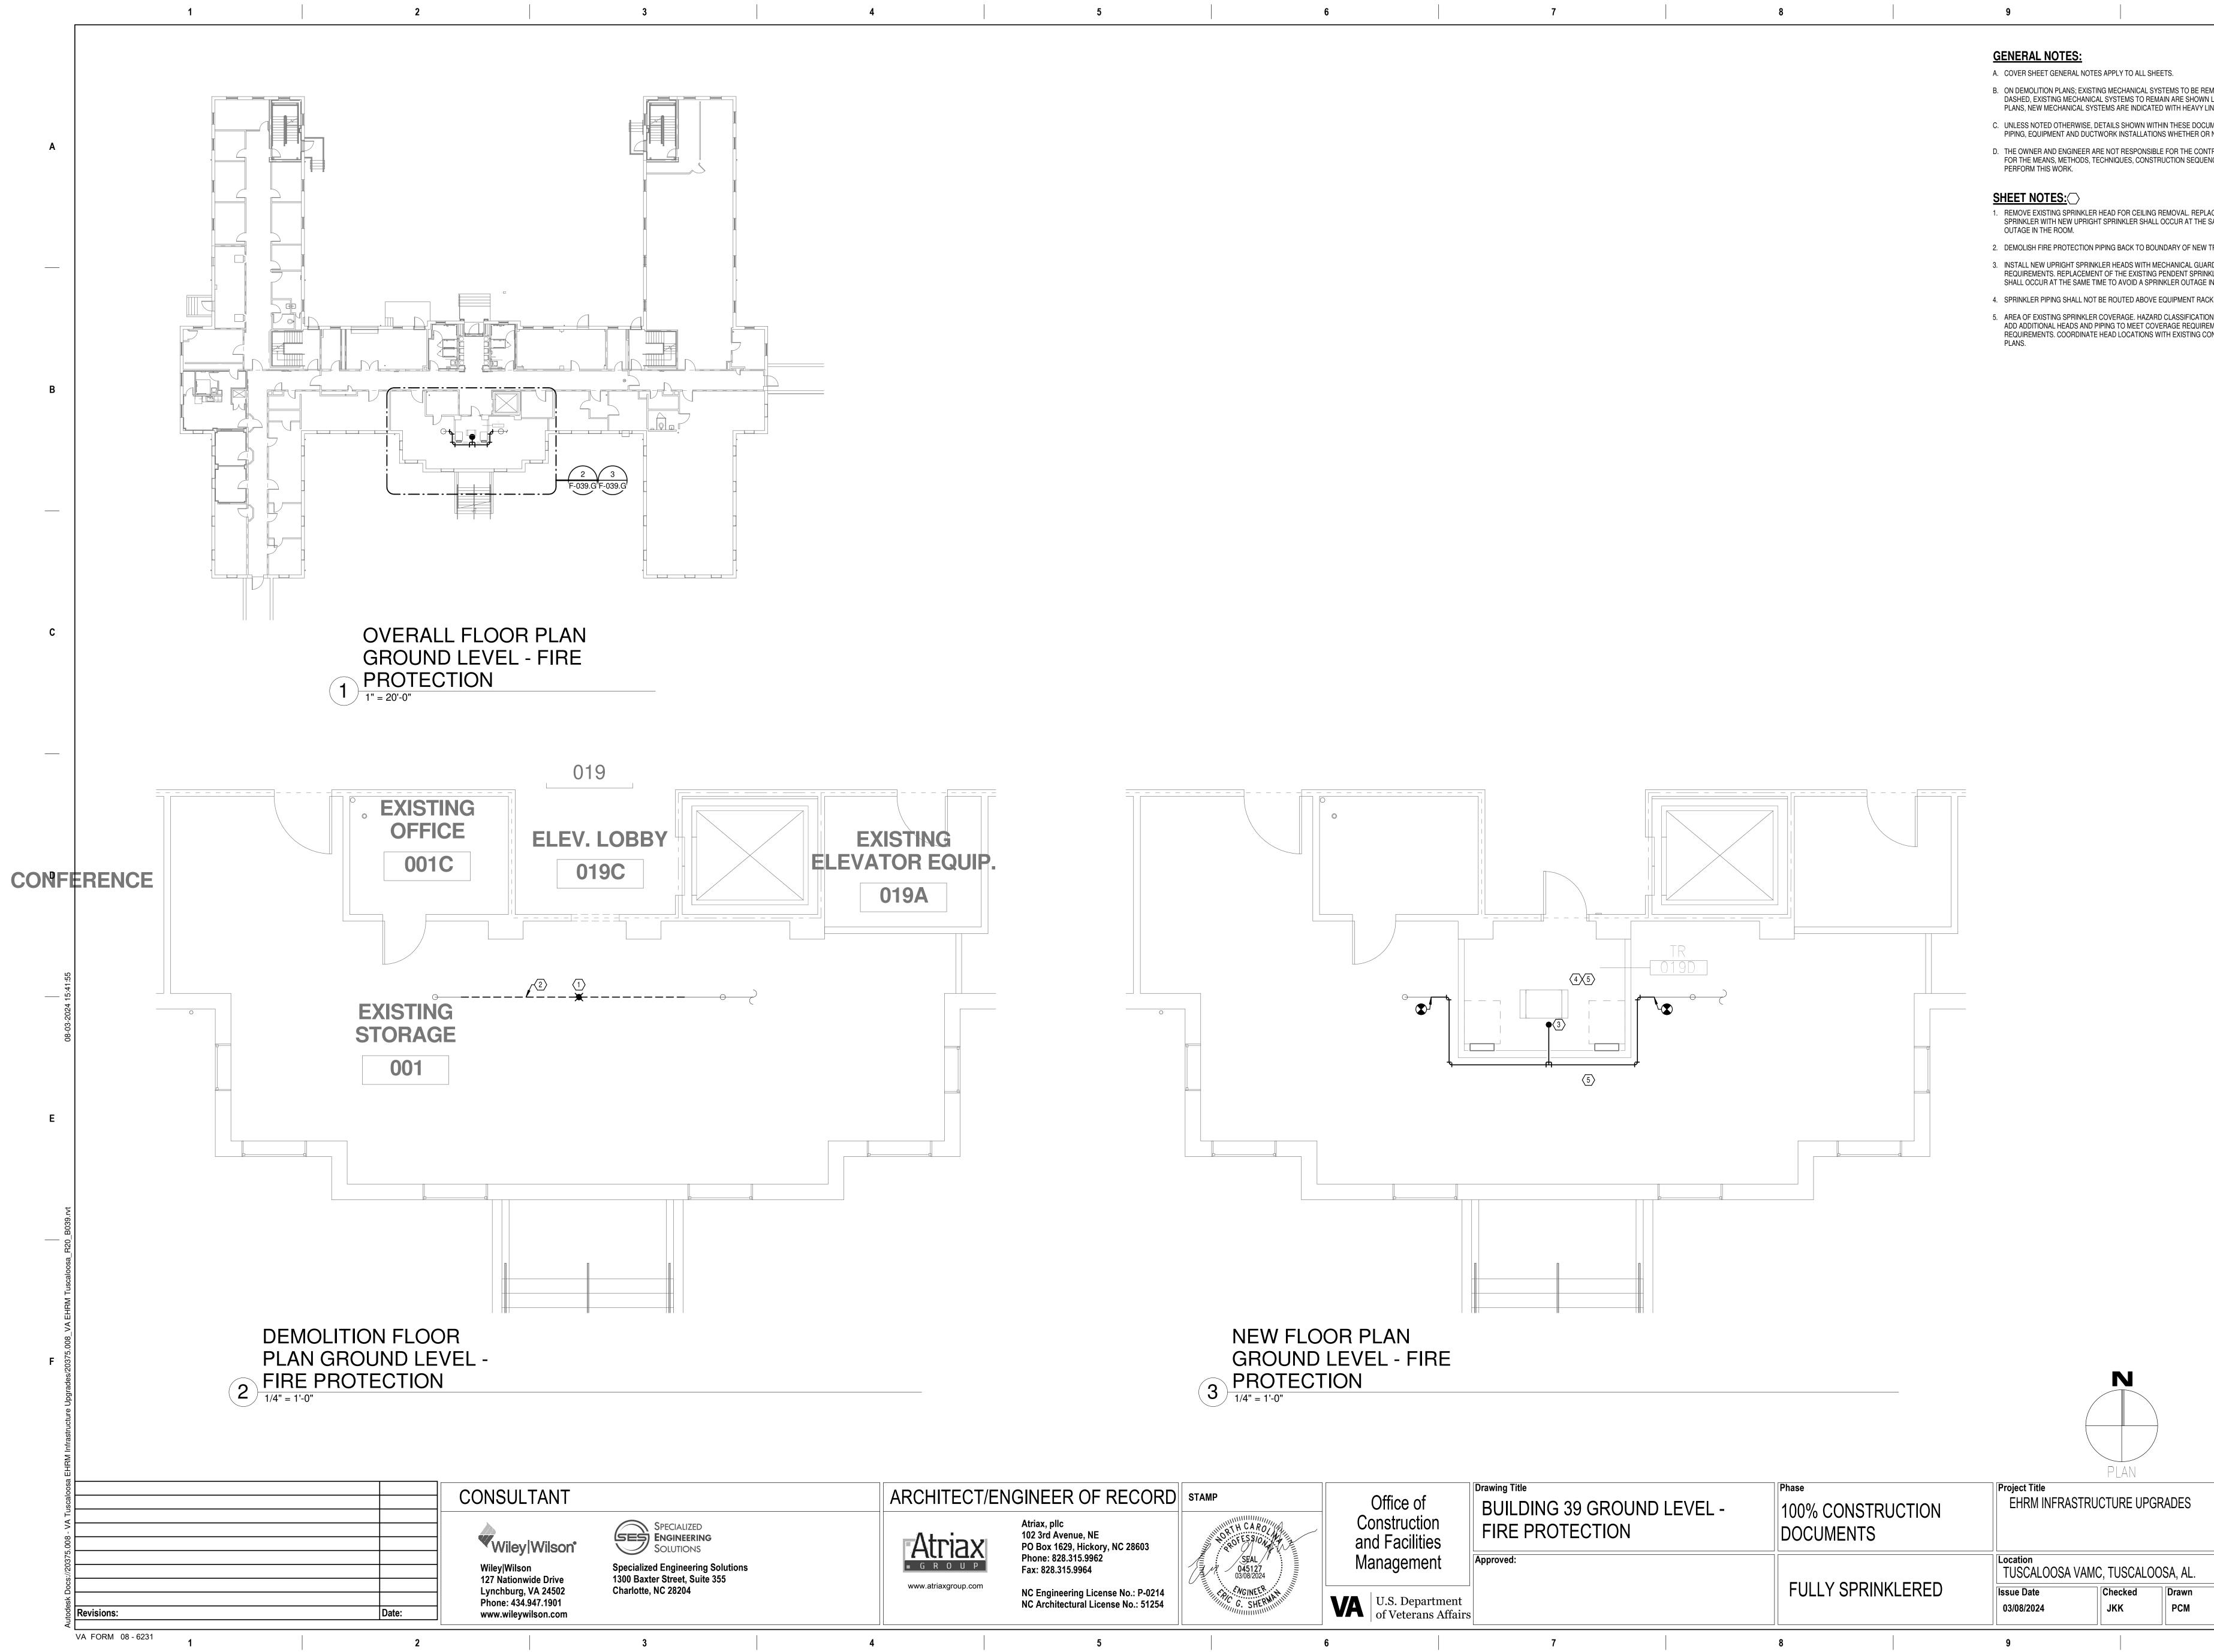
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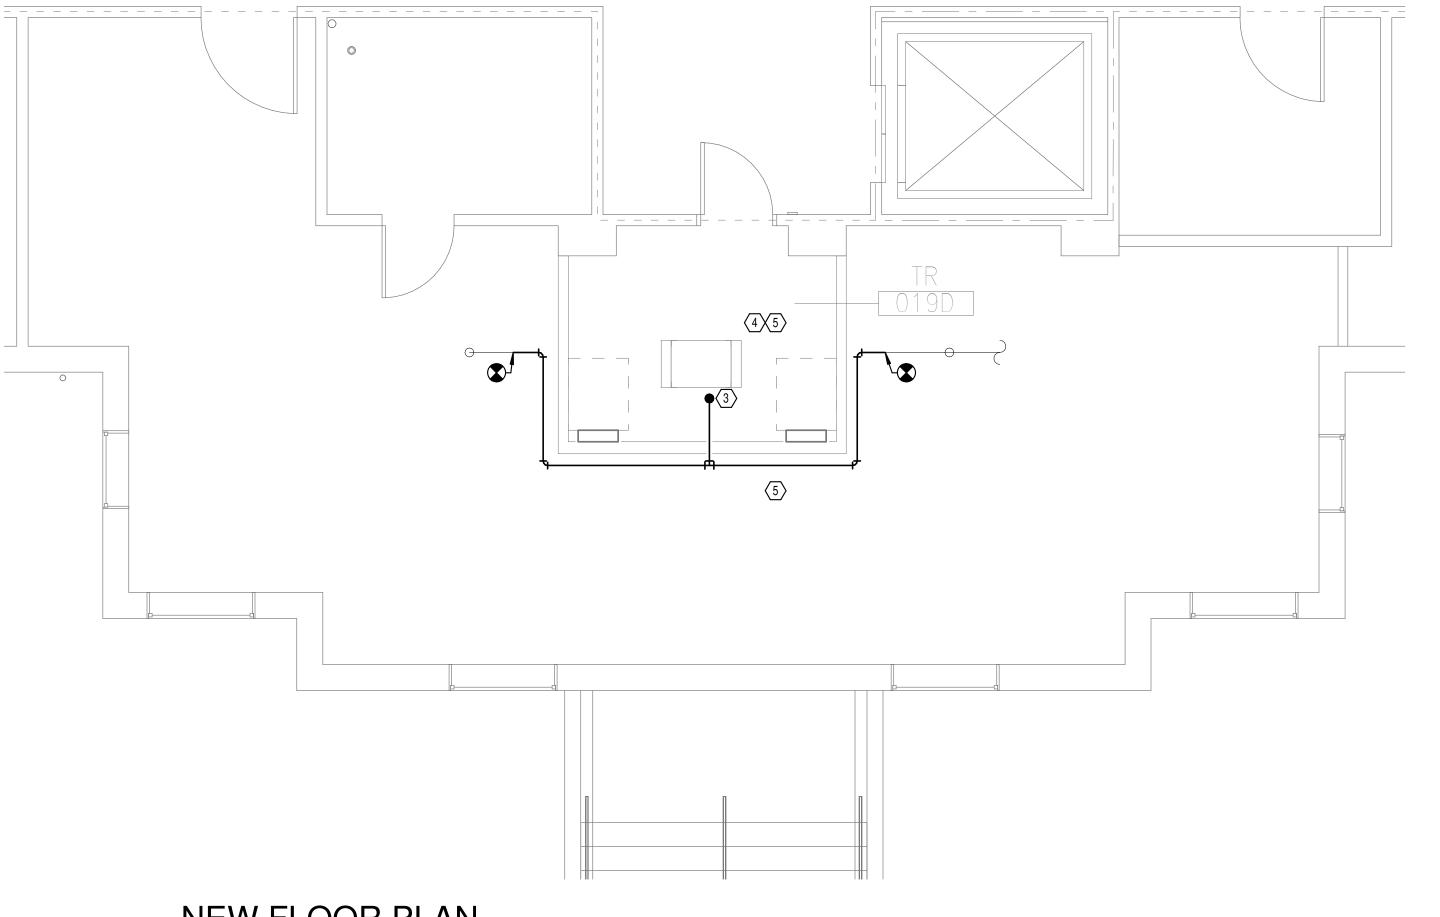
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PLAN	TRUE
RUCTURE UPGRADES	Project Number 679-20-104
	Building Number 38
MC, TUSCALOOSA, AL.	Drawing Number
CheckedDrawnJKKPCM	F-038.2





### **GENERAL NOTES:**

- A. COVER SHEET GENERAL NOTES APPLY TO ALL SHEETS.
- PLANS, NEW MECHANICAL SYSTEMS ARE INDICATED WITH HEAVY LINE WEIGHTS.
- PIPING, EQUIPMENT AND DUCTWORK INSTALLATIONS WHETHER OR NOT SPECIFICALLY NOTED.
- PERFORM THIS WORK.

### SHEET NOTES:

- OUTAGE IN THE ROOM.
- 4. SPRINKLER PIPING SHALL NOT BE ROUTED ABOVE EQUIPMENT RACKS OR ELECTRICAL PANELS.
- PLANS.

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of		 Phase		Project Title EHRM INFRASTR	
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B. ON DEMOLITION PLANS; EXISTING MECHANICAL SYSTEMS TO BE REMOVED ARE SHOWN HATCHED AND/OR DASHED, EXISTING MECHANICAL SYSTEMS TO REMAIN ARE SHOWN LIGHT LINE WEIGHT. ON ALL OTHER C. UNLESS NOTED OTHERWISE, DETAILS SHOWN WITHIN THESE DOCUMENTS ARE APPLICABLE FOR ALL

D. THE OWNER AND ENGINEER ARE NOT RESPONSIBLE FOR THE CONTRACTOR'S SAFETY PRECAUTIONS OR FOR THE MEANS, METHODS, TECHNIQUES, CONSTRUCTION SEQUENCES, OR PROCEDURES REQUIRED TO

1. REMOVE EXISTING SPRINKLER HEAD FOR CEILING REMOVAL. REPLACEMENT OF THE EXISTING PENDENT SPRINKLER WITH NEW UPRIGHT SPRINKLER SHALL OCCUR AT THE SAME TIME TO AVOID A SPRINKLER

2. DEMOLISH FIRE PROTECTION PIPING BACK TO BOUNDARY OF NEW TR 019D.

3. INSTALL NEW UPRIGHT SPRINKLER HEADS WITH MECHANICAL GUARDS TO SERVE 019D. VERIFY COVERAGE REQUIREMENTS. REPLACEMENT OF THE EXISTING PENDENT SPRINKLER WITH NEW UPRIGHT SPRINKLER SHALL OCCUR AT THE SAME TIME TO AVOID A SPRINKLER OUTAGE IN THE ROOM.

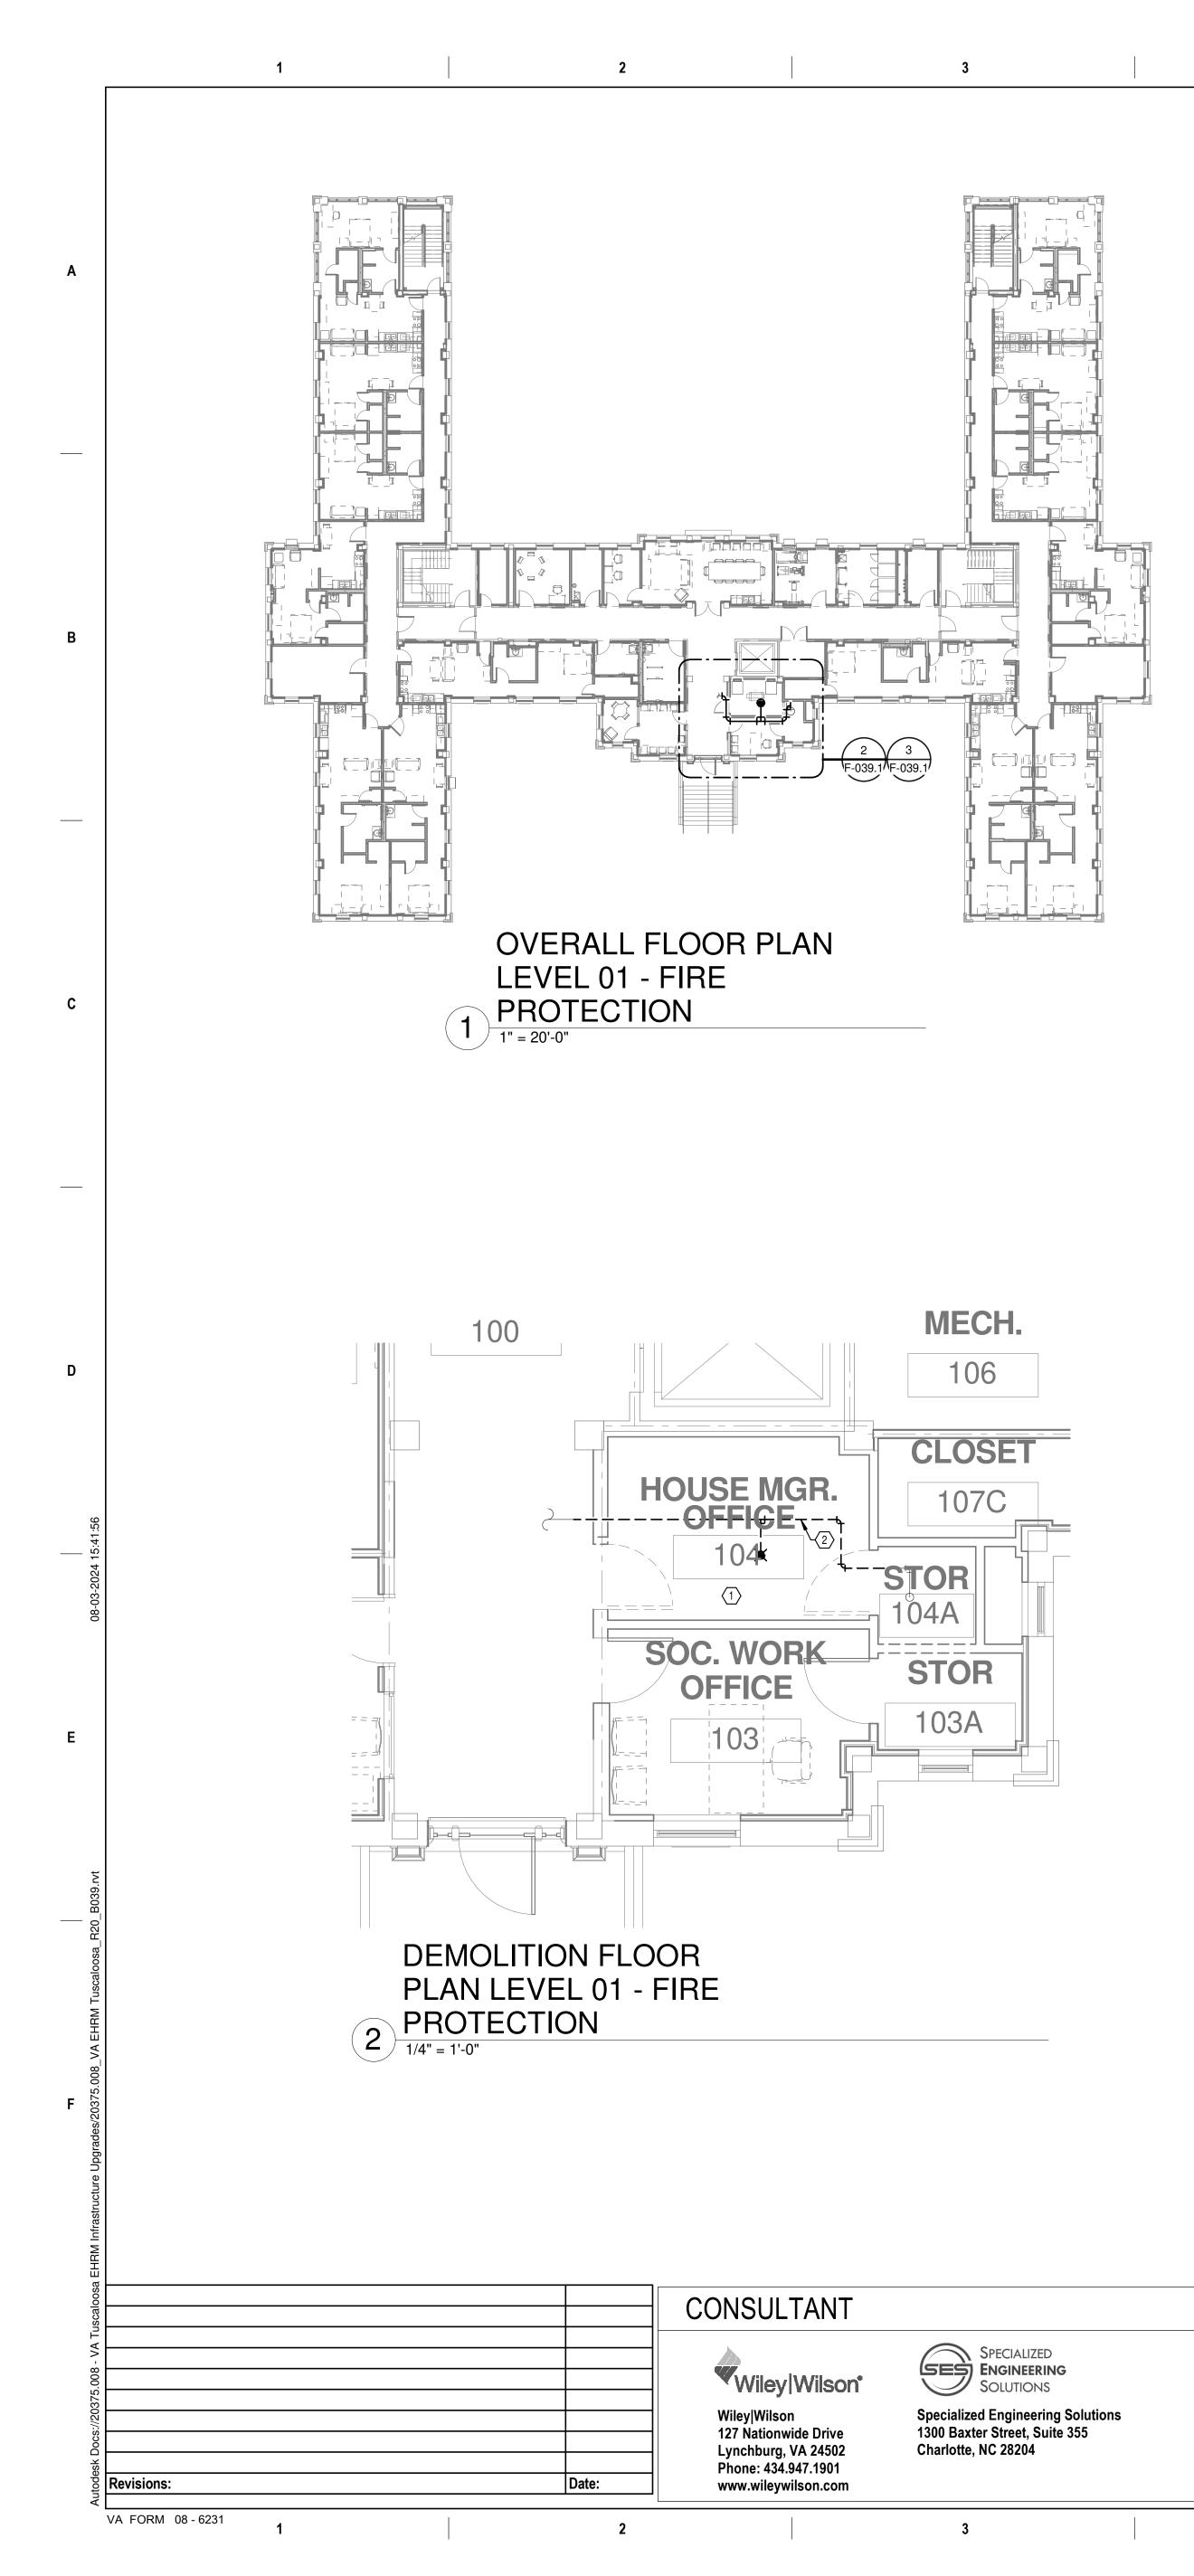
5. AREA OF EXISTING SPRINKLER COVERAGE. HAZARD CLASSIFICATION "LIGHT HAZARD". RELOCATE AND/OR ADD ADDITIONAL HEADS AND PIPING TO MEET COVERAGE REQUIREMENTS PER NFPA 13 AND VA REQUIREMENTS. COORDINATE HEAD LOCATIONS WITH EXISTING CONDITIONS AND ARCHITECT'S CEILING

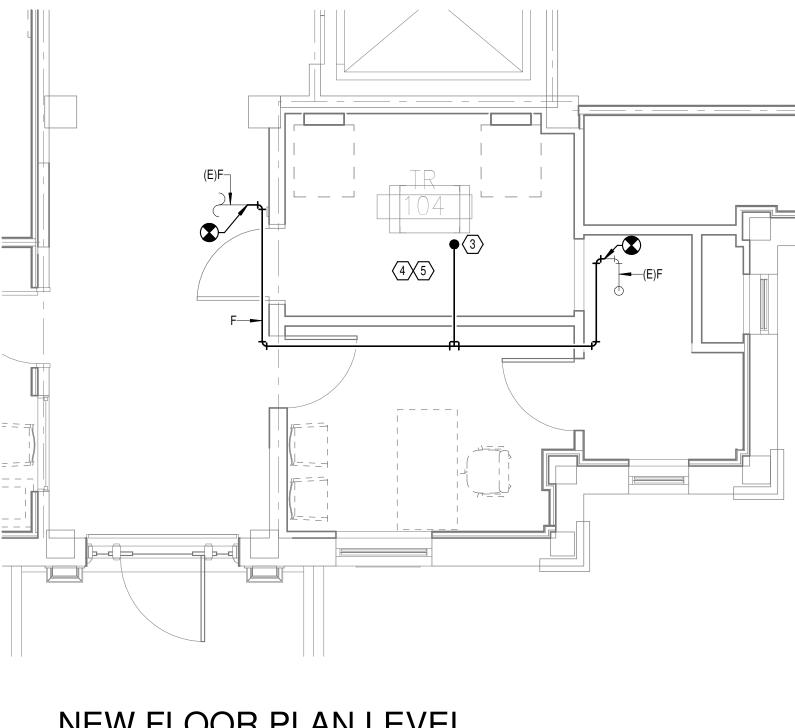
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PLAN	TRUE
CTURE UPGRADES	Project Number 679-20-104
	Building Number 39
, TUSCALOOSA, AL.	Drawing Number
Checked Drawn JKK PCM	F-039.G





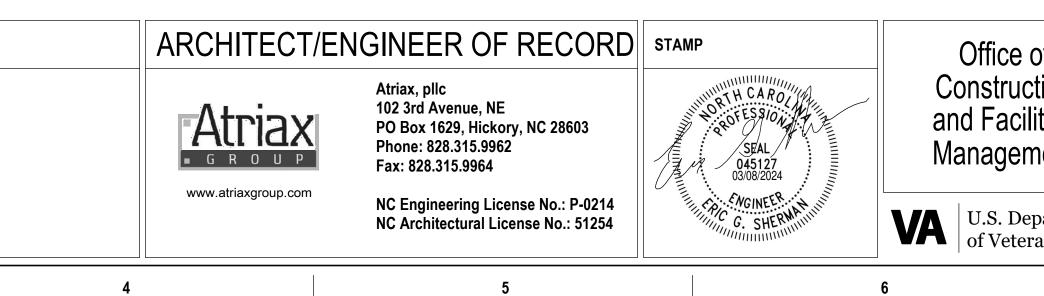
NEW FLOOR PLAN LEVEL  $3 \frac{01 - FIRE PROTECTION}{\frac{1}{4"} = 1'-0"}$ 

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### **GENERAL NOTES:**

- A. COVER SHEET GENERAL NOTES APPLY TO ALL SHEETS.
- PLANS, NEW MECHANICAL SYSTEMS ARE INDICATED WITH HEAVY LINE WEIGHTS.
- PIPING, EQUIPMENT AND DUCTWORK INSTALLATIONS WHETHER OR NOT SPECIFICALLY NOTED.
- PERFORM THIS WORK.

### SHEET NOTES:

- 1. REMOVE EXISTING SPRINKLER HEAD FOR CEILING REMOVAL. REFER TO NEW WORK PLANS FOR
- 4. SPRINKLER PIPING SHALL NOT BE ROUTED ABOVE EQUIPMENT RACKS OR ELECTRICAL PANELS.
- PLANS.

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of ction ilities	Drawing Title BUILDING 39 LEVEL 01 - FIRE PROTECTION	Phase 100% CONSTRUCTION DOCUMENTS	Project Title EHRM INFRASTRU	JCTURE UI
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epartment erans Affairs		FULLY SPRINKLERED	Issue Date 03/08/2024	Checked JKK
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B. ON DEMOLITION PLANS; EXISTING MECHANICAL SYSTEMS TO BE REMOVED ARE SHOWN HATCHED AND/OR DASHED, EXISTING MECHANICAL SYSTEMS TO REMAIN ARE SHOWN LIGHT LINE WEIGHT. ON ALL OTHER C. UNLESS NOTED OTHERWISE, DETAILS SHOWN WITHIN THESE DOCUMENTS ARE APPLICABLE FOR ALL

D. THE OWNER AND ENGINEER ARE NOT RESPONSIBLE FOR THE CONTRACTOR'S SAFETY PRECAUTIONS OR FOR THE MEANS, METHODS, TECHNIQUES, CONSTRUCTION SEQUENCES, OR PROCEDURES REQUIRED TO

INSTALLATION OF NEW UPRIGHT HEADS. REPLACEMENT OF THE EXISTING PENDENT SPRINKLER WITH NEW UPRIGHT SPRINKLER SHALL OCCUR AT THE SAME TIME TO AVOID A SPRINKLER OUTAGE IN THE ROOM. 2. DEMOLISH FIRE PROTECTION PIPING BACK TO BOUNDARY OF NEW TR 104.

3. INSTALL NEW UPRIGHT SPRINKLER HEADS WITH MECHANICAL GUARDS TO SERVE 132. VERIFY COVERAGE REQUIREMENTS. REPLACEMENT OF THE EXISTING PENDENT SPRINKLER WITH NEW UPRIGHT SPRINKLER SHALL OCCUR AT THE SAME TIME TO AVOID A SPRINKLER OUTAGE IN THE ROOM.

5. AREA OF EXISTING SPRINKLER COVERAGE. HAZARD CLASSIFICATION "LIGHT HAZARD". RELOCATE AND/OR ADD ADDITIONAL HEADS AND PIPING TO MEET COVERAGE REQUIREMENTS PER NFPA 13 AND VA REQUIREMENTS. COORDINATE HEAD LOCATIONS WITH EXISTING CONDITIONS AND ARCHITECT'S CEILING

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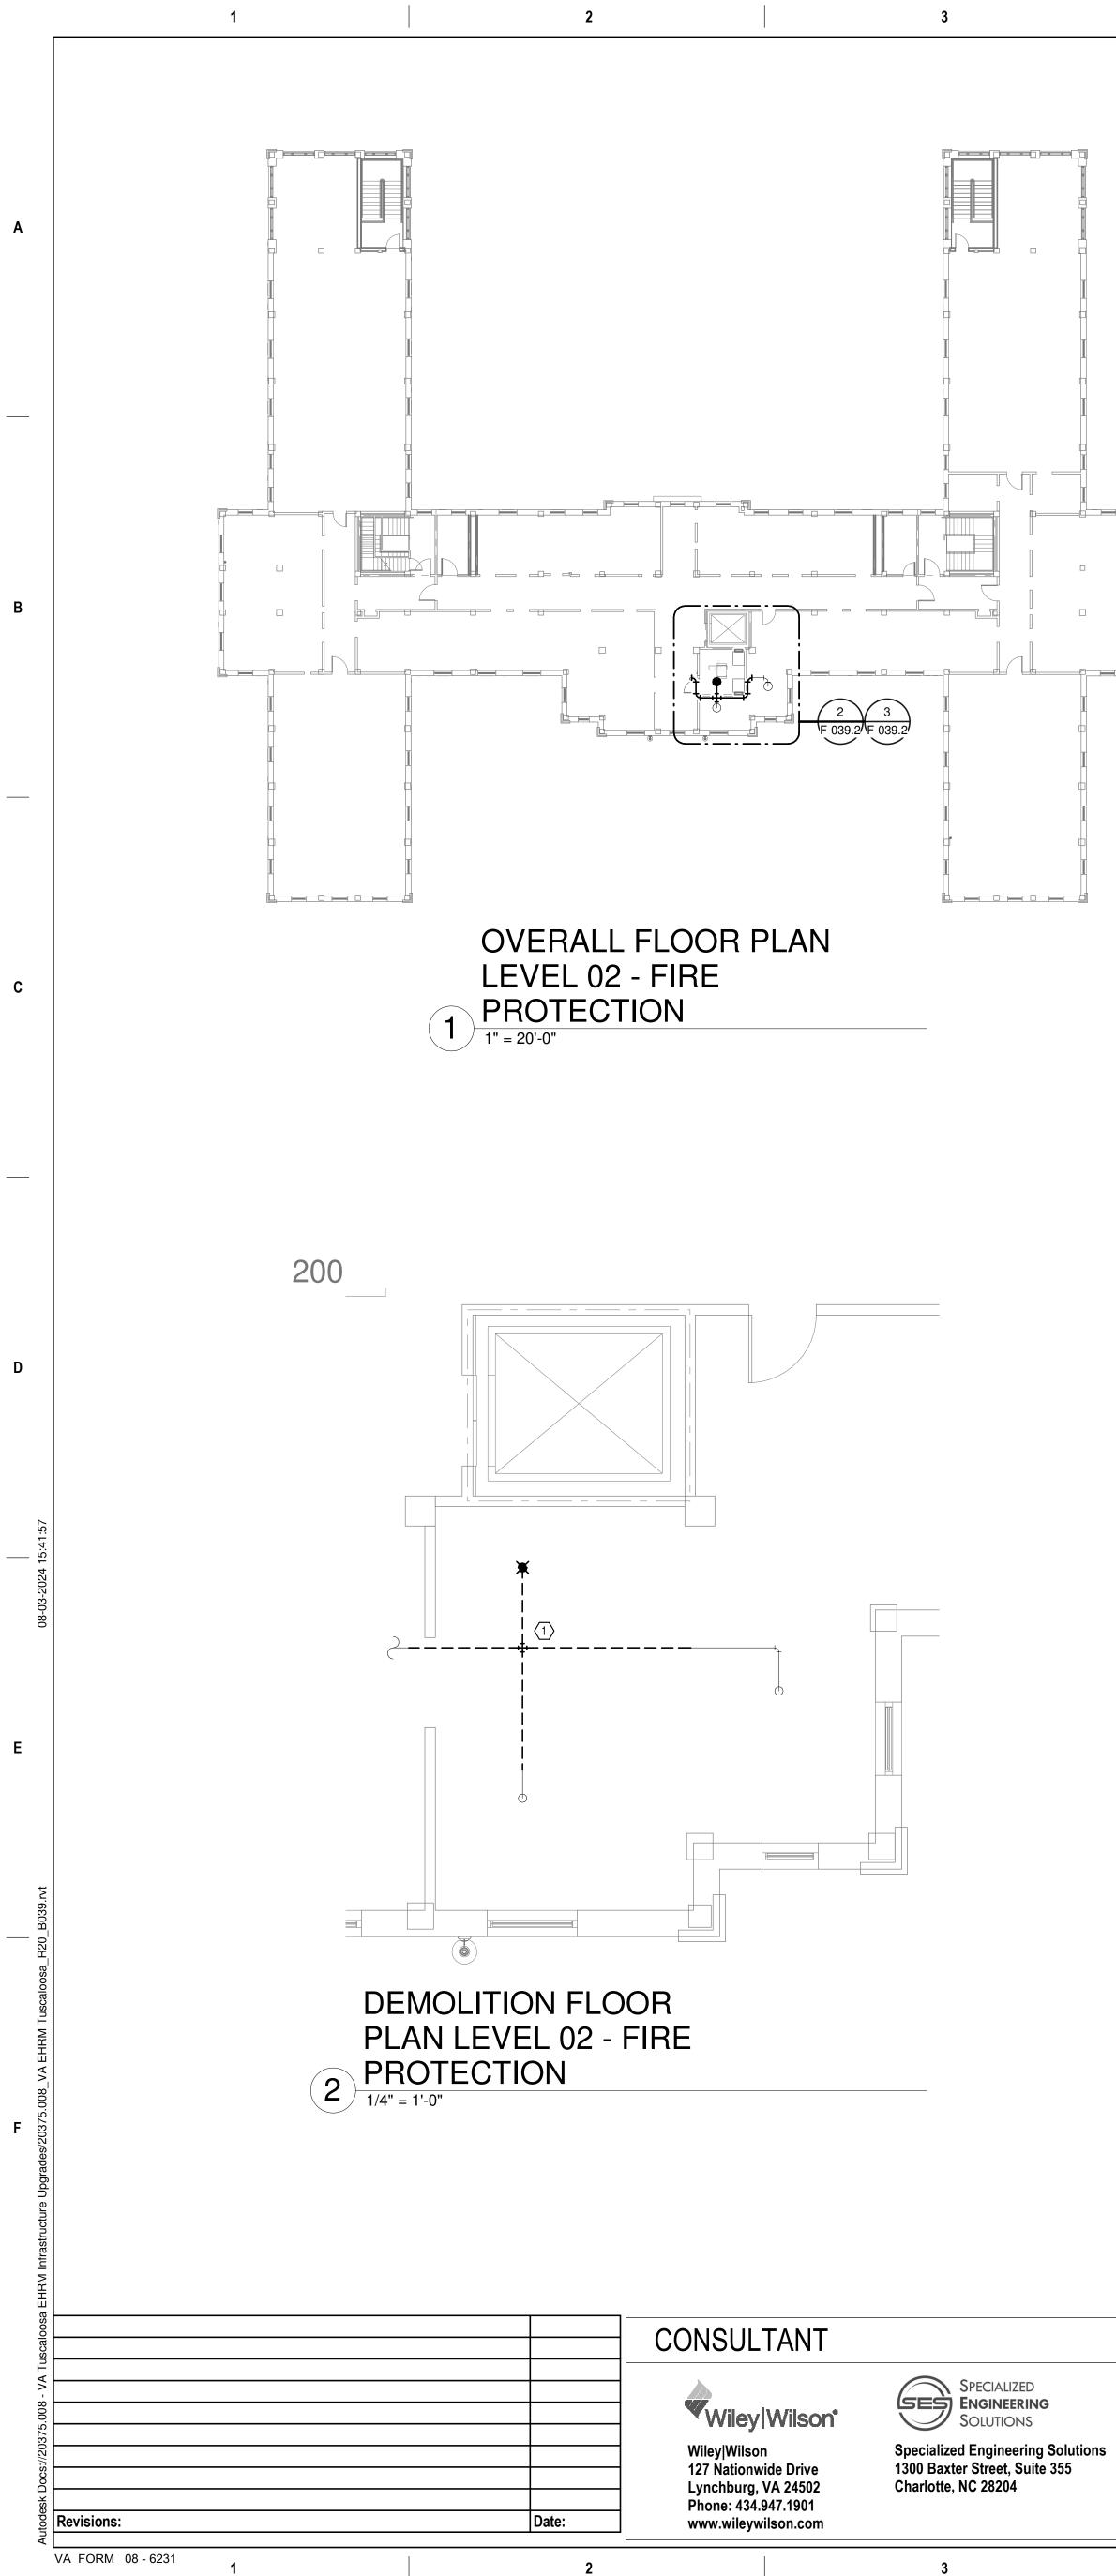
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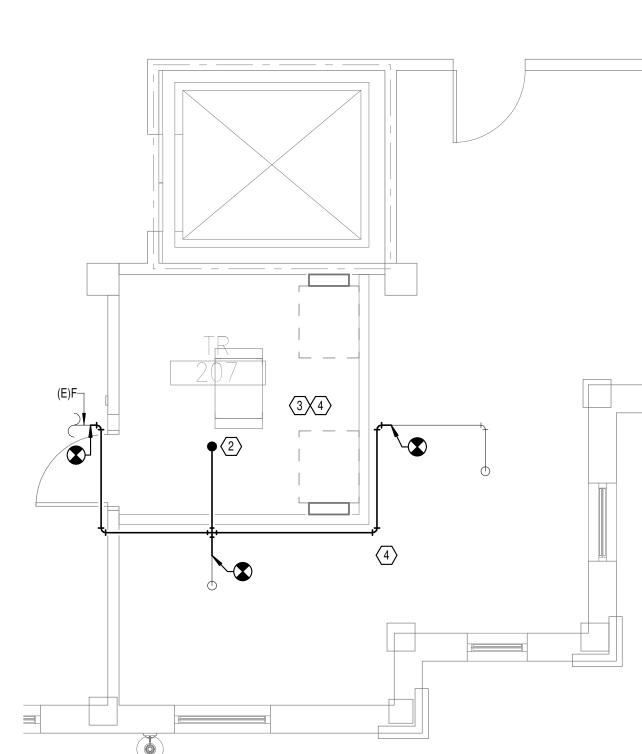
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PLAN	TRUE
CTURE UPGRADES	Project Number 679-20-104
	Building Number 39
, TUSCALOOSA, AL.	Drawing Number
Checked Drawn JKK PCM	F-039.1







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■ G R O U P www.atriaxgroup.com

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Phone: 828.315.9962 Fax: 828.315.9964

NC Engineering License No.: P-0214 NC Architectural License No.: 51254

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Office o Construct and Facilit Managem



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# **GENERAL NOTES:**

- A. COVER SHEET GENERAL NOTES APPLY TO ALL SHEETS.
- PLANS, NEW MECHANICAL SYSTEMS ARE INDICATED WITH HEAVY LINE WEIGHTS.
- PERFORM THIS WORK.

### SHEET NOTES:

- 3. SPRINKLER PIPING SHALL NOT BE ROUTED ABOVE EQUIPMENT RACKS OR ELECTRICAL PANELS.
- PLANS.

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of ction ilities	Drawing Title BUILDING 39 LEVEL 02 - FIRE PROTECTION	Phase 100% CONSTRUCTION DOCUMENTS	Project Title EHRM INFRASTRU	CTURE UI
ment	Approved:		Location TUSCALOOSA VAMO	C, TUSCAL
epartment erans Affairs		FULLY SPRINKLERED	Issue Date 03/08/2024	Checked JKK
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B. ON DEMOLITION PLANS; EXISTING MECHANICAL SYSTEMS TO BE REMOVED ARE SHOWN HATCHED AND/OR DASHED, EXISTING MECHANICAL SYSTEMS TO REMAIN ARE SHOWN LIGHT LINE WEIGHT. ON ALL OTHER C. UNLESS NOTED OTHERWISE, DETAILS SHOWN WITHIN THESE DOCUMENTS ARE APPLICABLE FOR ALL PIPING, EQUIPMENT AND DUCTWORK INSTALLATIONS WHETHER OR NOT SPECIFICALLY NOTED. D. THE OWNER AND ENGINEER ARE NOT RESPONSIBLE FOR THE CONTRACTOR'S SAFETY PRECAUTIONS OR FOR THE MEANS, METHODS, TECHNIQUES, CONSTRUCTION SEQUENCES, OR PROCEDURES REQUIRED TO

1. DEMOLISH FIRE PROTECTION PIPING BACK TO BOUNDARY OF NEW TR.

2. INSTALL NEW UPRIGHT SPRINKLER HEAD WITH MECHANICAL GUARDS TO SERVE 100. VERIFY COVERAGE REQUIREMENTS.

4. AREA OF EXISTING SPRINKLER COVERAGE. HAZARD CLASSIFICATION "LIGHT HAZARD". RELOCATE AND/OR ADD ADDITIONAL HEADS AND PIPING TO MEET COVERAGE REQUIREMENTS PER NFPA 13 AND VA REQUIREMENTS. COORDINATE HEAD LOCATIONS WITH EXISTING CONDITIONS AND ARCHITECT'S CEILING

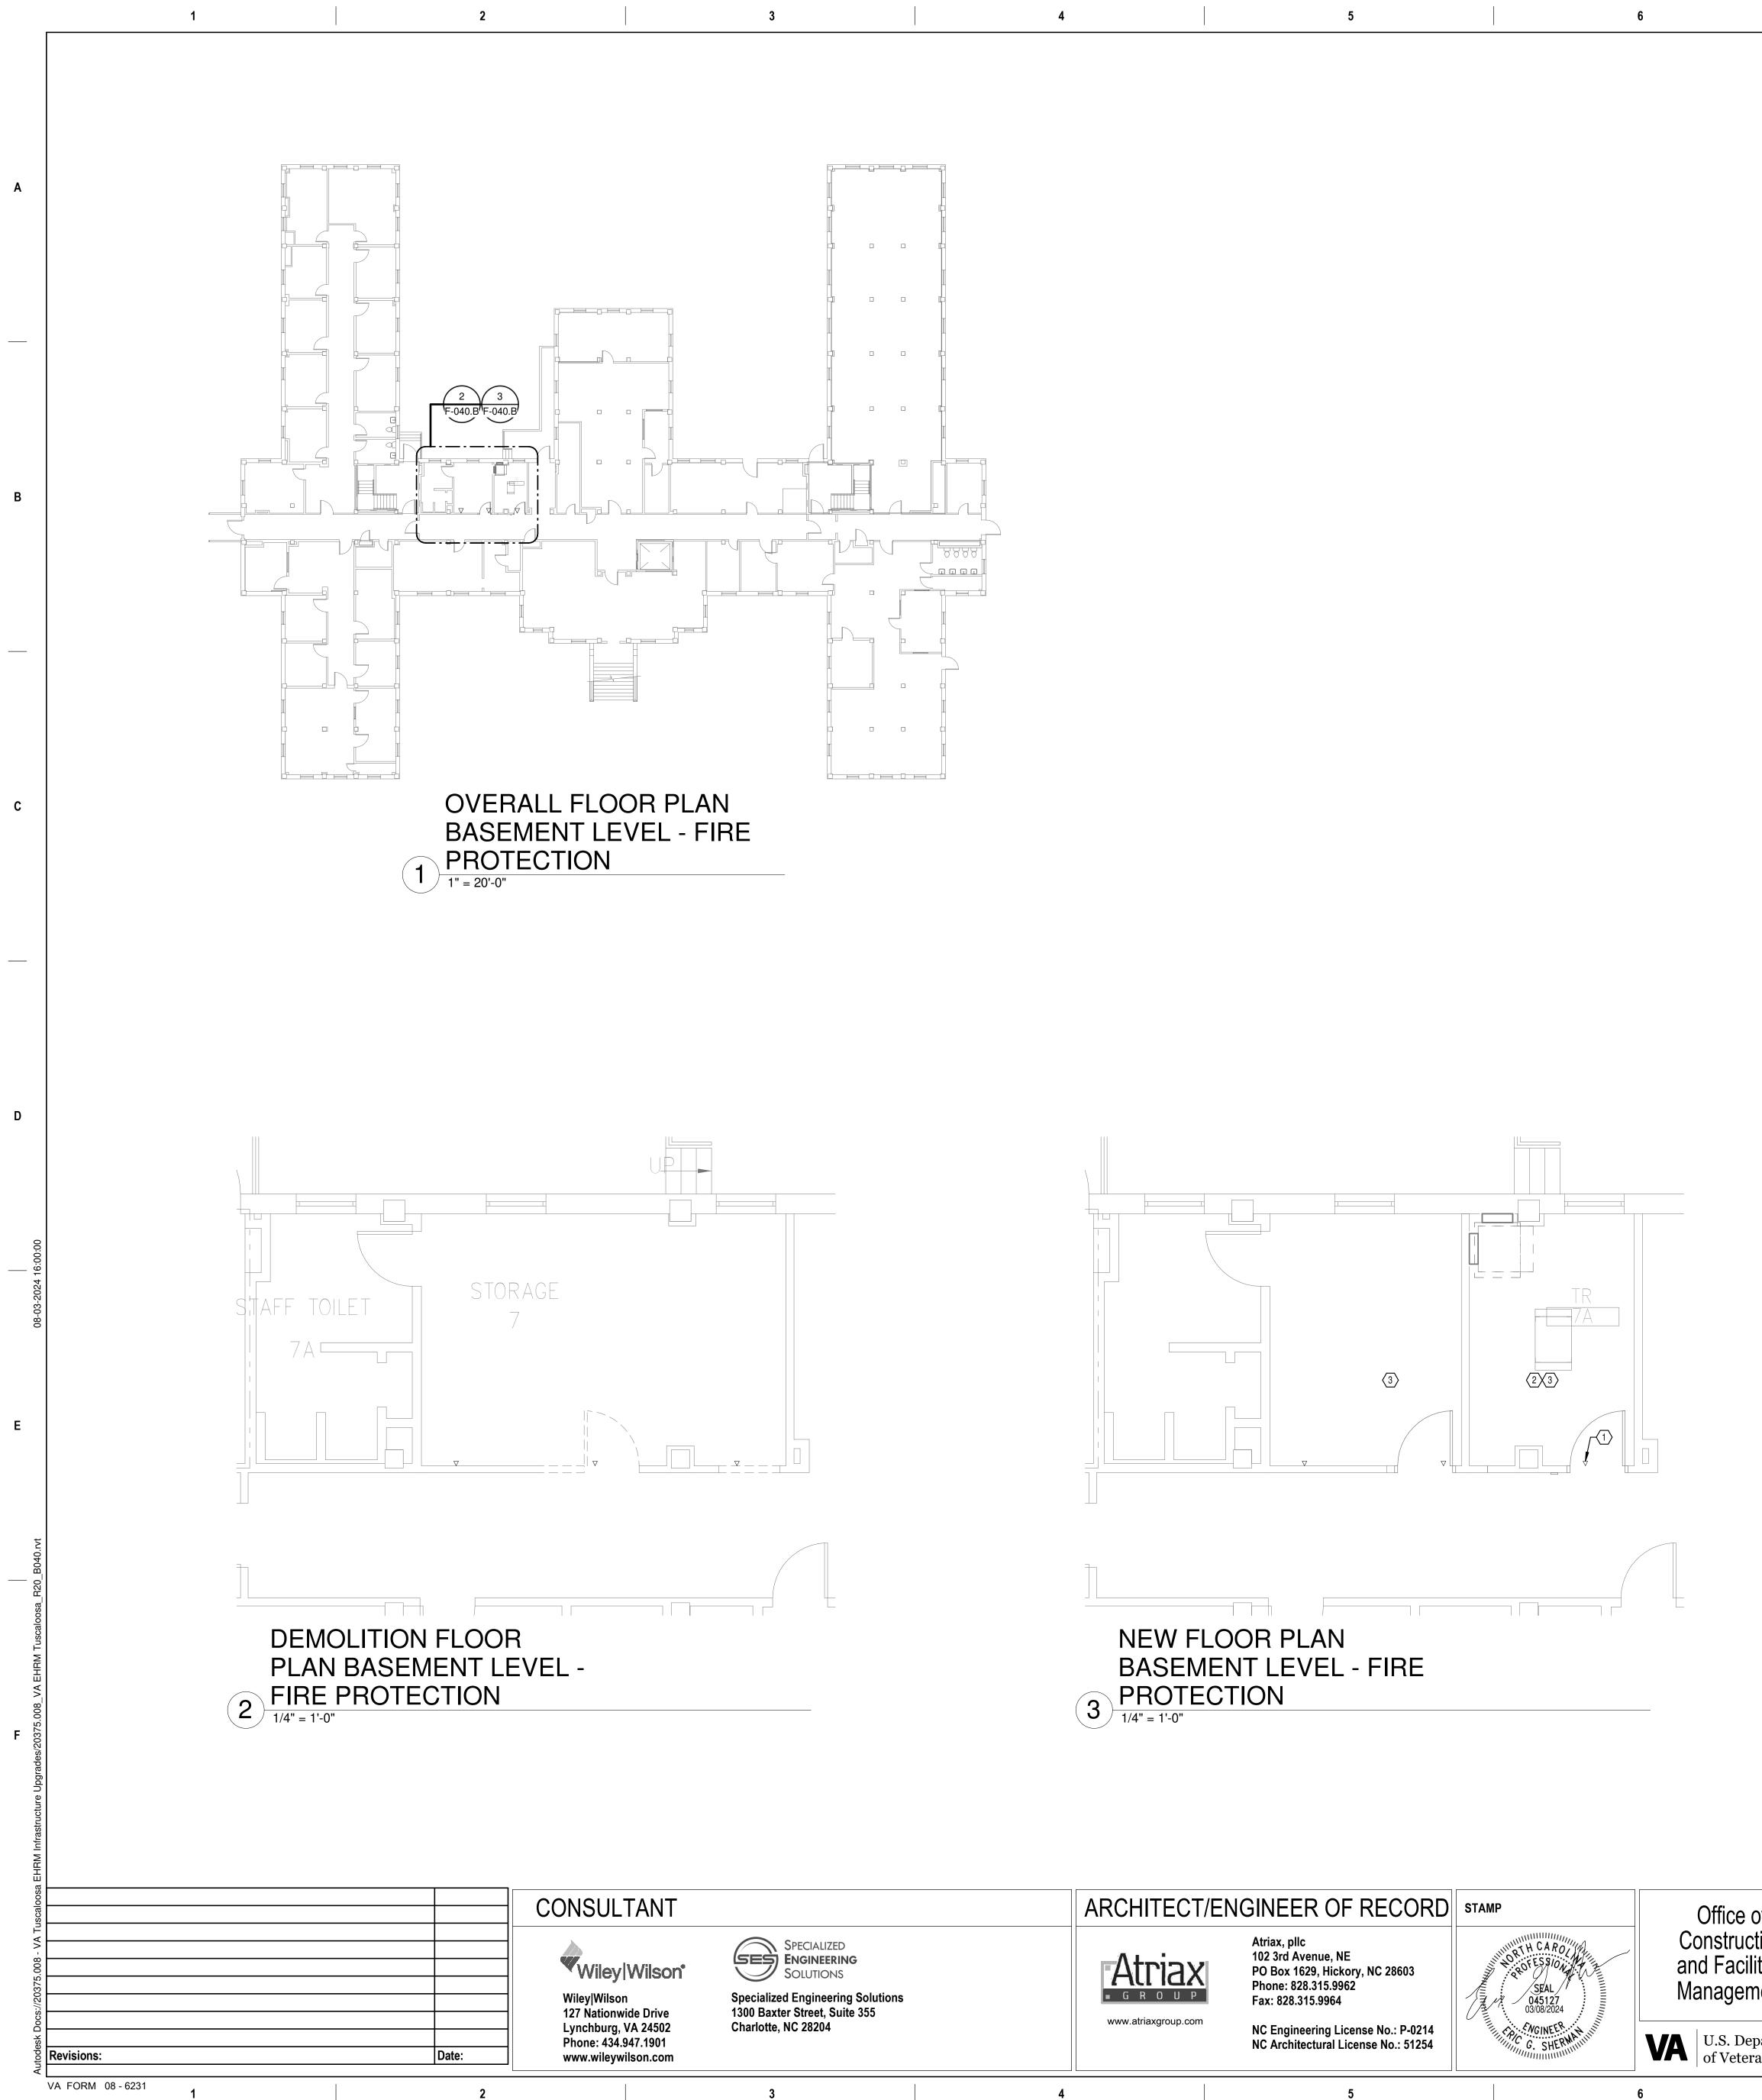
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# **GENERAL NOTES:**

- A. COVER SHEET GENERAL NOTES APPLY TO ALL SHEETS.

- FOR THE MEANS, METHODS, TECHNIQUES, CONSTRUCTION SEQUENCES, OR PROCEDURES REQUIRED TO PERFORM THIS WORK.

### SHEET NOTES:

- PLANS.

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e of Iction Silities	Drawing Title BUILDING 40 BASEMENT LEVEL - FIRE PROTECTION	Phase 100% CONSTRUCTION DOCUMENTS	Project Title EHRM INFRASTF	RUCTURE UI
ement	Approved:		Location TUSCALOOSA VA	MC, TUSCAL
epartment erans Affairs		FULLY SPRINKLERED	Issue Date 03/08/2024	Checked JKK
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B. ON DEMOLITION PLANS; EXISTING MECHANICAL SYSTEMS TO BE REMOVED ARE SHOWN HATCHED AND/OR DASHED, EXISTING MECHANICAL SYSTEMS TO REMAIN ARE SHOWN LIGHT LINE WEIGHT. ON ALL OTHER PLANS, NEW MECHANICAL SYSTEMS ARE INDICATED WITH HEAVY LINE WEIGHTS. C. UNLESS NOTED OTHERWISE, DETAILS SHOWN WITHIN THESE DOCUMENTS ARE APPLICABLE FOR ALL PIPING, EQUIPMENT AND DUCTWORK INSTALLATIONS WHETHER OR NOT SPECIFICALLY NOTED. D. THE OWNER AND ENGINEER ARE NOT RESPONSIBLE FOR THE CONTRACTOR'S SAFETY PRECAUTIONS OR

1. INSTALL MECHANICAL GUARDS ON EXISTING SIDEWALL SPRINKLER. VERIFY COVERAGE REQUIREMENTS. 2. SPRINKLER PIPING SHALL NOT BE ROUTED ABOVE EQUIPMENT RACKS OR ELECTRICAL PANELS. 3. AREA OF EXISTING SPRINKLER COVERAGE. HAZARD CLASSIFICATION "LIGHT HAZARD". RELOCATE AND/OR ADD ADDITIONAL HEADS AND PIPING TO MEET COVERAGE REQUIREMENTS PER NFPA 13 AND VA REQUIREMENTS. COORDINATE HEAD LOCATIONS WITH EXISTING CONDITIONS AND ARCHITECT'S CEILING

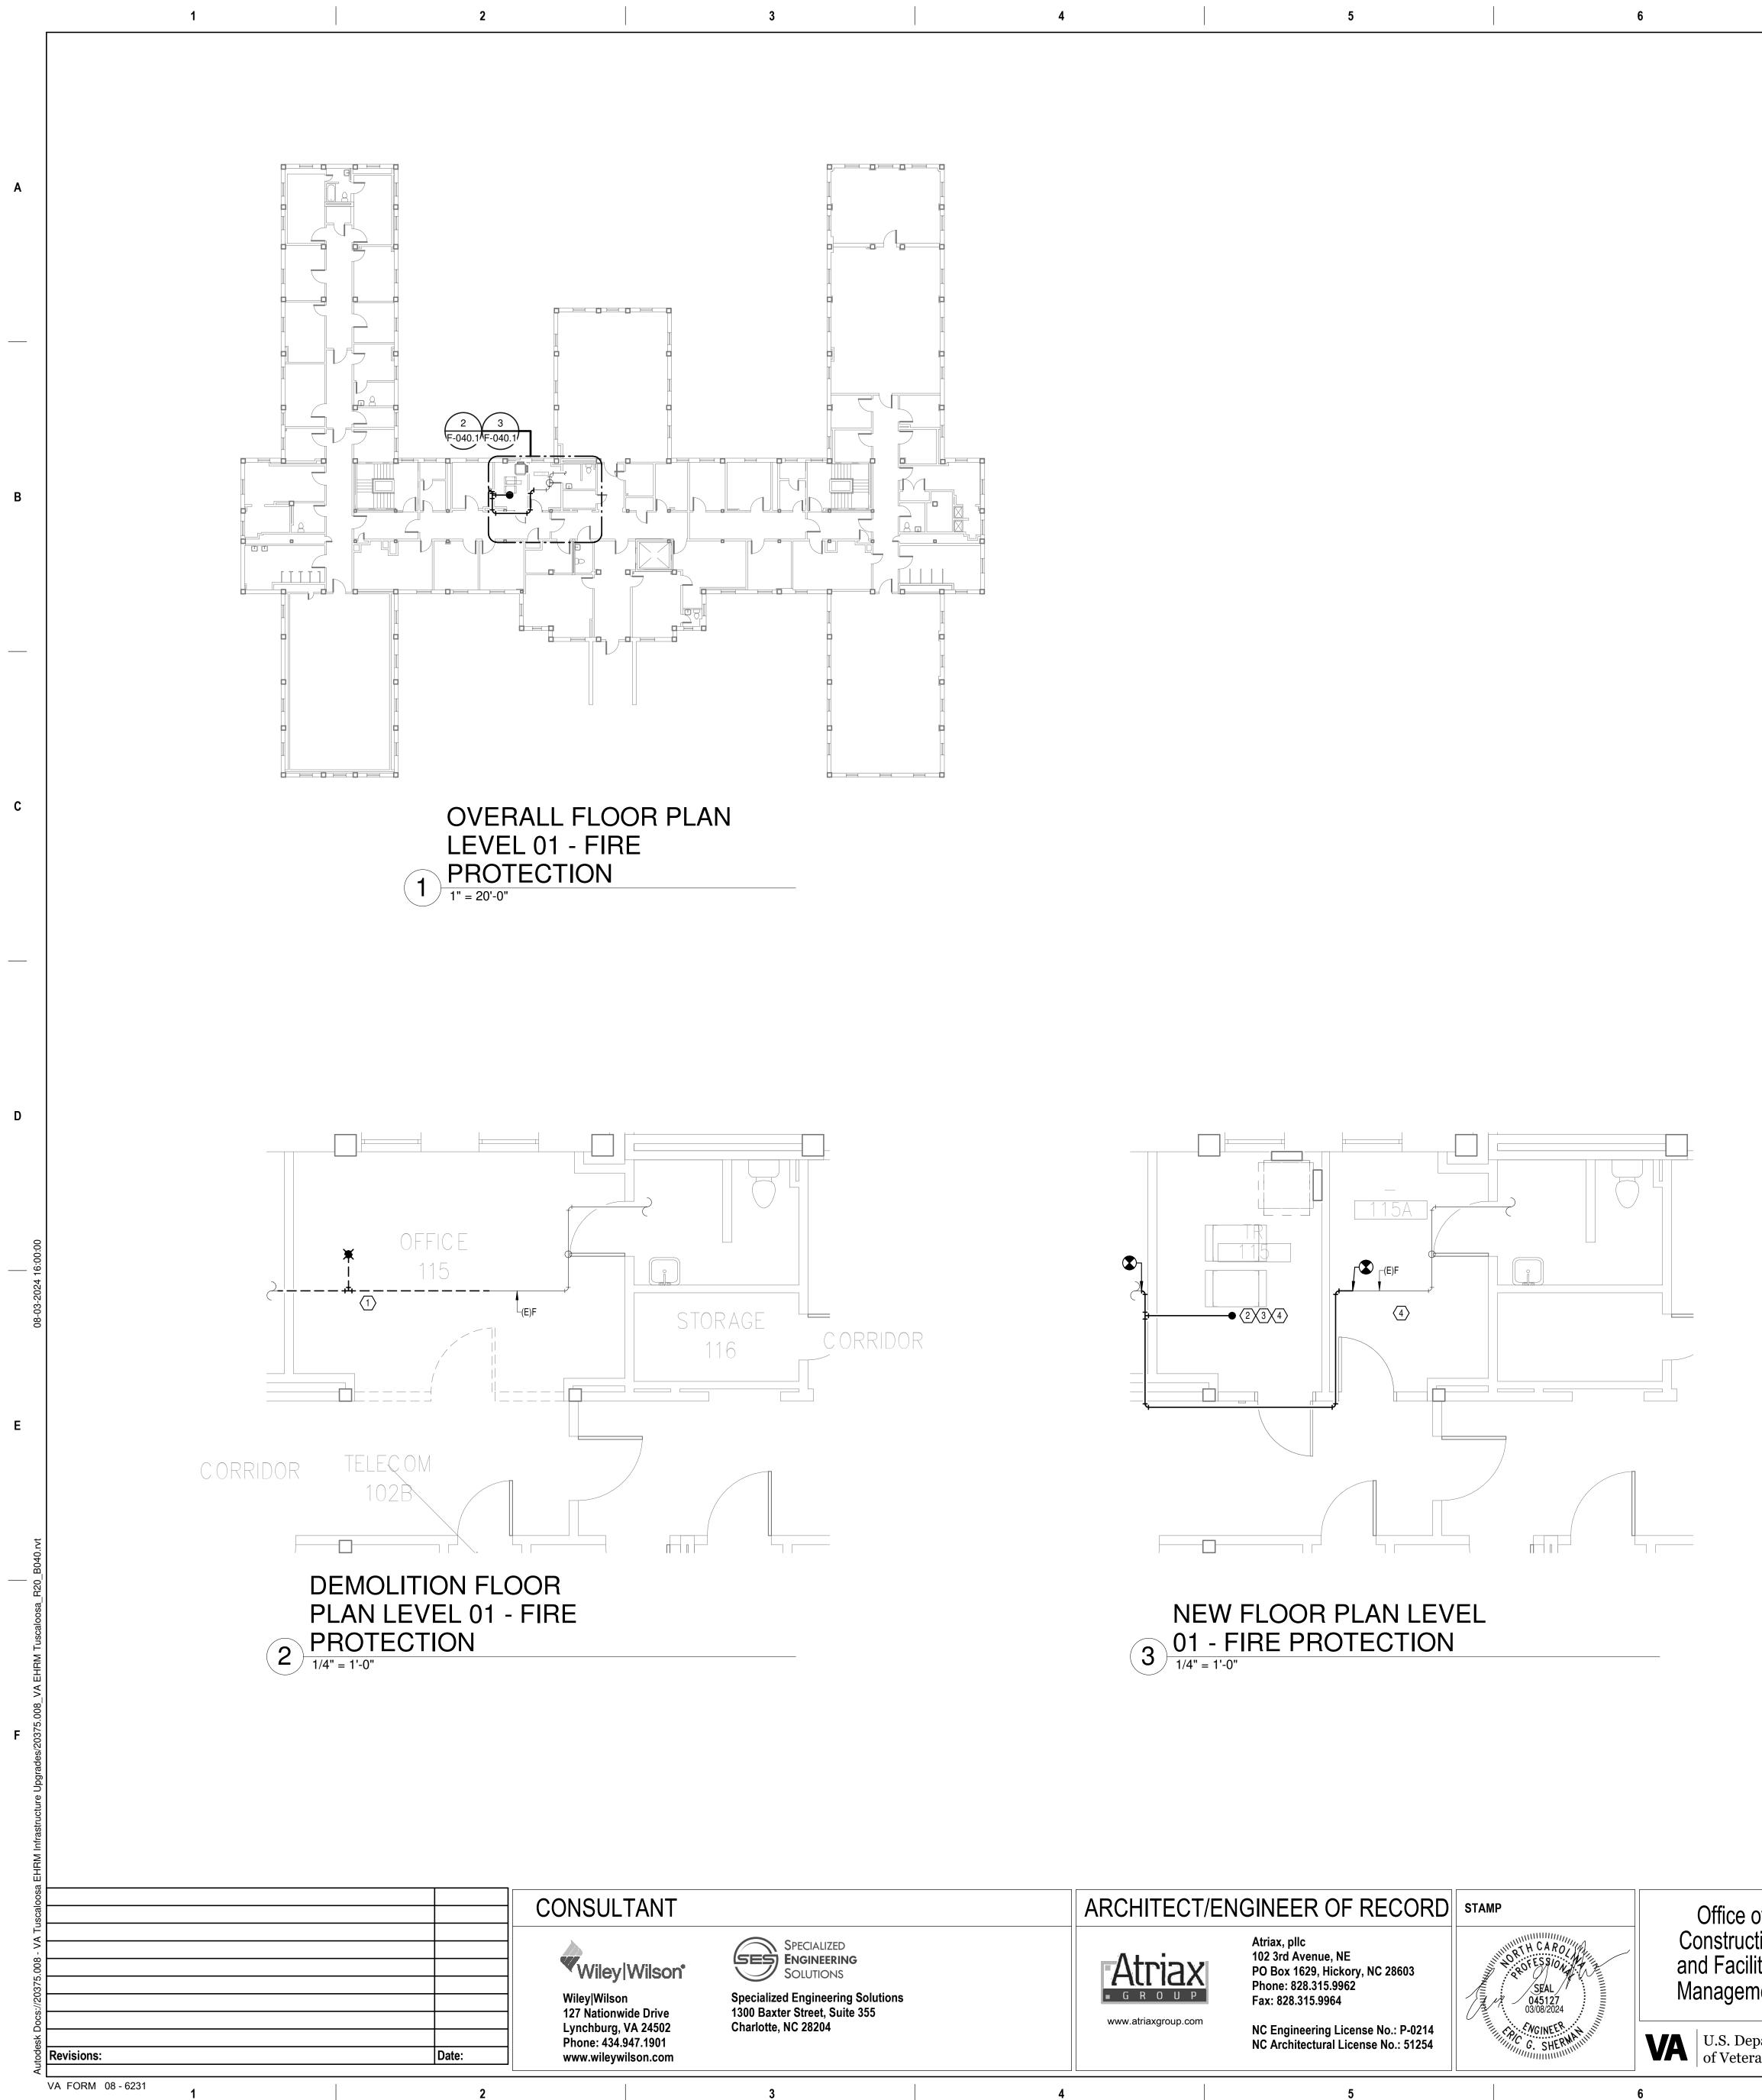
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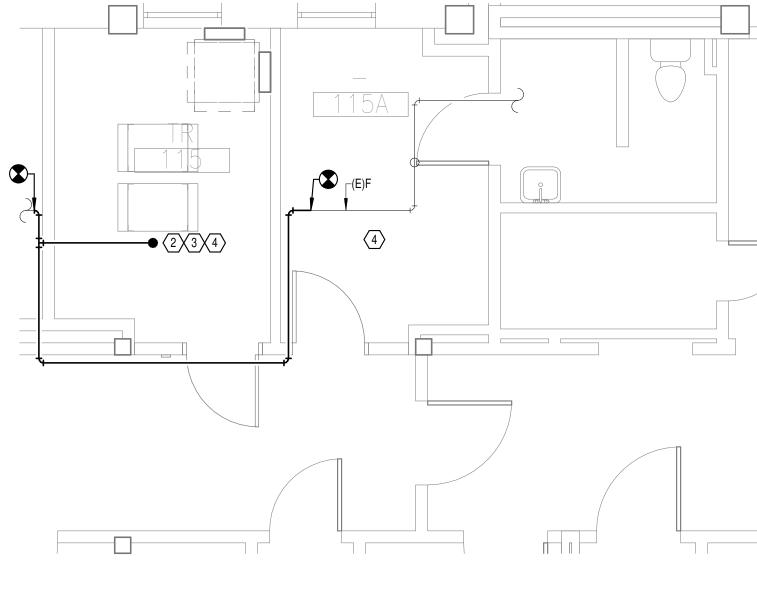
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	TRUE
JCTURE UPGRADES	Project Number 679-20-104 Building Number 40
C, TUSCALOOSA, AL. Сhecked JKK РСМ	Drawing Number F-040.B







### **GENERAL NOTES:**

- A. COVER SHEET GENERAL NOTES APPLY TO ALL SHEETS.
- PLANS, NEW MECHANICAL SYSTEMS ARE INDICATED WITH HEAVY LINE WEIGHTS.
- FOR THE MEANS, METHODS, TECHNIQUES, CONSTRUCTION SEQUENCES, OR PROCEDURES REQUIRED TO PERFORM THIS WORK.

### SHEET NOTES:

- REQUIREMENTS.
- 3. SPRINKLER PIPING SHALL NOT BE ROUTED ABOVE EQUIPMENT RACKS OR ELECTRICAL PANELS. PLANS.

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of ction ilities	Drawing Title BUILDING 40 LEVEL 01 - FIRE PROTECTION	Phase 100% CONSTRUCTION DOCUMENTS	Project Title EHRM INFRASTRUCTURE U
ment	Approved:		Location TUSCALOOSA VAMC, TUSCA
epartment erans Affairs		FULLY SPRINKLERED	Issue Date 03/08/2024 JKK
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B. ON DEMOLITION PLANS; EXISTING MECHANICAL SYSTEMS TO BE REMOVED ARE SHOWN HATCHED AND/OR DASHED, EXISTING MECHANICAL SYSTEMS TO REMAIN ARE SHOWN LIGHT LINE WEIGHT. ON ALL OTHER C. UNLESS NOTED OTHERWISE, DETAILS SHOWN WITHIN THESE DOCUMENTS ARE APPLICABLE FOR ALL PIPING, EQUIPMENT AND DUCTWORK INSTALLATIONS WHETHER OR NOT SPECIFICALLY NOTED. D. THE OWNER AND ENGINEER ARE NOT RESPONSIBLE FOR THE CONTRACTOR'S SAFETY PRECAUTIONS OR

1. DEMOLISH FIRE PROTECTION PIPING BACK TO BOUNDARY OF NEW TR 115.

2. INSTALL NEW UPRIGHT SPRINKLER HEAD WITH MECHANICAL GUARDS TO SERVE 115. VERIFY COVERAGE

4. AREA OF EXISTING SPRINKLER COVERAGE. HAZARD CLASSIFICATION "LIGHT HAZARD". RELOCATE AND/OR ADD ADDITIONAL HEADS AND PIPING TO MEET COVERAGE REQUIREMENTS PER NFPA 13 AND VA REQUIREMENTS. COORDINATE HEAD LOCATIONS WITH EXISTING CONDITIONS AND ARCHITECT'S CEILING

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TRUE
Project Number 679-20-104
Building Number 40
Drawing Number
F-040.1





# **GENERAL NOTES:**

- A. COVER SHEET GENERAL NOTES APPLY TO ALL SHEETS.
- PLANS, NEW MECHANICAL SYSTEMS ARE INDICATED WITH HEAVY LINE WEIGHTS.
- PERFORM THIS WORK.

### SHEET NOTES:

- SPRINKLER OUTAGE IN THE ROOM.
- SHALL OCCUR AT THE SAME TIME TO AVOID A SPRINKLER OUTAGE IN THE ROOM.
- ADD ADDITIONAL HEADS AND PIPING TO MEET COVERAGE REQUIREMENTS PER NFPA 13 AND VA REQUIREMENTS. COORDINATE HEAD LOCATIONS WITH EXISTING CONDITIONS AND ARCHITECT'S CEILING PLANS.

			PLA
of ction ilities	Drawing Title BUILDING 40 LEVEL 02 - FIRE PROTECTION	Phase 100% CONSTRUCTION DOCUMENTS	Project Title EHRM INFRASTRUCTURE
ment	Approved:		Location TUSCALOOSA VAMC, TUS
epartment erans Affairs		FULLY SPRINKLERED	Issue Date 03/08/2024 JKK
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B. ON DEMOLITION PLANS; EXISTING MECHANICAL SYSTEMS TO BE REMOVED ARE SHOWN HATCHED AND/OR DASHED, EXISTING MECHANICAL SYSTEMS TO REMAIN ARE SHOWN LIGHT LINE WEIGHT. ON ALL OTHER C. UNLESS NOTED OTHERWISE, DETAILS SHOWN WITHIN THESE DOCUMENTS ARE APPLICABLE FOR ALL PIPING, EQUIPMENT AND DUCTWORK INSTALLATIONS WHETHER OR NOT SPECIFICALLY NOTED. D. THE OWNER AND ENGINEER ARE NOT RESPONSIBLE FOR THE CONTRACTOR'S SAFETY PRECAUTIONS OR FOR THE MEANS, METHODS, TECHNIQUES, CONSTRUCTION SEQUENCES, OR PROCEDURES REQUIRED TO

1. DEMOLISH EXISTING SPRINKLER HEAD FOR CEILING REMOVAL AND SPRINKLER PIPE TO POINT INDICATED. REFER TO NEW WORK PLANS FOR INSTALLATION OF NEW UPRIGHT HEADS. REPLACEMENT OF THE EXISTING PENDENT SPRINKLER WITH NEW UPRIGHT SPRINKLER SHALL OCCUR AT THE SAME TIME TO AVOID A

2. INSTALL NEW UPRIGHT SPRINKLER HEADS WITH MECHANICAL GUARDS TO SERVE 215. VERIFY COVERAGE REQUIREMENTS. REPLACEMENT OF THE EXISTING PENDENT SPRINKLER WITH NEW UPRIGHT SPRINKLER 3. SPRINKLER PIPING SHALL NOT BE ROUTED ABOVE EQUIPMENT RACKS OR ELECTRICAL PANELS. 4. AREA OF EXISTING SPRINKLER COVERAGE. HAZARD CLASSIFICATION "LIGHT HAZARD". RELOCATE AND/OR

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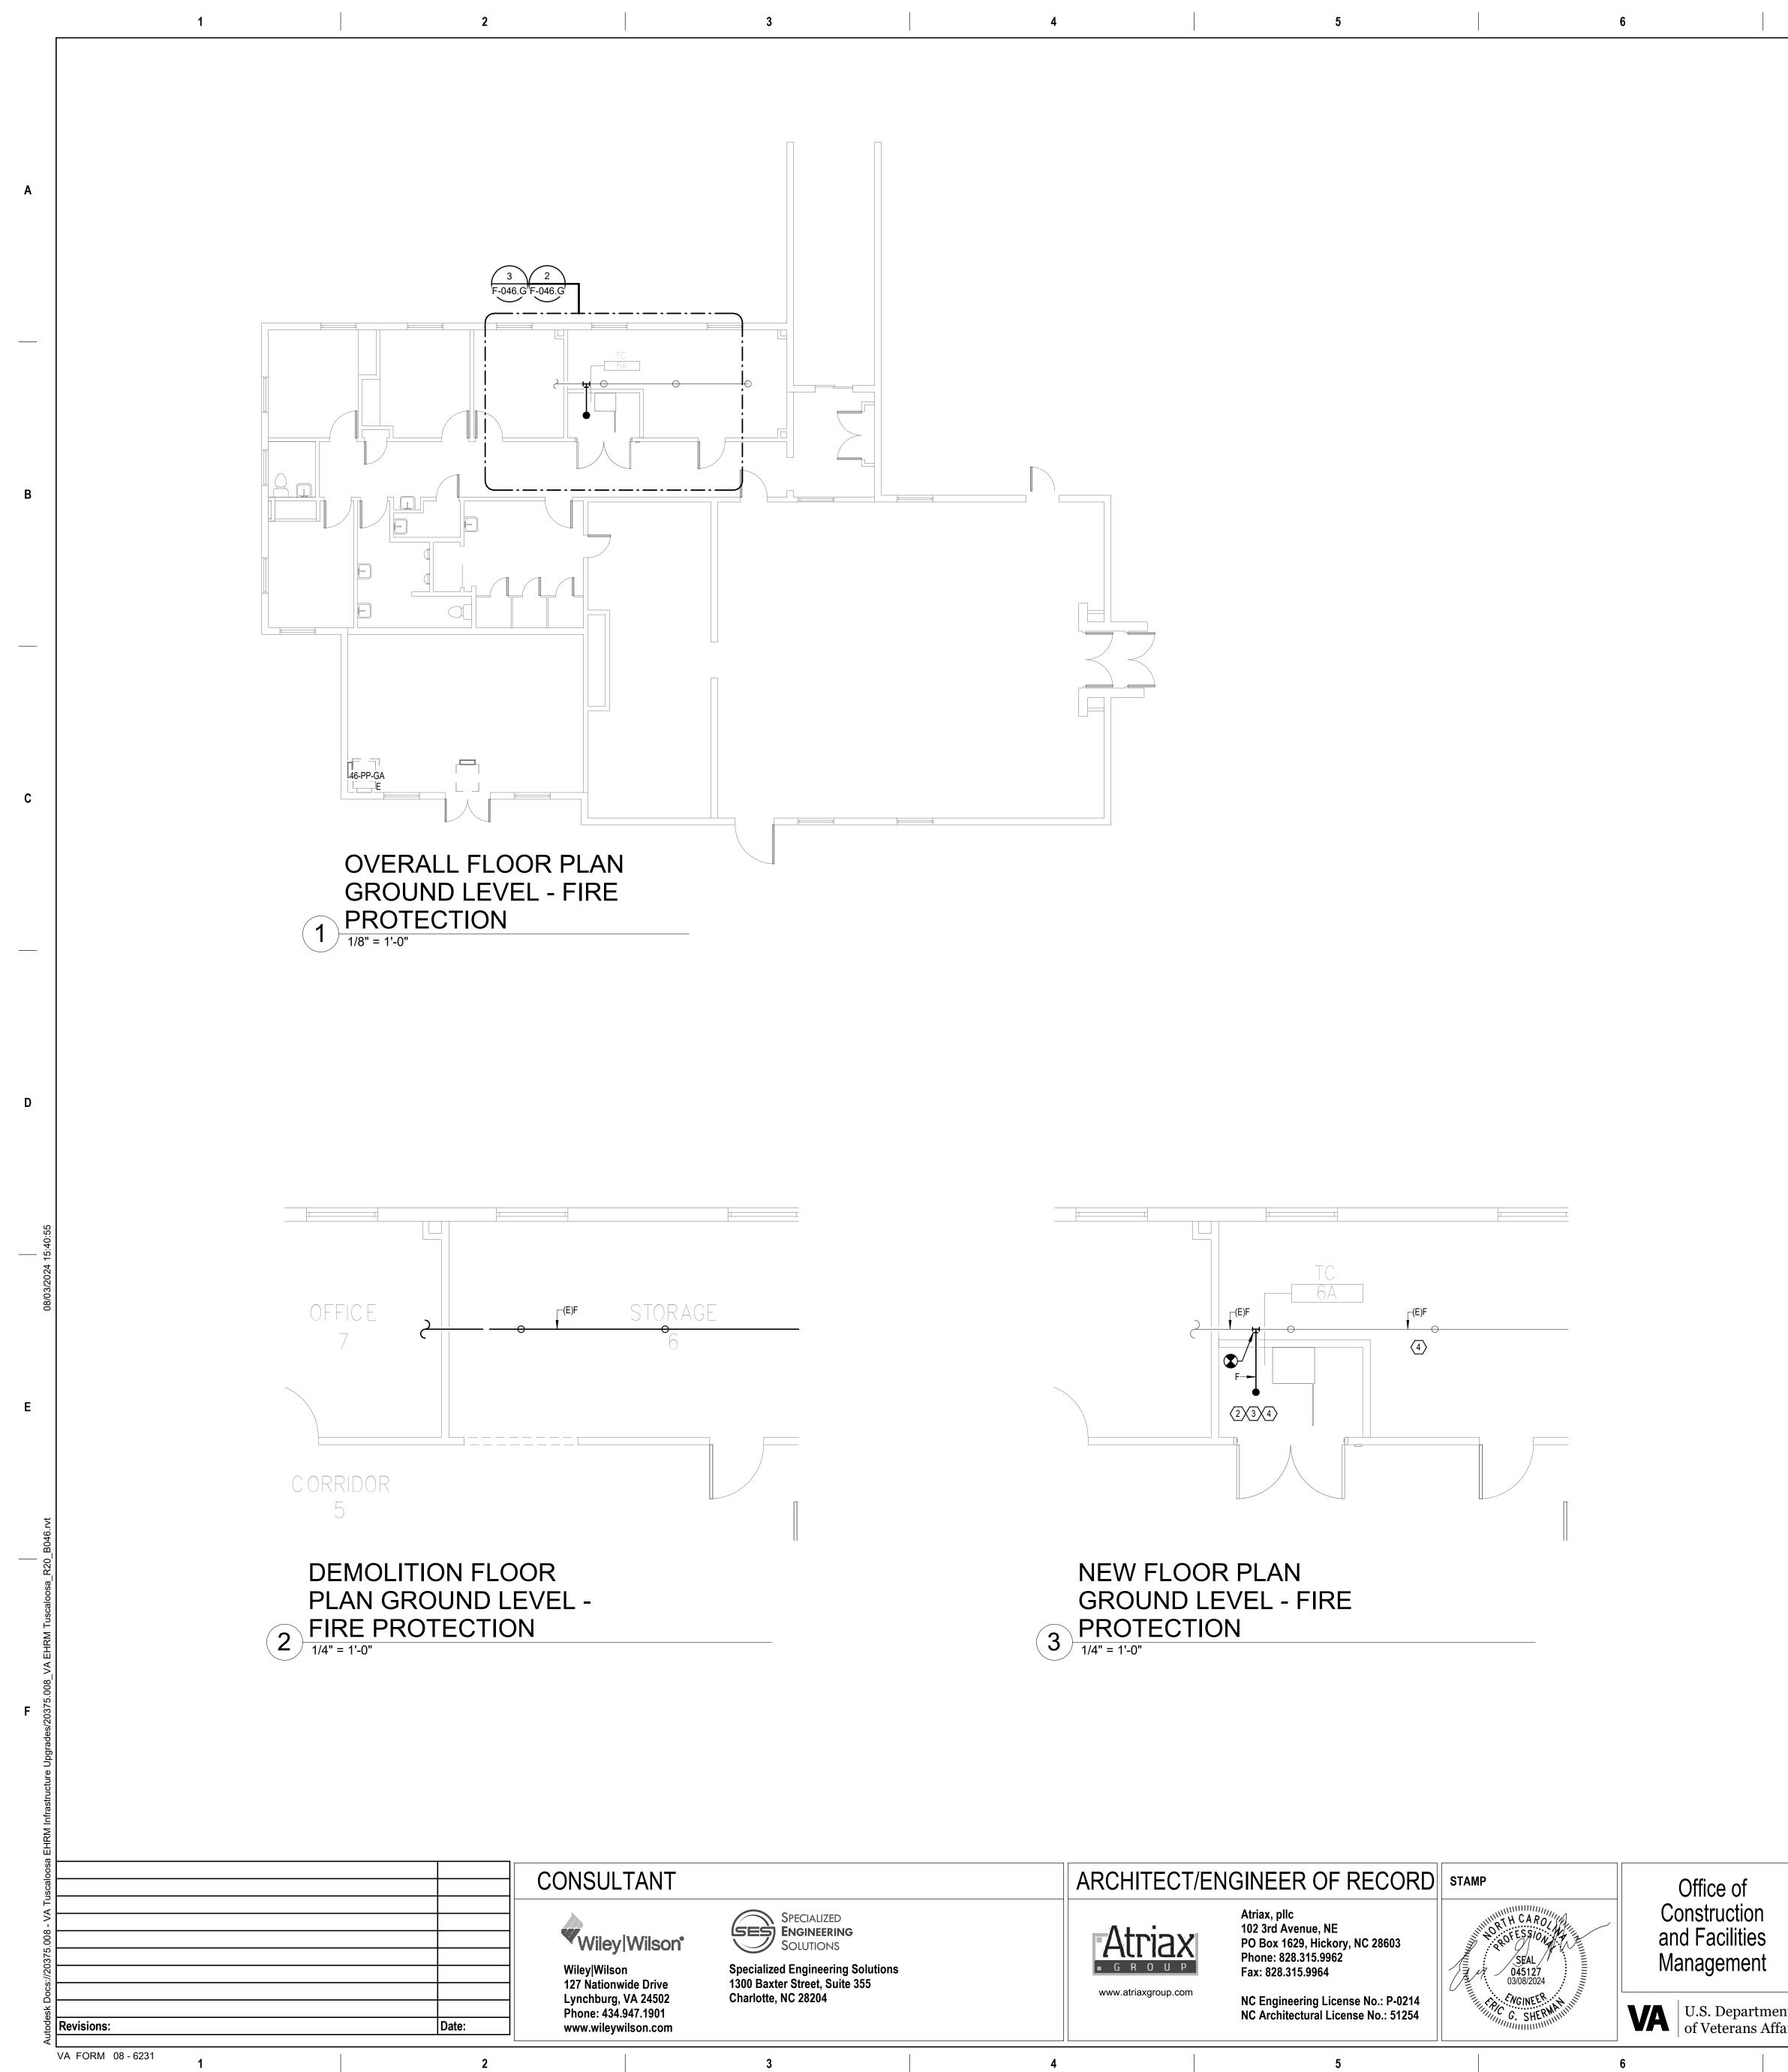
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N 2 Project Number URE UPGRADES 679-20-104 Building Number 40 Drawing Number USCALOOSA, AL. Drawn cked F-040.2 PCM



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### **GENERAL NOTES:**

- A. COVER SHEET GENERAL NOTES APPLY TO ALL SHEETS.
- PLANS, NEW MECHANICAL SYSTEMS ARE INDICATED WITH HEAVY LINE WEIGHTS.
- PERFORM THIS WORK.

### SHEET NOTES:

- OUTAGE IN THE ROOM.
- REQUIREMENTS. 3. SPRINKLER PIPING SHALL NOT BE ROUTED ABOVE EQUIPMENT RACKS OR ELECTRICAL PANELS.
- PLANS.

						PLAN
of tion ities	Drawing Title BUILDING 46 GROUND FIRE PROTECTION	) LEVEL -	<sup>Phase</sup> 100% CONSTR DOCUMENTS	UCTION	Project Title EHRM INFRAS	
nent	Approved:				Location TUSCALOOSA	VAMC, TUSCAL
partment ans Affairs	5		FULLY SPRIN	KLERED	Issue Date 03/08/2024	Checked JKK
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B. ON DEMOLITION PLANS; EXISTING MECHANICAL SYSTEMS TO BE REMOVED ARE SHOWN HATCHED AND/OR DASHED, EXISTING MECHANICAL SYSTEMS TO REMAIN ARE SHOWN LIGHT LINE WEIGHT. ON ALL OTHER C. UNLESS NOTED OTHERWISE, DETAILS SHOWN WITHIN THESE DOCUMENTS ARE APPLICABLE FOR ALL PIPING, EQUIPMENT AND DUCTWORK INSTALLATIONS WHETHER OR NOT SPECIFICALLY NOTED. D. THE OWNER AND ENGINEER ARE NOT RESPONSIBLE FOR THE CONTRACTOR'S SAFETY PRECAUTIONS OR FOR THE MEANS, METHODS, TECHNIQUES, CONSTRUCTION SEQUENCES, OR PROCEDURES REQUIRED TO

1. REMOVE EXISTING SPRINKLER HEAD FOR CEILING REMOVAL. REPLACEMENT OF THE EXISTING PENDENT SPRINKLER WITH NEW UPRIGHT SPRINKLER SHALL OCCUR AT THE SAME TIME TO AVOID A SPRINKLER

2. INSTALL NEW UPRIGHT SPRINKLER HEAD WITH MECHANICAL GUARDS TO SERVE 6A. VERIFY COVERAGE

4. AREA OF EXISTING SPRINKLER COVERAGE. HAZARD CLASSIFICATION "LIGHT HAZARD". RELOCATE AND/OR ADD ADDITIONAL HEADS AND PIPING TO MEET COVERAGE REQUIREMENTS PER NFPA 13 AND VA REQUIREMENTS. COORDINATE HEAD LOCATIONS WITH EXISTING CONDITIONS AND ARCHITECT'S CEILING

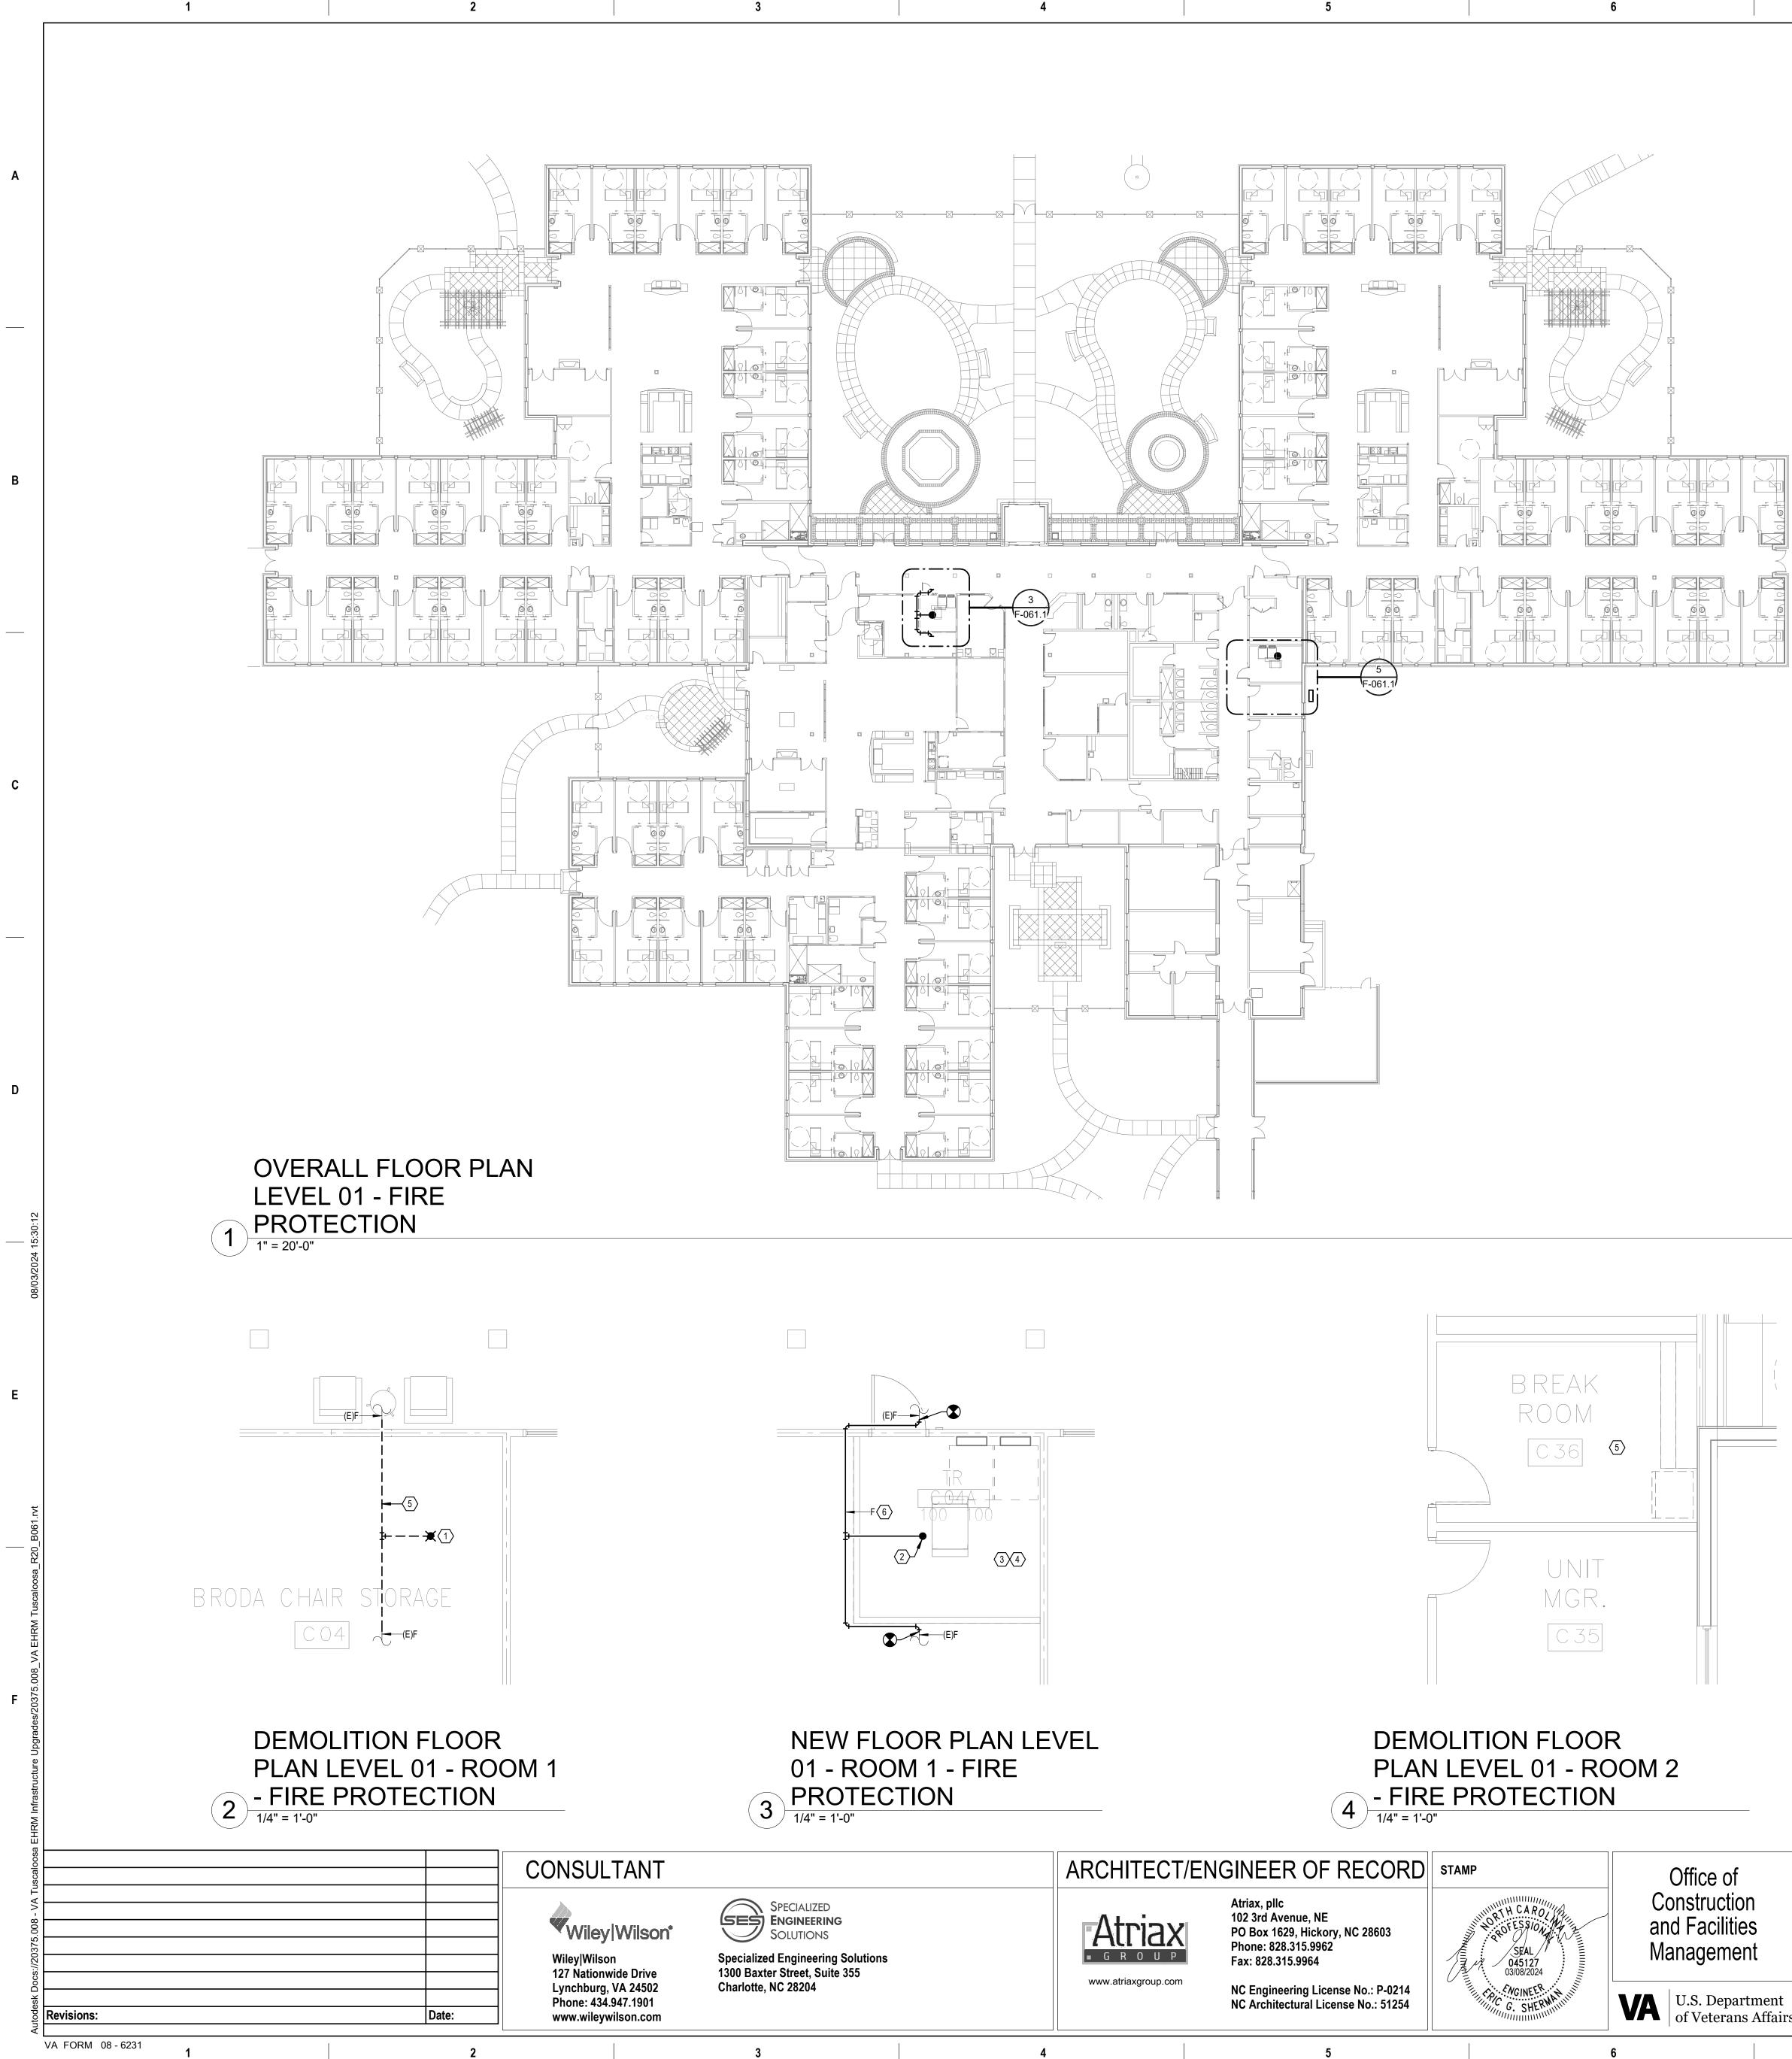
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PLAN		TRUE		
UCTURE UPGRADES		Project Number 679-20-104		
		Building Number 46		
MC, TUSCALOO	SA, AL.	Drawing Number		
Checked JKK	Drawn PCM	F-046.G		



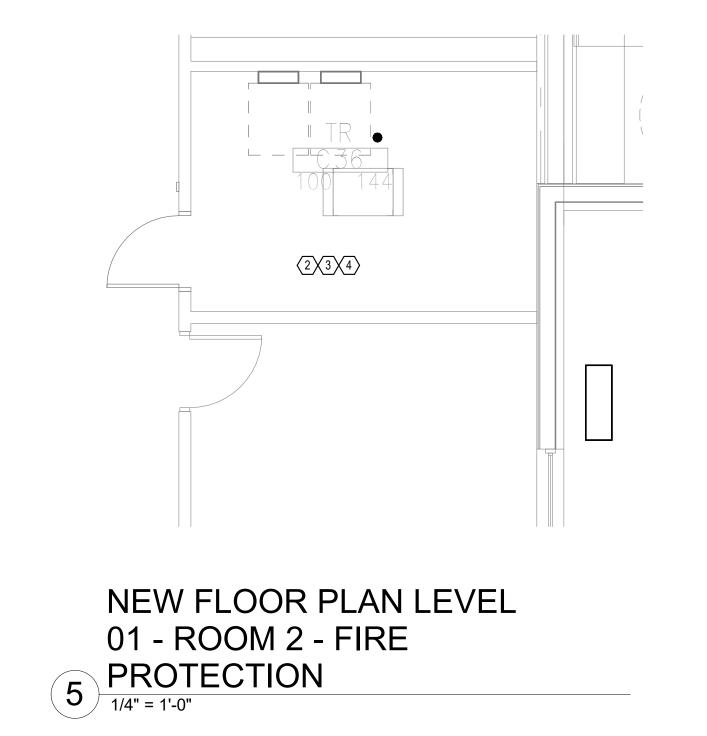
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### **GENERAL NOTES:**

- A. COVER SHEET GENERAL NOTES APPLY TO ALL SHEETS.
- PLANS, NEW MECHANICAL SYSTEMS ARE INDICATED WITH HEAVY LINE WEIGHTS.
- FOR THE MEANS, METHODS, TECHNIQUES, CONSTRUCTION SEQUENCES, OR PROCEDURES REQUIRED TO PERFORM THIS WORK.

### SHEET NOTES:

- SHALL OCCUR AT THE SAME TIME TO AVOID A SPRINKLER OUTAGE IN THE ROOM.
- PLANS.
- 5. DEMOLISH FIRE PROTECTION PIPING BACK TO BOUNDARY OF NEW TR.
- 6. REROUTE FIRE PROTECTION BRANCH OUTSIDE OF TR.



	$(5)^{11}_{1/4"}$	= 1'-0"				
e of iction cilities	Drawing Title BUILDING 61 LEVEL 01 PROTECTION		<sup>Phase</sup> 100% CONSTR DOCUMENTS	UCTION	Project Title EHRM INFRASTRU(	PLAN CTURE L
ement Department erans Affairs	Approved:		FULLY SPRIN	KLERED	Location TUSCALOOSA VAMC Issue Date 03/08/2024	C, TUSCA Checked JKK
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B. ON DEMOLITION PLANS; EXISTING MECHANICAL SYSTEMS TO BE REMOVED ARE SHOWN HATCHED AND/OR DASHED, EXISTING MECHANICAL SYSTEMS TO REMAIN ARE SHOWN LIGHT LINE WEIGHT. ON ALL OTHER C. UNLESS NOTED OTHERWISE, DETAILS SHOWN WITHIN THESE DOCUMENTS ARE APPLICABLE FOR ALL PIPING, EQUIPMENT AND DUCTWORK INSTALLATIONS WHETHER OR NOT SPECIFICALLY NOTED. D. THE OWNER AND ENGINEER ARE NOT RESPONSIBLE FOR THE CONTRACTOR'S SAFETY PRECAUTIONS OR

1. REMOVE EXISTING SPRINKLER HEAD FOR CEILING REMOVAL. REFER TO NEW WORK PLANS FOR INSTALLATION OF NEW UPRIGHT HEADS. REPLACEMENT OF THE EXISTING PENDENT SPRINKLER WITH NEW UPRIGHT SPRINKLER SHALL OCCUR AT THE SAME TIME TO AVOID A SPRINKLER OUTAGE IN THE ROOM. 2. INSTALL NEW UPRIGHT SPRINKLER HEADS WITH MECHANICAL GUARDS TO SERVE TR. VERIFY COVERAGE REQUIREMENTS. REPLACEMENT OF THE EXISTING PENDENT SPRINKLER WITH NEW UPRIGHT SPRINKLER 3. SPRINKLER PIPING SHALL NOT BE ROUTED ABOVE EQUIPMENT RACKS OR ELECTRICAL PANELS.

4. AREA OF EXISTING SPRINKLER COVERAGE. HAZARD CLASSIFICATION "LIGHT HAZARD". RELOCATE AND/OR ADD ADDITIONAL HEADS AND PIPING TO MEET COVERAGE REQUIREMENTS PER NFPA 13 AND VA REQUIREMENTS. COORDINATE HEAD LOCATIONS WITH EXISTING CONDITIONS AND ARCHITECT'S CEILING

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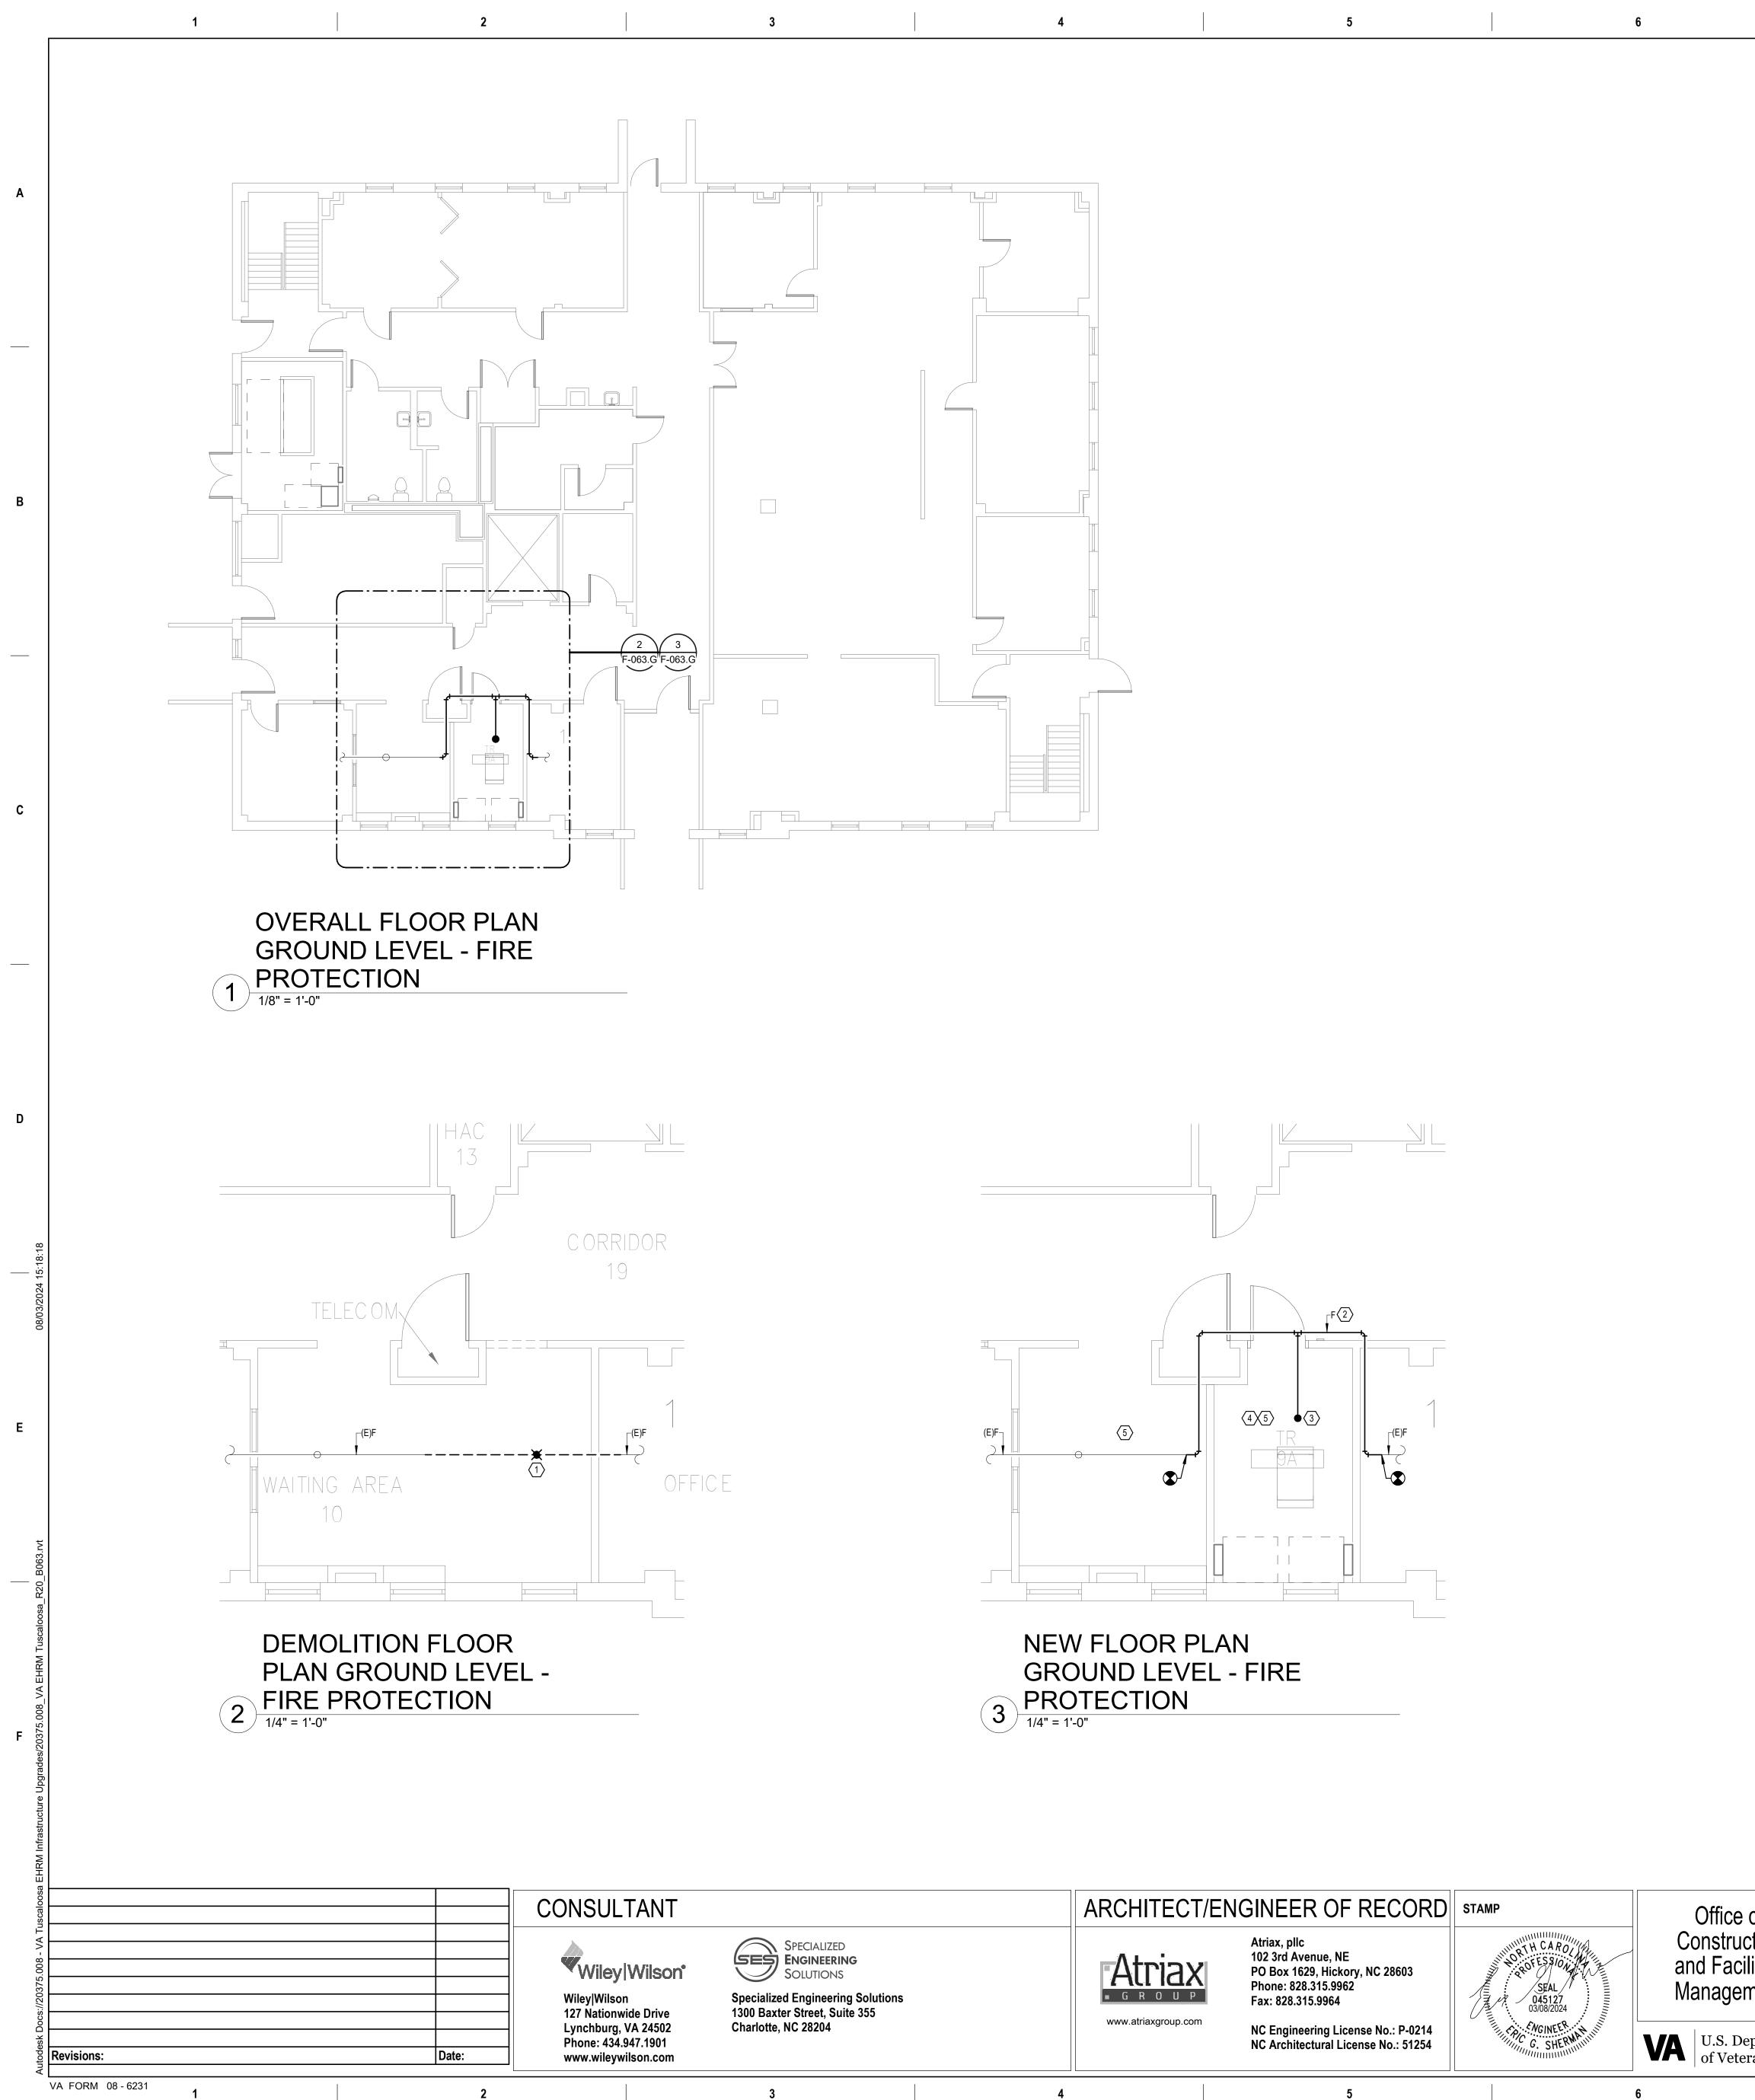
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PLAN		TRUE
UCTURE UPGRADES		Project Number 679-20-104
		Building Number 61
MC, TUSCALOC	)SA, AL.	Drawing Number
Checked JKK	Drawn PCM	F-061.1

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### **GENERAL NOTES:**

- A. COVER SHEET GENERAL NOTES APPLY TO ALL SHEETS.
- PLANS, NEW MECHANICAL SYSTEMS ARE INDICATED WITH HEAVY LINE WEIGHTS.
- PERFORM THIS WORK.

### SHEET NOTES:

- OUTAGE IN THE ROOM.
- 2. REROUTE NEW FIRE PROTECTION PIPING OUTSIDE OF NEW TR 10.
- 4. SPRINKLER PIPING SHALL NOT BE ROUTED ABOVE EQUIPMENT RACKS OR ELECTRICAL PANELS.
- PLANS.

					Plan
e of uction cilities	Drawing Title BUILDING 63 GROUND LEVEL - FIRE PROTECTION	Phase 100% CONSTRUCT DOCUMENTS		Project Title EHRM INFRASTRUC	TURE U
ement	Approved:			Location TUSCALOOSA VAMC	, TUSCA
Department erans Affairs		FULLY SPRINKLEF	RED	Issue Date 03/08/2024	Checked JKK
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B. ON DEMOLITION PLANS; EXISTING MECHANICAL SYSTEMS TO BE REMOVED ARE SHOWN HATCHED AND/OR DASHED, EXISTING MECHANICAL SYSTEMS TO REMAIN ARE SHOWN LIGHT LINE WEIGHT. ON ALL OTHER C. UNLESS NOTED OTHERWISE, DETAILS SHOWN WITHIN THESE DOCUMENTS ARE APPLICABLE FOR ALL PIPING, EQUIPMENT AND DUCTWORK INSTALLATIONS WHETHER OR NOT SPECIFICALLY NOTED.

D. THE OWNER AND ENGINEER ARE NOT RESPONSIBLE FOR THE CONTRACTOR'S SAFETY PRECAUTIONS OR FOR THE MEANS, METHODS, TECHNIQUES, CONSTRUCTION SEQUENCES, OR PROCEDURES REQUIRED TO

1. REMOVE EXISTING SPRINKLER HEAD FOR CEILING REMOVAL. REPLACEMENT OF THE EXISTING PENDENT SPRINKLER WITH NEW UPRIGHT SPRINKLER SHALL OCCUR AT THE SAME TIME TO AVOID A SPRINKLER

3. INSTALL NEW UPRIGHT SPRINKLER HEADS WITH MECHANICAL GUARDS TO SERVE TR 10. VERIFY COVERAGE REQUIREMENTS. REPLACEMENT OF THE EXISTING PENDENT SPRINKLER WITH NEW UPRIGHT SPRINKLER SHALL OCCUR AT THE SAME TIME TO AVOID A SPRINKLER OUTAGE IN THE ROOM.

5. AREA OF EXISTING SPRINKLER COVERAGE. HAZARD CLASSIFICATION "LIGHT HAZARD". RELOCATE AND/OR ADD ADDITIONAL HEADS AND PIPING TO MEET COVERAGE REQUIREMENTS PER NFPA 13 AND VA REQUIREMENTS. COORDINATE HEAD LOCATIONS WITH EXISTING CONDITIONS AND ARCHITECT'S CEILING

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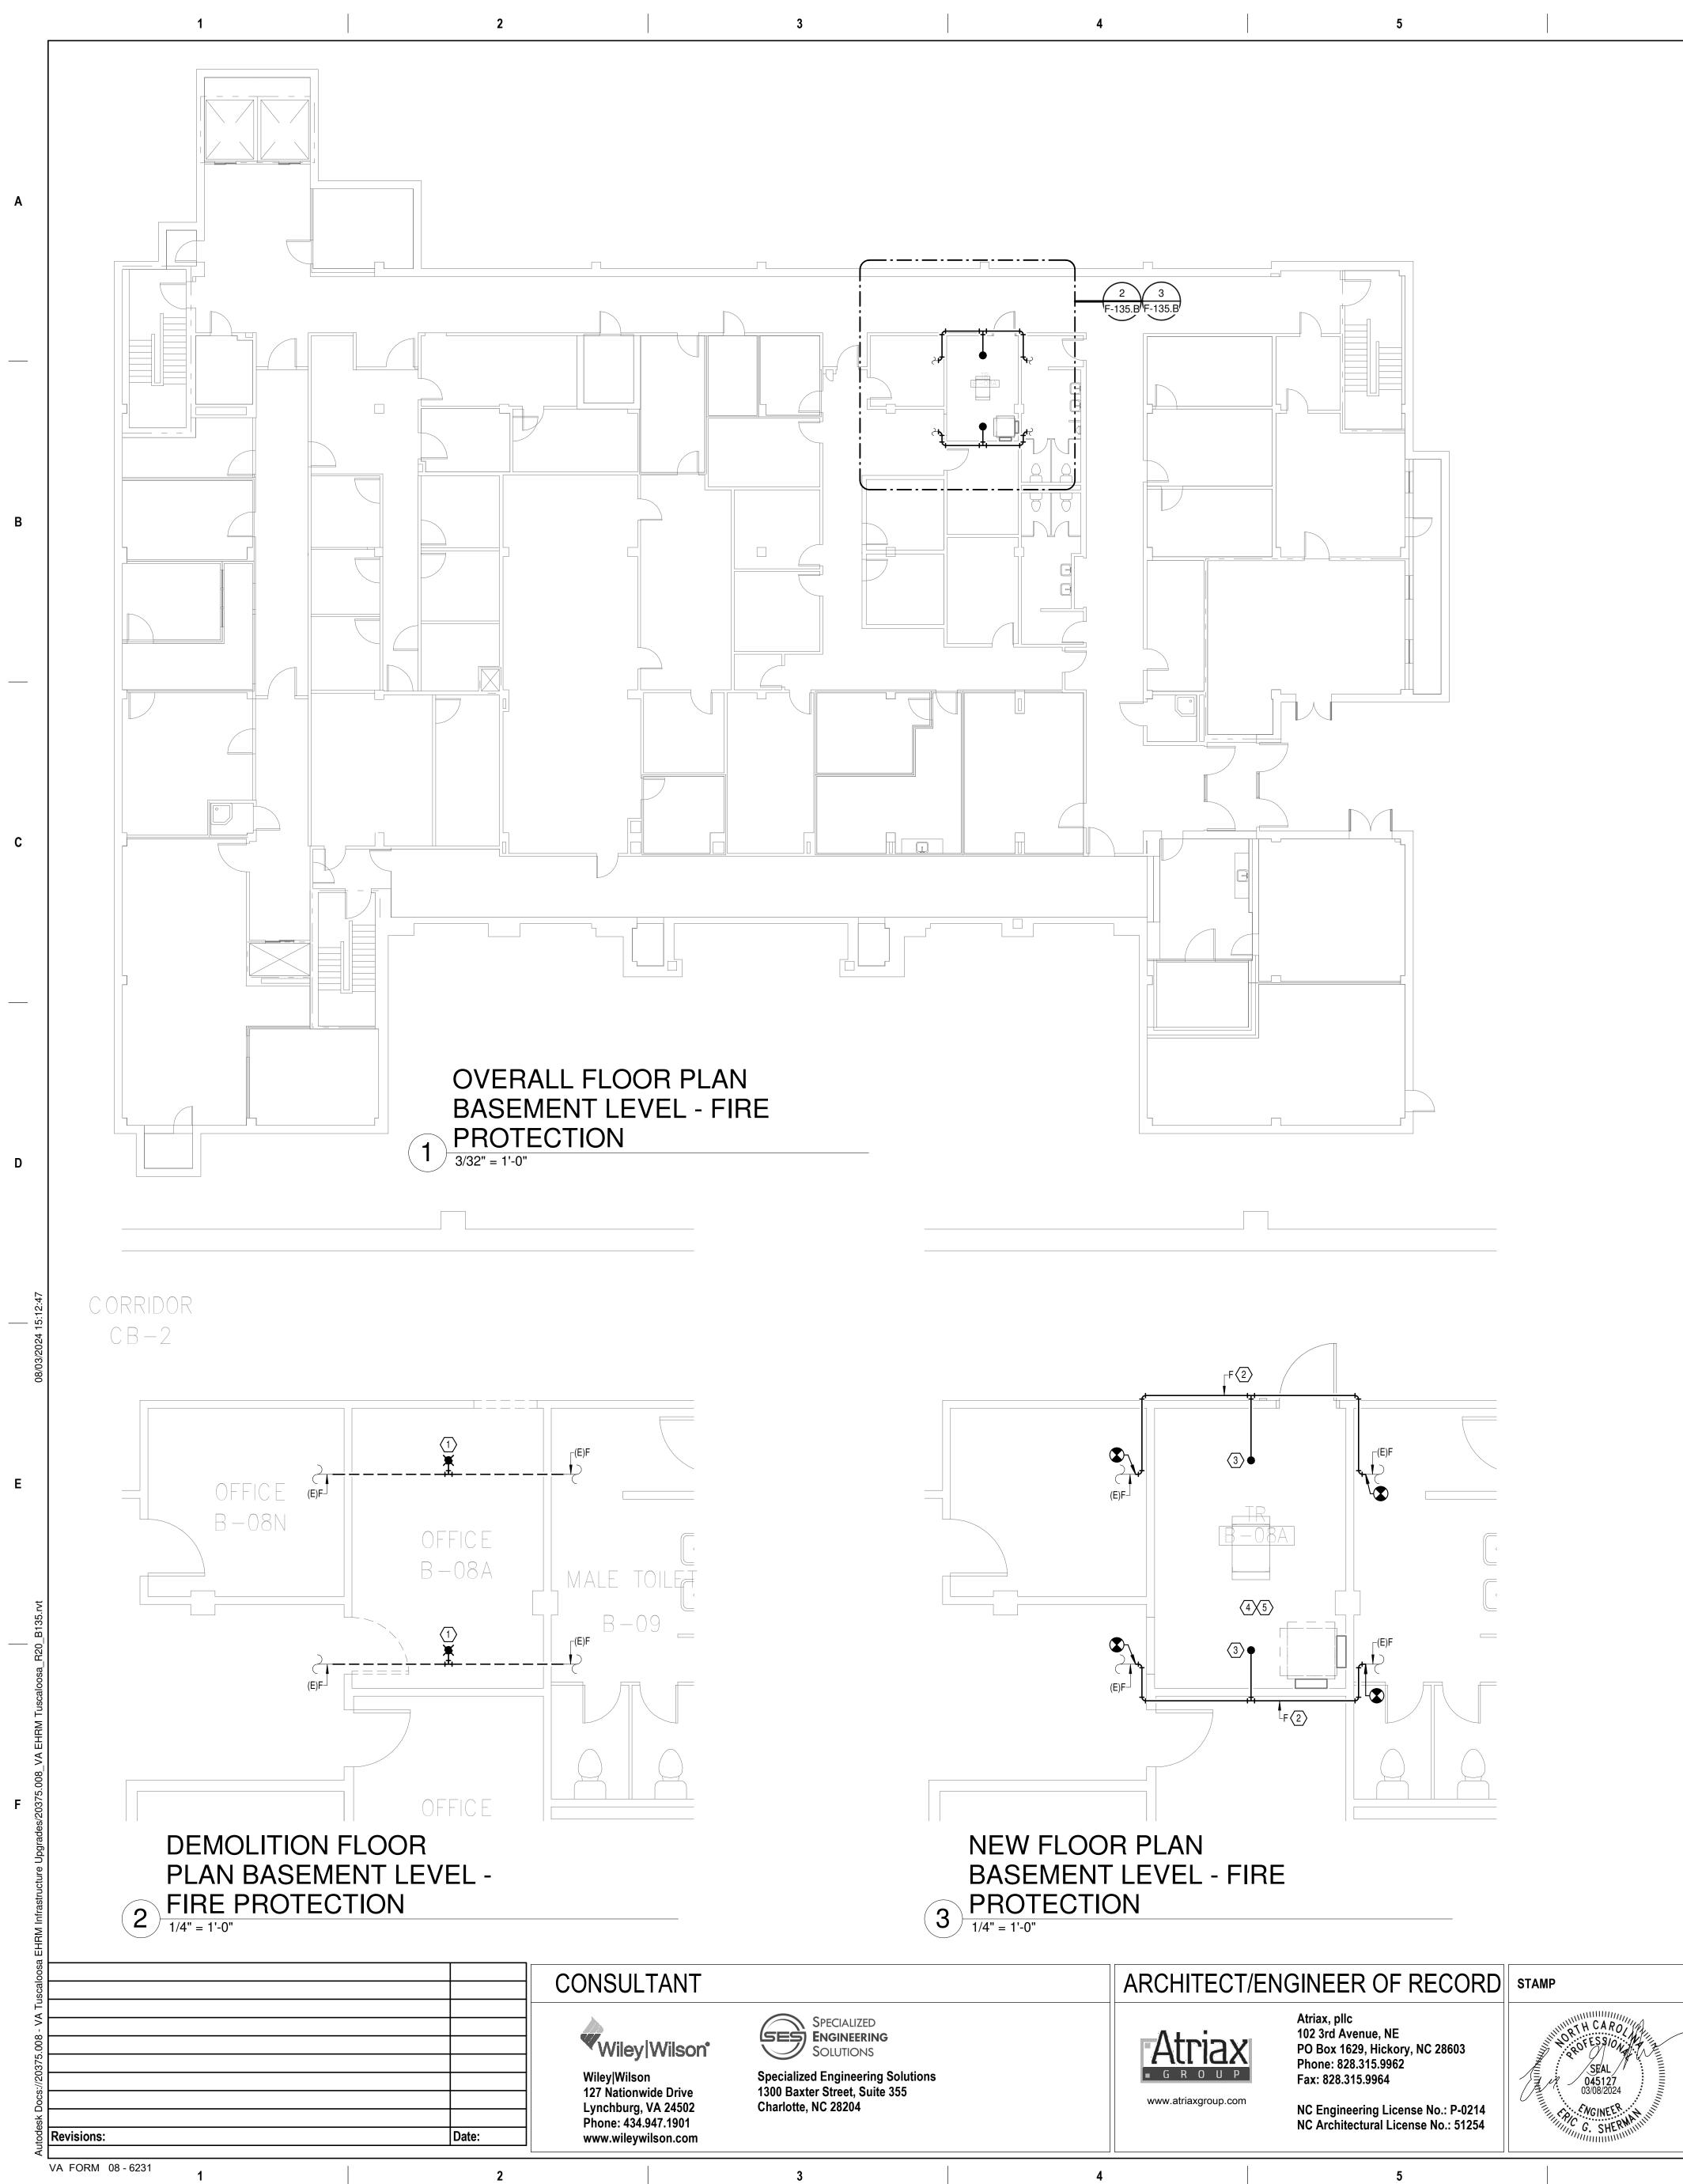
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N PLAN	TRUE
CTURE UPGRADES	Project Number 679-20-104
	Building Number 63
C, TUSCALOOSA, AL.	Drawing Number
Checked Drawn JKK PCM	F-063.G



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### **GENERAL NOTES:**

- A. COVER SHEET GENERAL NOTES APPLY TO ALL SHEETS.
- PLANS, NEW MECHANICAL SYSTEMS ARE INDICATED WITH HEAVY LINE WEIGHTS.
- FOR THE MEANS, METHODS, TECHNIQUES, CONSTRUCTION SEQUENCES, OR PROCEDURES REQUIRED TO PERFORM THIS WORK.

### SHEET NOTES:

- 2. REROUTE NEW FIRE PROTECTION PIPINGOUTSIDE OF NEW TR B-08A.
- 4. SPRINKLER PIPING SHALL NOT BE ROUTED ABOVE EQUIPMENT RACKS OR ELECTRICAL PANELS.
- PLANS.

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				PLAN
	Drawing Title	Phase	Project Title	
of	BUILDING 135 BASEMENT LEVEL -	100% CONSTRUCTION	EHRM INFRASTRU	JCTURE UF
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			TUSCALOOSA VAM	C, TUSCAL
epartment		FULLY SPRINKLERED	Issue Date	Checked
erans Affairs			03/08/2024	JKK
	7	8	9	

B. ON DEMOLITION PLANS; EXISTING MECHANICAL SYSTEMS TO BE REMOVED ARE SHOWN HATCHED AND/OR DASHED, EXISTING MECHANICAL SYSTEMS TO REMAIN ARE SHOWN LIGHT LINE WEIGHT. ON ALL OTHER C. UNLESS NOTED OTHERWISE, DETAILS SHOWN WITHIN THESE DOCUMENTS ARE APPLICABLE FOR ALL PIPING, EQUIPMENT AND DUCTWORK INSTALLATIONS WHETHER OR NOT SPECIFICALLY NOTED. D. THE OWNER AND ENGINEER ARE NOT RESPONSIBLE FOR THE CONTRACTOR'S SAFETY PRECAUTIONS OR

1. DEMOLISH FIRE PROTECTION BACK TO BOUNDARY OF NEW TR B-08A.

3. INSTALL NEW UPRIGHT SPRINKLER HEADS WITH MECHANICAL GUARDS TO SERVE B-08A. VERIFY COVERAGE REQUIREMENTS. REPLACEMENT OF THE EXISTING PENDENT SPRINKLER WITH NEW UPRIGHT SPRINKLER SHALL OCCUR AT THE SAME TIME TO AVOID A SPRINKLER OUTAGE IN THE ROOM.

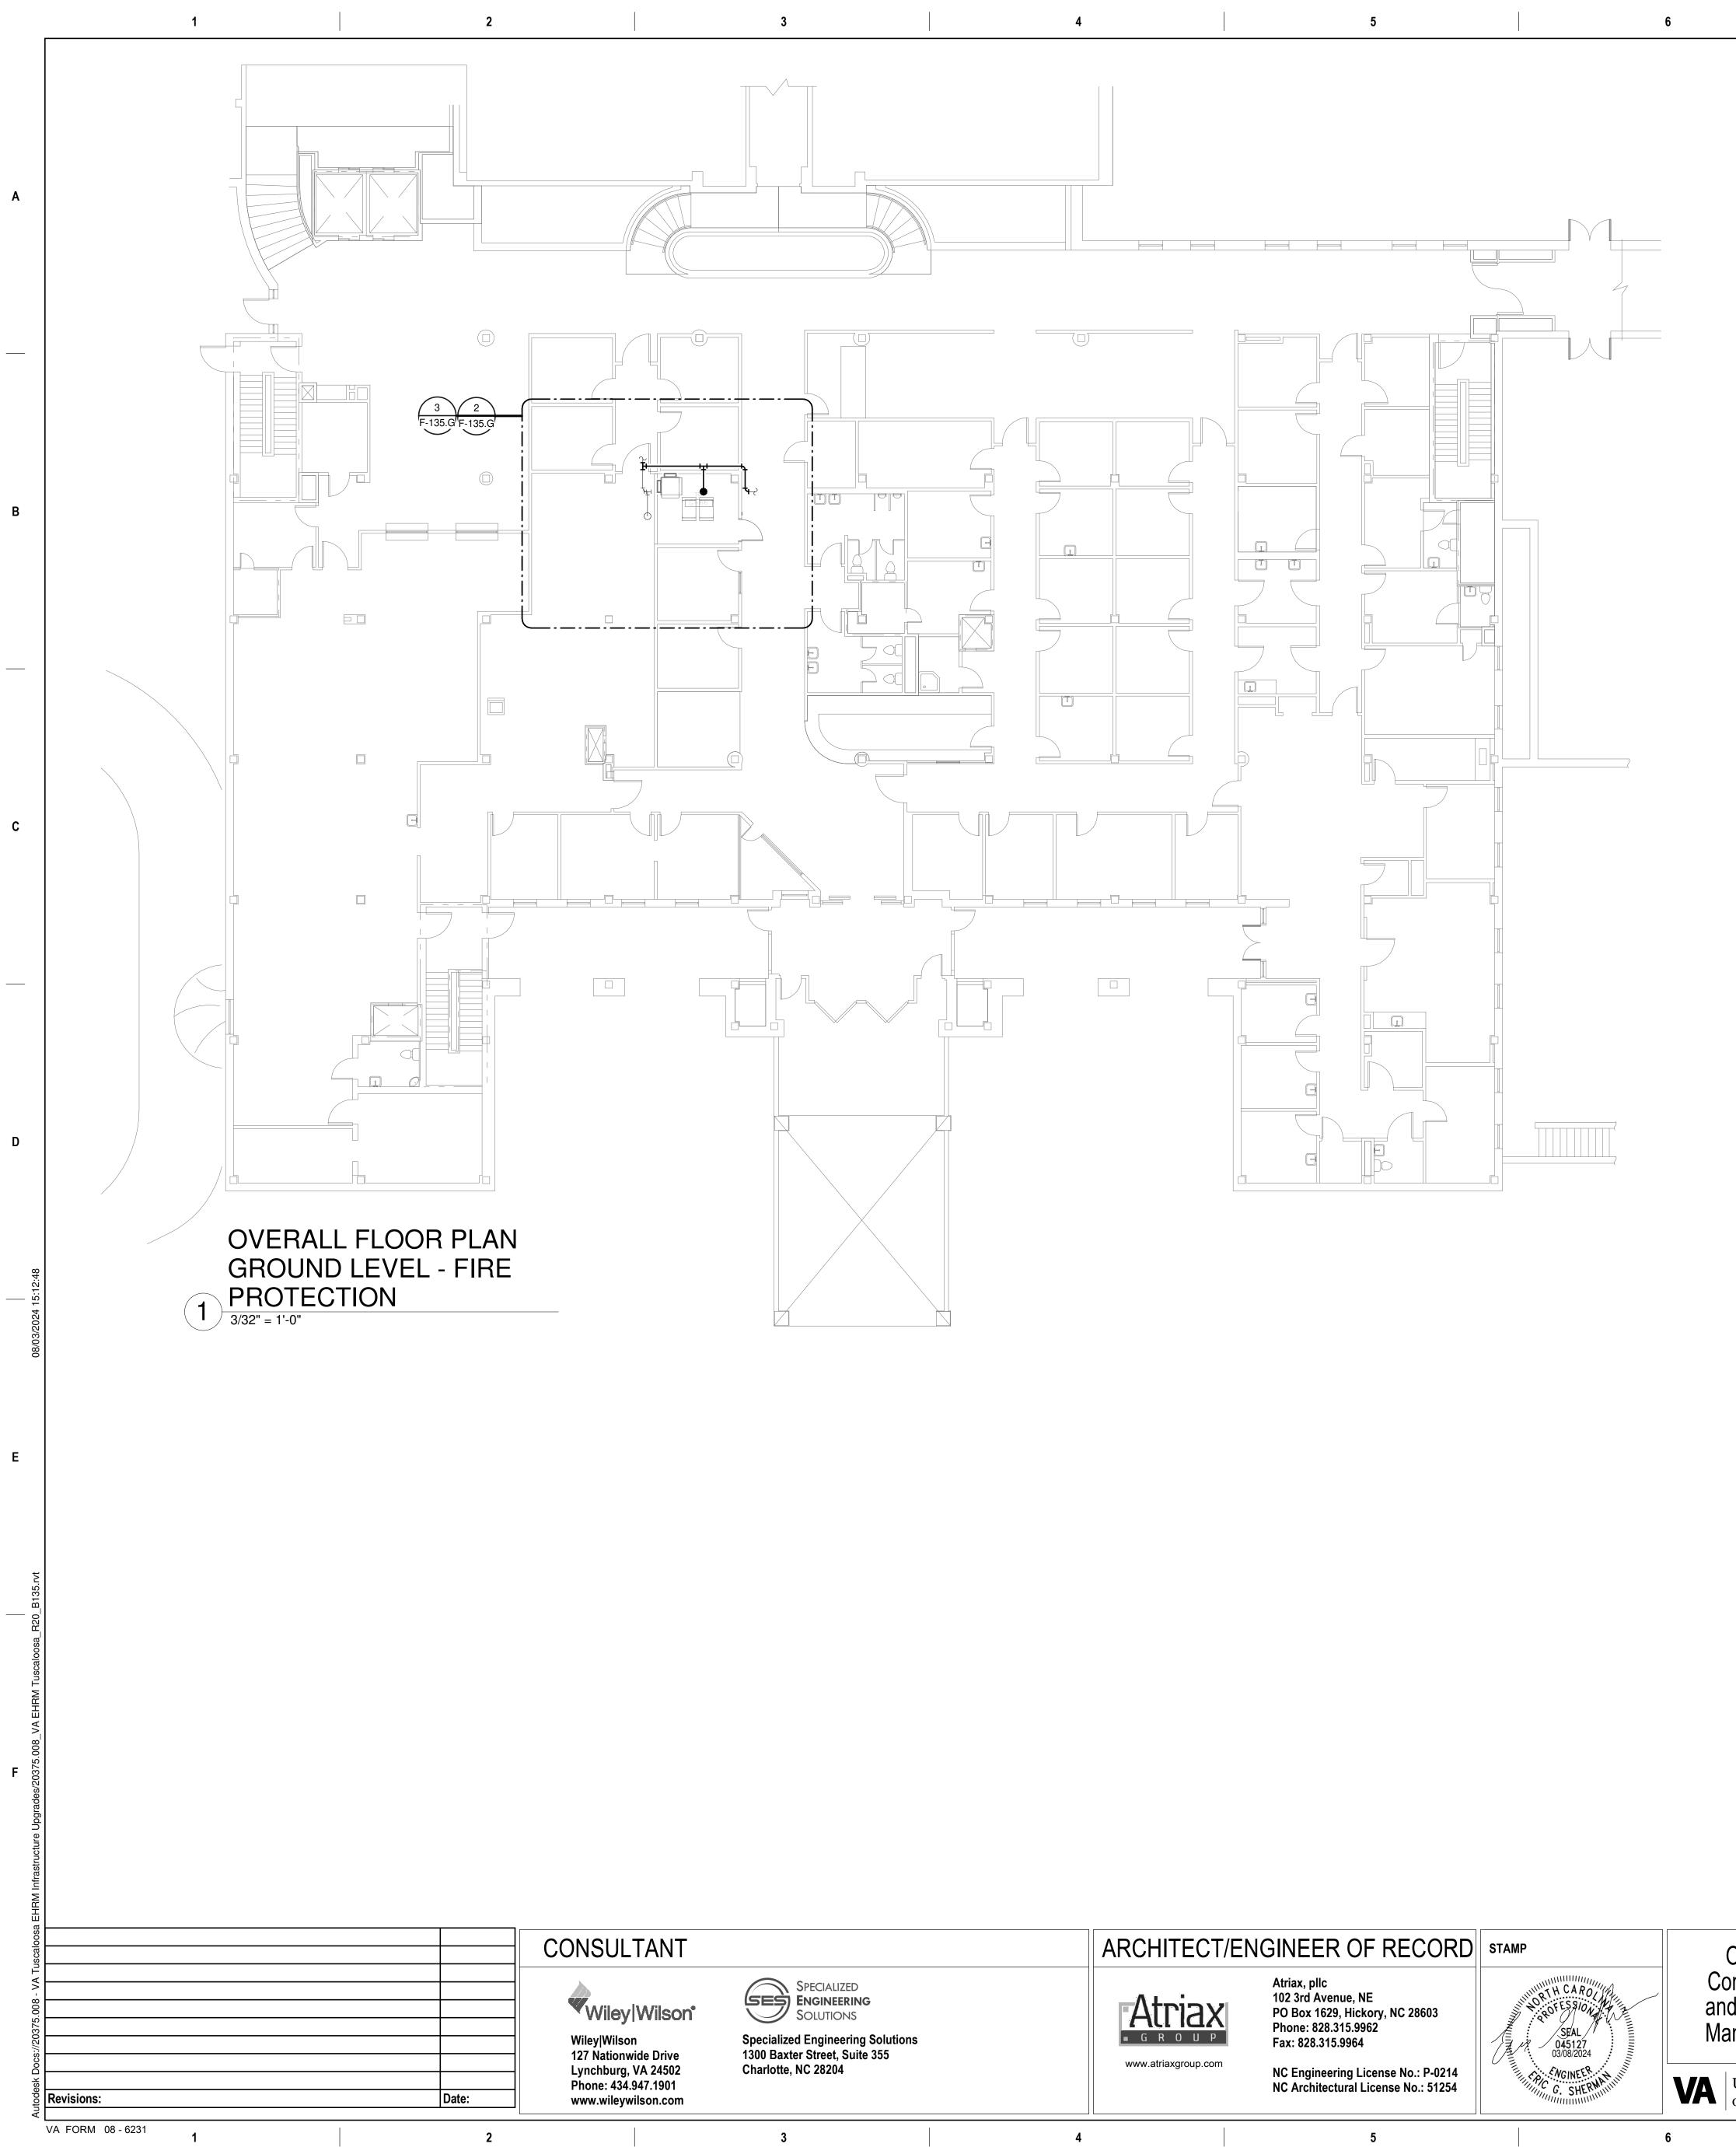
5. AREA OF EXISTING SPRINKLER COVERAGE. HAZARD CLASSIFICATION "LIGHT HAZARD". RELOCATE AND/OR ADD ADDITIONAL HEADS AND PIPING TO MEET COVERAGE REQUIREMENTS PER NFPA 13 AND VA REQUIREMENTS. COORDINATE HEAD LOCATIONS WITH EXISTING CONDITIONS AND ARCHITECT'S CEILING

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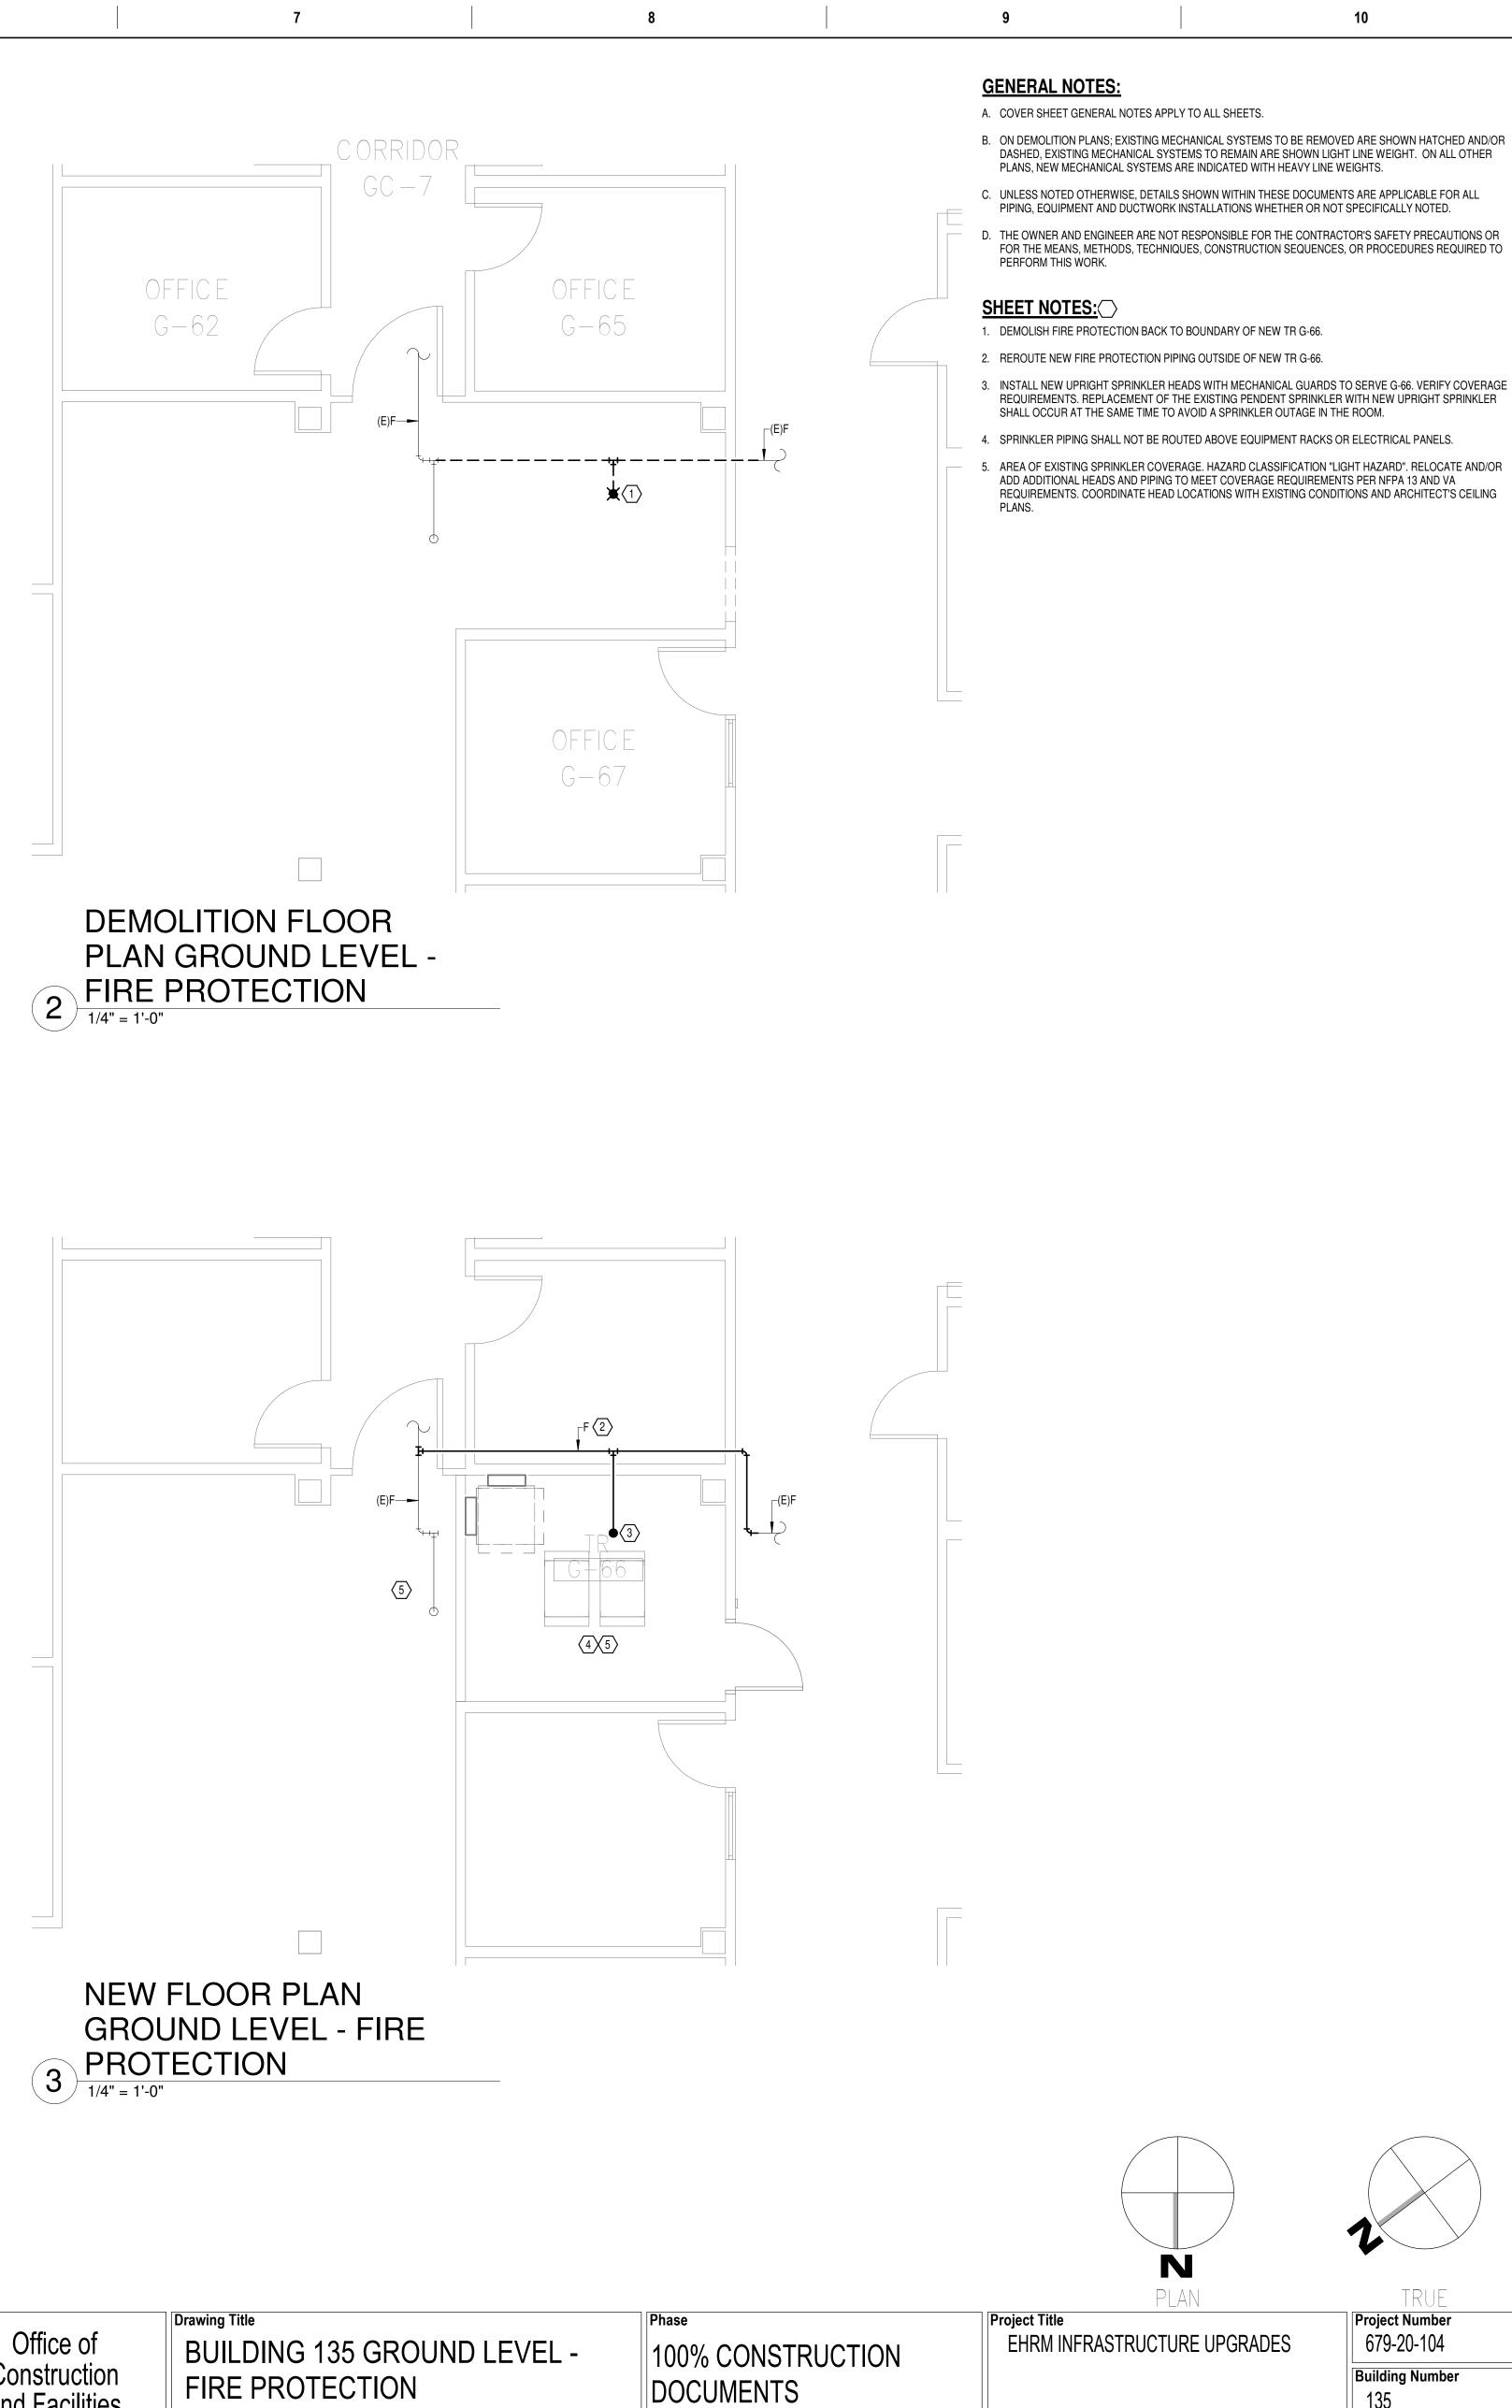
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JRE UPGRADES		Project Number 679-20-104		
		Building Number 135		
USCALOO	SA, AL.	Drawing Number		
ecked KK	Drawn PCM	F-135.B		



Office of Construction and Facilities



Management Approved: FULLY SPRINKLERED U.S. Department of Veterans Affairs

Location TUSCALOOSA VAMC, TUSC Checked Issue Date 03/08/2024 JKK

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DASHED, EXISTING MECHANICAL SYSTEMS TO REMAIN ARE SHOWN LIGHT LINE WEIGHT. ON ALL OTHER C. UNLESS NOTED OTHERWISE, DETAILS SHOWN WITHIN THESE DOCUMENTS ARE APPLICABLE FOR ALL PIPING, EQUIPMENT AND DUCTWORK INSTALLATIONS WHETHER OR NOT SPECIFICALLY NOTED.

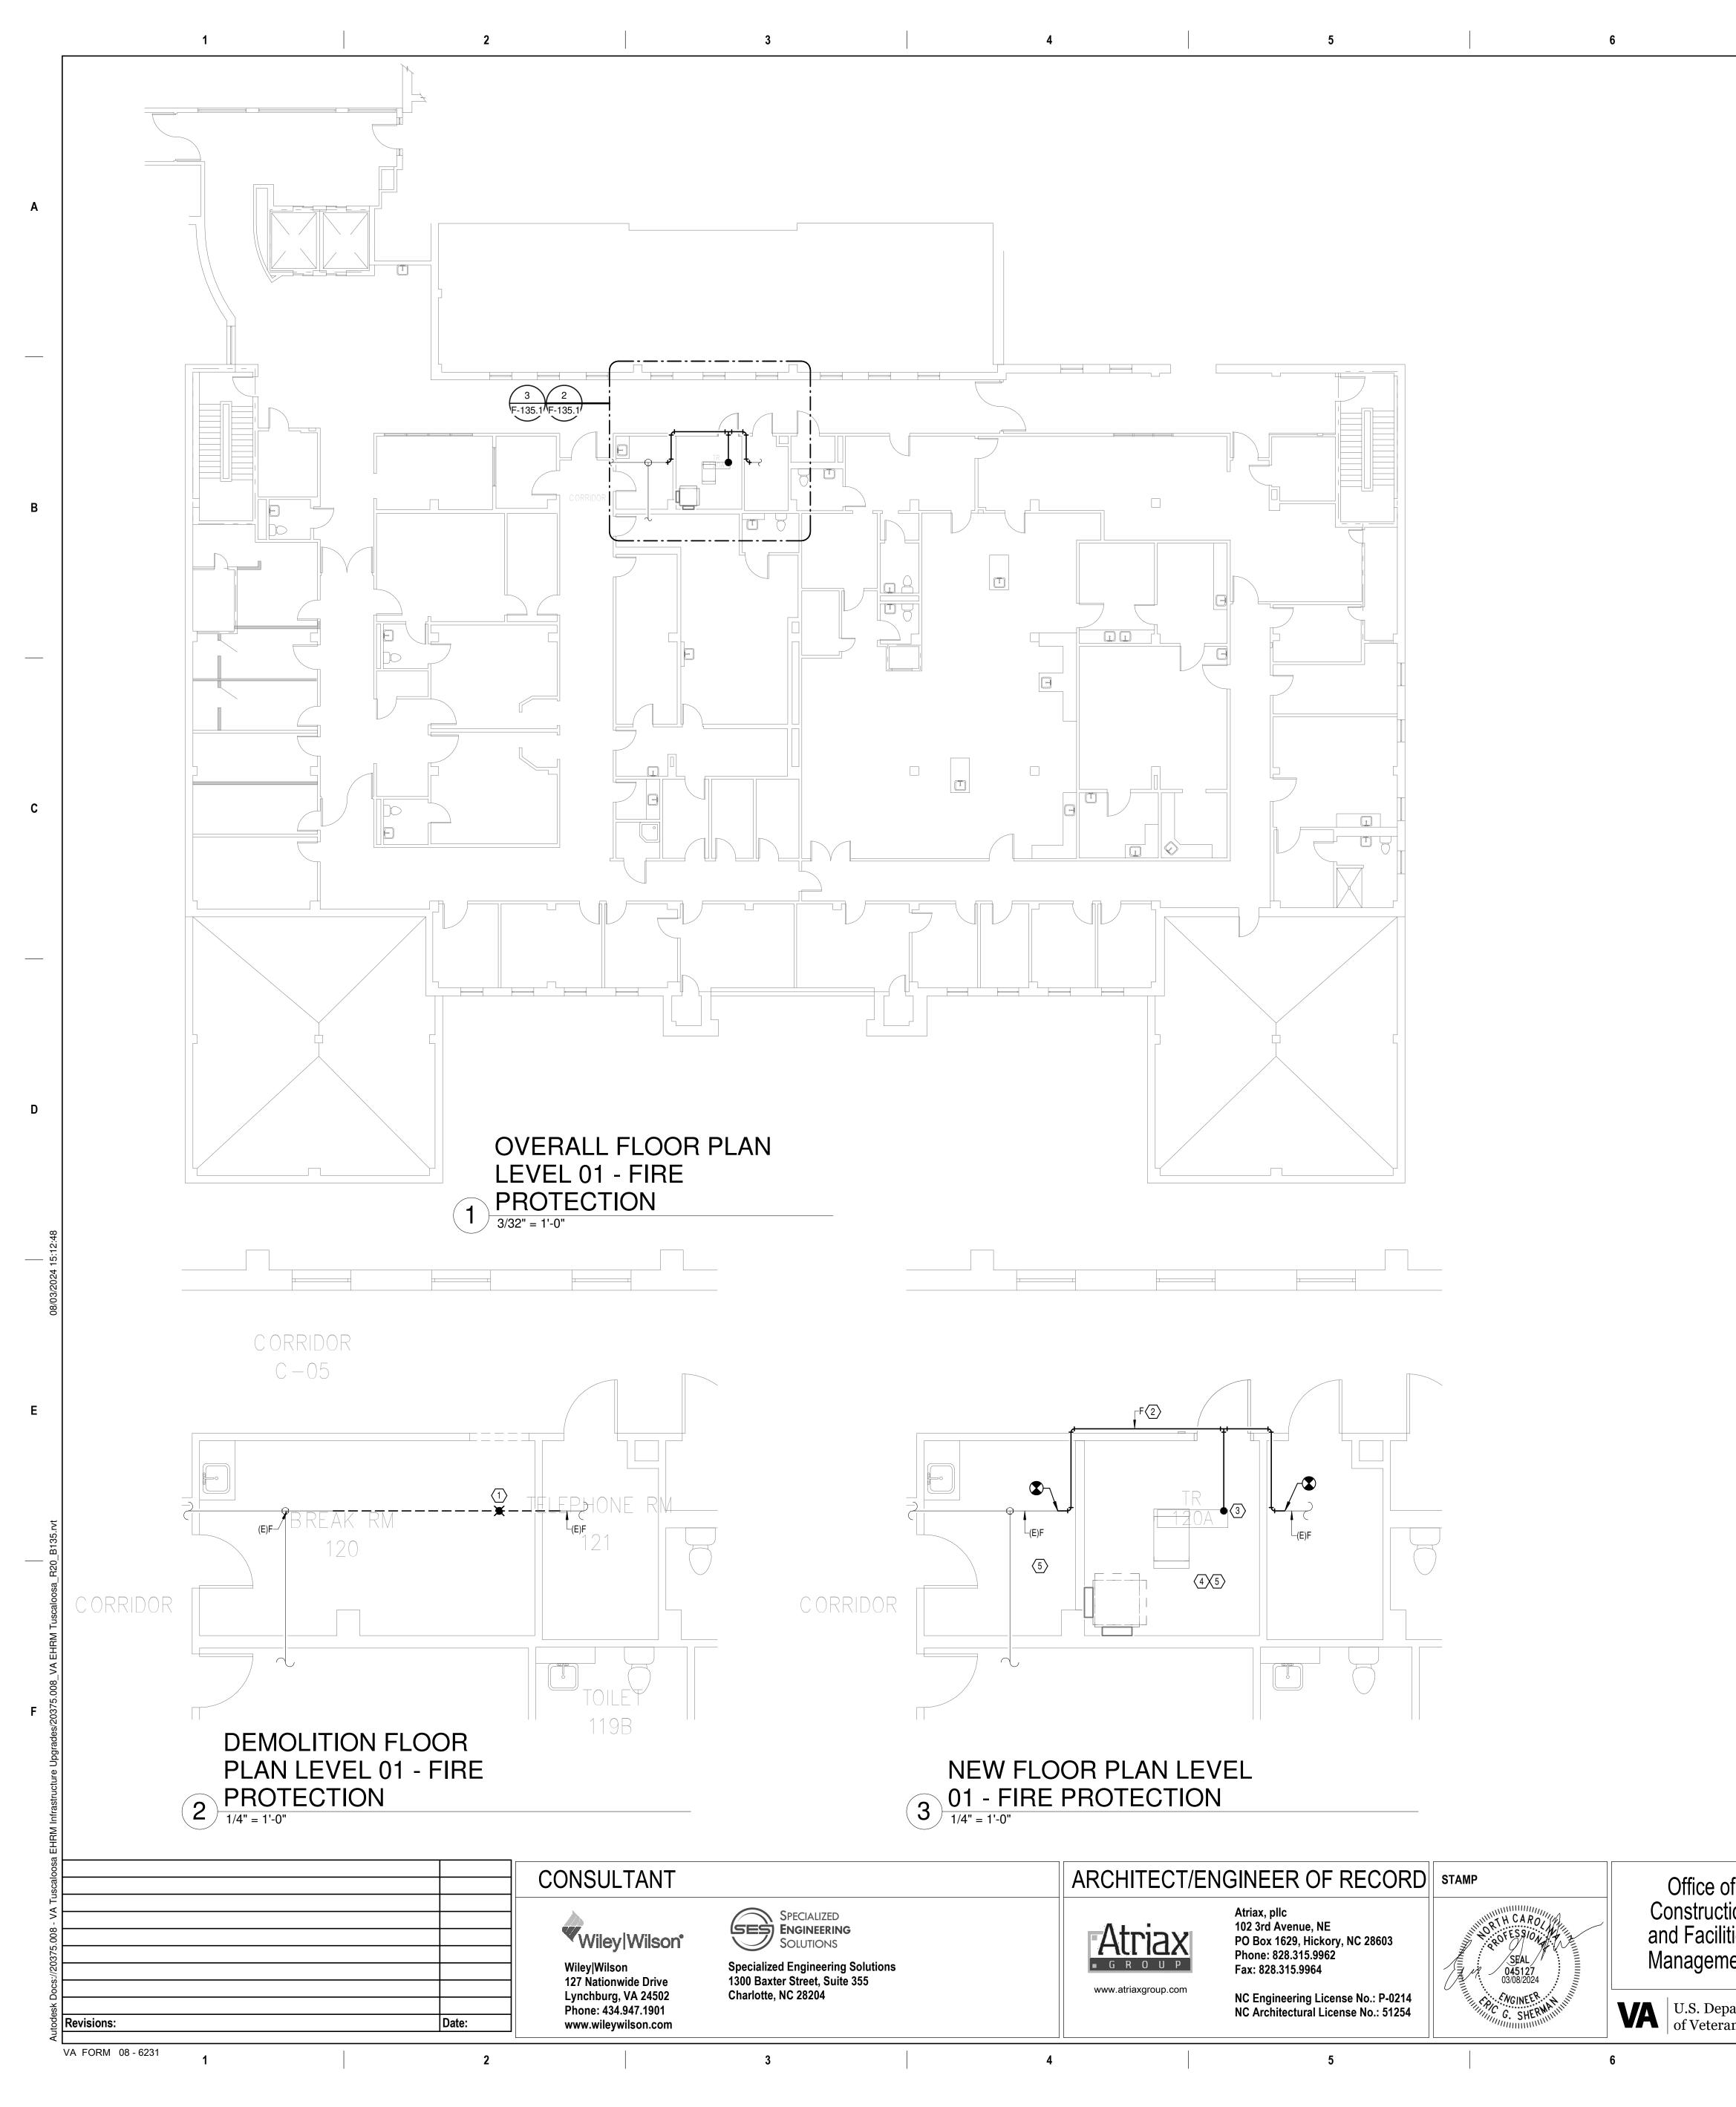
3. INSTALL NEW UPRIGHT SPRINKLER HEADS WITH MECHANICAL GUARDS TO SERVE G-66. VERIFY COVERAGE REQUIREMENTS. REPLACEMENT OF THE EXISTING PENDENT SPRINKLER WITH NEW UPRIGHT SPRINKLER

5. AREA OF EXISTING SPRINKLER COVERAGE. HAZARD CLASSIFICATION "LIGHT HAZARD". RELOCATE AND/OR ADD ADDITIONAL HEADS AND PIPING TO MEET COVERAGE REQUIREMENTS PER NFPA 13 AND VA REQUIREMENTS. COORDINATE HEAD LOCATIONS WITH EXISTING CONDITIONS AND ARCHITECT'S CEILING

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		TRUE
UPGRADES		Project Number 679-20-104
		Building Number 135
CALOO	SA, AL.	Drawing Number
d	Drawn PCM	F-135.G



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### **GENERAL NOTES:**

- A. COVER SHEET GENERAL NOTES APPLY TO ALL SHEETS.
- PLANS, NEW MECHANICAL SYSTEMS ARE INDICATED WITH HEAVY LINE WEIGHTS.
- FOR THE MEANS, METHODS, TECHNIQUES, CONSTRUCTION SEQUENCES, OR PROCEDURES REQUIRED TO PERFORM THIS WORK.

### SHEET NOTES:

- 2. REROUTE NEW FIRE PROTECTION PIPING OUTSIDE OF NEW TR 120A.
- 4. SPRINKLER PIPING SHALL NOT BE ROUTED ABOVE EQUIPMENT RACKS OR ELECTRICAL PANELS.
- PLANS.

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	Drawing Title		Phase		
of	BUILDING 135 LEVEL 0 <sup>2</sup>	1 - FIRE	100% CONSTRUCTION	EHRM INFRASTRU	JUTURE U
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ment	Approved:			Location TUSCALOOSA VAM	C, TUSCA
epartment			FULLY SPRINKLERED	Issue Date	Checked
rans Affairs				03/08/2024	JKK
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B. ON DEMOLITION PLANS; EXISTING MECHANICAL SYSTEMS TO BE REMOVED ARE SHOWN HATCHED AND/OR DASHED, EXISTING MECHANICAL SYSTEMS TO REMAIN ARE SHOWN LIGHT LINE WEIGHT. ON ALL OTHER C. UNLESS NOTED OTHERWISE, DETAILS SHOWN WITHIN THESE DOCUMENTS ARE APPLICABLE FOR ALL PIPING, EQUIPMENT AND DUCTWORK INSTALLATIONS WHETHER OR NOT SPECIFICALLY NOTED. D. THE OWNER AND ENGINEER ARE NOT RESPONSIBLE FOR THE CONTRACTOR'S SAFETY PRECAUTIONS OR

1. DEMOLISH FIRE PROTECTION BACK TO BOUNDARY OF NEW TR 120A.

3. INSTALL NEW UPRIGHT SPRINKLER HEADS WITH MECHANICAL GUARDS TO SERVE 120A. VERIFY COVERAGE REQUIREMENTS. REPLACEMENT OF THE EXISTING PENDENT SPRINKLER WITH NEW UPRIGHT SPRINKLER SHALL OCCUR AT THE SAME TIME TO AVOID A SPRINKLER OUTAGE IN THE ROOM.

5. AREA OF EXISTING SPRINKLER COVERAGE. HAZARD CLASSIFICATION "LIGHT HAZARD". RELOCATE AND/OR ADD ADDITIONAL HEADS AND PIPING TO MEET COVERAGE REQUIREMENTS PER NFPA 13 AND VA REQUIREMENTS. COORDINATE HEAD LOCATIONS WITH EXISTING CONDITIONS AND ARCHITECT'S CEILING

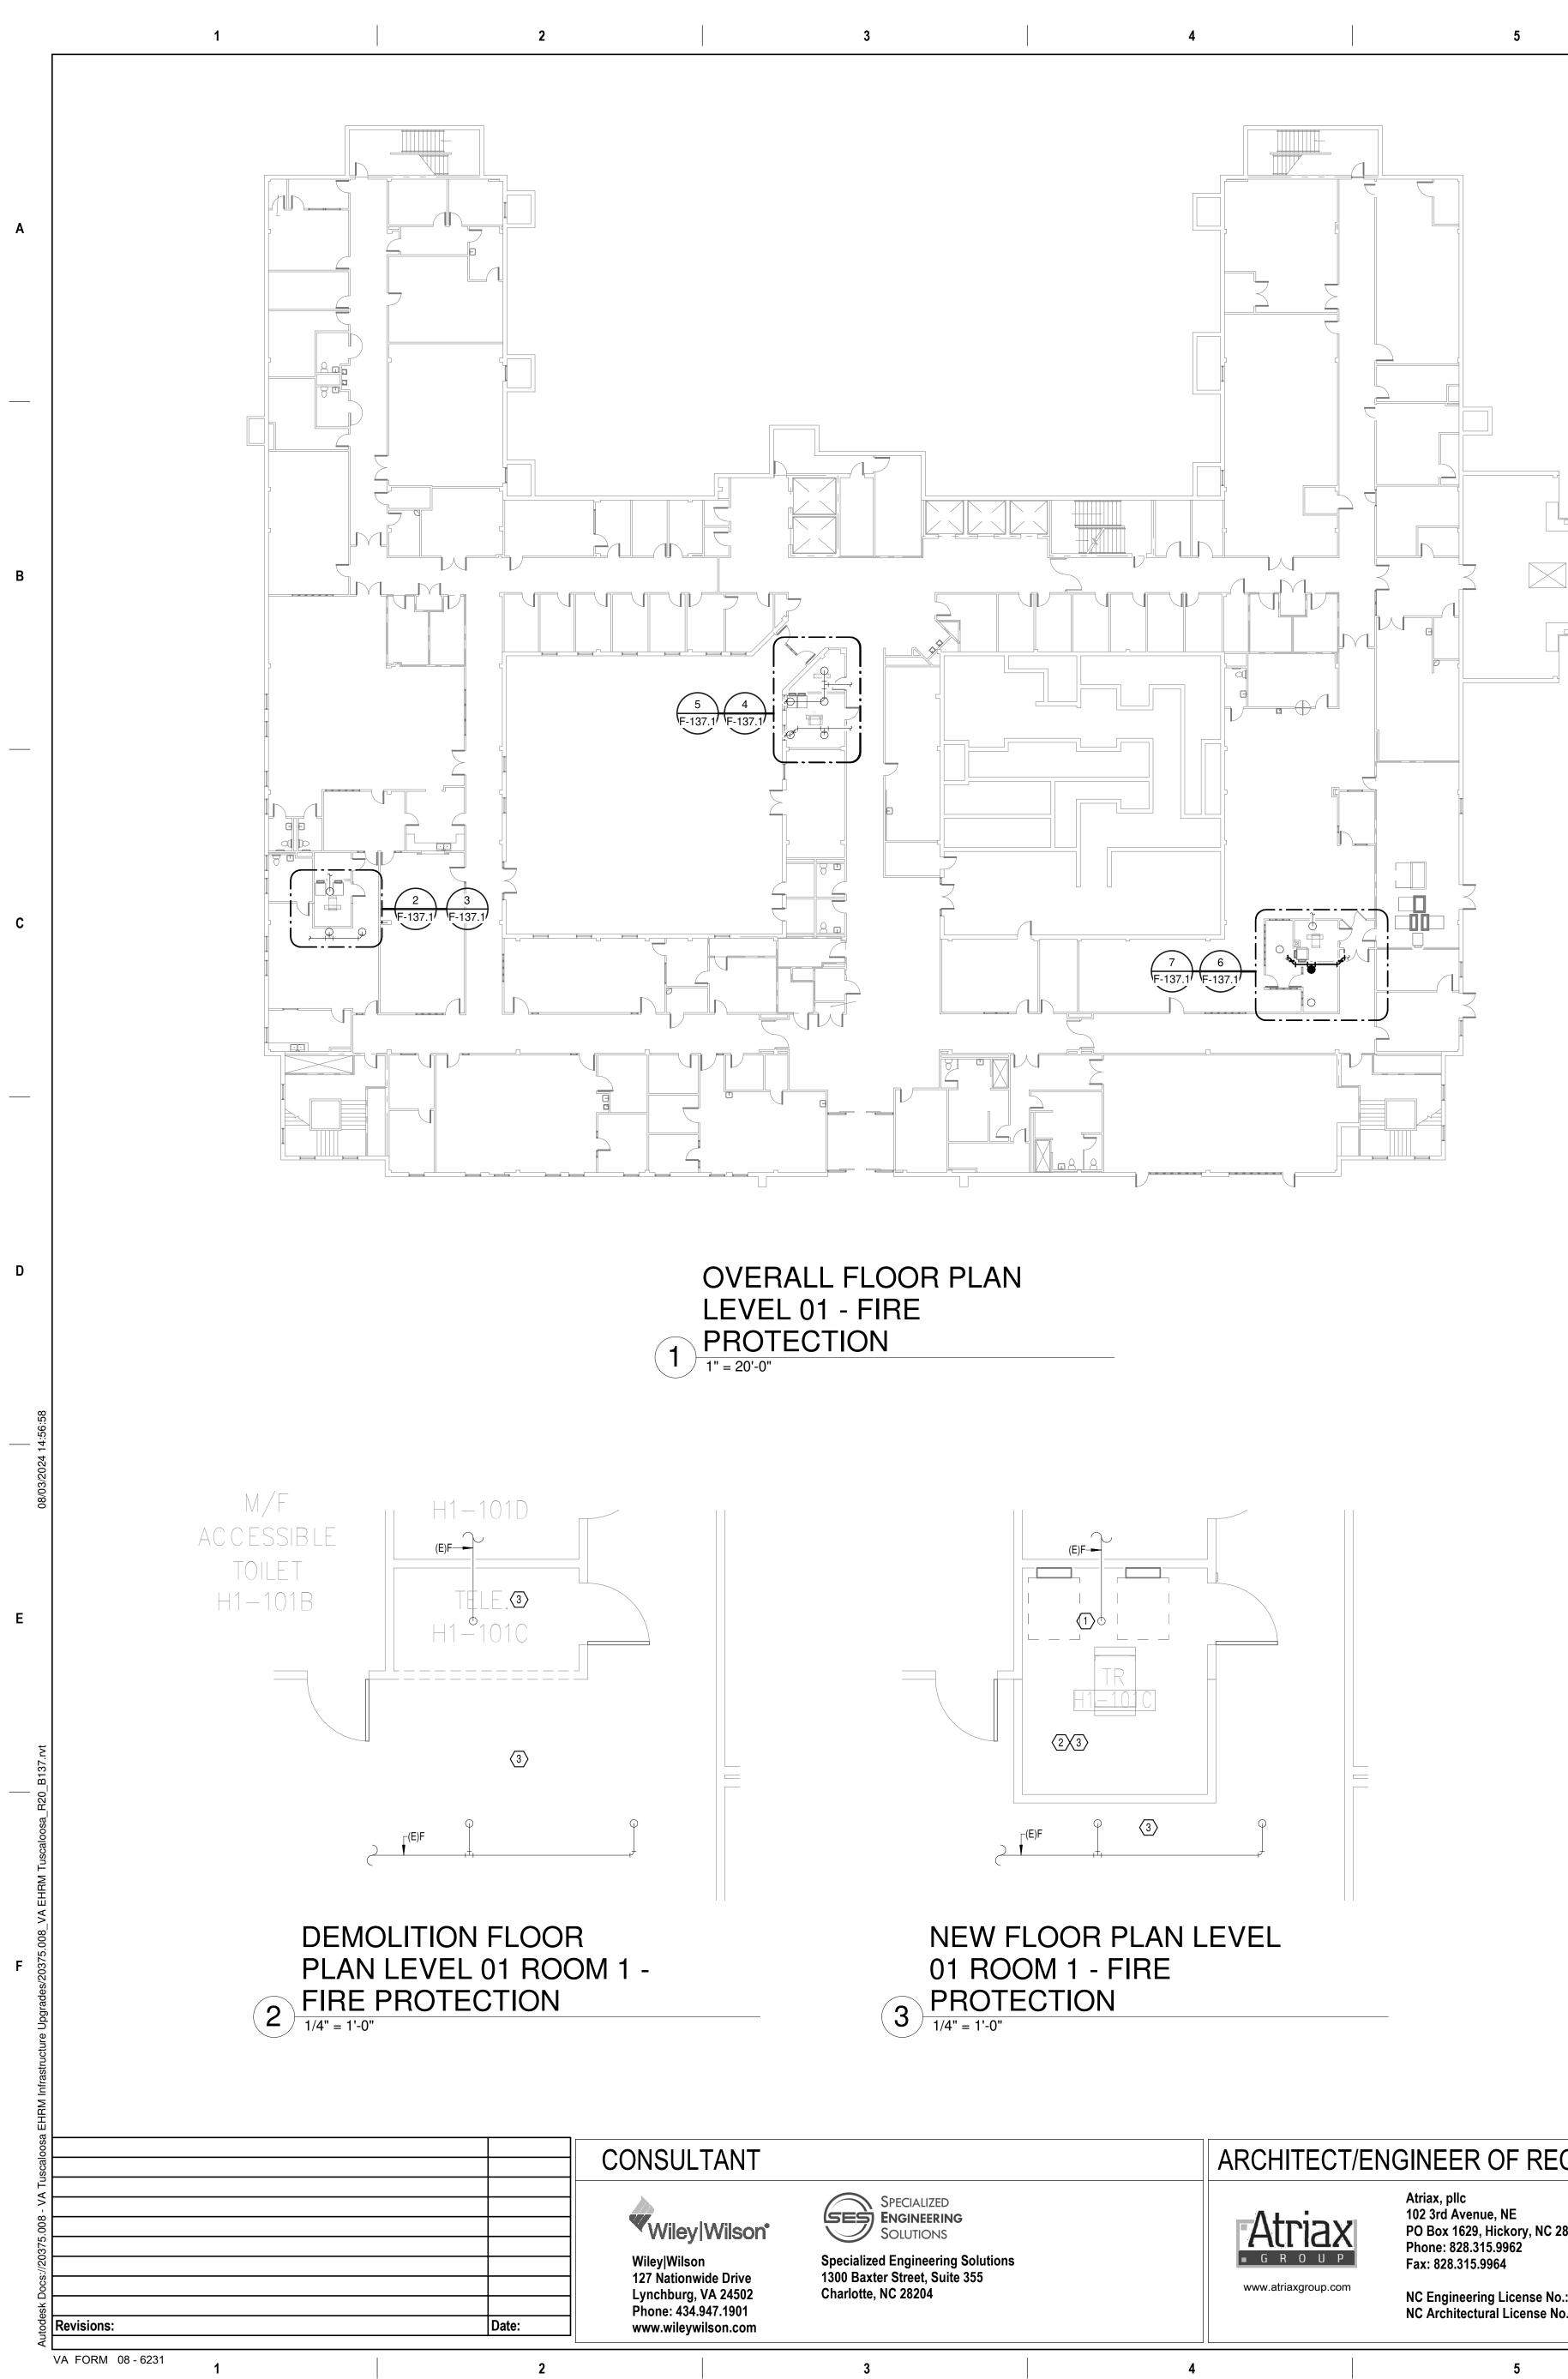
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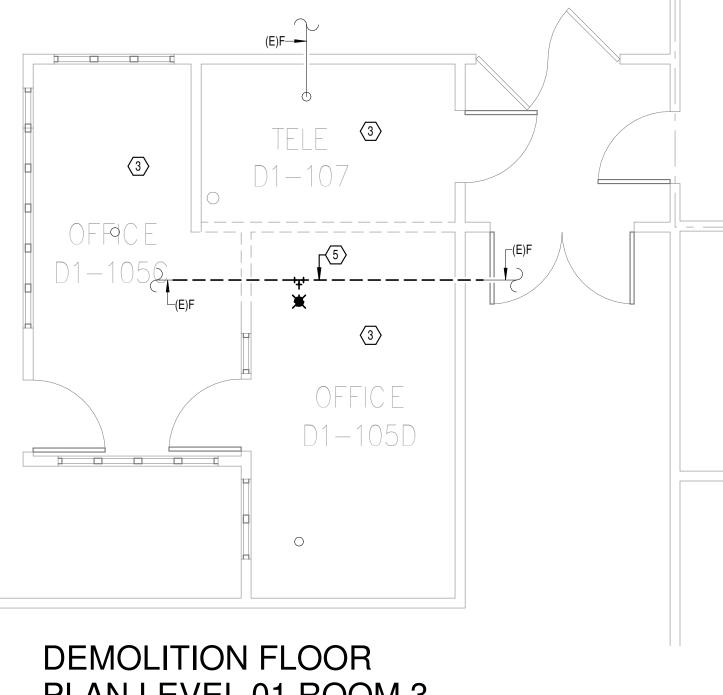
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		TRUE	
UPGRADES		Project Number 679-20-104	
		Building Number 135	
CALOO	SA, AL.	Drawing Number	
d	Drawn PCM	F-135.1	



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# **DEMOLITION FLOOR** PLAN LEVEL 01 ROOM 2 -4 FIRE PROTECTION





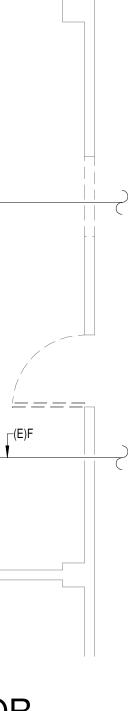
	ARCHIT	ECT/ENG	INEER OF RECORD	STAMP	Office	
ZED RING NS ering Solutions Suite 355			Atriax, pllc 102 3rd Avenue, NE PO Box 1629, Hickory, NC 28603 Phone: 828.315.9962 Fax: 828.315.9964	SEAL 045127 03/08/2024	Construct and Faci Manager	
L	www.atriaxg		NC Engineering License No.: P-0214 NC Architectural License No.: 51254	C. SHERMANNIN	VA U.S. De of Veter	
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# **GENERAL NOTES:**

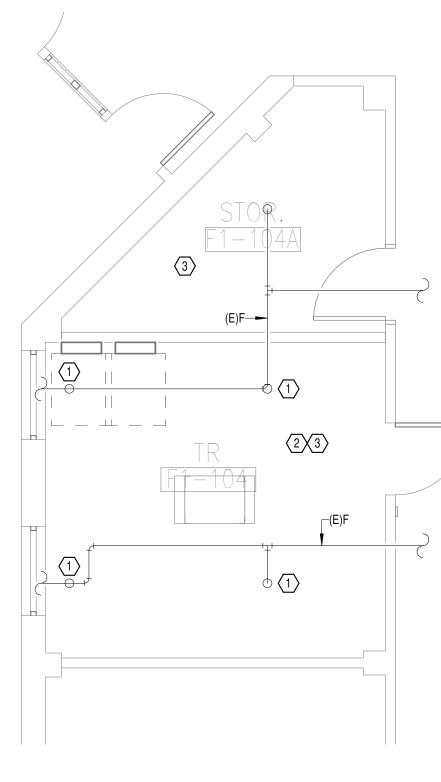
- PERFORM THIS WORK.

### SHEET NOTES:

- 2. SPRINKLER PIPING SHALL NOT BE ROUTED ABOVE EQUIPMENT RACKS OR ELECTRICAL PANELS.
- PLANS.
- 4. DEMOLISH FIRE PROTECTION PIPING BACK TO BOUNDARY OF NEW TR.

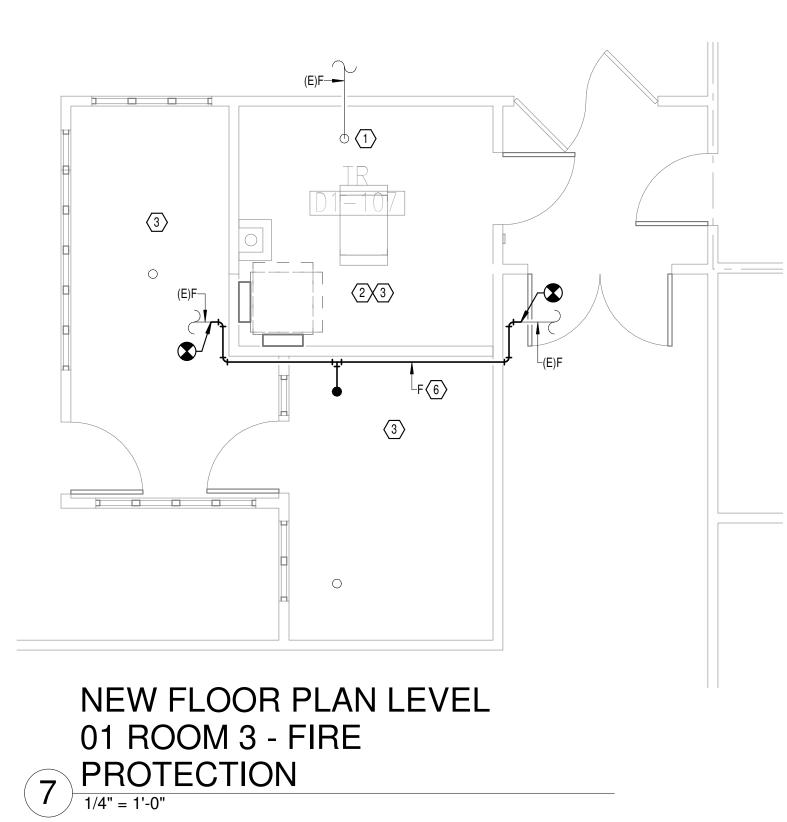


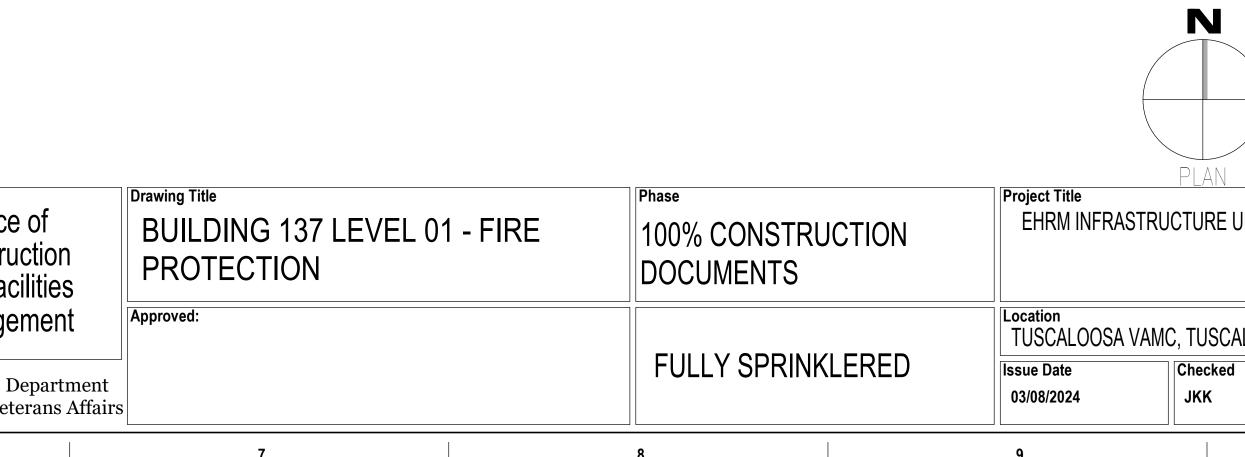




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NEW FLOOR PLAN LEVEL 01 ROOM 2 - FIRE 5 **PROTECTION** 1/4" = 1'-0"





A. COVER SHEET GENERAL NOTES APPLY TO ALL SHEETS.

B. ON DEMOLITION PLANS; EXISTING MECHANICAL SYSTEMS TO BE REMOVED ARE SHOWN HATCHED AND/OR DASHED, EXISTING MECHANICAL SYSTEMS TO REMAIN ARE SHOWN LIGHT LINE WEIGHT. ON ALL OTHER PLANS, NEW MECHANICAL SYSTEMS ARE INDICATED WITH HEAVY LINE WEIGHTS. UNLESS NOTED OTHERWISE, DETAILS SHOWN WITHIN THESE DOCUMENTS ARE APPLICABLE FOR ALL PIPING, EQUIPMENT AND DUCTWORK INSTALLATIONS WHETHER OR NOT SPECIFICALLY NOTED. D. THE OWNER AND ENGINEER ARE NOT RESPONSIBLE FOR THE CONTRACTOR'S SAFETY PRECAUTIONS OR FOR THE MEANS, METHODS, TECHNIQUES, CONSTRUCTION SEQUENCES, OR PROCEDURES REQUIRED TO

1. PROVIDE MECHANICAL GUARD FOR EXISTING SPRINKLER HEAD.

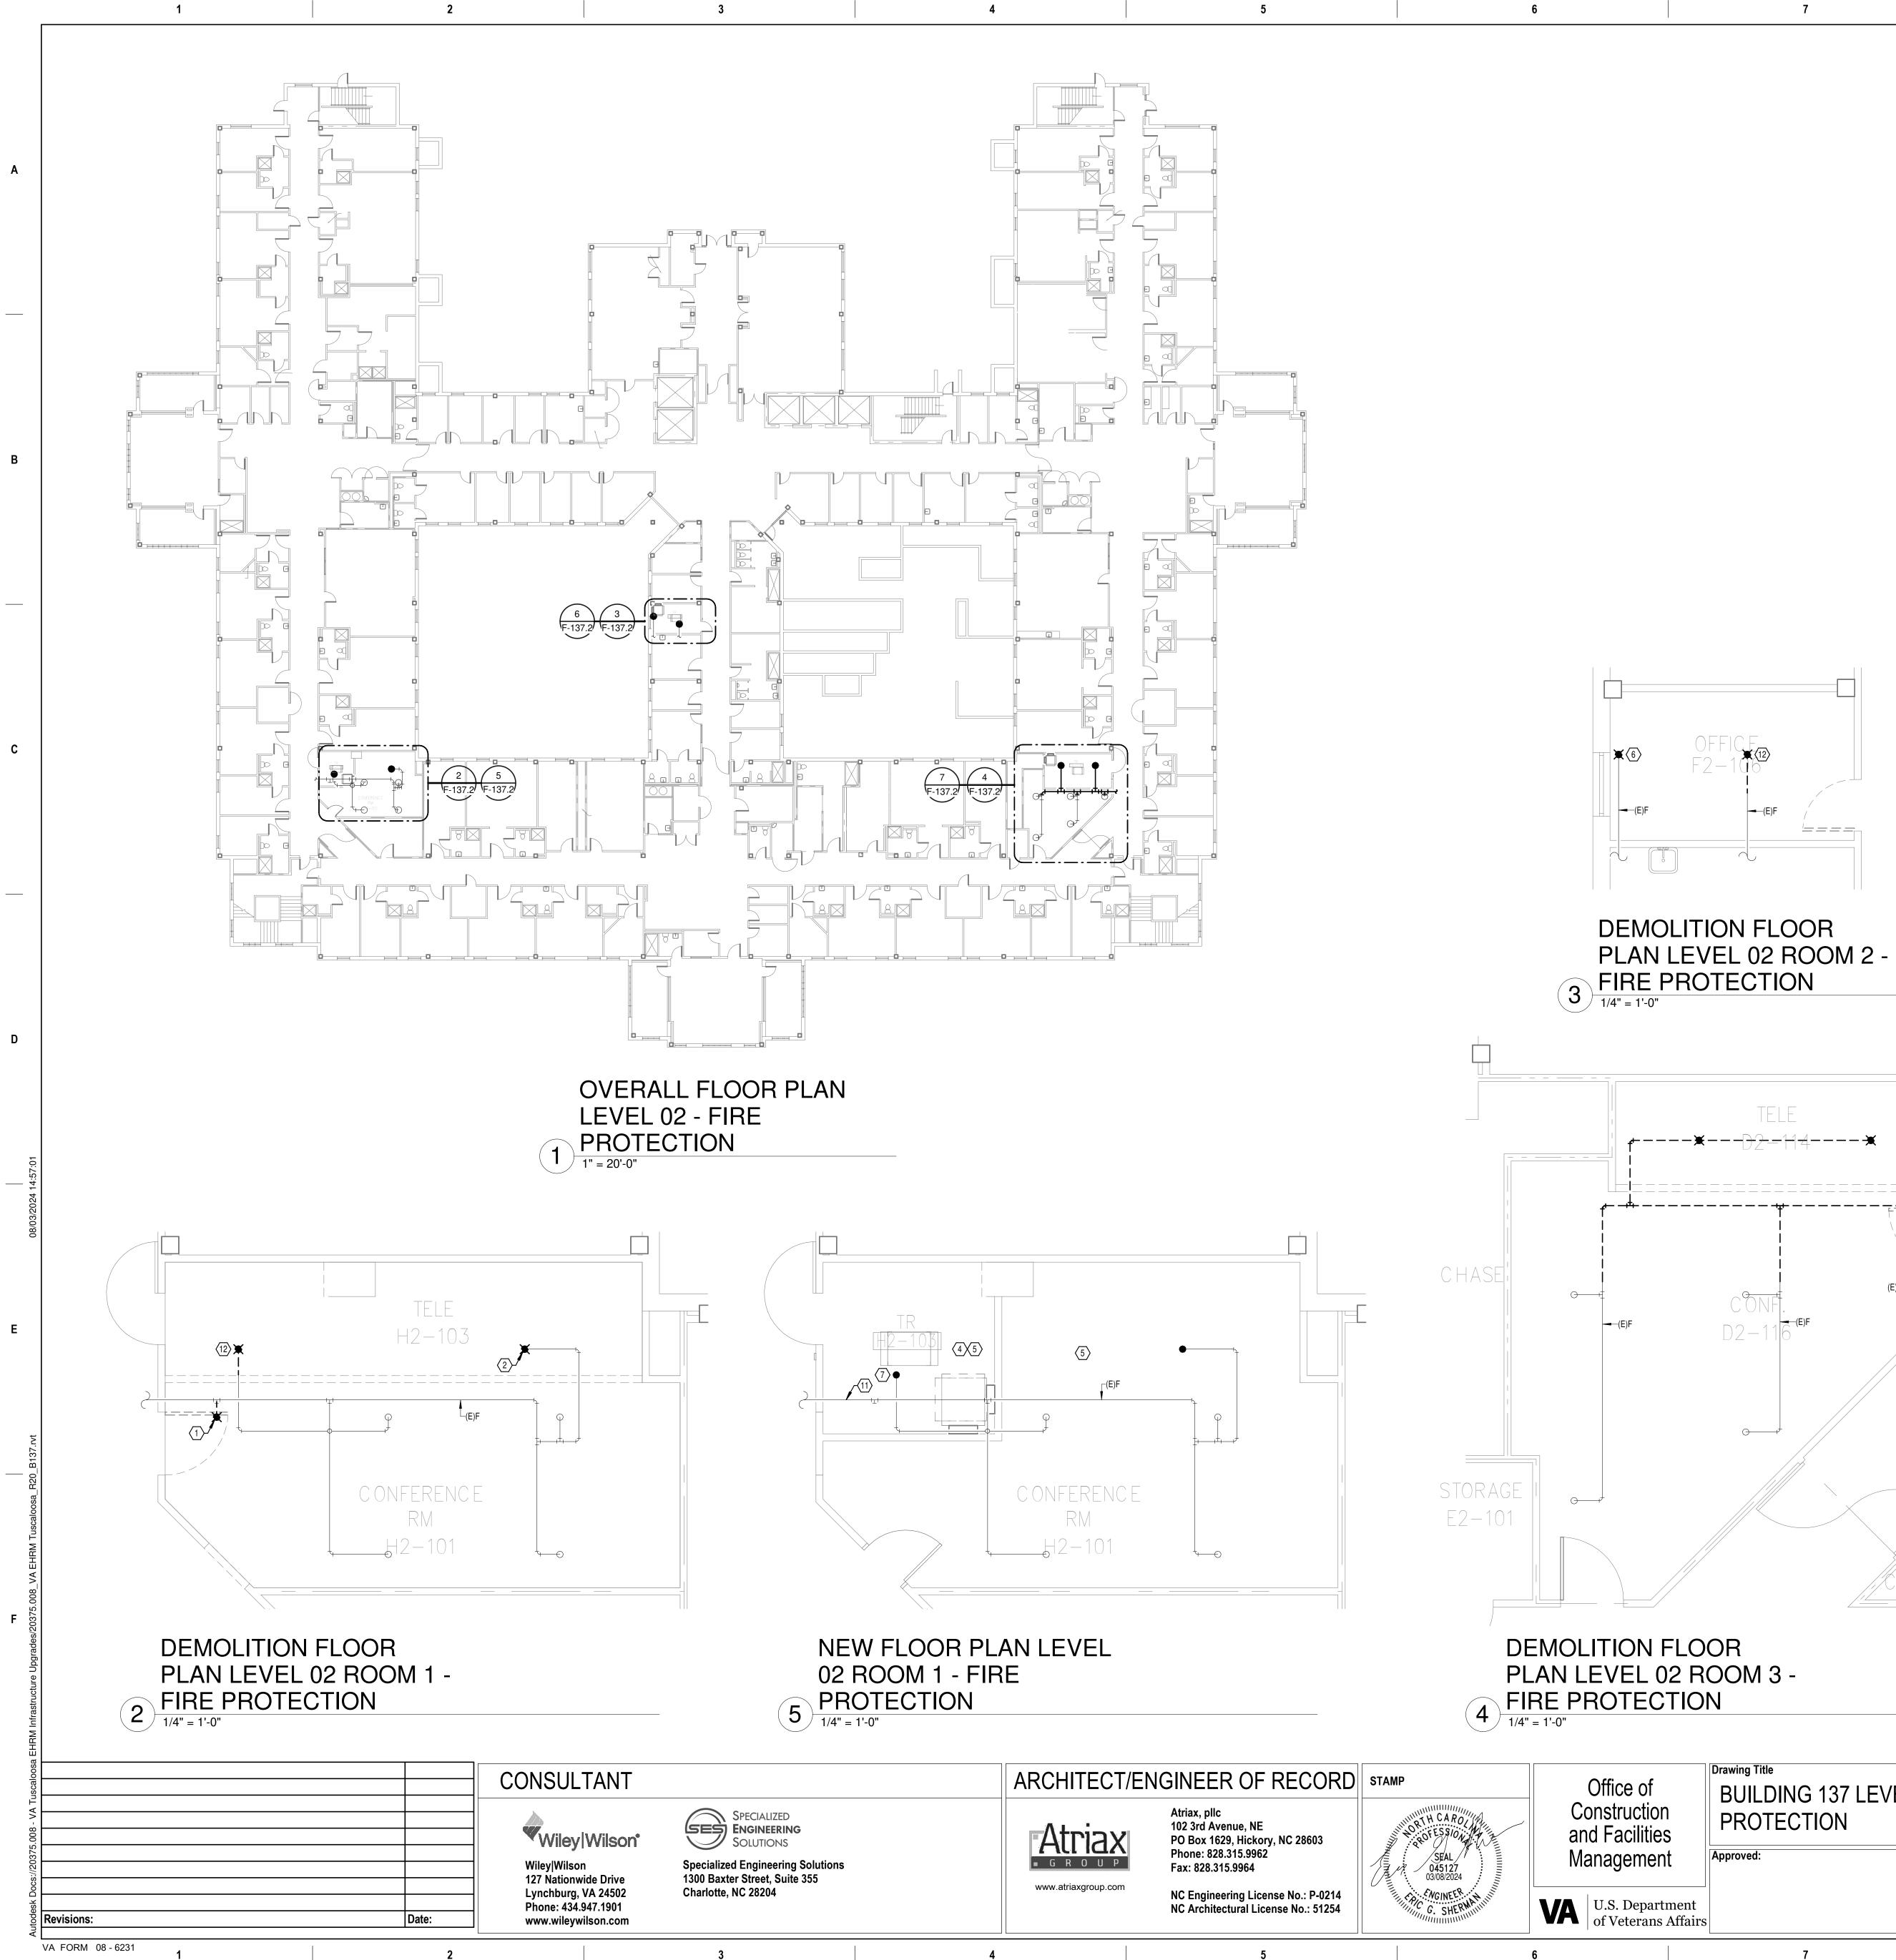
R. AREA OF EXISTING SPRINKLER COVERAGE. HAZARD CLASSIFICATION "LIGHT HAZARD". RELOCATE AND/OR ADD ADDITIONAL HEADS AND PIPING TO MEET COVERAGE REQUIREMENTS PER NFPA 13 AND VA REQUIREMENTS. COORDINATE HEAD LOCATIONS WITH EXISTING CONDITIONS AND ARCHITECT'S CEILING

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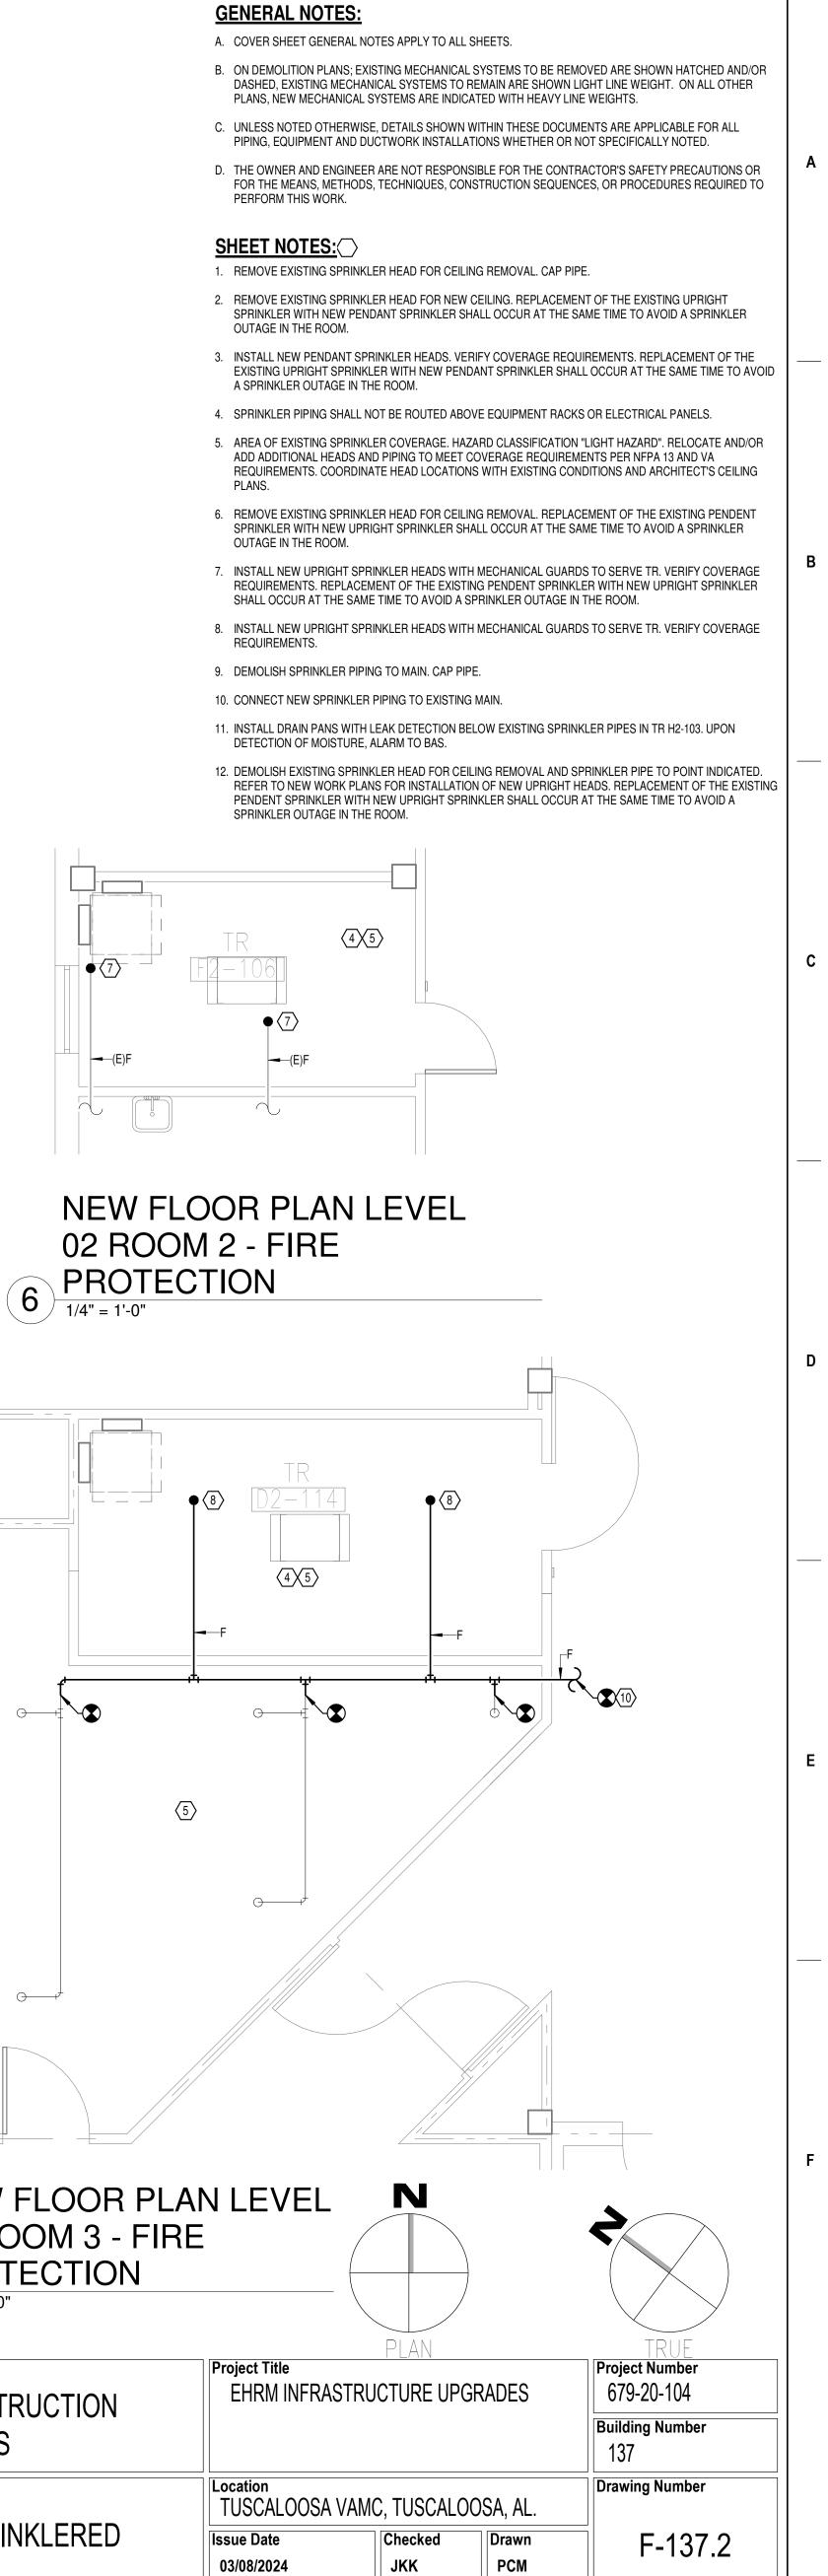
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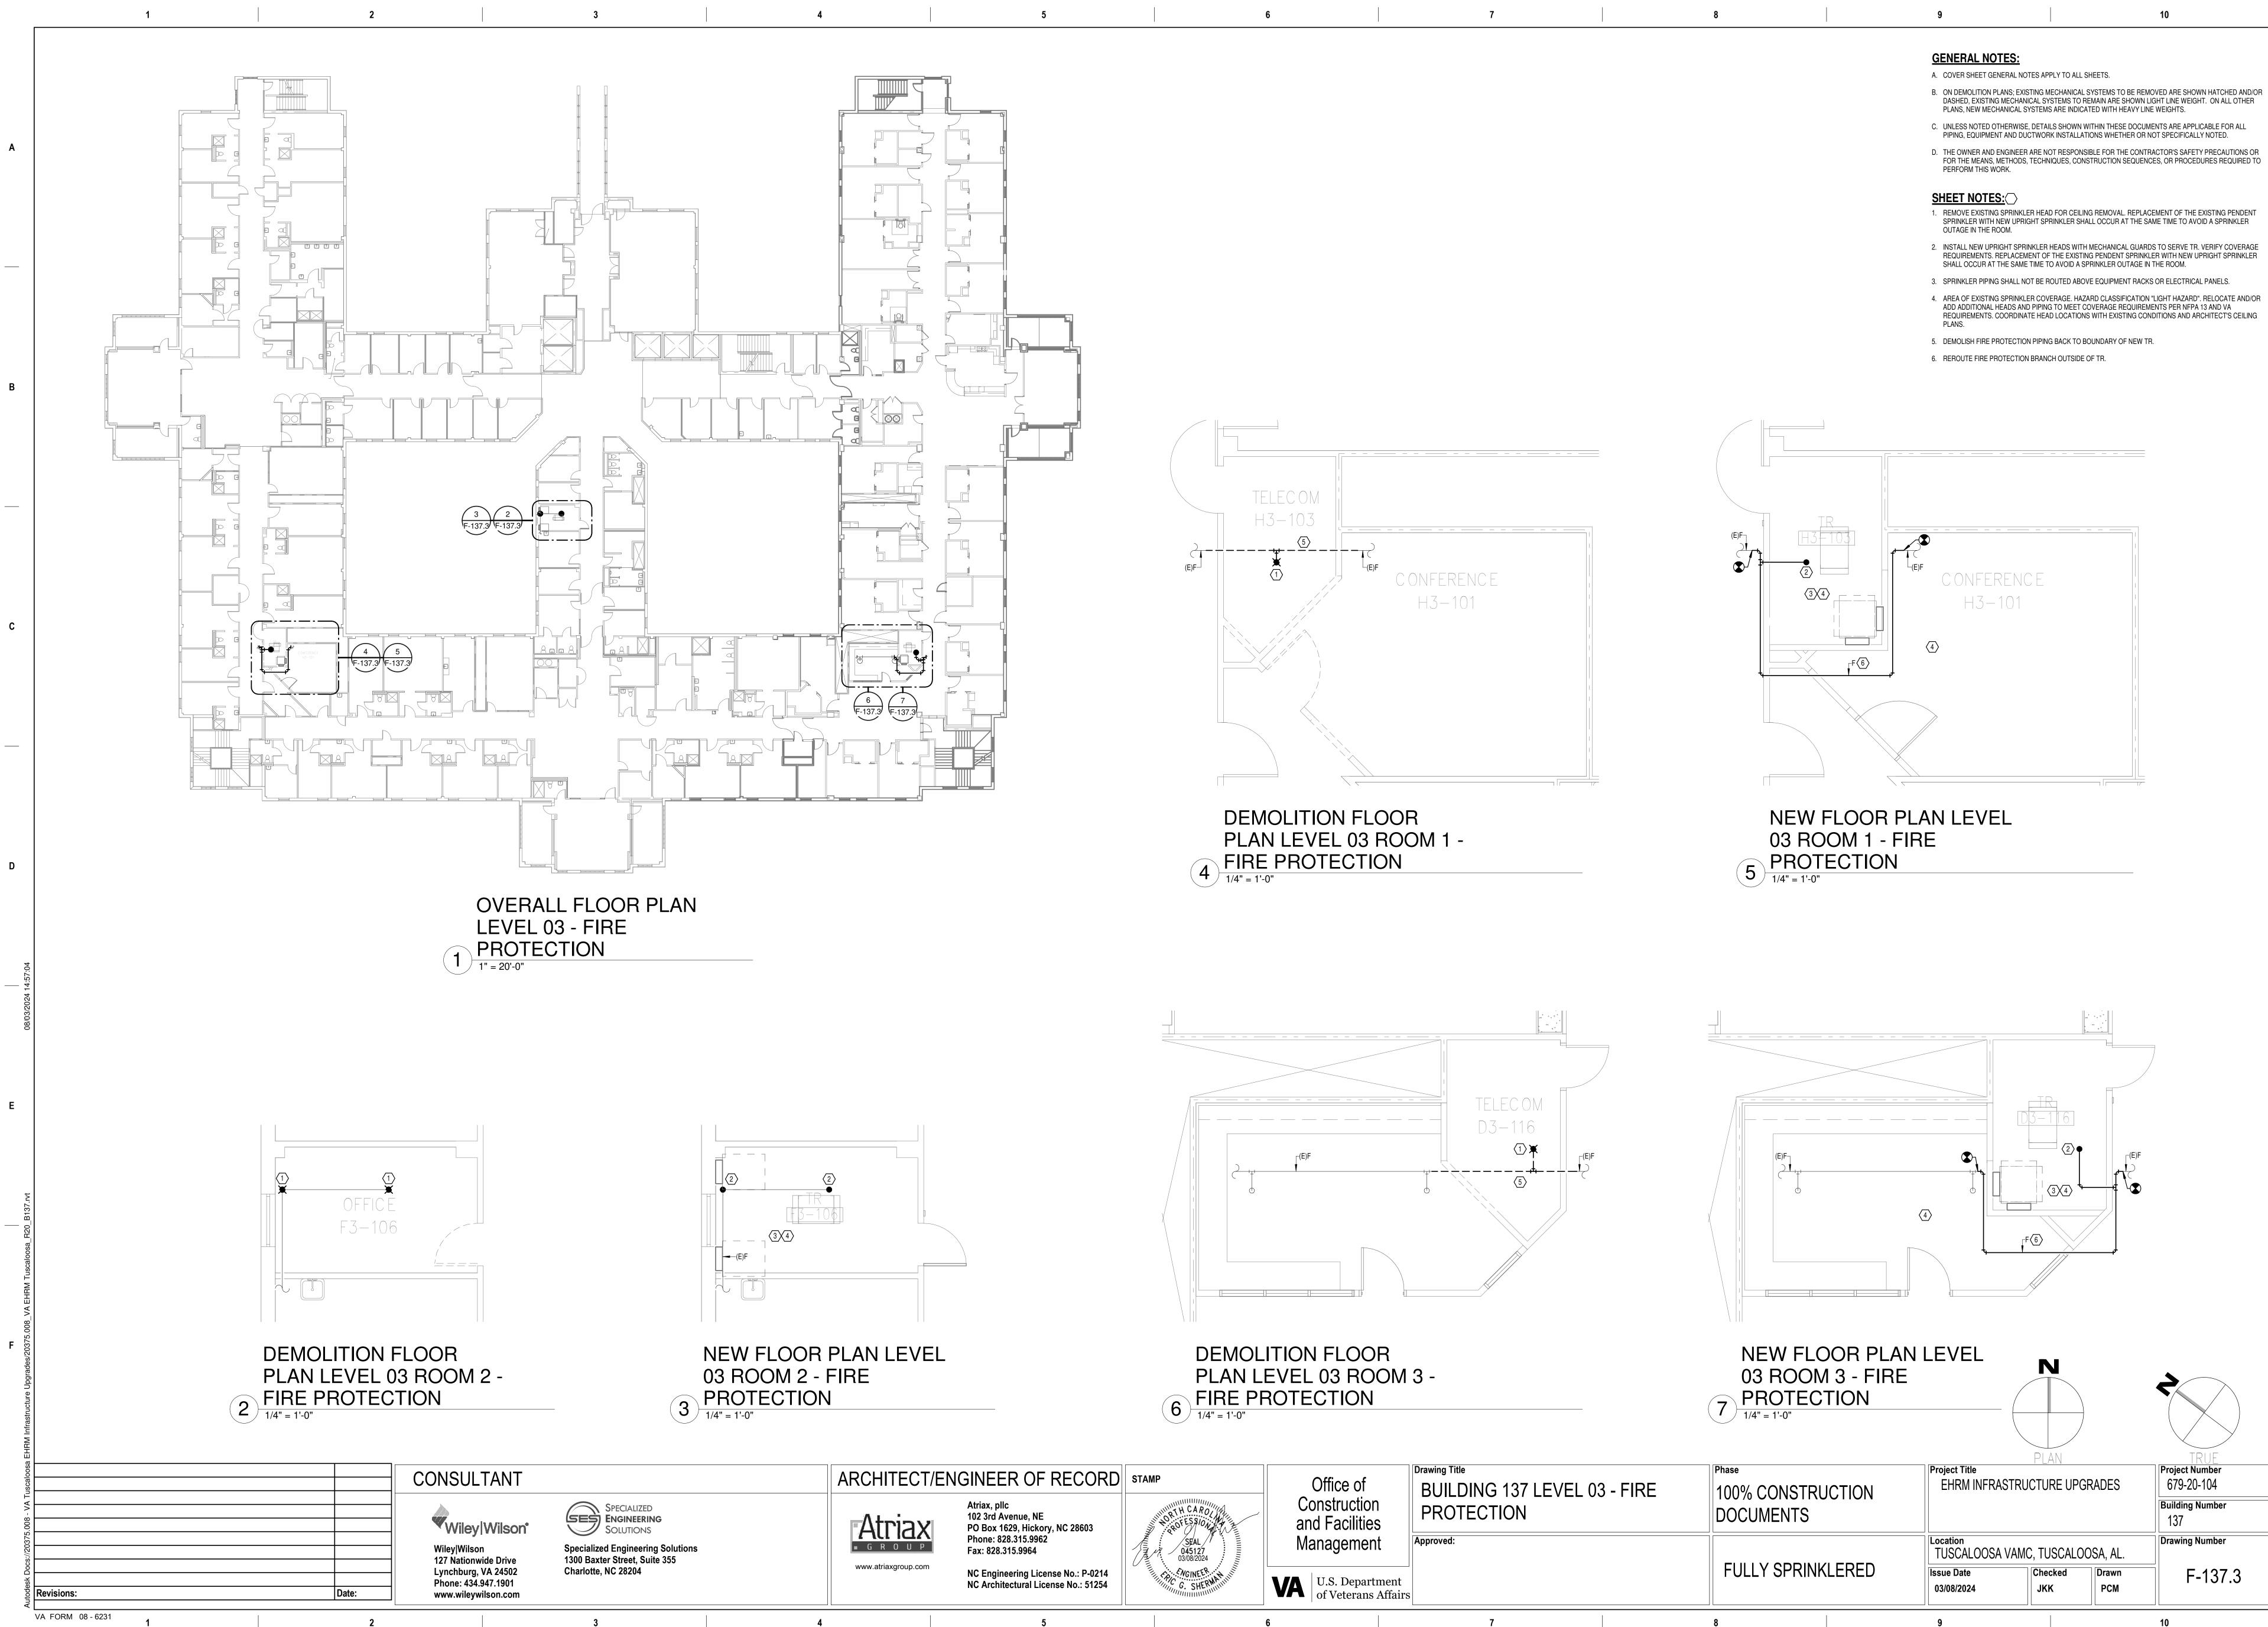
5. REROUTE FIRE PROTECTION BRANCH OUTSIDE OF TR

		TRUE
		Project Number
IPGR	ADES	679-20-104
		Building Number
		137
		Drawing Number
L008	SA, AL.	
	Drawn	F-137.1
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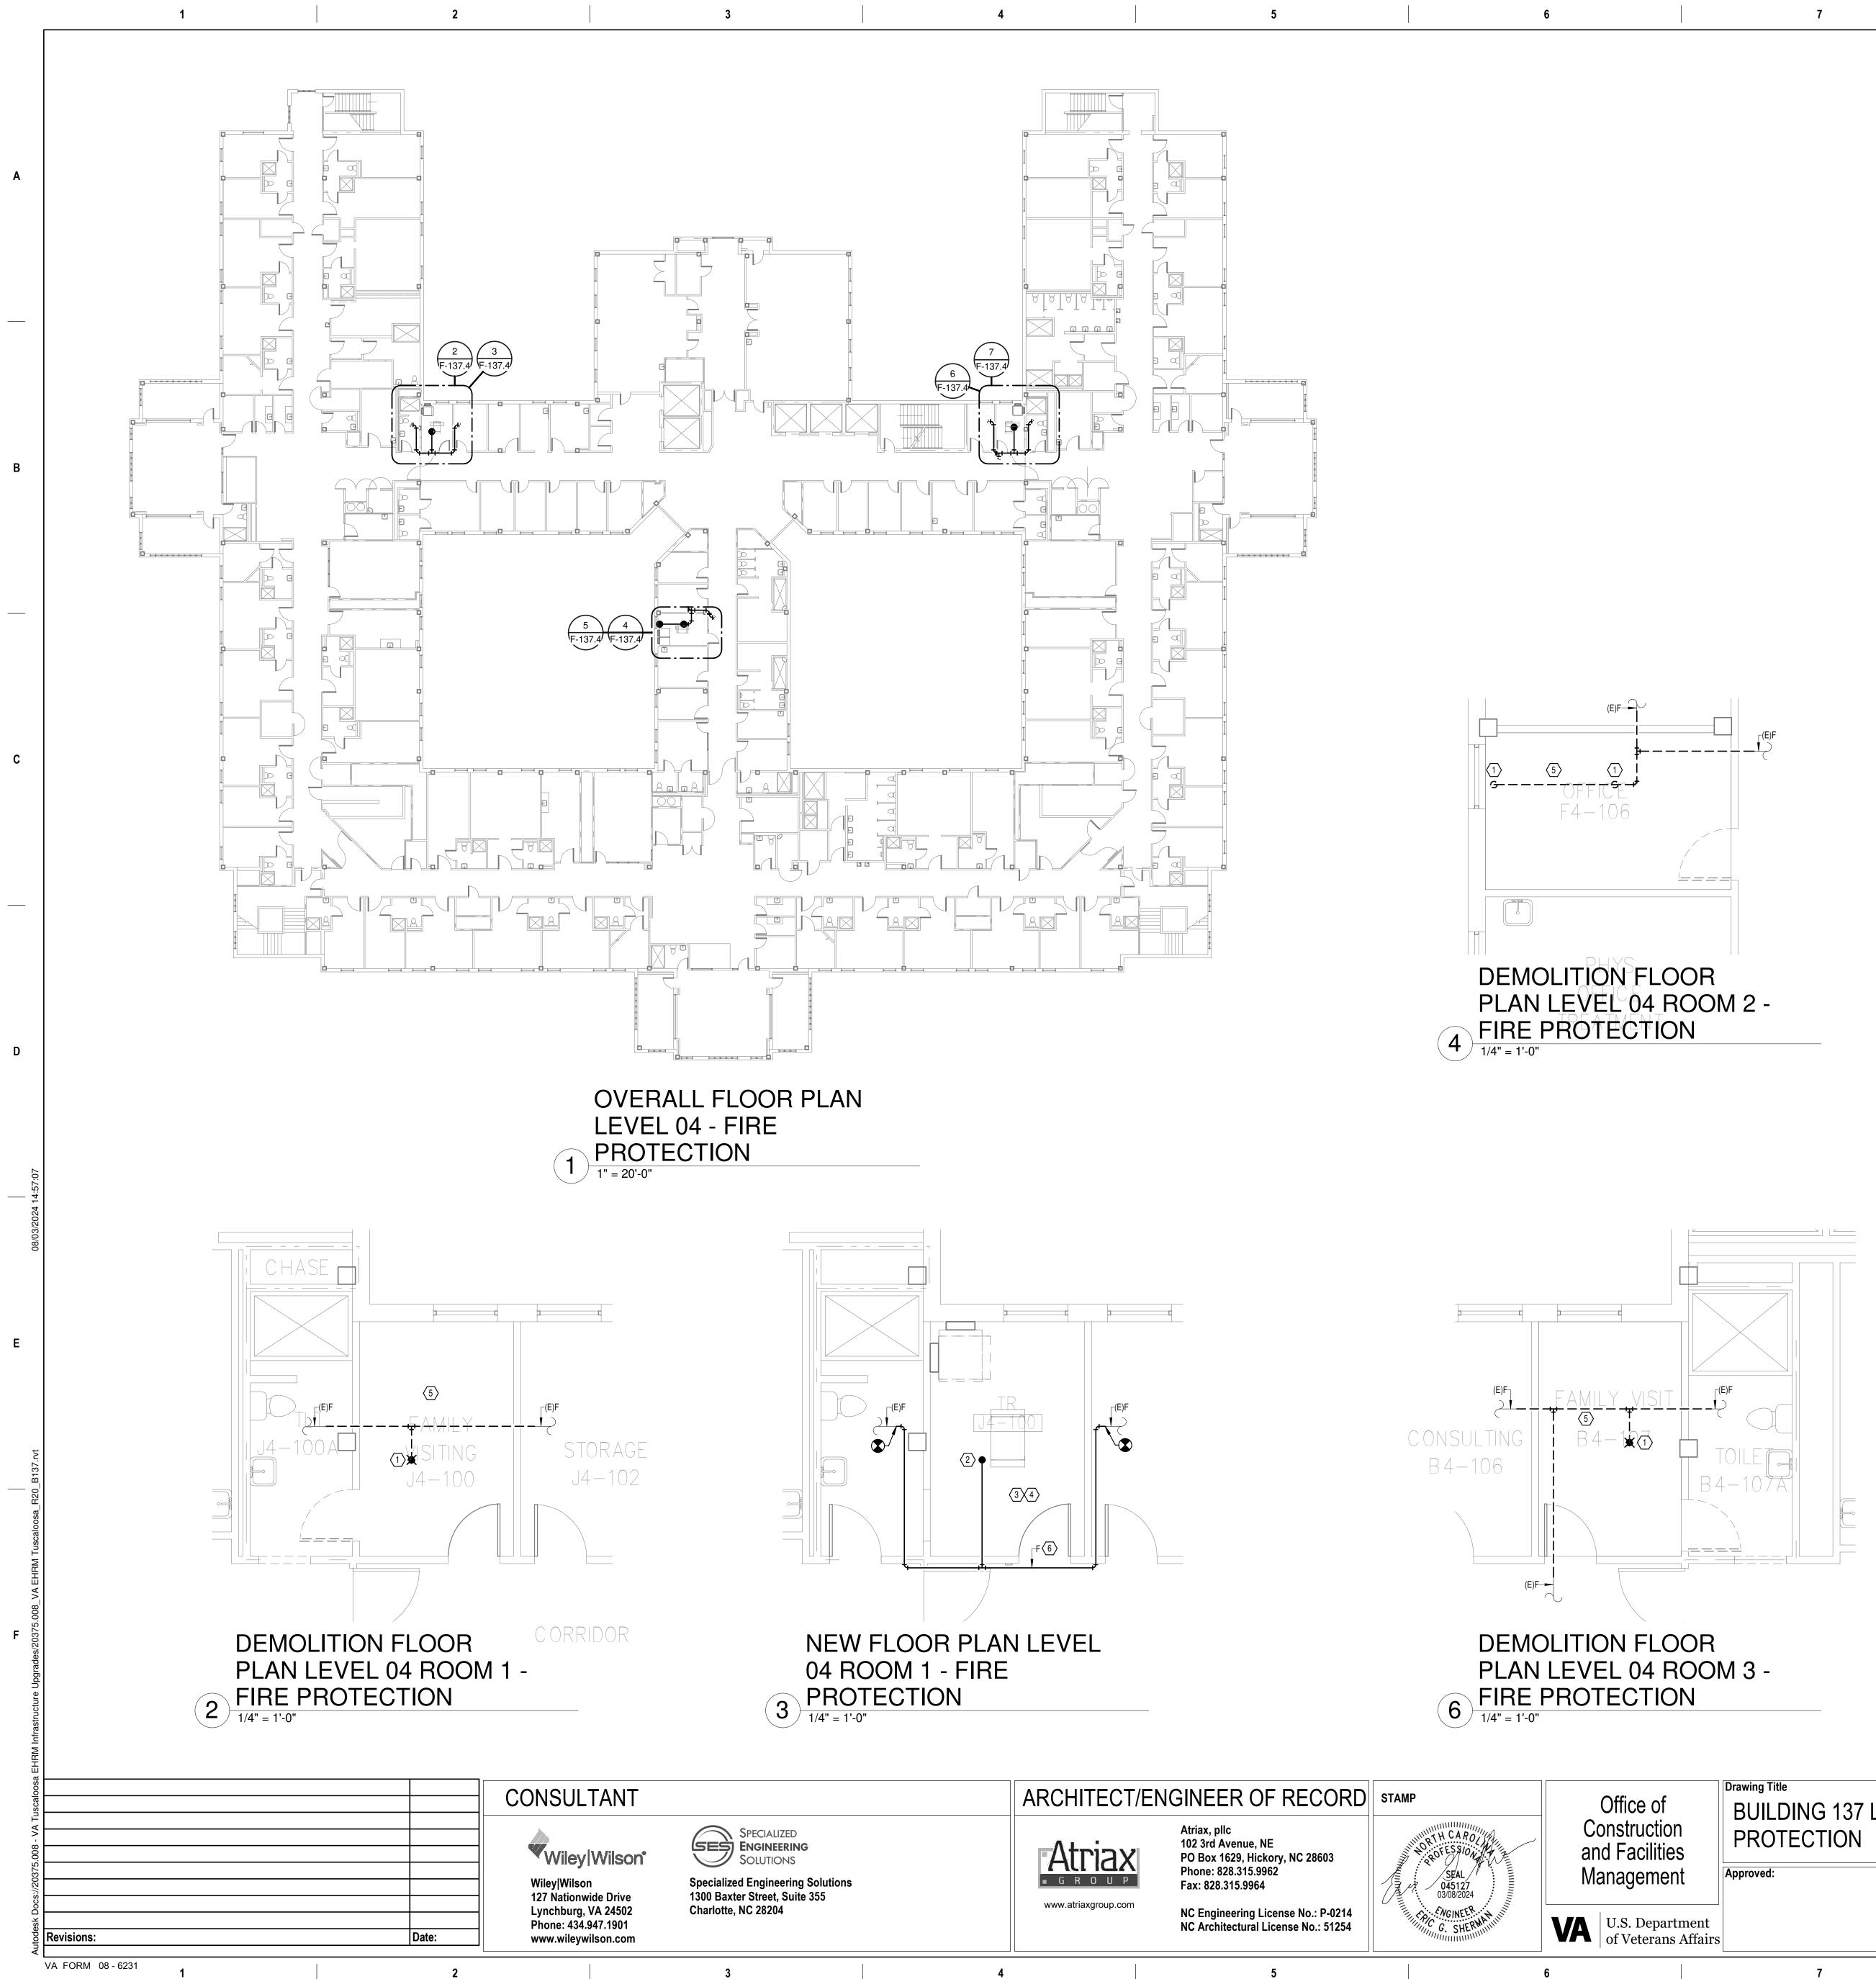


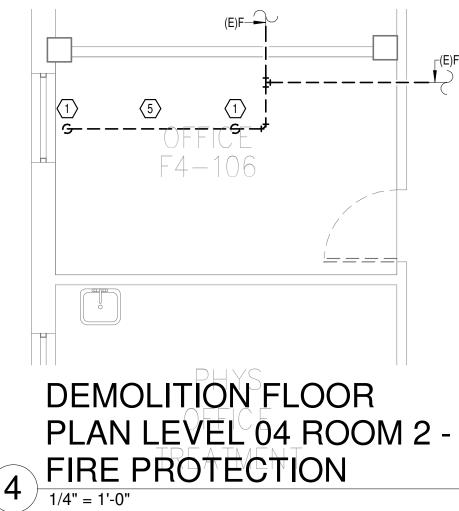
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		F F	
CONF. D2-116 <sup>(E)F</sup>		5	
N FLOOR L 02 ROOM 3 - ECTION	NEW FLOOR PLA 02 ROOM 3 - FIR PROTECTION 1/4" = 1'-0"	{Ε	PLAN
of ction ilities	Phase 100% CONSTRUCTION DOCUMENTS	Project Title EHRM INFRAS	STRUCTURE U
ment epartment erans Affairs	FULLY SPRINKLERED	Location TUSCALOOSA Issue Date 03/08/2024	VAMC, TUSCA Checked JKK
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# **GENERAL NOTES:**

- FOR THE MEANS, METHODS, TECHNIQUES, CONSTRUCTION SEQUENCES, OR PROCEDURES REQUIRED TO

# SHEET NOTES:

PERFORM THIS WORK.

- PLANS.
- 5. DEMOLISH FIRE PROTECTION PIPING BACK TO BOUNDARY OF NEW TR.
- 6. REROUTE FIRE PROTECTION BRANCH OUTSIDE OF TR.



# $\langle 3 \langle 4 \rangle$ (E)F---F(6)

# NEW FLOOR PLAN LEVEL 04 ROOM 3 - FIRE 7 **PROTECTION** 1/4" = 1'-0"

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of ction ilities	Drawing Title BUILDING 137 LEVEL 04 PROTECTION	4 - FIRE	<sup>Phase</sup> 100% CONSTRU DOCUMENTS	JCTION	Project Title EHRM INFRASTR	<u>PLAN</u> UCTURE
ment	Approved:				Location TUSCALOOSA VAM	AC, TUSC
epartment erans Affairs			FULLY SPRINK	LERED	Issue Date 03/08/2024	Checked JKK
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A. COVER SHEET GENERAL NOTES APPLY TO ALL SHEETS.

B. ON DEMOLITION PLANS; EXISTING MECHANICAL SYSTEMS TO BE REMOVED ARE SHOWN HATCHED AND/OR DASHED, EXISTING MECHANICAL SYSTEMS TO REMAIN ARE SHOWN LIGHT LINE WEIGHT. ON ALL OTHER PLANS, NEW MECHANICAL SYSTEMS ARE INDICATED WITH HEAVY LINE WEIGHTS. C. UNLESS NOTED OTHERWISE, DETAILS SHOWN WITHIN THESE DOCUMENTS ARE APPLICABLE FOR ALL PIPING, EQUIPMENT AND DUCTWORK INSTALLATIONS WHETHER OR NOT SPECIFICALLY NOTED. D. THE OWNER AND ENGINEER ARE NOT RESPONSIBLE FOR THE CONTRACTOR'S SAFETY PRECAUTIONS OR

1. REMOVE EXISTING SPRINKLER HEAD FOR CEILING REMOVAL. REFER TO NEW WORK PLANS FOR INSTALLATION OF NEW UPRIGHT HEADS. REPLACEMENT OF THE EXISTING PENDENT SPRINKLER WITH NEW UPRIGHT SPRINKLER SHALL OCCUR AT THE SAME TIME TO AVOID A SPRINKLER OUTAGE IN THE ROOM. 2. INSTALL NEW UPRIGHT SPRINKLER HEADS WITH MECHANICAL GUARDS TO SERVE TR. VERIFY COVERAGE REQUIREMENTS. REPLACEMENT OF THE EXISTING PENDENT SPRINKLER WITH NEW UPRIGHT SPRINKLER SHALL OCCUR AT THE SAME TIME TO AVOID A SPRINKLER OUTAGE IN THE ROOM. 3. SPRINKLER PIPING SHALL NOT BE ROUTED ABOVE EQUIPMENT RACKS OR ELECTRICAL PANELS.

4. AREA OF EXISTING SPRINKLER COVERAGE. HAZARD CLASSIFICATION "LIGHT HAZARD". RELOCATE AND/OR ADD ADDITIONAL HEADS AND PIPING TO MEET COVERAGE REQUIREMENTS PER NFPA 13 AND VA REQUIREMENTS. COORDINATE HEAD LOCATIONS WITH EXISTING CONDITIONS AND ARCHITECT'S CEILING

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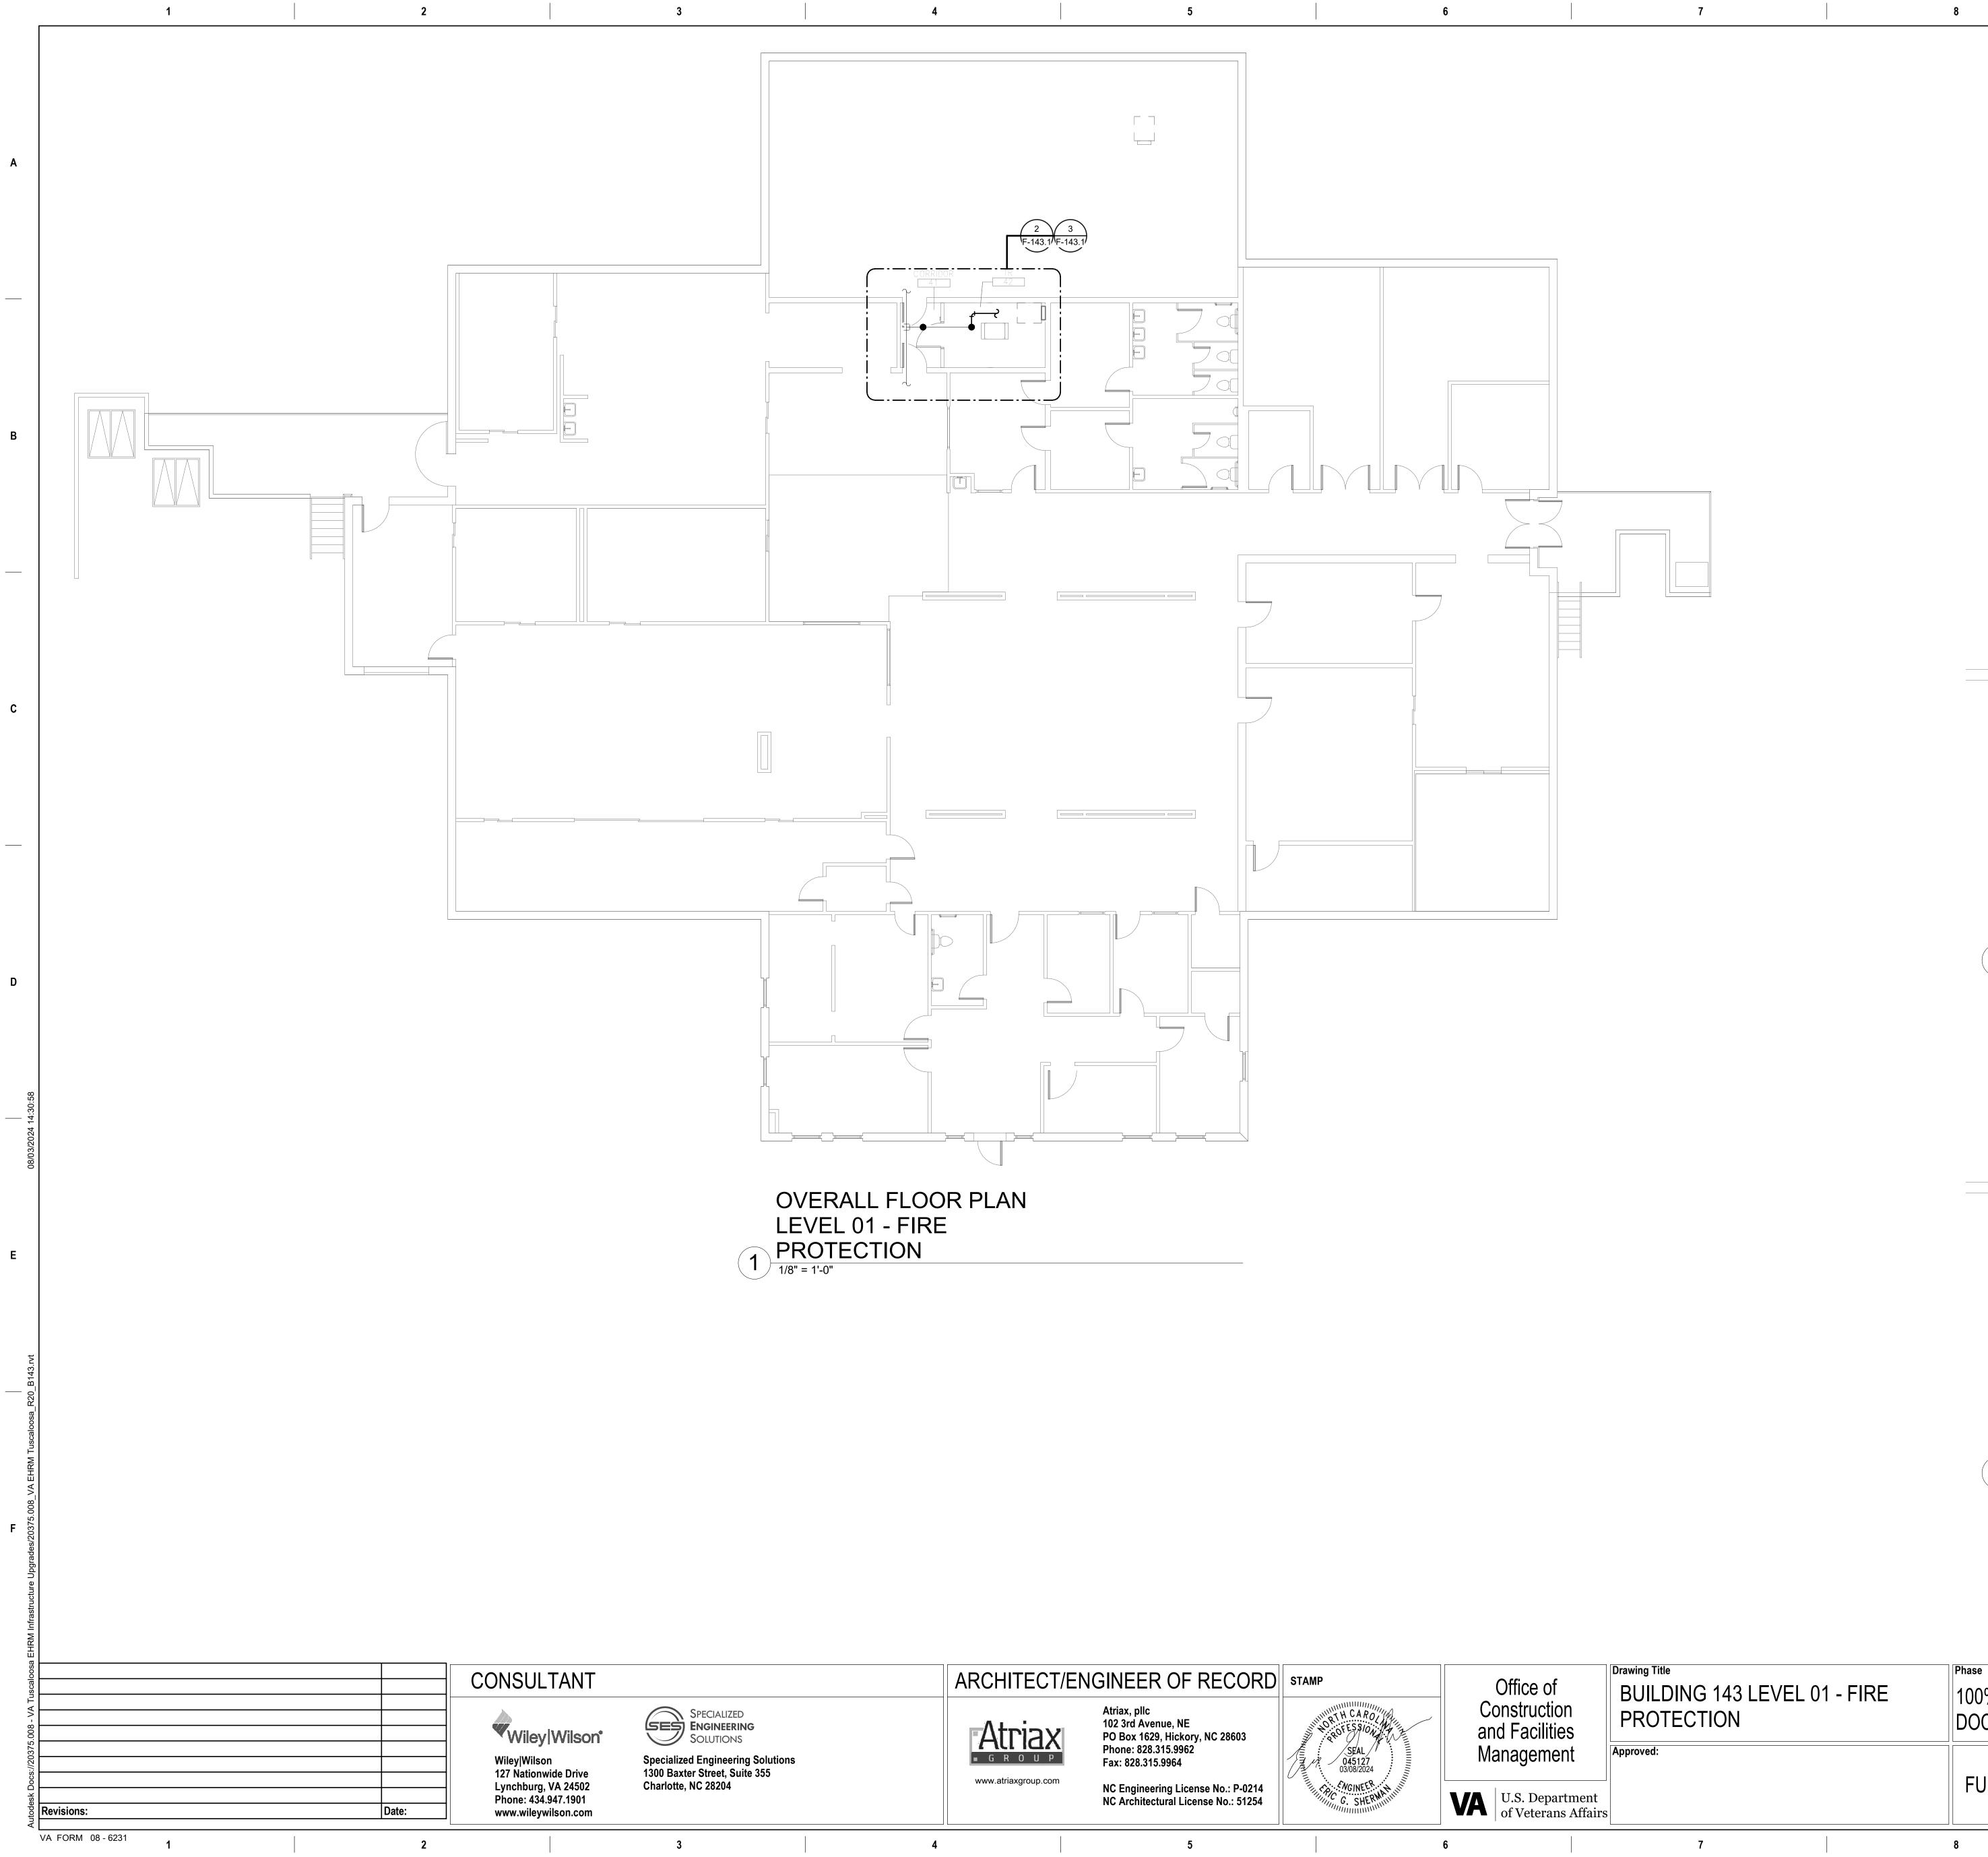
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Project Number 679-20-104 Building Number 137 Drawing Number F-137.4



ARCHITECT/E	NGINEER OF RECORD	STAMP	Office of
	Atriax, pllc 102 3rd Avenue, NE PO Box 1629, Hickory, NC 28603 Phone: 828.315.9962 Fax: 828.315.9964	SEAL 03/08/2024	Construct and Facili Managem
www.atriaxgroup.com	NC Engineering License No.: P-0214 NC Architectural License No.: 51254	G. SHERMANNIN	VA U.S. Dej of Veter

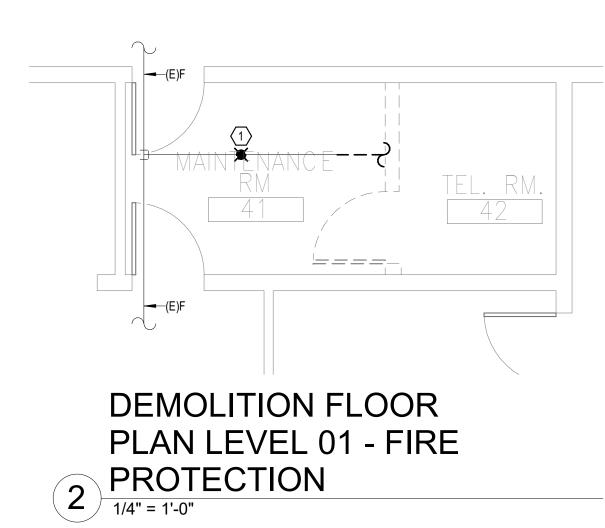
# **GENERAL NOTES:**

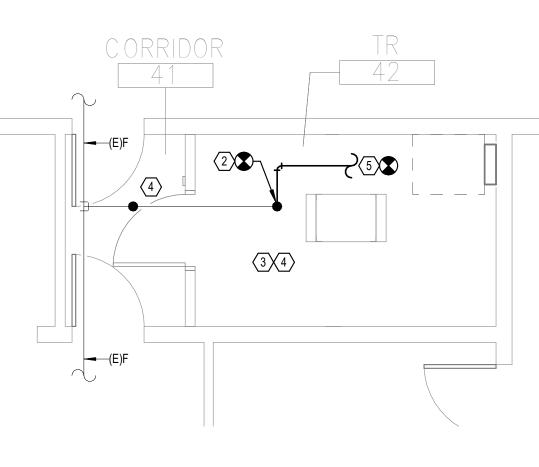
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- A. COVER SHEET GENERAL NOTES APPLY TO ALL SHEETS. B. ON DEMOLITION PLANS; EXISTING MECHANICAL SYSTEMS TO BE REMOVED ARE SHOWN HATCHED AND/OR
- D. THE OWNER AND ENGINEER ARE NOT RESPONSIBLE FOR THE CONTRACTOR'S SAFETY PRECAUTIONS OR FOR THE MEANS, METHODS, TECHNIQUES, CONSTRUCTION SEQUENCES, OR PROCEDURES REQUIRED TO PERFORM THIS WORK.

### SHEET NOTES:

- SPRINKLER OUTAGE IN THE ROOM.
- SHALL OCCUR AT THE SAME TIME TO AVOID A SPRINKLER OUTAGE IN THE ROOM.
- PLANS.
- 5. CONNECT NEW SPRINKLER PIPE TO EXISTING SPRINKLER PIPE.





NEW FLOOR PLAN LEVEL 3 01 - FIRE PROTECTION

of ction ilities	Drawing Title BUILDING 143 LEVEL PROTECTION	01 - FIRE	<sup>Phase</sup> 100% CONSTRU DOCUMENTS	JCTION	Project Title EHRM INFRASTRU	CTURE UPGR	A
ment	Approved:				Location TUSCALOOSA VAM(	C, TUSCALOO	S
epartment erans Affairs			FULLY SPRINK	KLERED	Issue Date 03/08/2024	Checked JKK	
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DASHED, EXISTING MECHANICAL SYSTEMS TO REMAIN ARE SHOWN LIGHT LINE WEIGHT. ON ALL OTHER PLANS, NEW MECHANICAL SYSTEMS ARE INDICATED WITH HEAVY LINE WEIGHTS. C. UNLESS NOTED OTHERWISE, DETAILS SHOWN WITHIN THESE DOCUMENTS ARE APPLICABLE FOR ALL PIPING, EQUIPMENT AND DUCTWORK INSTALLATIONS WHETHER OR NOT SPECIFICALLY NOTED.

DEMOLISH EXISTING SPRINKLER HEAD FOR CEILING REMOVAL AND SPRINKLER PIPE TO POINT INDICATED. REFER TO NEW WORK PLANS FOR INSTALLATION OF NEW UPRIGHT HEADS. REPLACEMENT OF THE EXISTING PENDENT SPRINKLER WITH NEW UPRIGHT SPRINKLER SHALL OCCUR AT THE SAME TIME TO AVOID A

2. INSTALL NEW UPRIGHT SPRINKLER HEADS WITH MECHANICAL GUARDS TO SERVE TR 42. VERIFY COVERAGE REQUIREMENTS. REPLACEMENT OF THE EXISTING PENDENT SPRINKLER WITH NEW UPRIGHT SPRINKLER 3. SPRINKLER PIPING SHALL NOT BE ROUTED ABOVE EQUIPMENT RACKS OR ELECTRICAL PANELS.

4. AREA OF EXISTING SPRINKLER COVERAGE. HAZARD CLASSIFICATION "LIGHT HAZARD". RELOCATE AND/OR ADD ADDITIONAL HEADS AND PIPING TO MEET COVERAGE REQUIREMENTS PER NFPA 13 AND VA REQUIREMENTS. COORDINATE HEAD LOCATIONS WITH EXISTING CONDITIONS AND ARCHITECT'S CEILING

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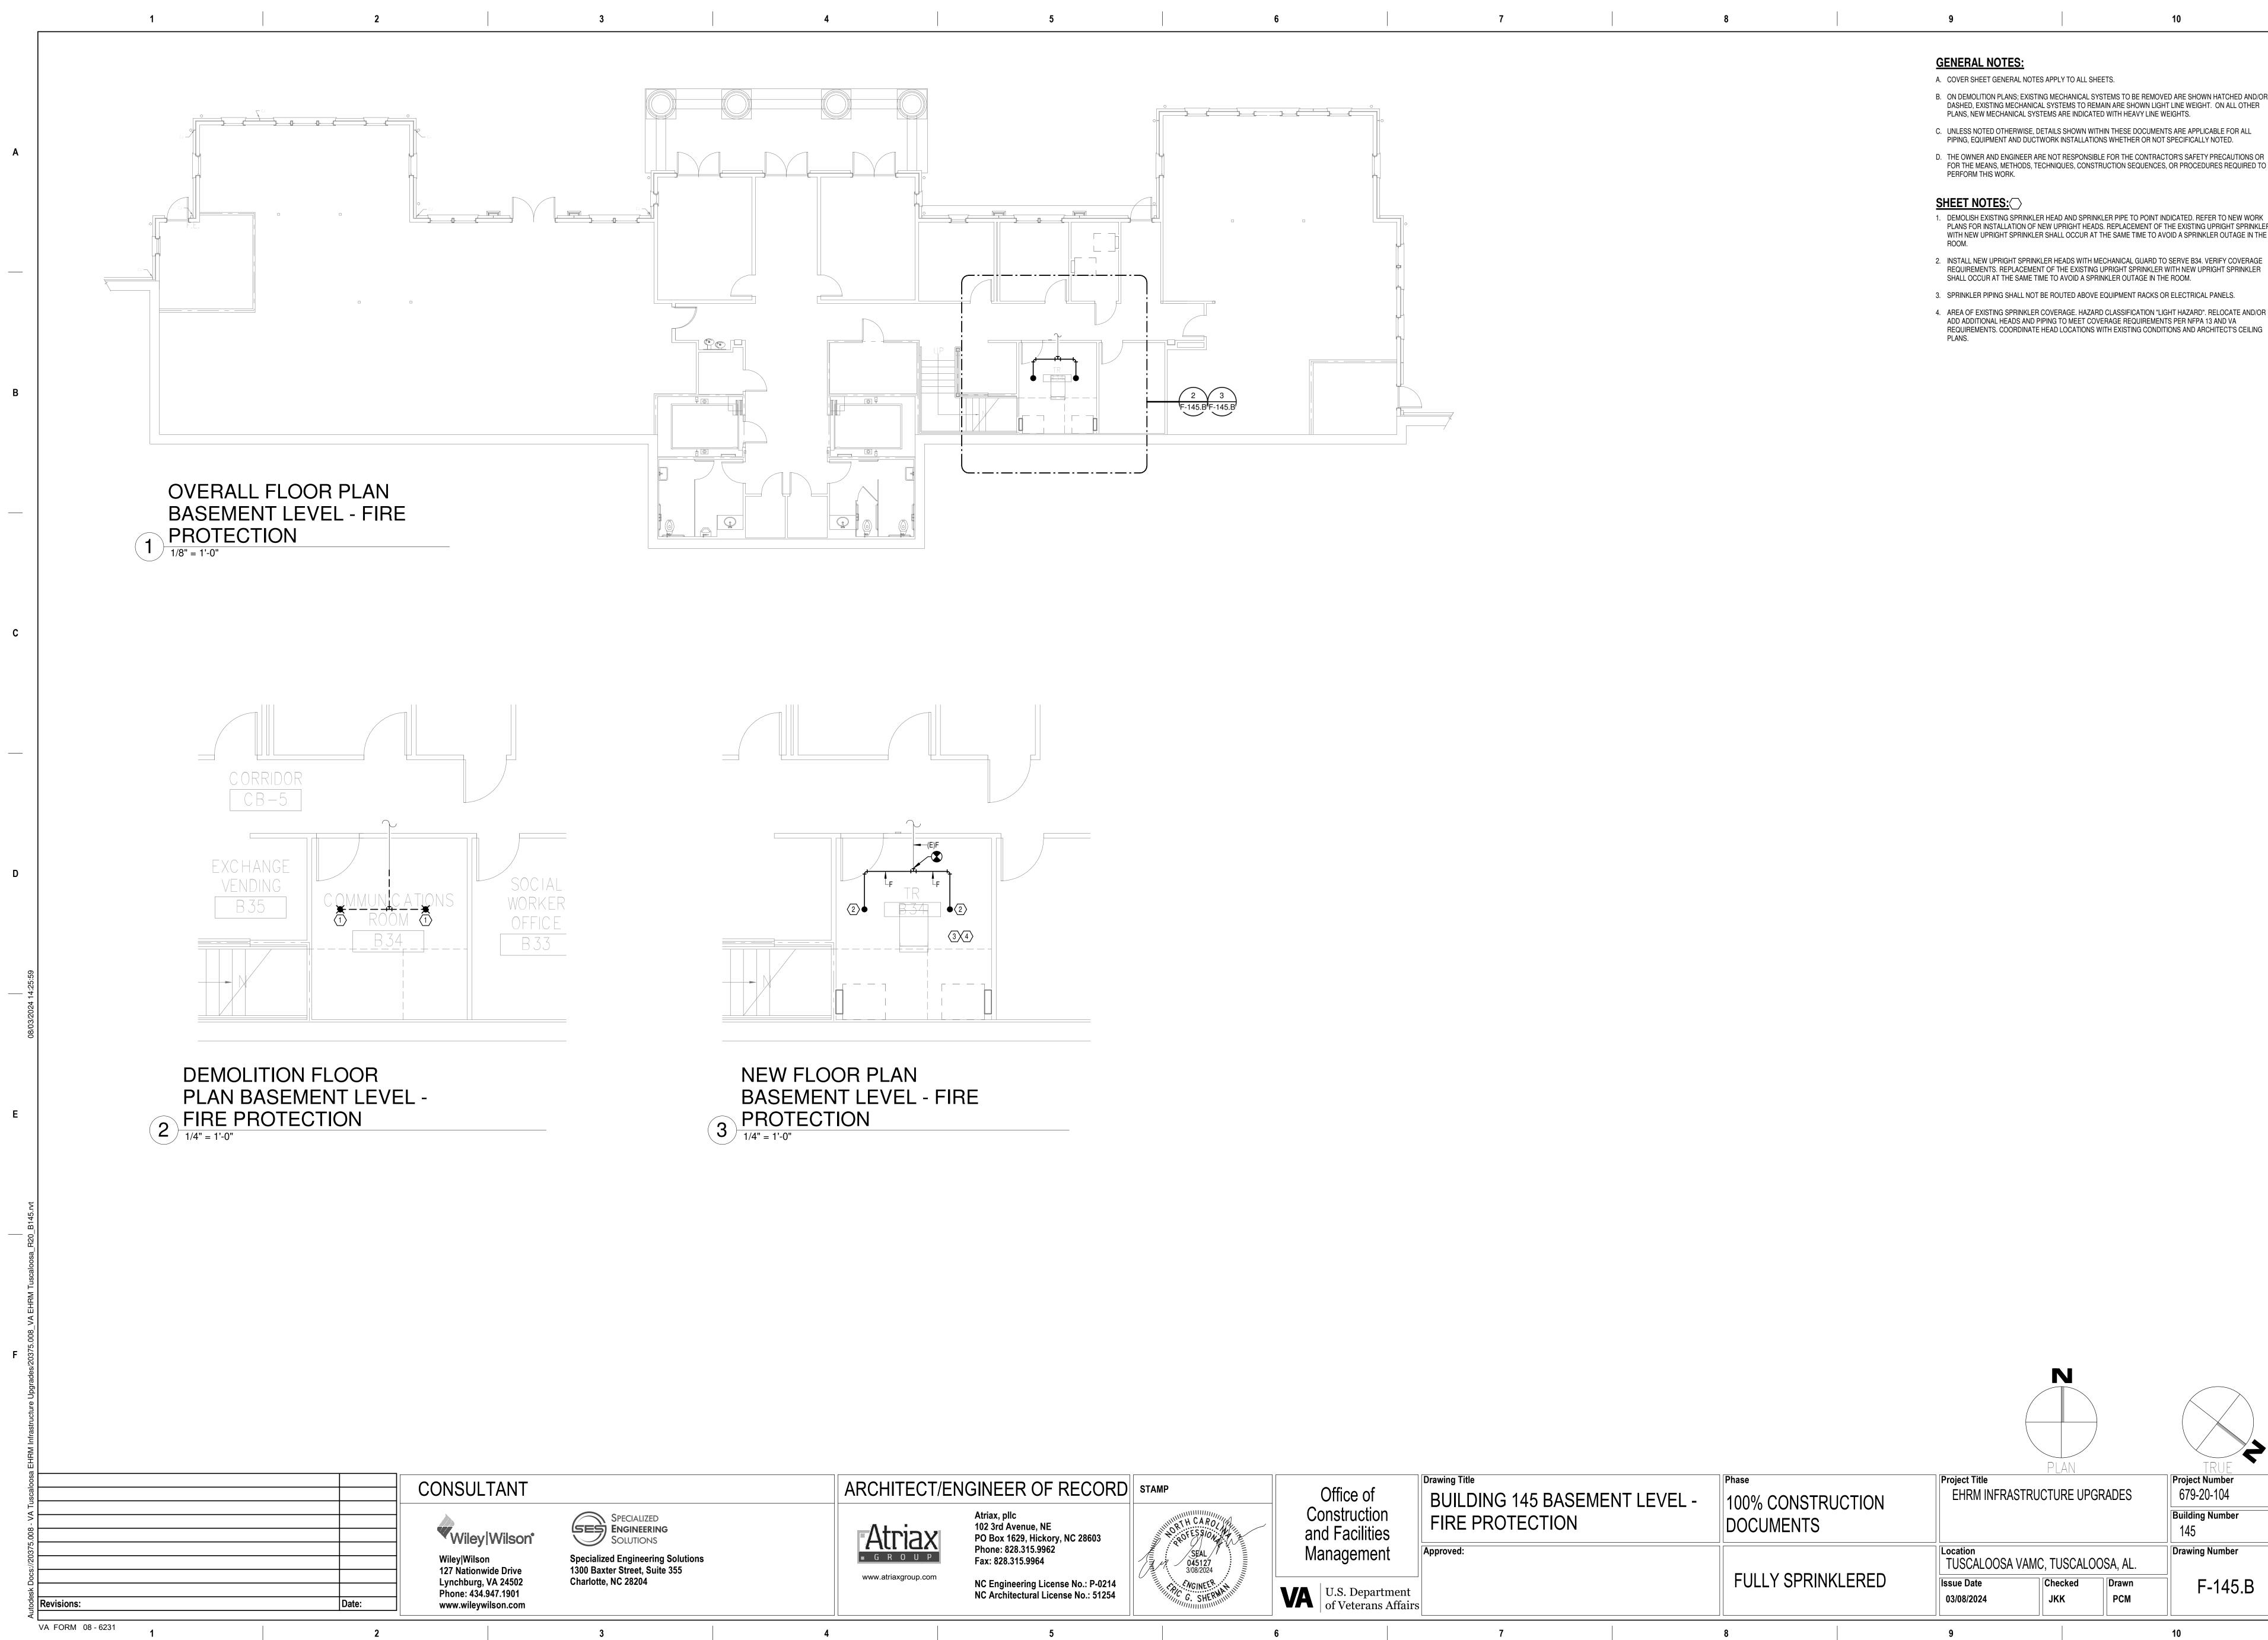
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ARCHITECT/E	NGINEER OF RECORD	STAMP	Office of
	Atriax, pllc 102 3rd Avenue, NE PO Box 1629, Hickory, NC 28603 Phone: 828.315.9962 Fax: 828.315.9964	SEAL 045127 3/08/2024	Construct and Facili Managem
www.atriaxgroup.com	NC Engineering License No.: P-0214 NC Architectural License No.: 51254	G. SHERMAN	VA U.S. Dep of Vetera

- PLANS, NEW MECHANICAL SYSTEMS ARE INDICATED WITH HEAVY LINE WEIGHTS.

- SHALL OCCUR AT THE SAME TIME TO AVOID A SPRINKLER OUTAGE IN THE ROOM.

B. ON DEMOLITION PLANS; EXISTING MECHANICAL SYSTEMS TO BE REMOVED ARE SHOWN HATCHED AND/OR DASHED, EXISTING MECHANICAL SYSTEMS TO REMAIN ARE SHOWN LIGHT LINE WEIGHT. ON ALL OTHER C. UNLESS NOTED OTHERWISE, DETAILS SHOWN WITHIN THESE DOCUMENTS ARE APPLICABLE FOR ALL PIPING, EQUIPMENT AND DUCTWORK INSTALLATIONS WHETHER OR NOT SPECIFICALLY NOTED. D. THE OWNER AND ENGINEER ARE NOT RESPONSIBLE FOR THE CONTRACTOR'S SAFETY PRECAUTIONS OR FOR THE MEANS, METHODS, TECHNIQUES, CONSTRUCTION SEQUENCES, OR PROCEDURES REQUIRED TO

1. DEMOLISH EXISTING SPRINKLER HEAD AND SPRINKLER PIPE TO POINT INDICATED. REFER TO NEW WORK PLANS FOR INSTALLATION OF NEW UPRIGHT HEADS. REPLACEMENT OF THE EXISTING UPRIGHT SPRINKLER WITH NEW UPRIGHT SPRINKLER SHALL OCCUR AT THE SAME TIME TO AVOID A SPRINKLER OUTAGE IN THE

2. INSTALL NEW UPRIGHT SPRINKLER HEADS WITH MECHANICAL GUARD TO SERVE B34. VERIFY COVERAGE REQUIREMENTS. REPLACEMENT OF THE EXISTING UPRIGHT SPRINKLER WITH NEW UPRIGHT SPRINKLER 3. SPRINKLER PIPING SHALL NOT BE ROUTED ABOVE EQUIPMENT RACKS OR ELECTRICAL PANELS. 4. AREA OF EXISTING SPRINKLER COVERAGE. HAZARD CLASSIFICATION "LIGHT HAZARD". RELOCATE AND/OR

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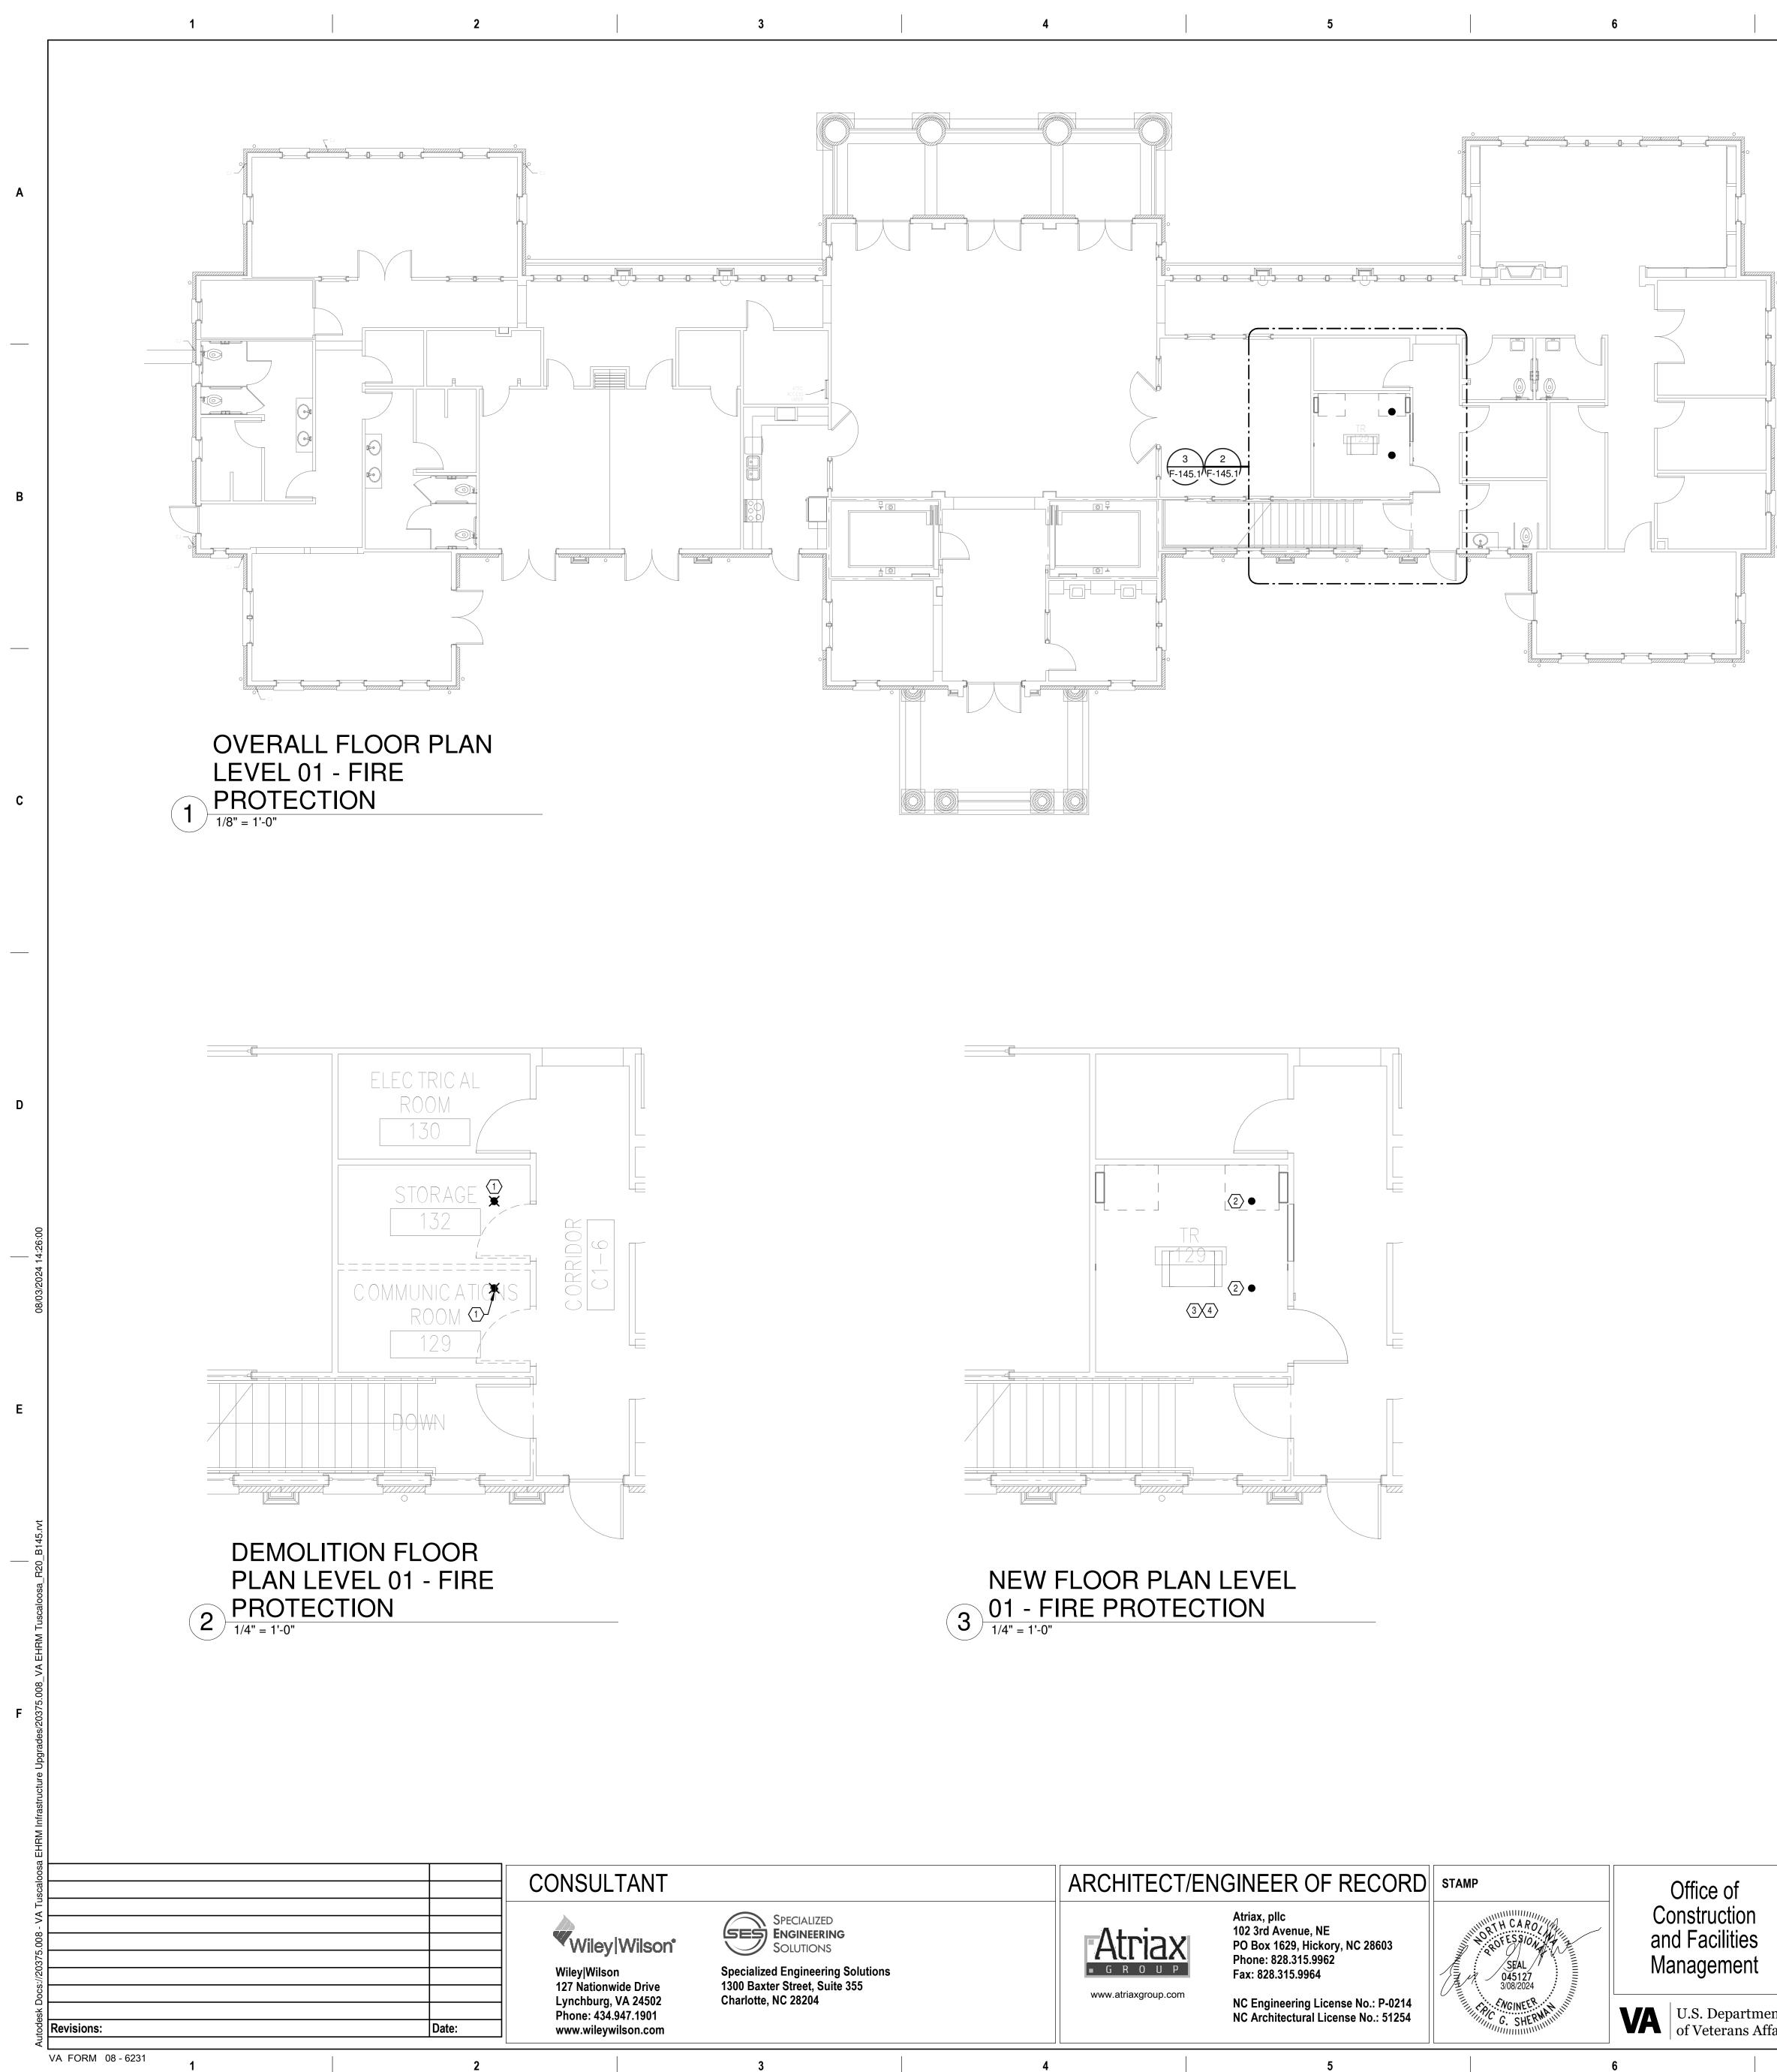
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	TRUE		
UPGRADES	Project Number 679-20-104		
	Building Number 145		
aloosa, al.	Drawing Number		
d Drawn PCM	F-145.B		



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# **GENERAL NOTES:**

- A. COVER SHEET GENERAL NOTES APPLY TO ALL SHEETS.
- PLANS, NEW MECHANICAL SYSTEMS ARE INDICATED WITH HEAVY LINE WEIGHTS.

# SHEET NOTES:

PERFORM THIS WORK.

- OUTAGE IN THE ROOM.
- A SPRINKLER OUTAGE IN THE ROOM.
- PLANS.

						PLAN
of ction ilities	Drawing Title BUILDING 145 LEVEL 0' PROTECTION	1 - FIRE	Phase 100% CONSTRU DOCUMENTS	ICTION	Project Title EHRM INFRASTRU	ICTURE
ment	Approved:				Location TUSCALOOSA VAM	C, TUSC/
epartment erans Affairs			FULLY SPRINK	LERED	Issue Date 03/08/2024	Checked JKK
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B. ON DEMOLITION PLANS; EXISTING MECHANICAL SYSTEMS TO BE REMOVED ARE SHOWN HATCHED AND/OR DASHED, EXISTING MECHANICAL SYSTEMS TO REMAIN ARE SHOWN LIGHT LINE WEIGHT. ON ALL OTHER C. UNLESS NOTED OTHERWISE, DETAILS SHOWN WITHIN THESE DOCUMENTS ARE APPLICABLE FOR ALL PIPING, EQUIPMENT AND DUCTWORK INSTALLATIONS WHETHER OR NOT SPECIFICALLY NOTED. D. THE OWNER AND ENGINEER ARE NOT RESPONSIBLE FOR THE CONTRACTOR'S SAFETY PRECAUTIONS OR FOR THE MEANS, METHODS, TECHNIQUES, CONSTRUCTION SEQUENCES, OR PROCEDURES REQUIRED TO

1. REMOVE EXISTING SPRINKLER HEAD FOR CEILING REMOVAL. REPLACEMENT FOR THE EXISTING PENDENT SPRINKLER WITH NEW UPRIGHT SPRINKLER SHALL OCCUR AT THE SAME TIME TO AVOID A SPRINKLER

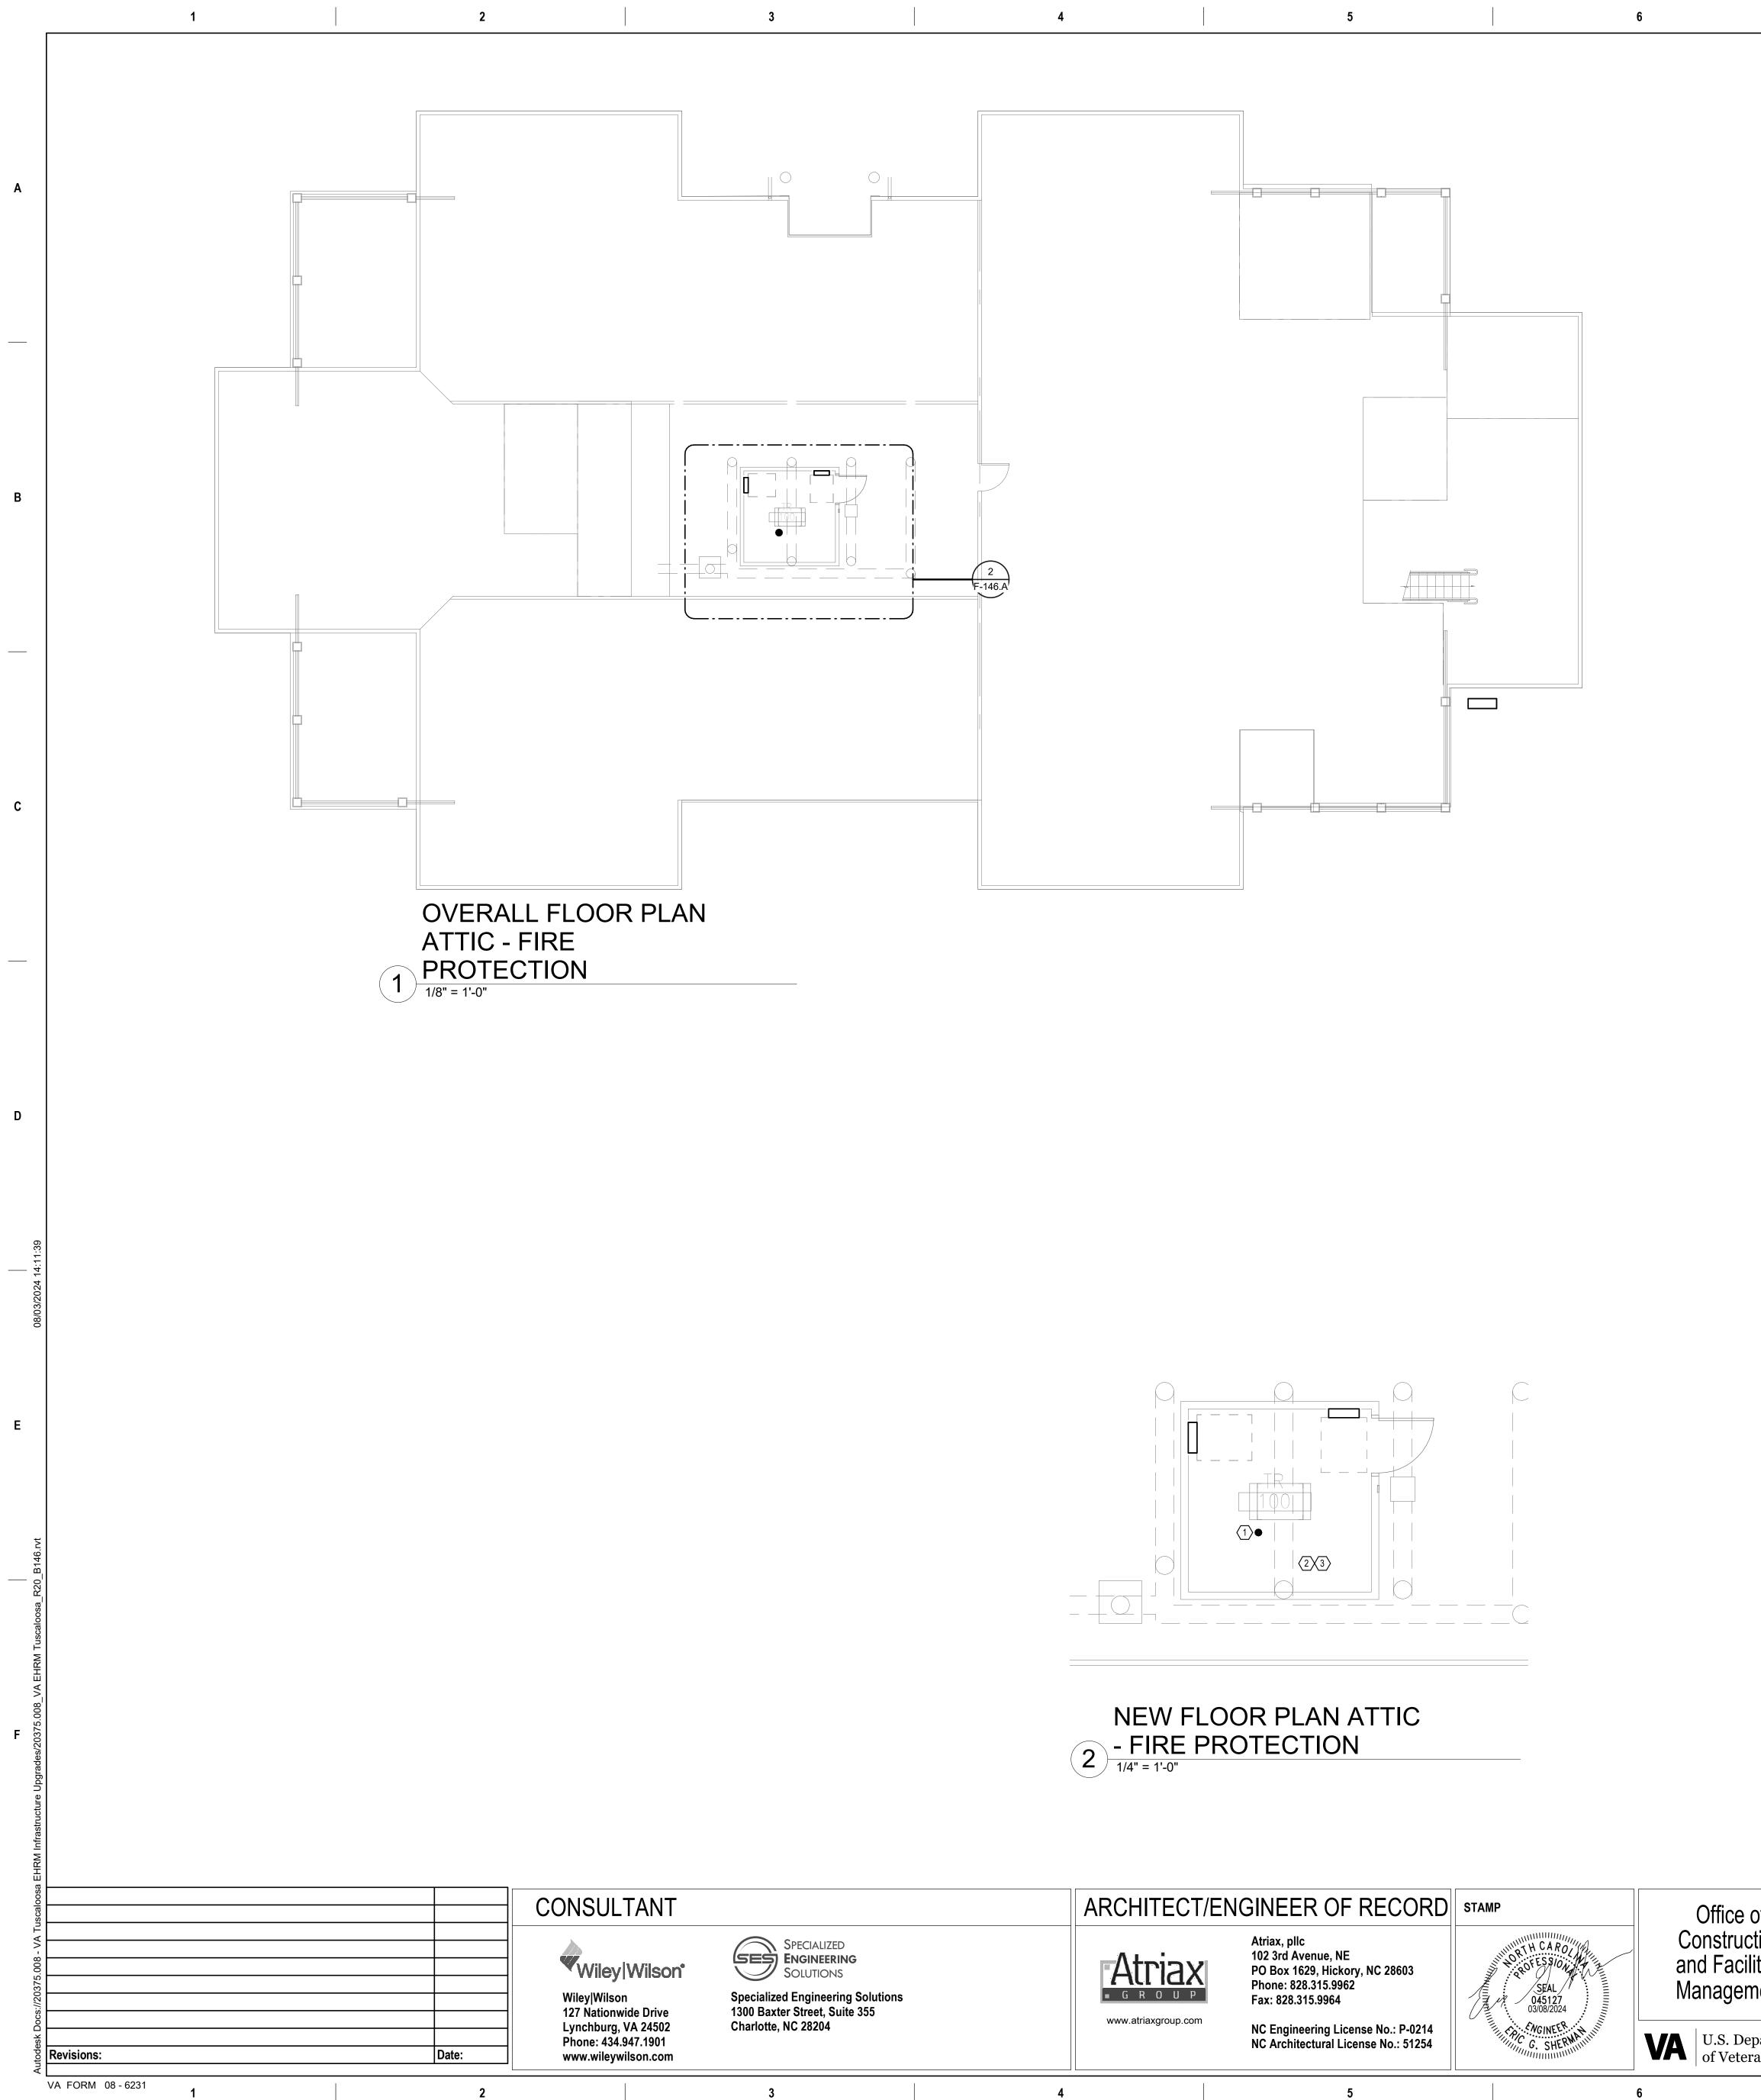
2. INSTALL NEW UPRIGHT SPRINKLER HEADS WITH MECHANICAL GUARDS TO SERVE TR 129. CONNECT NEW SPRINKLER HEAD TO EXISTING SPRINKLER MAIN. VERIFY COVERAGE REQUIREMENTS. REPLACEMENT OF THE EXISTING PENDENT SPRINKLER WITH NEW UPRIGHT SPRINKLER SHALL OCCUR AT THE SAME TIME TO AVOID

3. SPRINKLER PIPING SHALL NOT BE ROUTED ABOVE EQUIPMENT RACKS OR ELECTRICAL PANELS. 4. AREA OF EXISTING SPRINKLER COVERAGE. HAZARD CLASSIFICATION "LIGHT HAZARD". RELOCATE AND/OR ADD ADDITIONAL HEADS AND PIPING TO MEET COVERAGE REQUIREMENTS PER NFPA 13 AND VA REQUIREMENTS. COORDINATE HEAD LOCATIONS WITH EXISTING CONDITIONS AND ARCHITECT'S CEILING

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	TRUE
JCTURE UPGRADES	Project Number 679-20-104 Building Number 145
IC, TUSCALOOSA, AL. Checked JKK PCM	Drawing Number F-145.1



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# **GENERAL NOTES:**

- A. COVER SHEET GENERAL NOTES APPLY TO ALL SHEETS. B. ON DEMOLITION PLANS; EXISTING MECHANICAL SYSTEMS TO BE REMOVED ARE SHOWN HATCHED AND/OR
- PLANS, NEW MECHANICAL SYSTEMS ARE INDICATED WITH HEAVY LINE WEIGHTS.

# SHEET NOTES:

PERFORM THIS WORK.

- REQUIREMENTS. SPRINKLER SHALL BE SERVED FROM SPRINKLER PIPING ABOVE.
- 3. AREA OF EXISTING SPRINKLER COVERAGE. HAZARD CLASSIFICATION "LIGHT HAZARD". RELOCATE AND/OR PLANS.

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of ction ilities	Drawing Title BUILDING 146 ATTIC - FI PROTECTION	Phase 100% CONSTR DOCUMENTS	UCTION	Project Title EHRM INFRASTRU(	
ment	Approved:			Location TUSCALOOSA VAMC	, TUSCAL
epartment erans Affairs		FULLY SPRIN	KLERED	Issue Date 03/08/2024	Checked JKK
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DASHED, EXISTING MECHANICAL SYSTEMS TO REMAIN ARE SHOWN LIGHT LINE WEIGHT. ON ALL OTHER C. UNLESS NOTED OTHERWISE, DETAILS SHOWN WITHIN THESE DOCUMENTS ARE APPLICABLE FOR ALL PIPING, EQUIPMENT AND DUCTWORK INSTALLATIONS WHETHER OR NOT SPECIFICALLY NOTED. D. THE OWNER AND ENGINEER ARE NOT RESPONSIBLE FOR THE CONTRACTOR'S SAFETY PRECAUTIONS OR FOR THE MEANS, METHODS, TECHNIQUES, CONSTRUCTION SEQUENCES, OR PROCEDURES REQUIRED TO

1. INSTALL NEW UPRIGHT SPRINKLER HEADS WITH MECHANICAL GUARDS TO SERVE 100. VERIFY COVERAGE 2. SPRINKLER PIPING SHALL NOT BE ROUTED ABOVE EQUIPMENT RACKS OR ELECTRICAL PANELS.

ADD ADDITIONAL HEADS AND PIPING TO MEET COVERAGE REQUIREMENTS PER NFPA 13 AND VA REQUIREMENTS. COORDINATE HEAD LOCATIONS WITH EXISTING CONDITIONS AND ARCHITECT'S CEILING

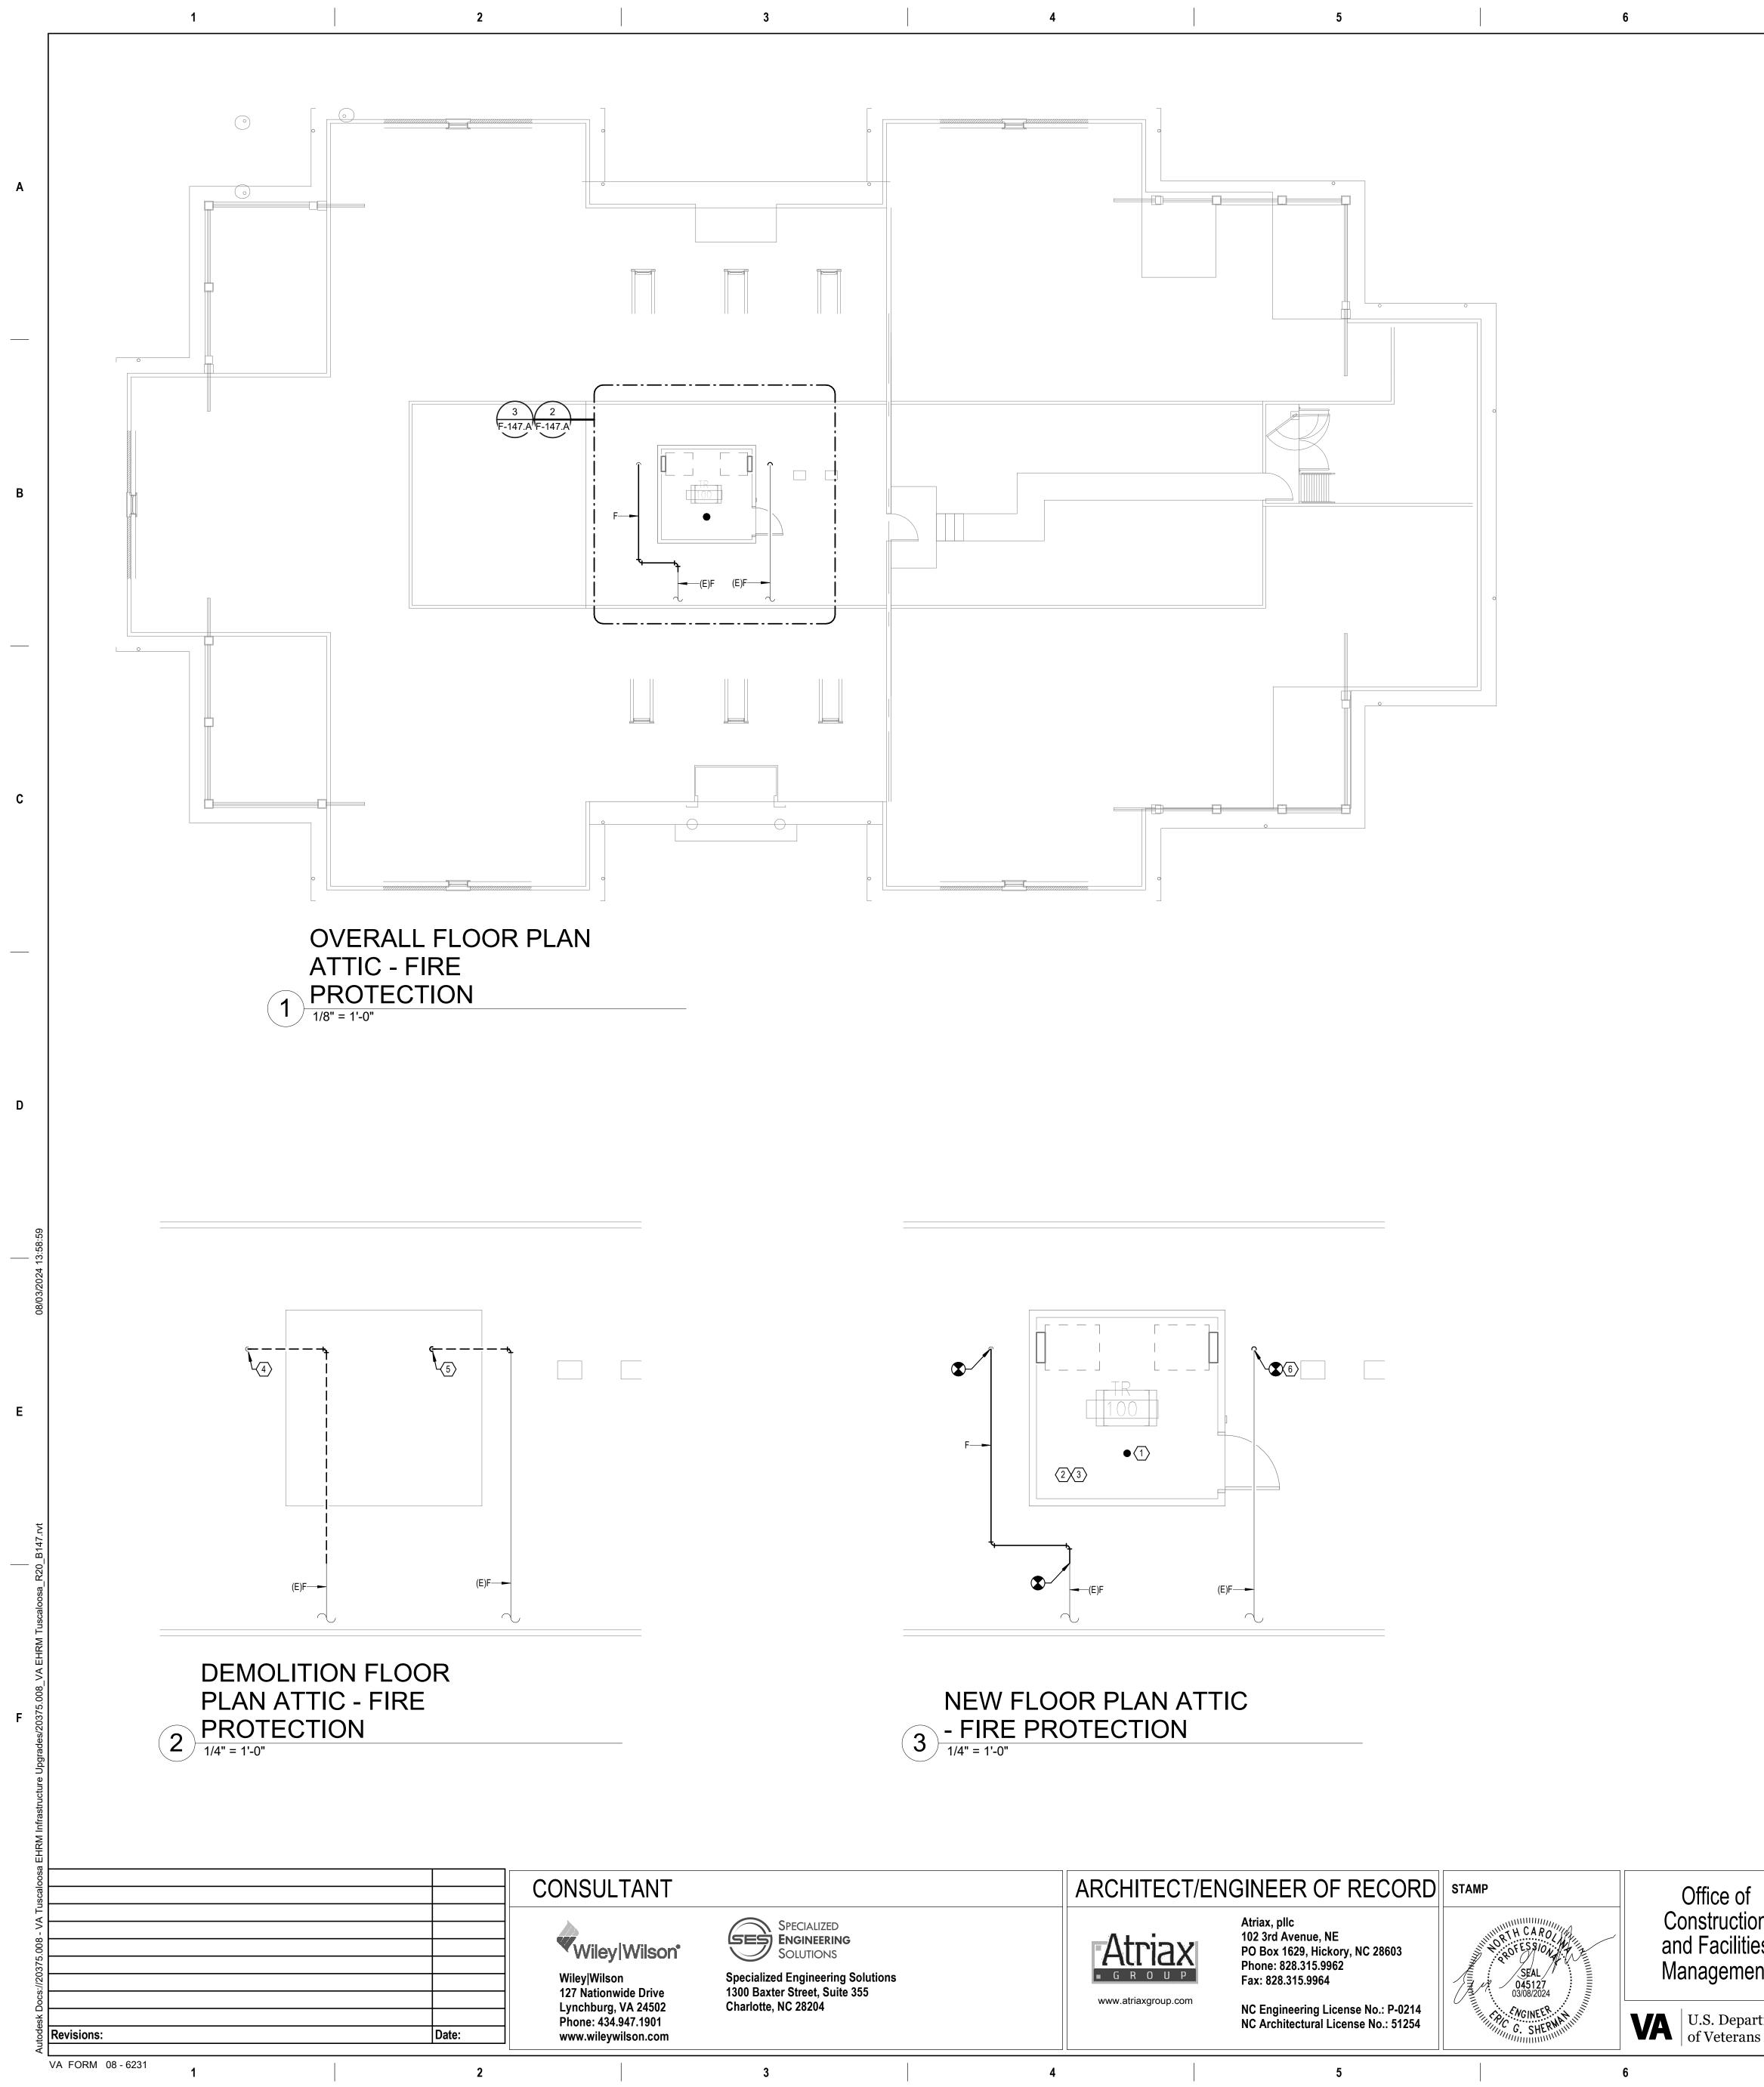
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	Z TRUE
UCTURE UPGRADES	Project Number 679-20-104
	Building Number 146
IC, TUSCALOOSA, AL.	Drawing Number
Checked Drawn JKK PCM	F-146.A



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### **GENERAL NOTES:**

- A. COVER SHEET GENERAL NOTES APPLY TO ALL SHEETS.
- PLANS, NEW MECHANICAL SYSTEMS ARE INDICATED WITH HEAVY LINE WEIGHTS.
- D. THE OWNER AND ENGINEER ARE NOT RESPONSIBLE FOR THE CONTRACTOR'S SAFETY PRECAUTIONS OR FOR THE MEANS, METHODS, TECHNIQUES, CONSTRUCTION SEQUENCES, OR PROCEDURES REQUIRED TO PERFORM THIS WORK.

### SHEET NOTES:

- REQUIREMENTS. SPRINKLER SHALL BE SERVED FROM SPRINKLER PIPING ABOVE. 2. SPRINKLER PIPING SHALL NOT BE ROUTED ABOVE EQUIPMENT RACKS OR ELECTRICAL PANELS.
- PLANS.
- REMAIN FOR RECONNECTION TO NEW SPRINKLER PIPING.
- EXISTING SPRINKLER HEADS.

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nent	Approved:				Location TUSCALOOSA V	AMC, TUSCAL
partment rans Affairs	3		FULLY SPRINK	KLERED	Issue Date 03/08/2024	Checked JKK
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B. ON DEMOLITION PLANS; EXISTING MECHANICAL SYSTEMS TO BE REMOVED ARE SHOWN HATCHED AND/OR DASHED, EXISTING MECHANICAL SYSTEMS TO REMAIN ARE SHOWN LIGHT LINE WEIGHT. ON ALL OTHER C. UNLESS NOTED OTHERWISE, DETAILS SHOWN WITHIN THESE DOCUMENTS ARE APPLICABLE FOR ALL PIPING, EQUIPMENT AND DUCTWORK INSTALLATIONS WHETHER OR NOT SPECIFICALLY NOTED.

1. INSTALL NEW UPRIGHT SPRINKLER HEADS WITH MECHANICAL GUARDS TO SERVE 100. VERIFY COVERAGE

3. AREA OF EXISTING SPRINKLER COVERAGE. HAZARD CLASSIFICATION "LIGHT HAZARD". RELOCATE AND/OR ADD ADDITIONAL HEADS AND PIPING TO MEET COVERAGE REQUIREMENTS PER NFPA 13 AND VA REQUIREMENTS. COORDINATE HEAD LOCATIONS WITH EXISTING CONDITIONS AND ARCHITECT'S CEILING

4. DEMOLISH SPRINKLER HEAD IN CEILING BELOW AND ASSOCIATED SPRINKLER PIPING TO POINT INDICATED. 5. DEMOLISH SPRINKLER PIPING WHERE INDICATED. EXISTING SPRINKLER HEAD IN CEILING BELOW SHALL

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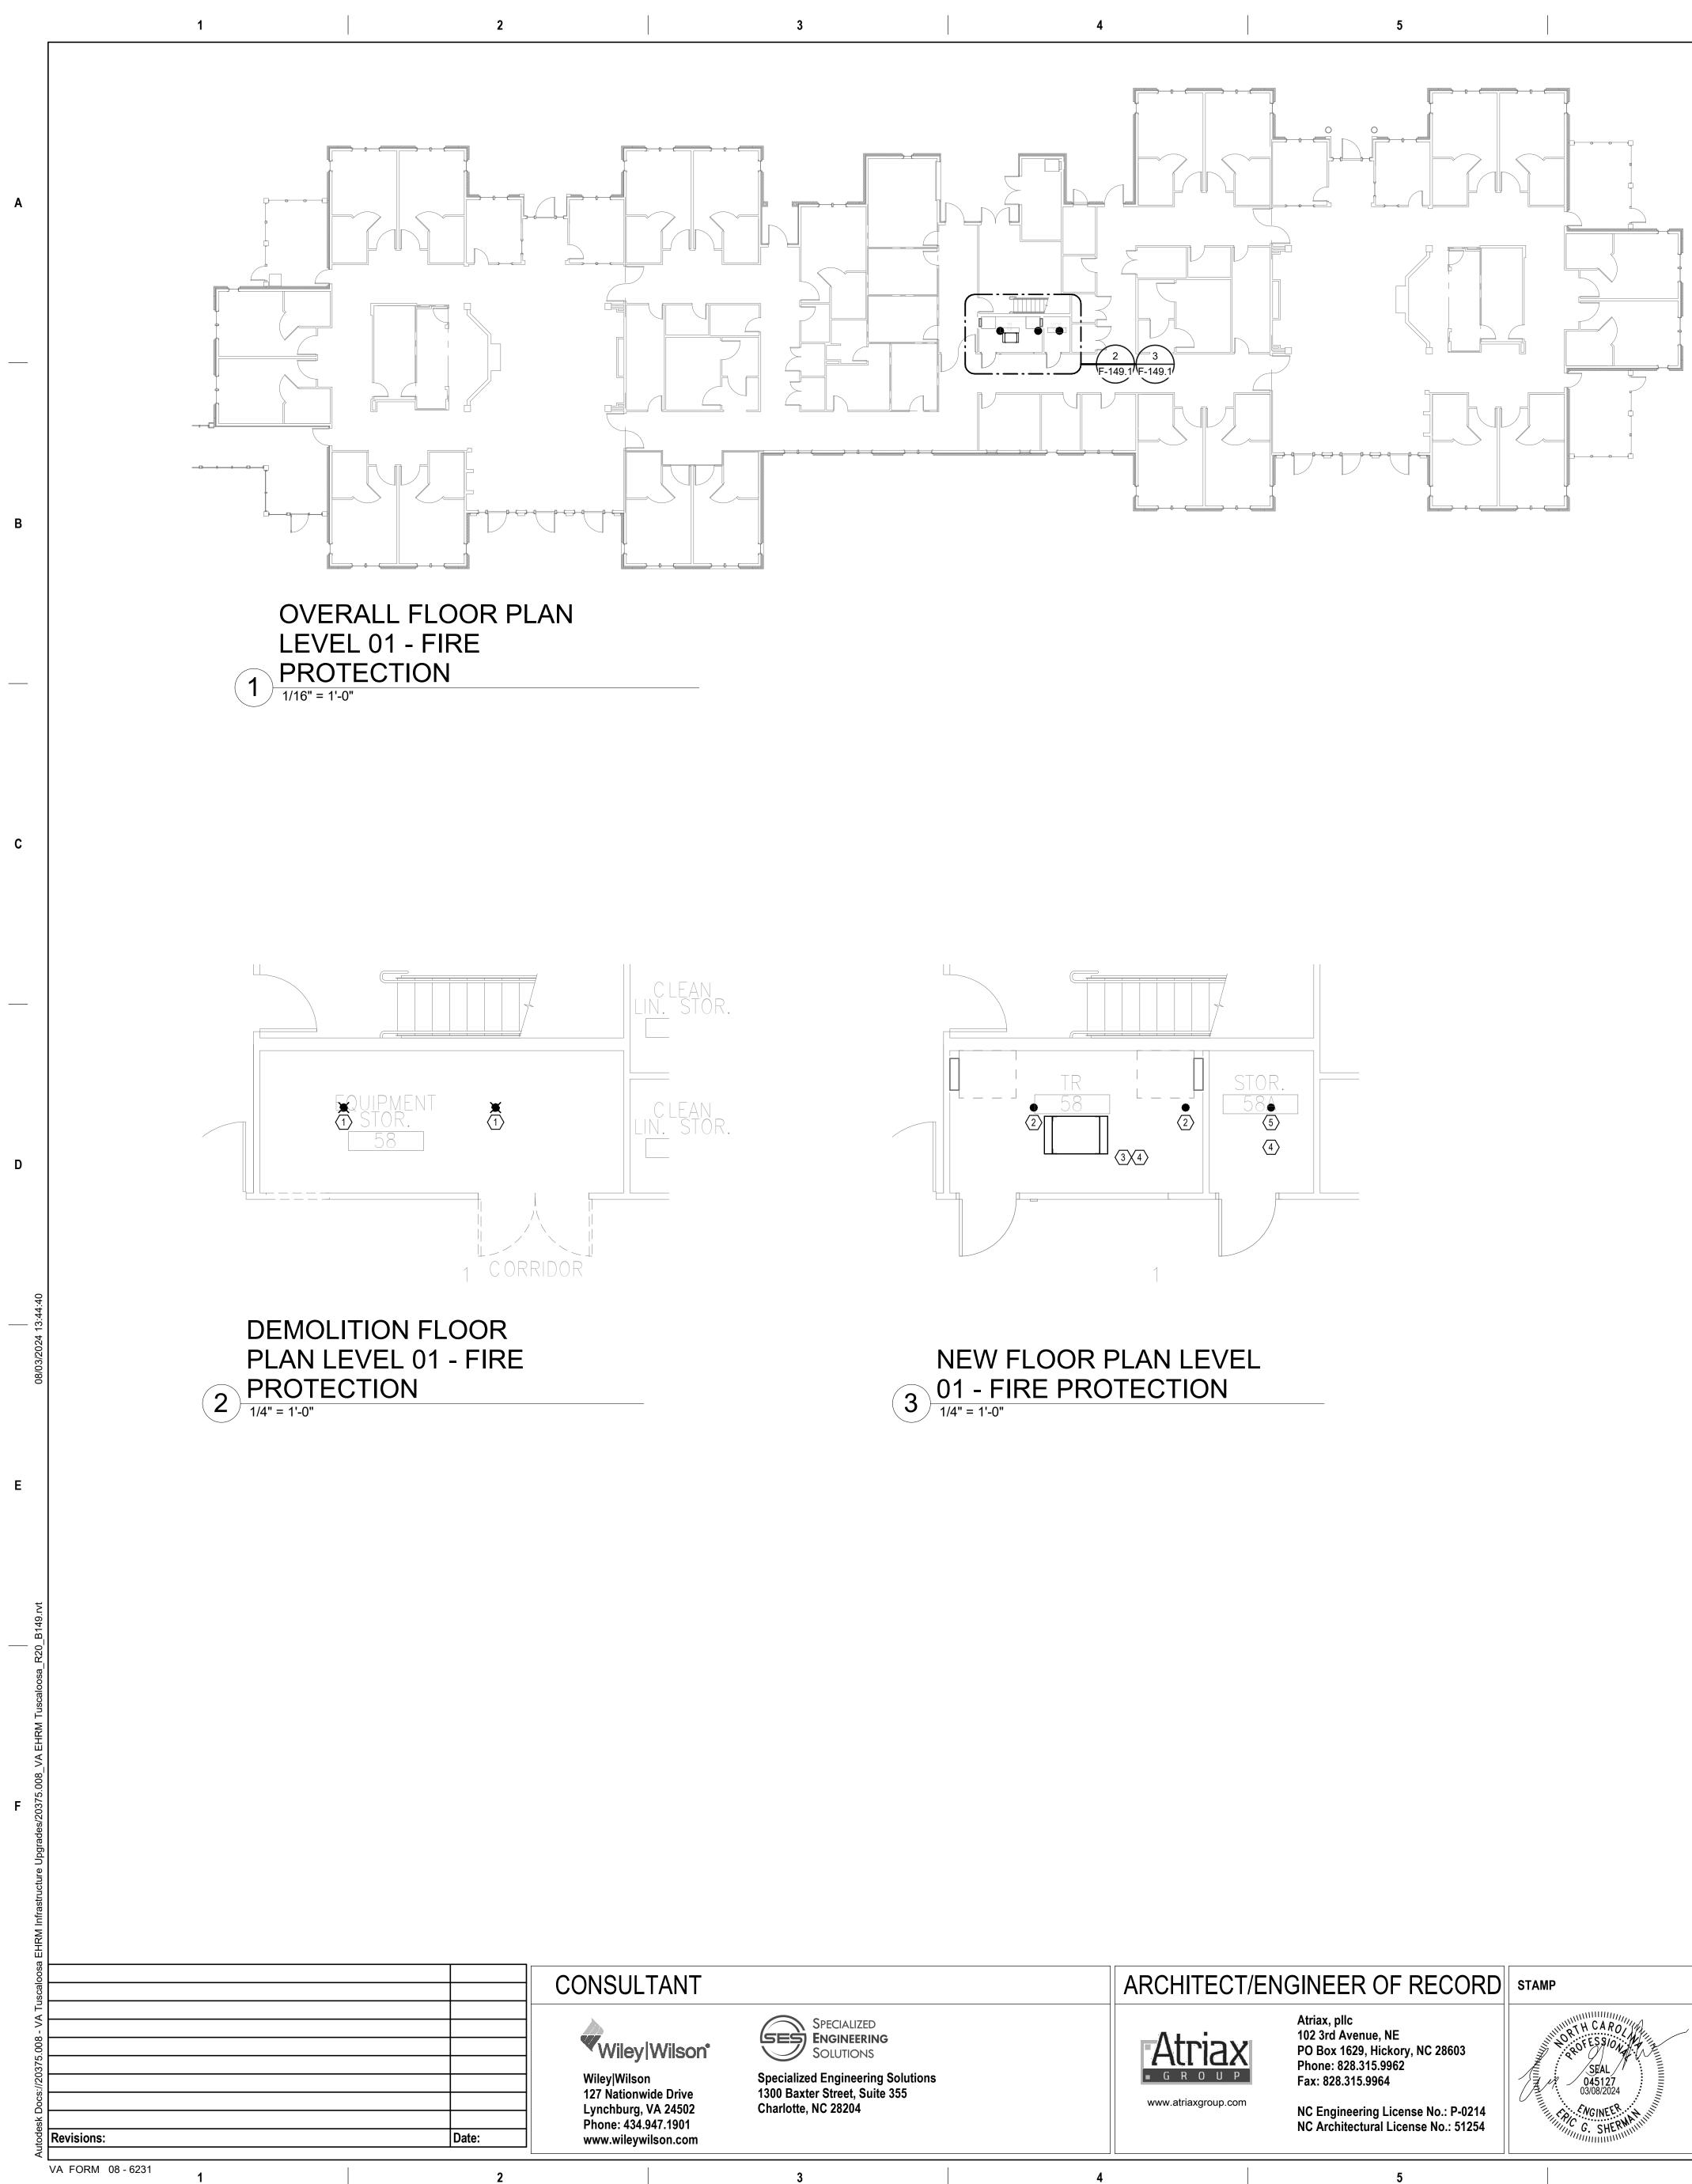
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6. INSTALL NEW SPRINKLER HEAD IN CEILING BELOW. SPRINKLER HEAD TYPE AND STYLE SHALL MATCH

	TRUE
UCTURE UPGRADES	Project Number 679-20-104
	Building Number 147
IC, TUSCALOOSA, AL.	Drawing Number
Checked Drawn JKK PCM	F-147.A



Office of Construction and Facilities Management

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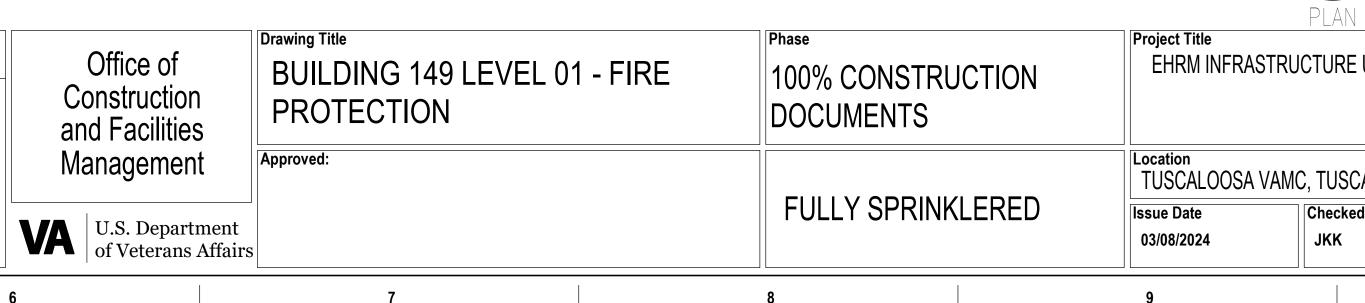
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### **GENERAL NOTES:**

- A. COVER SHEET GENERAL NOTES APPLY TO ALL SHEETS.
- PLANS, NEW MECHANICAL SYSTEMS ARE INDICATED WITH HEAVY LINE WEIGHTS.
- PERFORM THIS WORK.

### SHEET NOTES:

- OUTAGE IN THE ROOM.
- SHALL OCCUR AT THE SAME TIME TO AVOID A SPRINKLER OUTAGE IN THE ROOM. 3. SPRINKLER PIPING SHALL NOT BE ROUTED ABOVE EQUIPMENT RACKS OR ELECTRICAL PANELS.
- PLANS.
- THE SAME TIME TO AVOID A SPRINKLER OUTAGE IN THE ROOM.



B. ON DEMOLITION PLANS; EXISTING MECHANICAL SYSTEMS TO BE REMOVED ARE SHOWN HATCHED AND/OR DASHED, EXISTING MECHANICAL SYSTEMS TO REMAIN ARE SHOWN LIGHT LINE WEIGHT. ON ALL OTHER C. UNLESS NOTED OTHERWISE, DETAILS SHOWN WITHIN THESE DOCUMENTS ARE APPLICABLE FOR ALL PIPING, EQUIPMENT AND DUCTWORK INSTALLATIONS WHETHER OR NOT SPECIFICALLY NOTED. D. THE OWNER AND ENGINEER ARE NOT RESPONSIBLE FOR THE CONTRACTOR'S SAFETY PRECAUTIONS OR FOR THE MEANS, METHODS, TECHNIQUES, CONSTRUCTION SEQUENCES, OR PROCEDURES REQUIRED TO

1. REMOVE EXISTING SPRINKLER HEAD FOR CEILING REMOVAL. REPLACEMENT FOR THE EXISTING PENDENT SPRINKLER WITH NEW UPRIGHT SPRINKLER SHALL OCCUR AT THE SAME TIME TO AVOID A SPRINKLER

2. INSTALL NEW UPRIGHT SPRINKLER HEADS WITH MECHANICAL GUARDS TO SERVE 58. VERIFY COVERAGE REQUIREMENTS. REPLACEMENT OF THE EXISTING PENDENT SPRINKLER WITH NEW UPRIGHT SPRINKLER

4. AREA OF EXISTING SPRINKLER COVERAGE. HAZARD CLASSIFICATION "LIGHT HAZARD". RELOCATE AND/OR ADD ADDITIONAL HEADS AND PIPING TO MEET COVERAGE REQUIREMENTS PER NFPA 13 AND VA REQUIREMENTS. COORDINATE HEAD LOCATIONS WITH EXISTING CONDITIONS AND ARCHITECT'S CEILING

5. INSTALL NEW PENDANT SPRINKLER HEADS TO SERVE 58A. VERIFY COVERAGE REQUIREMENTS. REPLACEMENT OF THE EXISTING PENDENT SPRINKLER WITH NEW PENDANT SPRINKLER SHALL OCCUR AT

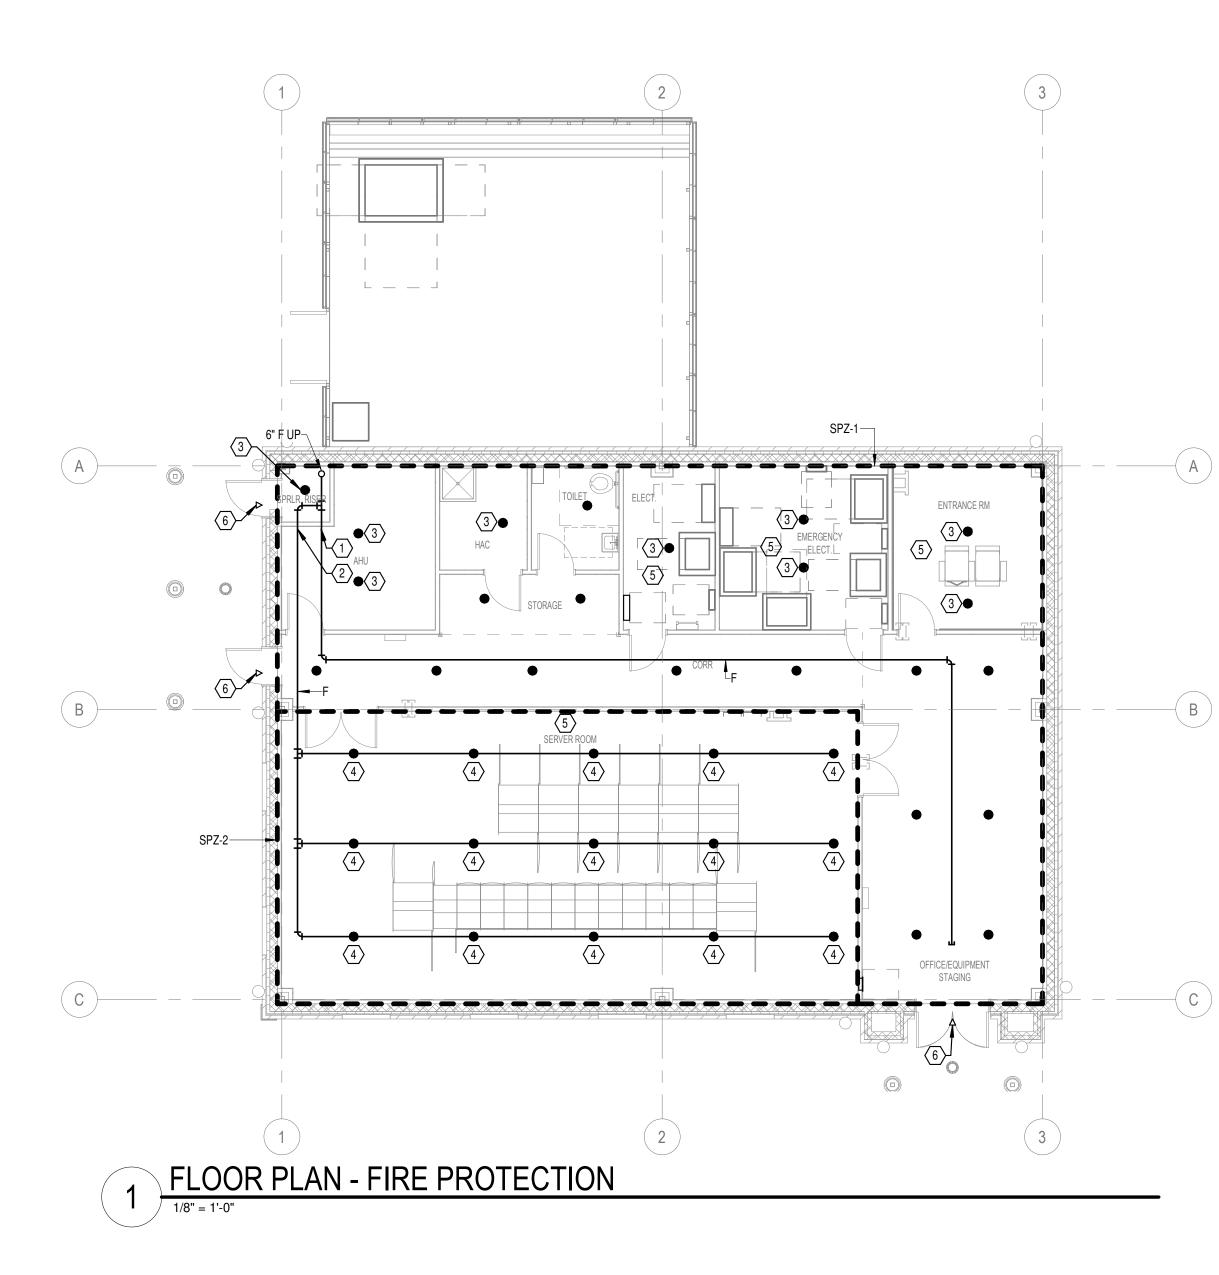
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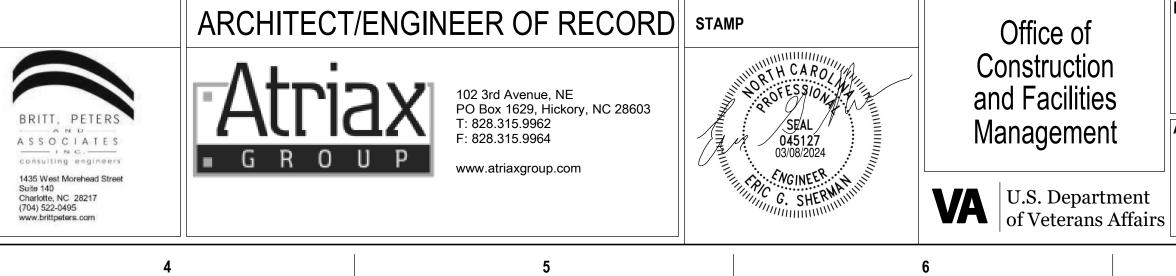
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				Deter	Lynchburg, VA 24502 Phone: 434.947.1901 www.wileywilson.com	Charlotte, NC 2
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### **GENERAL NOTES:**

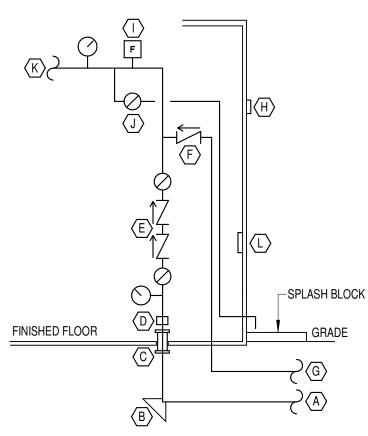
- A. UNLESS NOTED OTHERWISE DETAILS SHOWN V PIPING, EQUIPMENT, AND FIXTURE INSTALLATIC B. THE OWNER AND ENGINEER ARE NOT RESPON-FOR THE MEANS AND METHODS, TECHNIQUES,
- TO PERFORM THIS WORK.
- C. THE FIRE PROTECTION CONTRACTOR SHALL P TO ANY SHUTDOWNS FOR APPROVAL.
- D. LIGHT HAZARD DESIGN EXCEPT AS NOTED WITH ROOMS.
- E. ALL SPRINKLER HEADS SHALL BE FM AND UL AF SPRINKLER HEADS, UNLESS NOTED OTHERWIS

### SHEET NOTES:

- 1. INSTALL TAMPER AND FLOW SWITCH TO SERVI 2. INSTALL TAMPER AND FLOW SWITCH TO SERV
- INSTALL UPRIGHT, QUICK RESPONSE SPRINKLE REQUIREMENTS.
- 4. INSTALL UPRIGHT, ORDINARY RESPONSE SPRI ROOM. VERIFY COVERAGE REQUIREMENTS.
- 5. SPRINKLER PIPING SHALL NOT BE ROUTED ABO
- 6. INSTALL EXTENDED COVERAGE DRY HORIZON

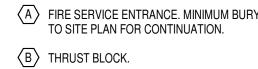
### NOTES:

SPRINKLER SYSTEM PROTECTION AREAS: SPZ-1 SPRINKLER ZONE 1 - LIGHT/ORDINARY HAZ SPZ-2 SPRINKLER ZONE 2 - LIGHT/ORDINARY HAZ



2 FIRE SPRINKLER RISER NO SCALE

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- C INSTALL MECHANICAL SEAL AT ALL BELO D PIPE ANCHOR AND FIRE SERVICE FLANG
- E SUPERVISED BACKFLOW PREVENTER.
- F FIRE DEPARTMENT CONNECTION CHECK
- G TO FIRE DEPARTMENT CONNECTION. REF
- H ELECTRIC ALARM BELL. CONTRACTOR SH INDICATOR DEVICES.

- $\langle I \rangle$  FLOW INDICATOR.
- $\square$  SPLASH BLOCK  $\langle J \rangle$  INSPECTOR TEST CONNECTION DRAIN PL K WET PIPE SPRINKLER MAIN, REFER TO FI
  - L SPRINKLER HEAD CABINET.
  - <u>NOTES:</u> 1. FINAL PIPE SIZES ARE TO BE DETERMINEI DESIGNER AND VERIFIED BY HYDRAULIC (

SCALE Drawing Title Project Title Phase FLOOR PLAN - FIRE PROTECTION 100% CONSTRUCTION DOCUMENTS Approved: Location TUSCALOOSA VAMC, TUSC FULLY SPRINKLERED Issue Date

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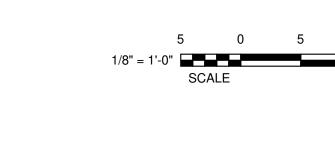
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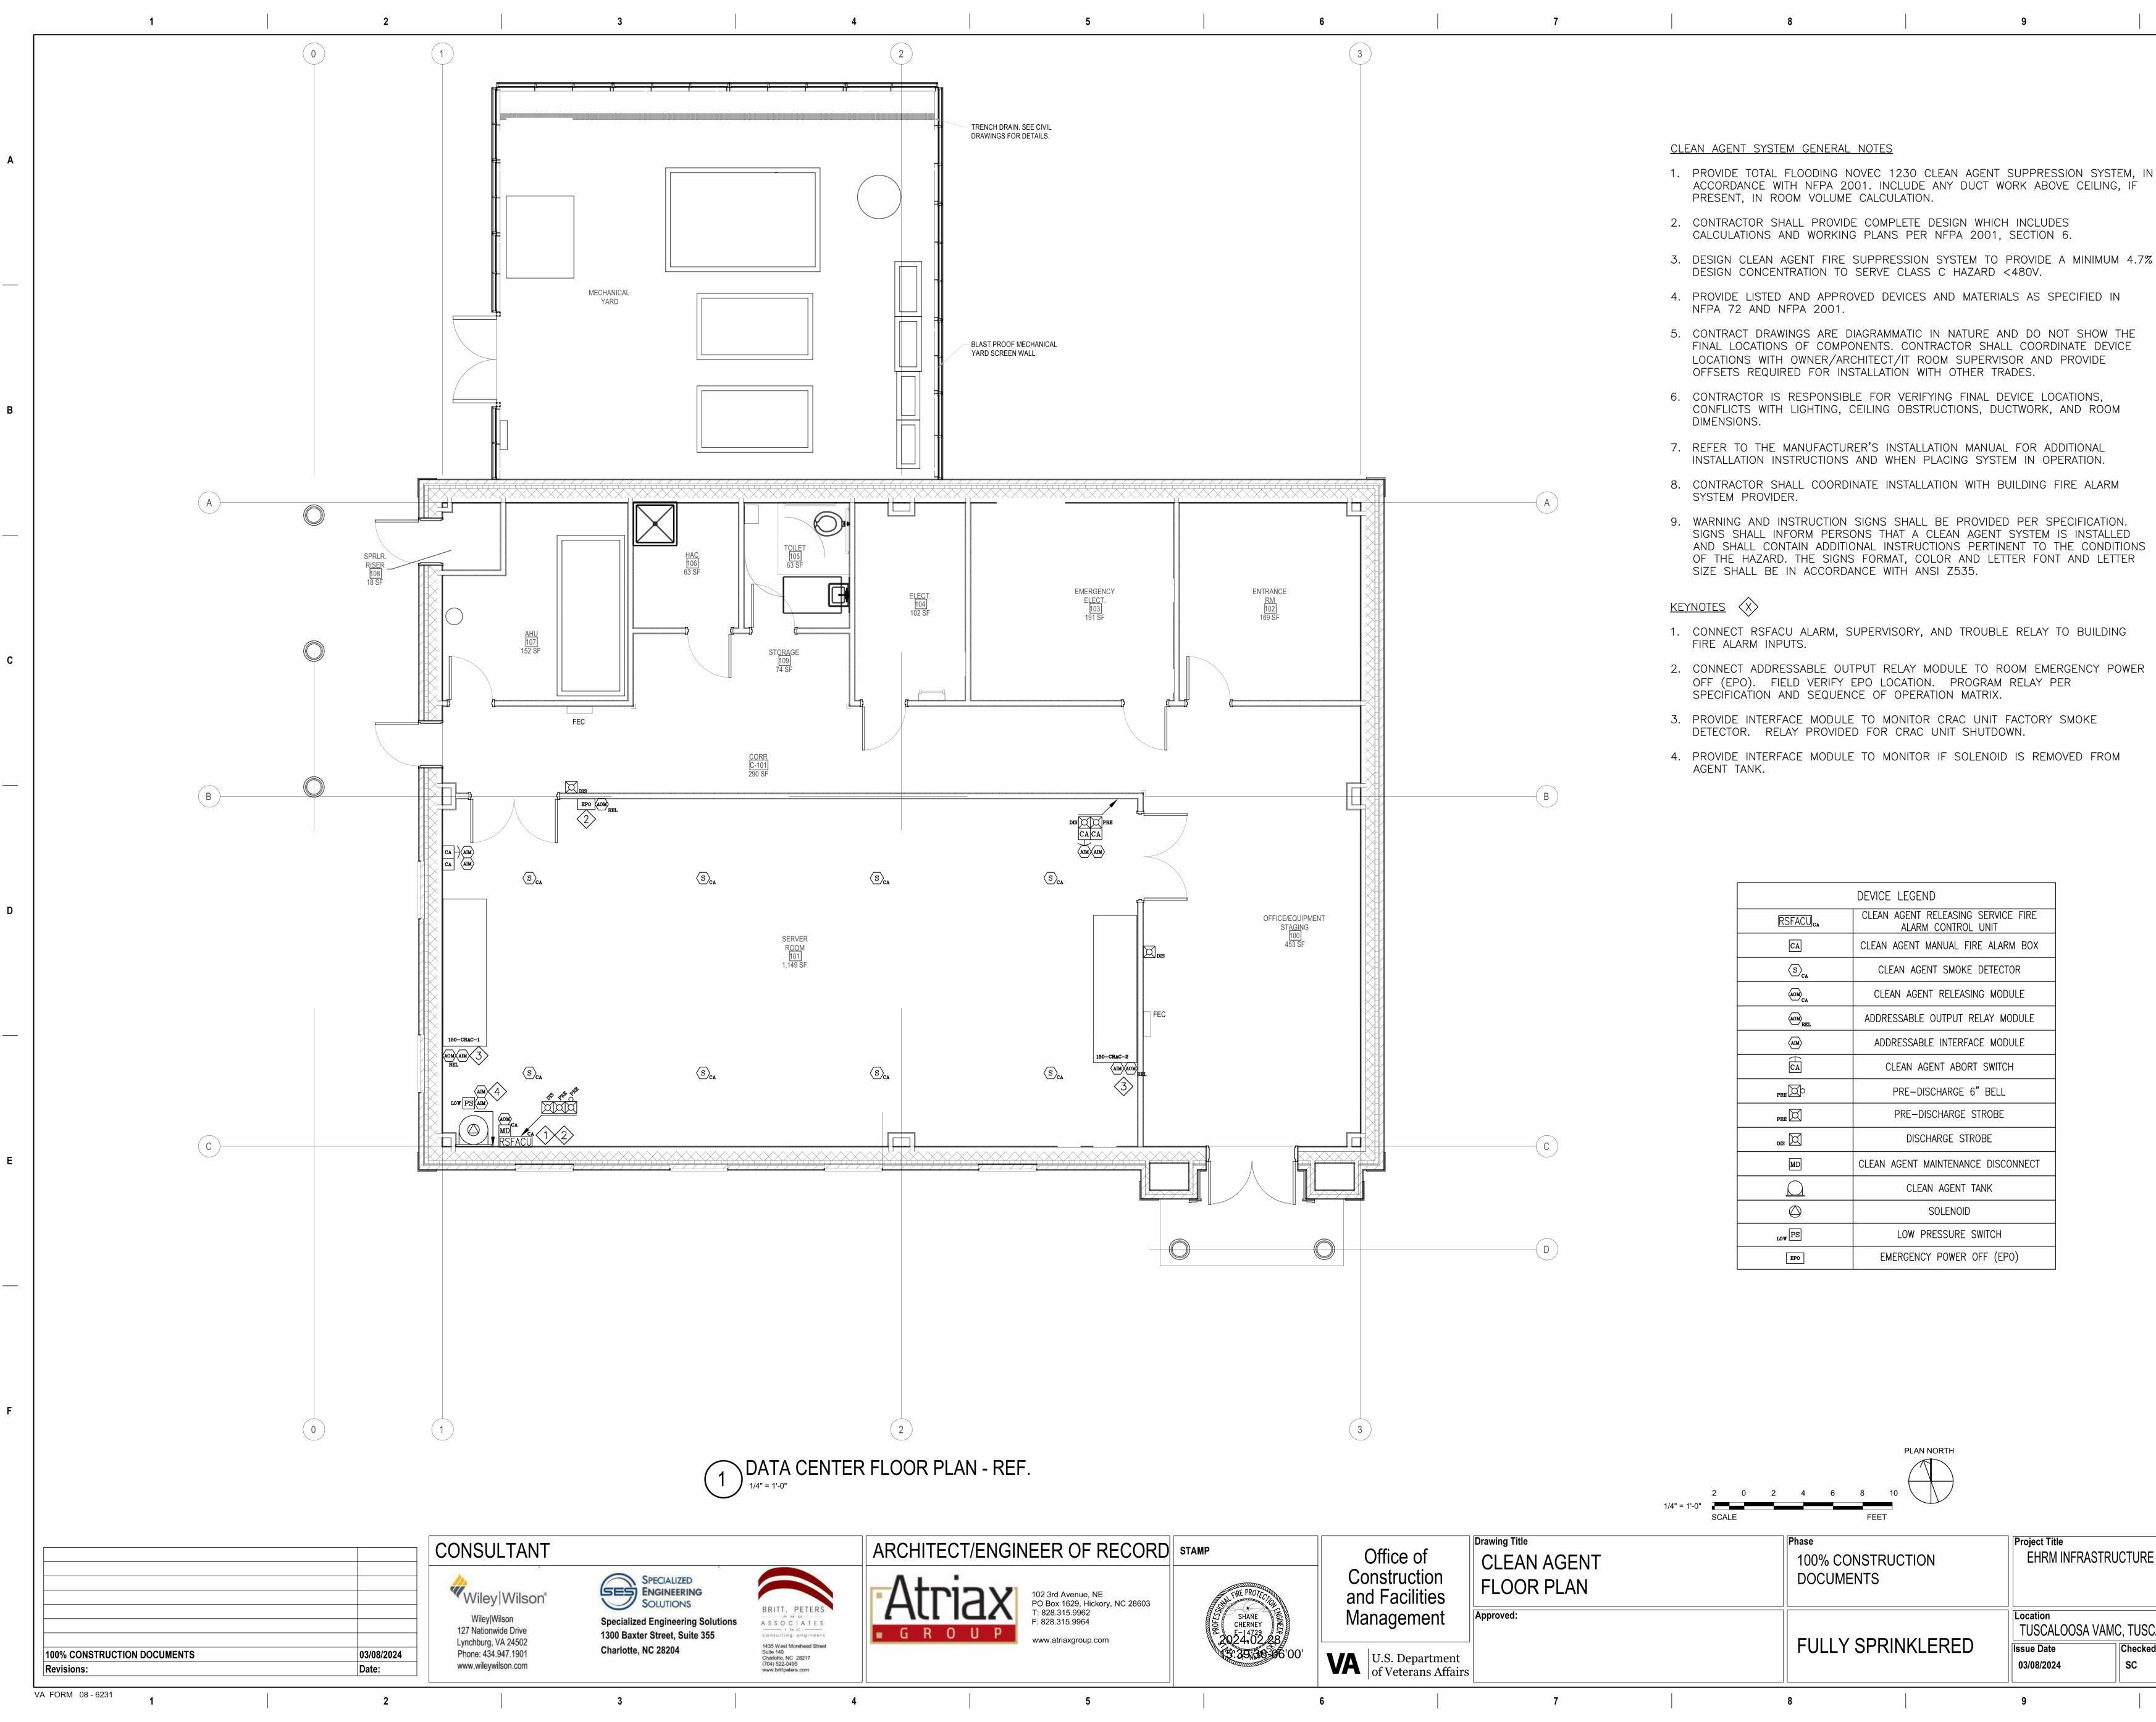
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EHRM INFRASTRUCTURE



AILS SHOWN WITHIN THESE DOCUMENTS ARI E INSTALLATIONS WHETHER OR NOT SPECIFI	CALLY NOTED.	
NOT RESPONSIBLE FOR THE CONTRACTOR'S TECHNIQUES, CONSTRUCTION SEQUENCES,		
CTOR SHALL PROVIDE WRITTEN NOTIFICATION		A
AS NOTED WITH ALL ORDINARY HAZARD GROU		
ED OTHERWISE.		
TCH TO SERVE SPZ-1.		
TCH TO SERVE SPZ-2. NSE SPRINKLER HEADS WITH PROTECTIVE C/	AGES. VERIFY COVERAGE	
SPONSE SPRINKLER HEADS WITH MECHANIC/ IREMENTS.	AL GUARDS TO SERVE SERVER	
E ROUTED ABOVE EQUIPMENT RACKS OR ELE		
DRY HORIZONTAL SIDEWALL SPRINKLER HEAE	).	
		В
REAS: RDINARY HAZARD - 1,640 SQ. FT.		
RDINARY HAZARD - 1,152 SQ. FT.		
MINIMUM BURY DEPTH 60 INCHES BELOW GR/	ADE. REFER	
UATION.		
L AT ALL BELOW GRADE PIPE PENETRATIONS. RVICE FLANGE.		
REVENTER. CTION CHECK VALVE.		С
INECTION. REFER TO CIVIL DRAWINGS FOR		
NTRACTOR SHALL PROVIDE WIRING FROM BE	ELL TO FLOW	
TION DRAIN PIPING, ROUTE TO BUILDING EXTE I, REFER TO FLOOR PLANS FOR CONTINUATIO		
E DETERMINED BY THE FIRE PROTECTION SY	STEM	
Y HYDRAULIC CALCULATION.		
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5 10 15 20	PLAN NORTH	
5 10 15 20		
UCTURE UPGRADES	Project Number 679-20-104	
	Building Number	
	B151 Drawing Number	
IC, TUSCALOOSA, AL.	F-151.1	
AGT PCM		



- 3. DESIGN CLEAN AGENT FIRE SUPPRESSION SYSTEM TO PROVIDE A MINIMUM 4.7%

- AND SHALL CONTAIN ADDITIONAL INSTRUCTIONS PERTINENT TO THE CONDITIONS

	DEVICE LEGEND
RSFACU <sub>CA</sub>	CLEAN AGENT RELEASING SERVICE FIRE ALARM CONTROL UNIT
CA	CLEAN AGENT MANUAL FIRE ALARM BOX
	CLEAN AGENT SMOKE DETECTOR
(AOM) CA	CLEAN AGENT RELEASING MODULE
	ADDRESSABLE OUTPUT RELAY MODULE
AIM	ADDRESSABLE INTERFACE MODULE
CA	CLEAN AGENT ABORT SWITCH
PRE	PRE-DISCHARGE 6" BELL
PRE	PRE-DISCHARGE STROBE
dis 🖂	DISCHARGE STROBE
MD	CLEAN AGENT MAINTENANCE DISCONNECT
Ω	CLEAN AGENT TANK
$\bigcirc$	SOLENOID
LOW PS	LOW PRESSURE SWITCH
EPO	EMERGENCY POWER OFF (EPO)

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E UPGRADES CALOOSA, AL. d Drawn TD	Project Number 679-20-104 Building Number B151 Drawing Number F-151.2	

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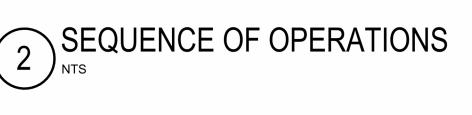
ROL PANEL NCIATION	OUTPUTS
	1       SMOKE DETECTOR-INITIAL ALARM         2       SMOKE DETECTOR-SECOND ALARM         3       20 OR 30 SECOND AGENT RELEASE TIME DELAY EXPIRES         4       CLEAN AGENT MANUAL ALARM BOX ACTIVATED         5       CRAC UNIT DUCT DETECTOR ACTIVATION         6       SYSTEM BYPASS ACTUATED         7       REMOVAL OF TANK SOLENOID         8       ABORT SWITCH ACTIVATED         9       TANK LOW PRESSURE ACTIVATED

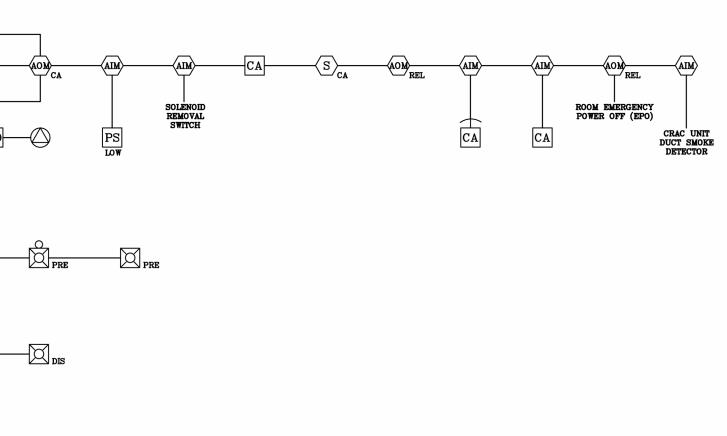
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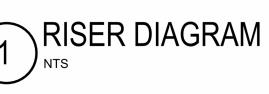
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CLEAN AGENT SYSTEM GENERAL NOTES

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1. PROVIDE TOTAL FLOODING NOVEC 1230 CLEAN AGENT SUPPRESSION SYSTEM, IN ACCORDANCE WITH NFPA 2001. INCLUDE ANY DUCT WORK ABOVE CEILING, IF PRESENT, IN ROOM VOLUME CALCULATION.

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- 2. CONTRACTOR SHALL PROVIDE COMPLETE DESIGN WHICH INCLUDES CALCULATIONS AND WORKING PLANS PER NFPA 2001, SECTION 6.
- 3. DESIGN CLEAN AGENT FIRE SUPPRESSION SYSTEM TO PROVIDE A MINIMUM 4.7% DESIGN CONCENTRATION TO SERVE CLASS C HAZARD <480V.
- 4. PROVIDE LISTED AND APPROVED DEVICES AND MATERIALS AS SPECIFIED IN NFPA 72 AND NFPA 2001.
- 5. CONTRACT DRAWINGS ARE DIAGRAMMATIC IN NATURE AND DO NOT SHOW THE FINAL LOCATIONS OF COMPONENTS. CONTRACTOR SHALL COORDINATE DEVICE LOCATIONS WITH OWNER/ARCHITECT/IT ROOM SUPERVISOR AND PROVIDE OFFSETS REQUIRED FOR INSTALLATION WITH OTHER TRADES.
- 6. CONTRACTOR IS RESPONSIBLE FOR VERIFYING FINAL DEVICE LOCATIONS, CONFLICTS WITH LIGHTING, CEILING OBSTRUCTIONS, DUCTWORK, AND ROOM DIMENSIONS.
- 7. REFER TO THE MANUFACTURER'S INSTALLATION MANUAL FOR ADDITIONAL INSTALLATION INSTRUCTIONS AND WHEN PLACING SYSTEM IN OPERATION.
- 8. CONTRACTOR SHALL COORDINATE INSTALLATION WITH BUILDING FIRE ALARM SYSTEM PROVIDER.
- 9. WARNING AND INSTRUCTION SIGNS SHALL BE PROVIDED PER SPECIFICATION. SIGNS SHALL INFORM PERSONS THAT A CLEAN AGENT SYSTEM IS INSTALLED AND SHALL CONTAIN ADDITIONAL INSTRUCTIONS PERTINENT TO THE CONDITIONS OF THE HAZARD. THE SIGNS FORMAT, COLOR AND LETTER FONT AND LETTER SIZE SHALL BE IN ACCORDANCE WITH ANSI Z535.

of tion ities	Drawing Title CLEAN AGENT NOTES, AND RISER DIAGRAM	Phase 100% CONSTRUC DOCUMENTS	TION	Project Title EHRM INFRASTRU	CTURE
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