


TALLAPOOSA CO E911 ADDITION TO THE TALLAPOOSA COUNTY JAIL FACILITY

DADEVILLE, AL.

PRINTED: 1/8/2026 @ 9:07AM

ABBREVIATIONS		VICINITY MAP		GENERAL NOTES		INDEX OF DRAWINGS			
A.B.	ANCHOR BOLT	F	FASTENER	P	PARALLEL PARTICLE BOARD PCC. PE PERI PKG PLATE PLASTIC LAMINATE PLAS. PNL PAINT P.TILE PAP PREFABRICATED PSE PSI PTN P.T. PV PVC PVMT PWD P.V. P.W.D. P.V.F.	1. DRAWINGS AND SPECIFICATIONS OF ALL DISCIPLINES INCLUDED HEREIN ARE GRAPHIC AND TEXT REPRESENTATIONS INTENDED TO ESTABLISH THE FULL SCOPE OF THIS PROJECT AND THE FULL CONTRACTUAL OBLIGATION OF THE GENERAL CONTRACTOR TO COMPLETE THE WORK SHOWN, IMPLIED, AND SPECIFIED. IT SHALL BE THE GENERAL CONTRACTOR'S ULTIMATE RESPONSIBILITY TO COORDINATE THE PROPOSALS AND WORK OF ALL TRADES TO ENSURE ALL MATERIALS AND WORK REQUIRED BY THE CONTRACT DOCUMENTS ARE INCLUDED IN THE GENERAL CONTRACTOR'S PROPOSAL AND ARE ULTIMATELY FURNISHED AND INSTALLED IN THE FINISHED PRODUCT, WHETHER EXPLICIT OR IMPLIED BY THESE DOCUMENTS. 2. THE FOLLOWING PRIORITIES ARE ESTABLISHED WITH REFERENCE TO DISCIPLINE COORDINATION A. ALL PLUMBING WORK AND INSTALLATION SHALL BE COORDINATED FULLY TO ALLEVIATE CONFLICTS. B. NO TRADE WILL TAKE UNNECESSARY ADVANTAGE OF AVAILABLE PLENUM SPACE OVER OTHER TRADES. RELOCATION OF ANY ITEMS VIOLATING THIS PRINCIPLE SHALL BE AT THE TRADES' EXPENSE. C. ALL STRUCTURAL DESIGN & DETAILING SHALL GOVERN OVER ARCHITECTURAL GRAPHIC REPRESENTATION WHERE APPLICABLE. D. ALL CIVIL DESIGN & DETAILING SHALL GOVERN OVER ARCHITECTURAL REPRESENTATION WHERE APPLICABLE. 3. CONTRACTOR IS RESPONSIBLE FOR OBTAINING ALL NECESSARY PERMITS FOR CONSTRUCTION ON THIS SITE. IF PROBLEMS ARE ENCOUNTERED WHILE ATTEMPTING TO OBTAIN PERMITS, THE ARCHITECT SHALL BE NOTIFIED IMMEDIATELY AND WILL ASSIST AS NECESSARY. 4. IT SHALL BE THE RESPONSIBILITY OF THE CONTRACTOR TO BECOME FAMILIAR WITH THE CONTRACT DOCUMENTS APPLICABLE TO THIS PROJECT PRIOR TO CONSTRUCTION. THE DRAWINGS AND SPECIFICATIONS ARE COMPLIMENTARY AND BOTH DOCUMENTS SHALL BE BINDING. 5. THE CONTRACTOR IS TO MAINTAIN A COMPLETE SET OF AS-BUILT DRAWINGS AT THE JOB SITE. AS-BUILTS SHALL BE AVAILABLE FOR FIELD OBSERVATION BY THE ARCHITECT OR ENGINEER. 6. THESE DRAWINGS ARE SCHEMATIC IN NATURE AND NOT INTENDED TO SHOW ALL POSSIBLE CONDITIONS, PROCEDURES, OR METHODS OF CONSTRUCTION. IT IS INTENDED THAT A COMPLETE BUILDING ADDITION BE PROVIDED WITH ALL NECESSARY EQUIPMENT APPURTENANCES, AND CONTROLS, COMPLETELY COORDINATED WITH ALL DISCIPLINES. ALL PARAMETERS GIVEN IN THESE DOCUMENTS SHALL BE STRICTLY CONFORMED WITH ANY ITEMS AND LABOR REQUIRED FOR A COMPLETE BUILDING ADDITION IN ACCORDANCE WITH ALL APPLICABLE CODES, STANDARDS, AND THESE CONTRACT DOCUMENTS. ALL ITEMS, SYSTEMS, ETC. OUTLINED HEREIN SHALL BE FURNISHED WITHOUT INCURRING ANY ADDITIONAL COST TO THE CONTRACT. CAREFULLY REVIEW ALL CONTRACT DOCUMENTS AND THE DESIGN OF OTHER TRADES BEFORE PREPARING SHOP DRAWINGS. 7. COORDINATE PIPING WITH STRUCTURAL AND PLUMBING. MAKE OFFSETS AND TRANSITIONS TO COORDINATE WITH OTHER TRADES WITHOUT ADDITIONAL EXPENSE TO THE OWNER. CONTRACTOR SHALL PROVIDE COORDINATION DRAWINGS OF ALL TRADES. SEE SPECS. CONTRACTOR IS SOLELY RESPONSIBLE FOR DE-COORDINATING PATHWAYS AND ROUTING. 8. COORDINATE ALL REVIEWS OF WORK IN PLACE PRIOR TO COMMENCEMENT OF ALL INTERIOR AND EXTERIOR WORK. 9. CONTRACTOR SHALL CHECK AND COORDINATE ALL DIMENSIONS PRIOR TO PROJECT LAYOUT. CONFIRM EXISTING CONDITIONS WILL ACCOMMODATE DIMENSIONAL CRITERIA SHOWN FOR NEW WORK, CONSTRUCTION, AND INSTALLATION. THIS CONFIRMATION WILL BE THE RESPONSIBILITY OF THE GENERAL CONTRACTOR. 10. CONTRACTOR SHALL PROTECT TO THE GREATEST EXTENT POSSIBLE EXISTING BUILDING / SITE CONSTRUCTION, MECHANICAL UNITS, EQUIPMENT, VEHICLES, TREES, SHRUBBERY, PAVING, GRASSED AREAS, ETC. FROM DAMAGE THROUGHOUT THE ENTIRE DURATION OF THE PROJECT. 11. CONTRACTOR IS RESPONSIBLE FOR: MAINTAINING ALL LANDSCAPING ITEMS, MOWING ALL GRASS, PROTECTING ALL DESIGNATED TREES, IRRIGATING GRASS AND LANDSCAPING, ETC. FOR THE ENTIRE SITE TO THE SATISFACTION OF THE OWNER FROM NOTICE TO PROCEED THROUGH FINAL ACCEPTANCE OF THE PROJECT BY THE OWNER.	SEQ. NO.	DWG. NO.	SHEET TITLE
A.B.	ANCHOR BOLT	F	FASTENER	P	PARALLEL PARTICLE BOARD PCC. PE PERI PKG PLATE PLASTIC LAMINATE PLAS. PNL PAINT P.TILE PAP PREFABRICATED PSE PSI PTN P.T. PV PVC PVMT PWD P.V. P.W.D. P.V.F.	1 T1.1		COVER SHEET	
ABV	ABOVE	F.B.	FACE BRICK	P.C.	PRECAST CONCRETE	2 C0.1		EXISTING SITE/ TOPO	
A/C	AIR CONDITIONING	F.B.O.	FURNISHED BY OTHERS	P.E.	PORCELAIN ENAMEL	3 C1.0		SITE PLAN	
ACC	ACCESS	F.E.	FIRE EXTINGUISHER	PED	PEDESTAL (SINK)	4 C1.1		PHOTOS & DETAILS	
ACT.	ACOUSTICAL TILE (CLG)	F.F.	FIXED GLASS	PERI	PERIMETER	5 A1.1		FLOOR PLAN	
AFF	ABOVE FINISH FLOOR	F.G.	FLIERGLASS	PKG	PARKING	6 A1.2		PLAN DETAILS	
A.D.	AREA DRAIN	F.H.	FINISH	PL	PLATE	7 A2.1		FINISH SCHEDULE / INTERIOR ELEVATIONS	
ADH	ADHESIVE	F.L.	FLASHING	P.LAM.	PLASTIC LAMINATE	8 A3.1		DOOR SCHEDULE	
ADJ	ADJUSTABLE	F.LR.	FLOOR	PLAS.	PLASTER	9 A4.1		EXTERIOR ELEVATIONS	
AGG	AGGREGATE	F.LU.	FLUORESCENT	PNL	PANEL	10 A5.1		BUILDING SECTIONS	
A.H.U.	AIR HANDLING UNIT	F.N.	FENCE	PNT	PAINT	11 A6.1		WALL SECTIONS	
ALT	ALTERNATE	F.ND.	FOUNDATION	P.TILE	PORCELAIN TILE	12 A6.2		WALL SECTIONS & DETAILS	
ALUM	ALUMINUM	F.O.	FACE	PAP	PAPER	13 A8.1		REFLECTED CEILING & ROOF PLAN	
A.P.	ACCESS PANEL	F.P.	FACE PROOF	PREFAB.	PREFABRICATED			STRUCTURAL	
APX	APPROXIMATE	F.P.H.	FACE PROOF HOSE BIBB	POUNDS PER SQUARE FOOT	POUNDS PER SQUARE INCH				
ARCH.	ARCHITECTURAL	F.P.H.	FACE	PTN	PARTITION				
ASPH.	ASPHALT	F.R.	FLASHING	P.T.	PRESSURE TREATED				
A.T.	ASPHALT TILE	F.S.	FLOOR	P.V.	PAVED (D) OR PAVING				
AUTO.	AUTOMATIC	F.TG.	FOOTING	PVC	POLYVINYL CHLORIDE (PIPE)				
AVG	AVERAGE	FUR.	FURRED(ING)	PVMT	PAVEMENT				
AWNG	AWNING	F.V.	FIELD VERIFY	PWD	PLYWOOD				
B36	36" WIDE BASE CAB.	G	GAUGE	Q.T.	QUARRY TILE				
BD	BOARD	G.B.	GYPSUM BOARD	R	RISER				
BF	BI-FOLD (DOOR)	G.C.	GENERAL CONTRACTOR	R/A	RETURN AIR				
BIT	BLIND (LUMINOUS)	G.D.	GRADE OR GRADING	R.B.	RUBBER BASE				
BLK	BLOCKING	G.D.O.	GROUND FAULT CIRCUIT INTERRUPTER	RAD.	RADIATOR				
BLK	BLOCK (CMUs)	GFI	GLASS OR GLAZING	RBL	RUBBLE				
BLKG	BLOCKING	GL	GLASS BLOCK	R.D.	ROOF DRAIN				
BM	BEAM	GL.BK.	GLASS BLOCK	REF	REFRIGERATOR				
BP	BENCH MARK	G.I.	GROUT	REQ	REQUIRED				
BRG	BEARING	GT	GROUT	RES	RESILIENT				
BRK	BRICK	H	HIGH	REV	REVISION, REVISED				
B.S.	BRICK SIDES	HB.	HOSE BIBB	REINF	REINFORCED(ING)				
BSMT	BASEMENT	H.C.	HOLLOW CORE	RFG	ROOFING				
BOT	BOTTOM	HD.	HEAD OR HARD	R.J.B.	REINFORCED JUNCTION BOX				
BWN	BETWEEN	H.D.	HEAT DETECTOR OR HEAVY DUTY	RLG	RAILING				
BVL	BEVELLED	HEADER	HEADER	R&M	RANGE W/ MICROWAVE				
B.W.	BOTH WAYS	HDW	HARDWARE	R.O.	ROOF W/ WATER LEADER				
CAB	CABINET	H.M.	HOLLOW METAL	R.O.W.	ROUGH OPENING				
C.B.	CATCH BASIN	HORZ.	HORIZONTAL	ROD	RIGHT OF WAY				
CEM	CERAMIC	H.R.	HORIZONTAL	ROD(S)	ROD AND SHELF(S)				
CF	CUBIC FOOT	H.R.	HORIZONTAL	SC	SOLID CORE				
CHAM	CHAMFER	HS.	HORIZONTAL SLIDER	SCH	SCHEDULE				
CI	CAST IRON	HTG.	HEATING	SD	SMOKE DETECTOR				
C.I.P.	CONCREAT-IN-PLACE CONC.	HVAC	HEATING/VENTILATING/AIR COND.	SEC	SECTION				
CIR	CIRCLE	HWD	HARDWOOD	S.F.	SQUARE FEET				
C.J.	CIRCUMFERENCE	I.B.	IRONING BOARD	S.G.L.	SAFETY GLASS				
CK	CONTROL JOINT	ID.	INSIDE DIAMETER	SG.D.	SLIDING GLASS DOOR				
CL	CALKING (CAULKING)	I.L.	IN LIEU OF	SH.	SINGLE HUNG OR SHELF (DRAWING) SHEET				
CLR	CLEARANCE)	INS.	INSULATED METAL	SHTH.	SHWEATHING				
CLS	CLOSURE OR CLOSER	INT.	INSULATED(ITION)	SIM.	SIMILAR				
CM	CENTIMETER(S)	JST.	INTERIOR	SKL.	SIDEGLIGHT OR SLEEVE				
CMU	CONCRETE MASONRY UNIT	JT.	JOINT	SNT.	SEALANT				
C.O.	CASED OPENING	KD.	KNOCKDOWN	SPC.	SPACER				
COL	COMBINATION	KO.	KNOCKOUT	SPC.	SPECIFICATIONS				
COMB	COMBINATION	KPL.	KICKPLATE	SPK.	SPEAKER				
COND	CONDENSER (AC)	KS.	KNEE SPACE	S.S.T.	STAINLESS STEEL				
CONST	CONSTRUCTION	LAM.	LAMINATE(D)	STD.	STANDARD				
CONT	CONTINUOUS	LAV.	LAVATORY	STOR.	STORAGE				
CONTR	CONTRACTOR	L.B.O.	LOCATION BY OTHERS	STL.	STEEL				
CORR	CORRUGATED	LIV.	LIVING	STR.	STRUCTURAL				
CPR	COPPER	LL.	LIVE LOAD	SQ.	SQUARE				
C.R.C.P.T.	CARPET	LP.	LAMINATED PLASTIC	SUS.	SUSPENDED				
CRS	COURSE(S)	LT.	LIGHT	S.W.	SHEAR WALL				
CSMT	CASEMENT	L.T.	LAUNDRY TUB	T.	TREAD				
C.S.T.	CAST STONE	L.TL.	LINTER	T.B.D.	TOWEL BAR				
C.I.	CERAMIC TILE	LVL.	VENNER LUMBER	T.B.D.	TO BE DETERMINED				
CTR	CENTER OR COUNTER	LVR.	LOUVER	T.C.J.	TOE-PA COTTA				
CX	CONNECTION	M	METER(S)	TEMP.	TRI-WEVED CONTROL JOINT				
CY	CUBIC YARD	MAX.	MAXIMUM	T.O.C.	TEMPERED (GLASS)				
D	12'D	MAS.	MASONRY	T.O.F.	TONGUE & GROOVE				
DBL	DRYER, OR DRAIN	MATL.	MATERIAL	T.O.M.	TEL				
DECO	DOUBLE	MC.	MEDICINE CABINET	T.O.W.	THICKNESS				
DEM	DECORATIVE	MECH.	MECHANICAL	TR.	THICKNESS				
DET	DETACHMENT	M.F.	MANUFACTURER	TP.	TOILET PAPER HOLDER				
DH	DRAINKING FOUNTAIN	M.I.	MANUFACTURE	TV.	TELEVISION				
DIM	DIAMETER	M.I.R.	MINIMUM	TV.	TELEVISION OUTLET				
D.L.	DIAM.	MISC.	MIRROR	TYP.	TELEVISION OUTLET				
DN	DIAMENSION	MOLDING	MISCELLANEOUS	TYP.	TELEVISION OUTLET				
D.P.	DEAD LOAD	MM.	MOLDING	UNF.	UNDERCUT				
DR	DRYER	MMB.	MOULDING	U.N.O.	UNFINISHED				
DW	DRYER MACHINE	M.M.	MARBLE	U.N.O.	UNLESS NOTED OTHERWISE				
DIS	DRYER OUT	M.R.B.	MARBLE	U.N.O.	UNLESS NOTED OTHERWISE				
DIS	DRAWER STACK	MTL.	MARBLE	U.N.O.	UNLESS NOTED OTHERWISE				
D.T.	DRAIN TILE	MT.	MARBLE	U.N.O.	UNLESS NOTED OTHERWISE				
DTL	DETAIL	MULL.	MARBLE	U.N.O.	UNLESS NOTED OTHERWISE				
DW	DISH WASHER	MULL.	MARBLE	U.N.O.	UNLESS NOTED OTHERWISE				
DWG	DRAWING	MULL.	MARBLE	U.N.O.	UNLESS NOTED OTHERWISE				
DWR	DRAWER	MULL.	MARBLE	U.N.O.	UNLESS NOTED OTHERWISE				
E	EACH	N.A.	NOT APPLICABLE	U.N.O.	UNLESS NOTED OTHERWISE				
EB	EYEBROW	N.I.C.	NOT IN CONTRACT	U.N.O.	UNLESS NOTED OTHERWISE				
E.F.	EACH FACE	NOM.	NOT NOMINAL	U.N.O.	UNLESS NOTED OTHERWISE				
EL	EXPANSION JOINT	N.T.S.	NOT TO SCALE	U.N.O.	UNLESS NOTED OTHERWISE				
ELEC	E								

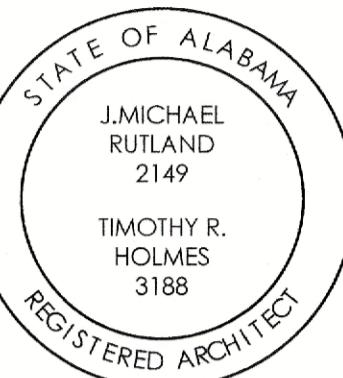

**TALLAPOOSA
CO E911
ADDITION TO
THE
TALLAPOOSA
COUNTY JAIL
FACILITY**

DADEVILLE, AL

**CONSTRUCTION
DOCUMENTS**

Project Number: 25-1465

Date: 8 JANUARY 2026

Revisions:

Sheet Description

**EXISTING SITE
/ TOPO**

Sheet Number

C0.1

LEGEND / ACRONYM


	FENCE
	OVERHEAD UTILITIES
	UTILITY POLE
	GUY WIRE
	ELECTRIC METER BOX
	ELECTRIC BOX
	TRAFFIC SIGNAL SWITCH BOX
	LIGHT
	SECURITY POLE
	SEWER VALVE
	PARKING POLE
	CLEAN OUT
	LIGHT POLE
	HANDICAP SIGN
	SEWER MANHOLE
	WATER METER
	WATER VALVE
	TELEPHONE RISER
	FIRE HYDRANT
	WATER SPIGOT




N

EXISTING SITE / TOPO PLAN

SCALE: 1/2" = 1'-0"

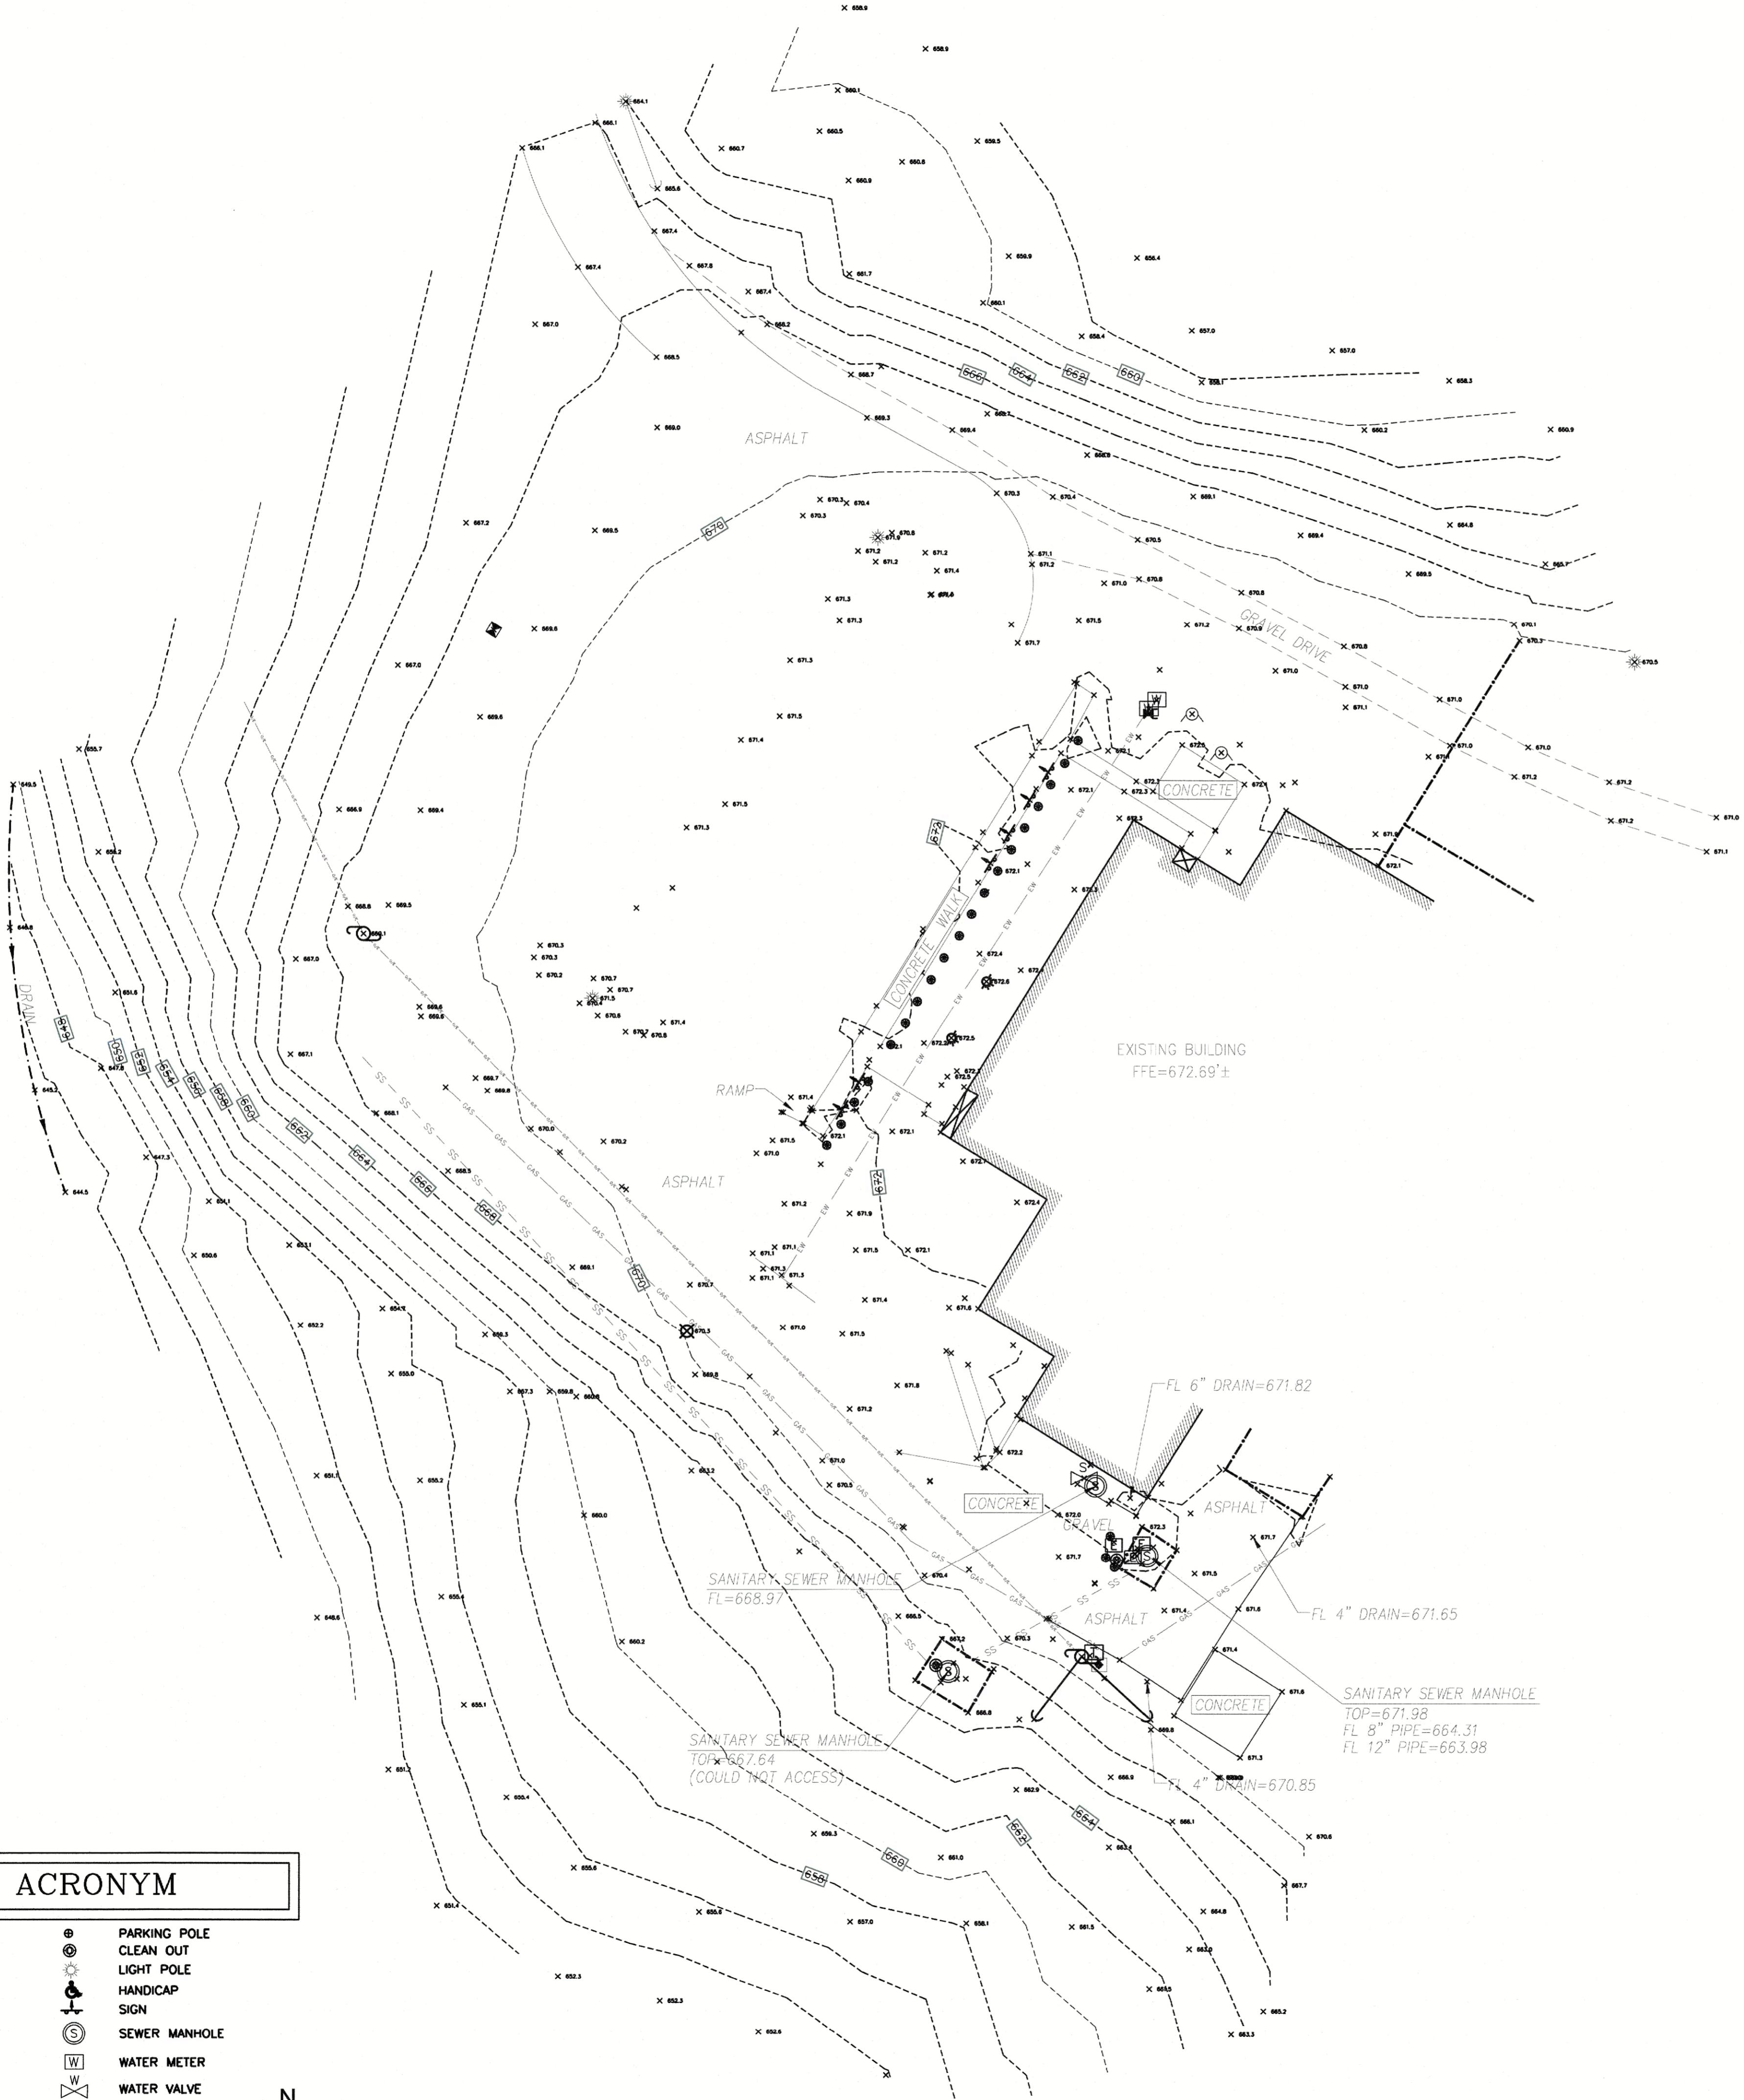

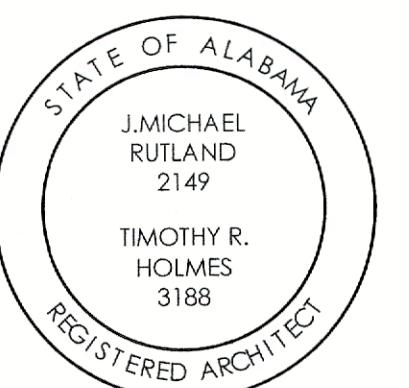

TALLAPOOSA CO E911 ADDITION TO THE TALLAPOOSA COUNTY JAIL FACILITY

DADEVILLE, AL




CONSTRUCTION DOCUMENTS

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MASTER SITE PLAN


SCALE: 1' = 30'

SITE WORK NOTES

- CUT & DELETE EXISTING WATER LINE. COORDINATE FOR SERVICE DOWN TIME. RELOCATE & CONNECT AS SHOWN.
- TEMPORARILY REMOVE SIGNAGE & REPLACE WHEN SITE WORK IS COMPLETE.
- CONNECT TO SANITARY SEWER SERVICE IN EXISTING PIPE TUNNEL. SEE PLUMBING.
- CUT & PATCH EXISTING DRIVE PAVING AS SPECIFIED.
- REMOVE EXISTING BOLLARDS TO ACCOMMODATE NEW WORK. REINSTALL IN ORIGINAL LOCATION.
- INSTALL NEW FIRE PROTECTION LINE AS SHOWN ON FIRE PROTECTION DRAWINGS.
- INSTALL NEW NATURAL GAS LINE TO NEW SERVICE @ NEW EQUIPMENT YARD.
- BORE UNDER WALK FOR NEW SERVICE COMPONENTS.
- INSTALL NEW 8'-0" HIGH 2X4 @ 24" O.C. TEMPORARY SAFETY BARRICADE TO PROTECT ENTRY TO SHERIFF'S OFFICE. INSTALL 1/2" PLYWOOD SHEATHING @ WALK SIDE. SEE DETAIL ON C1.1.
- INSTALL NEW 4" FOOTING DRAIN TILE - OUTFALL TO DAYLIGHT @ INVERT = 669.02.
- PROTECT EXISTING FLAGPOLE.
- PROTECT EXISTING DOWNSPOUT.
- NOTE: G.C. WILL UNDERCUT AS SPECIFIED AND LOAD ALL SPOILS ONTO COUNTY TRUCKS FOR HAUL OFF.
- CONTRACTOR WILL SOD ALL DISTURBED AREAS.

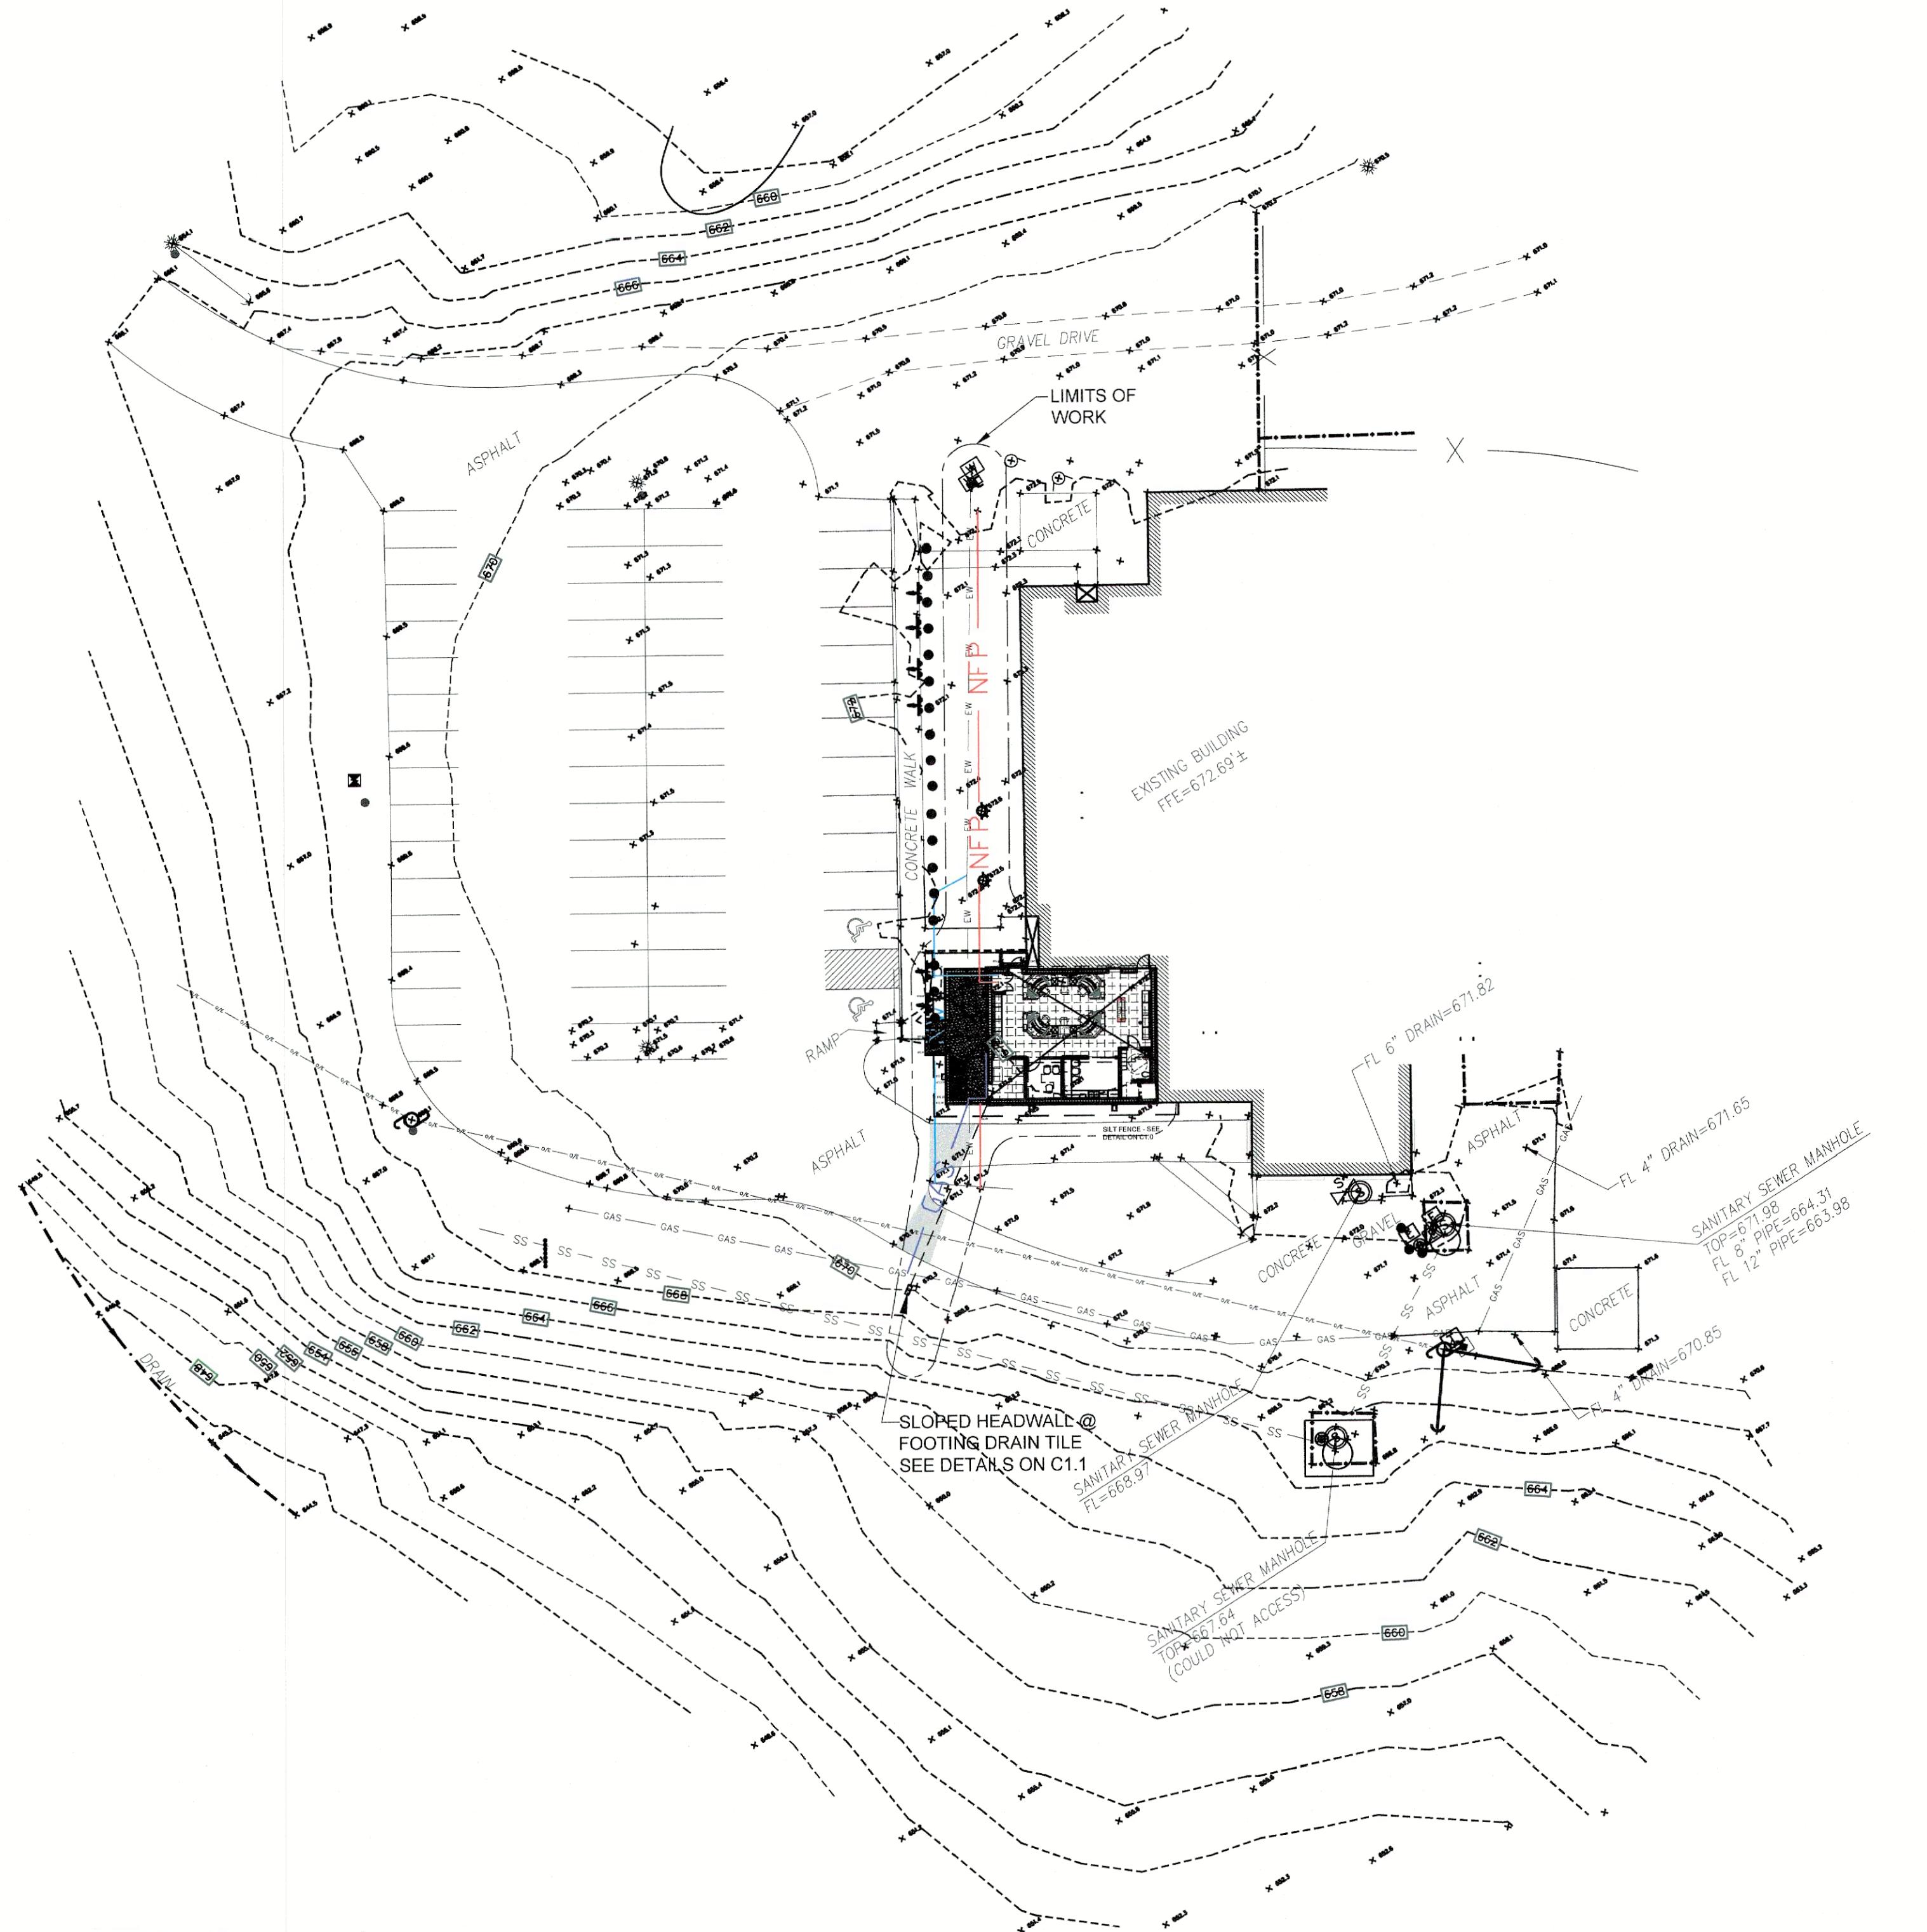
LEGEND

- EXISTING SITE CONTOUR
- EXISTING SITE SPOT ELEVATION X 670.19 ± 672.00"
- NEW SITE SPOT ELEVATION
- NEW UNDERGROUND GAS SERVICE
- EXISTING DOMESTIC WATER
- NEW DOMESTIC WATER
- SANITARY SEWER
- EXISTING FIRE PROTECTION
- NEW FIRE PROTECTION
- EXISTING BOLLARD
- EXISTING ADA SIGNAGE
- SAW CUT AND DEMOLITION OF EXISTING PAVING

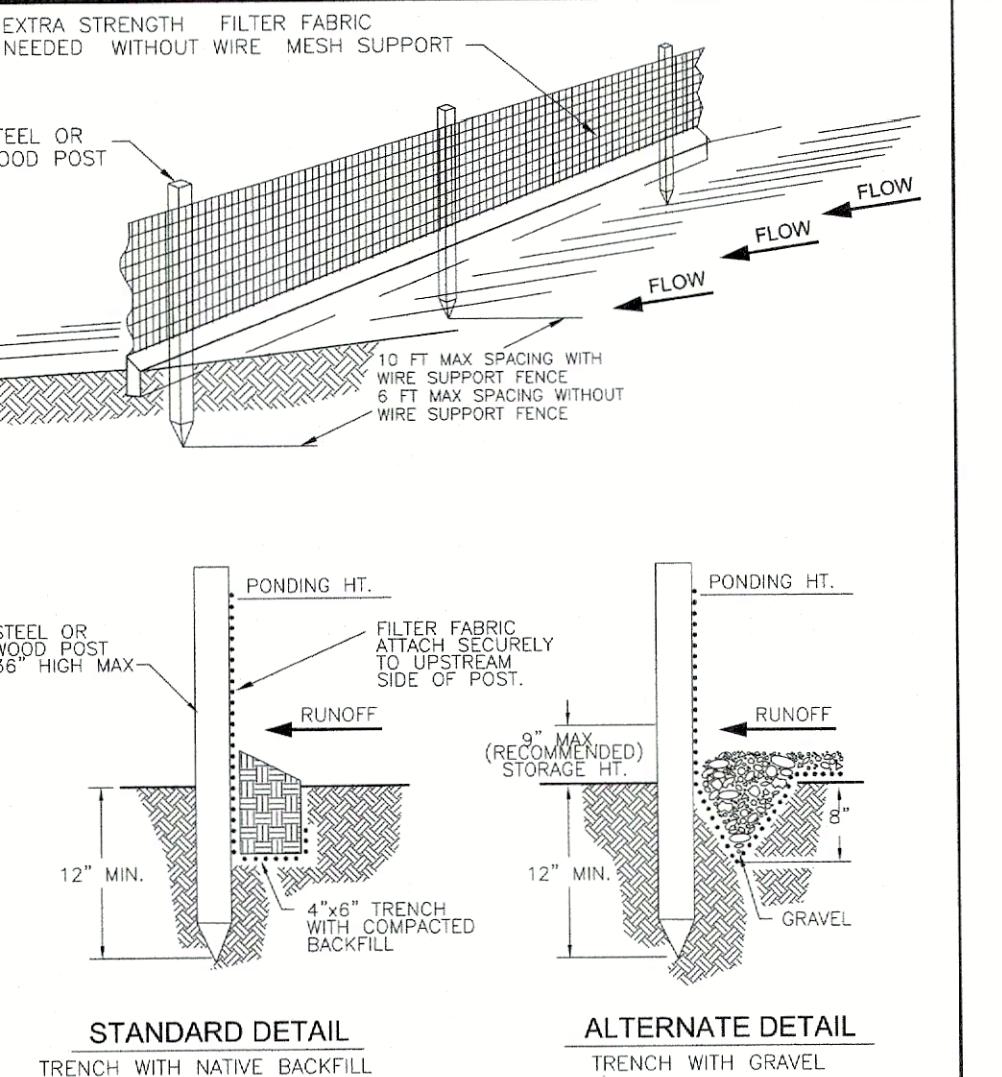


NOTE:
1. REPAIR AND REPAIR FENCE AFTER EACH STORM EVENT AND REMOVE SEDIMENT WHEN NECESSARY.
2. REMOVED SEDIMENT SHALL BE DEPOSITED ON SITE AND NOT DUMPED IN STREAMS OR SEDIMENT OFF-SITE AND CAN BE PERMANENTLY STABILIZED.
3. FENCE SHALL BE PLACED ON SLOPE CONTOURS TO MAXIMIZE PONDING EFFICIENCY.

SILT FENCE

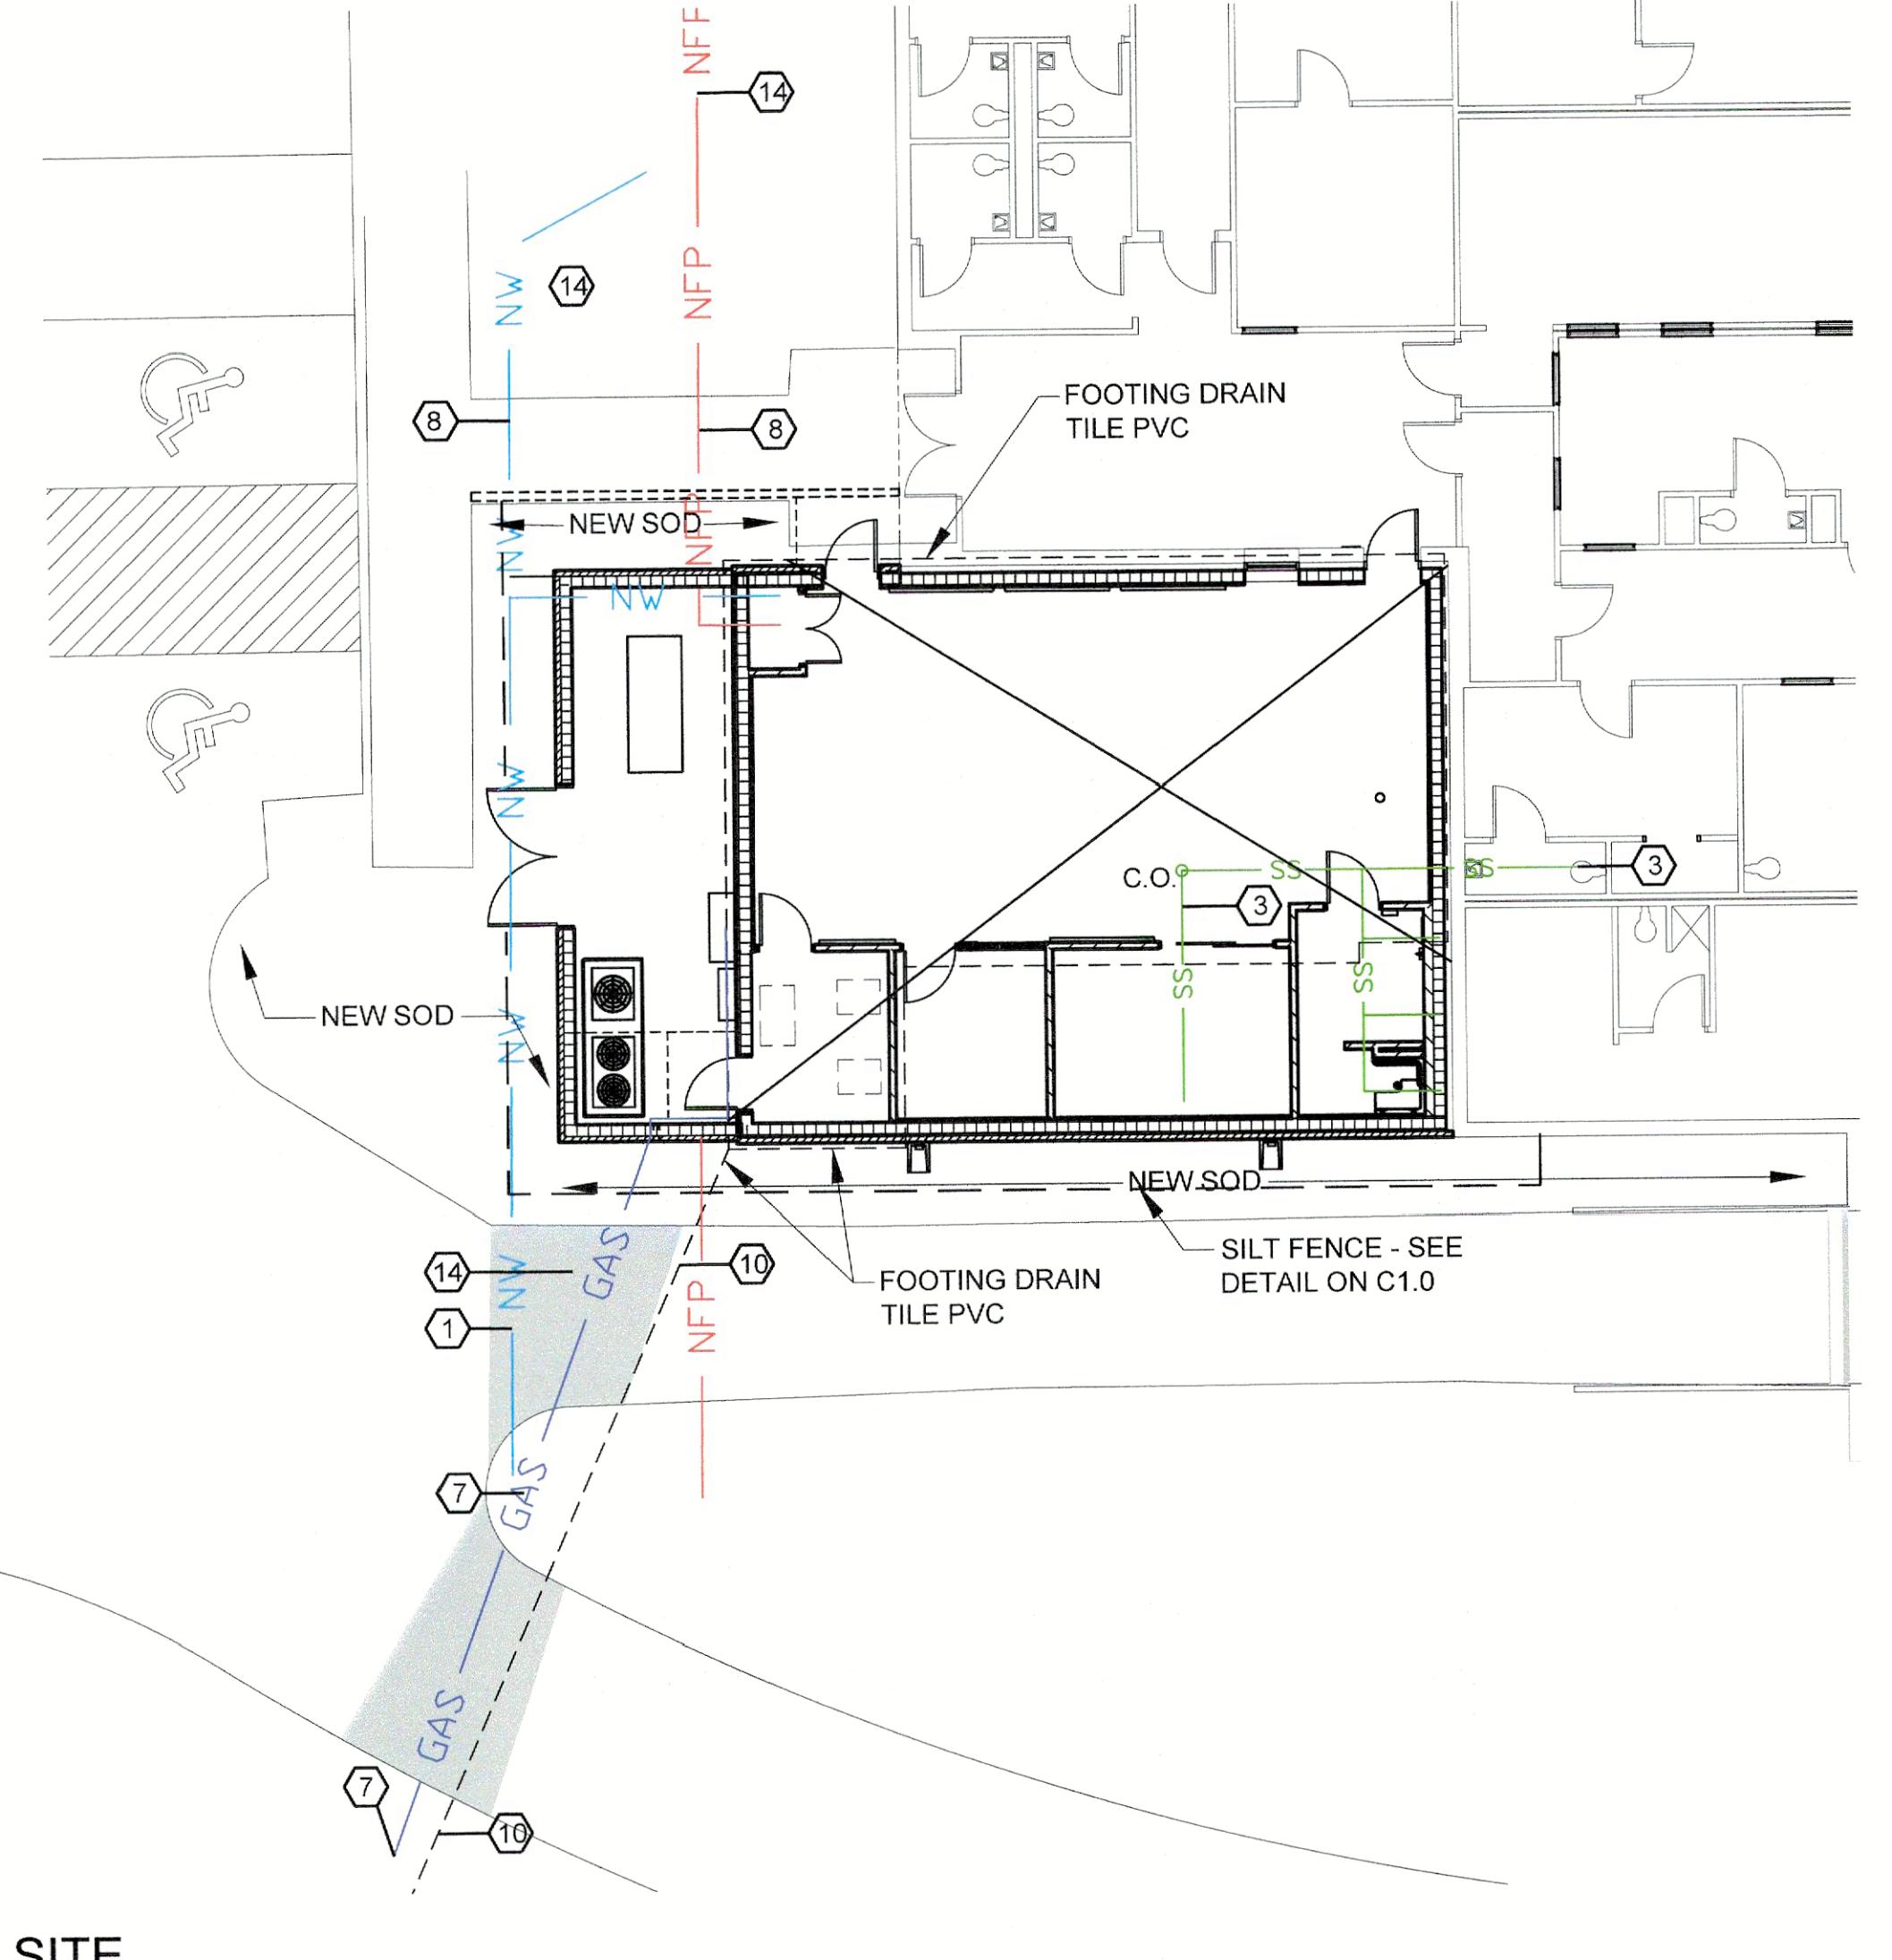


A
C1.0
LARGE SCALE SITE
SCALE: 1' = 10'

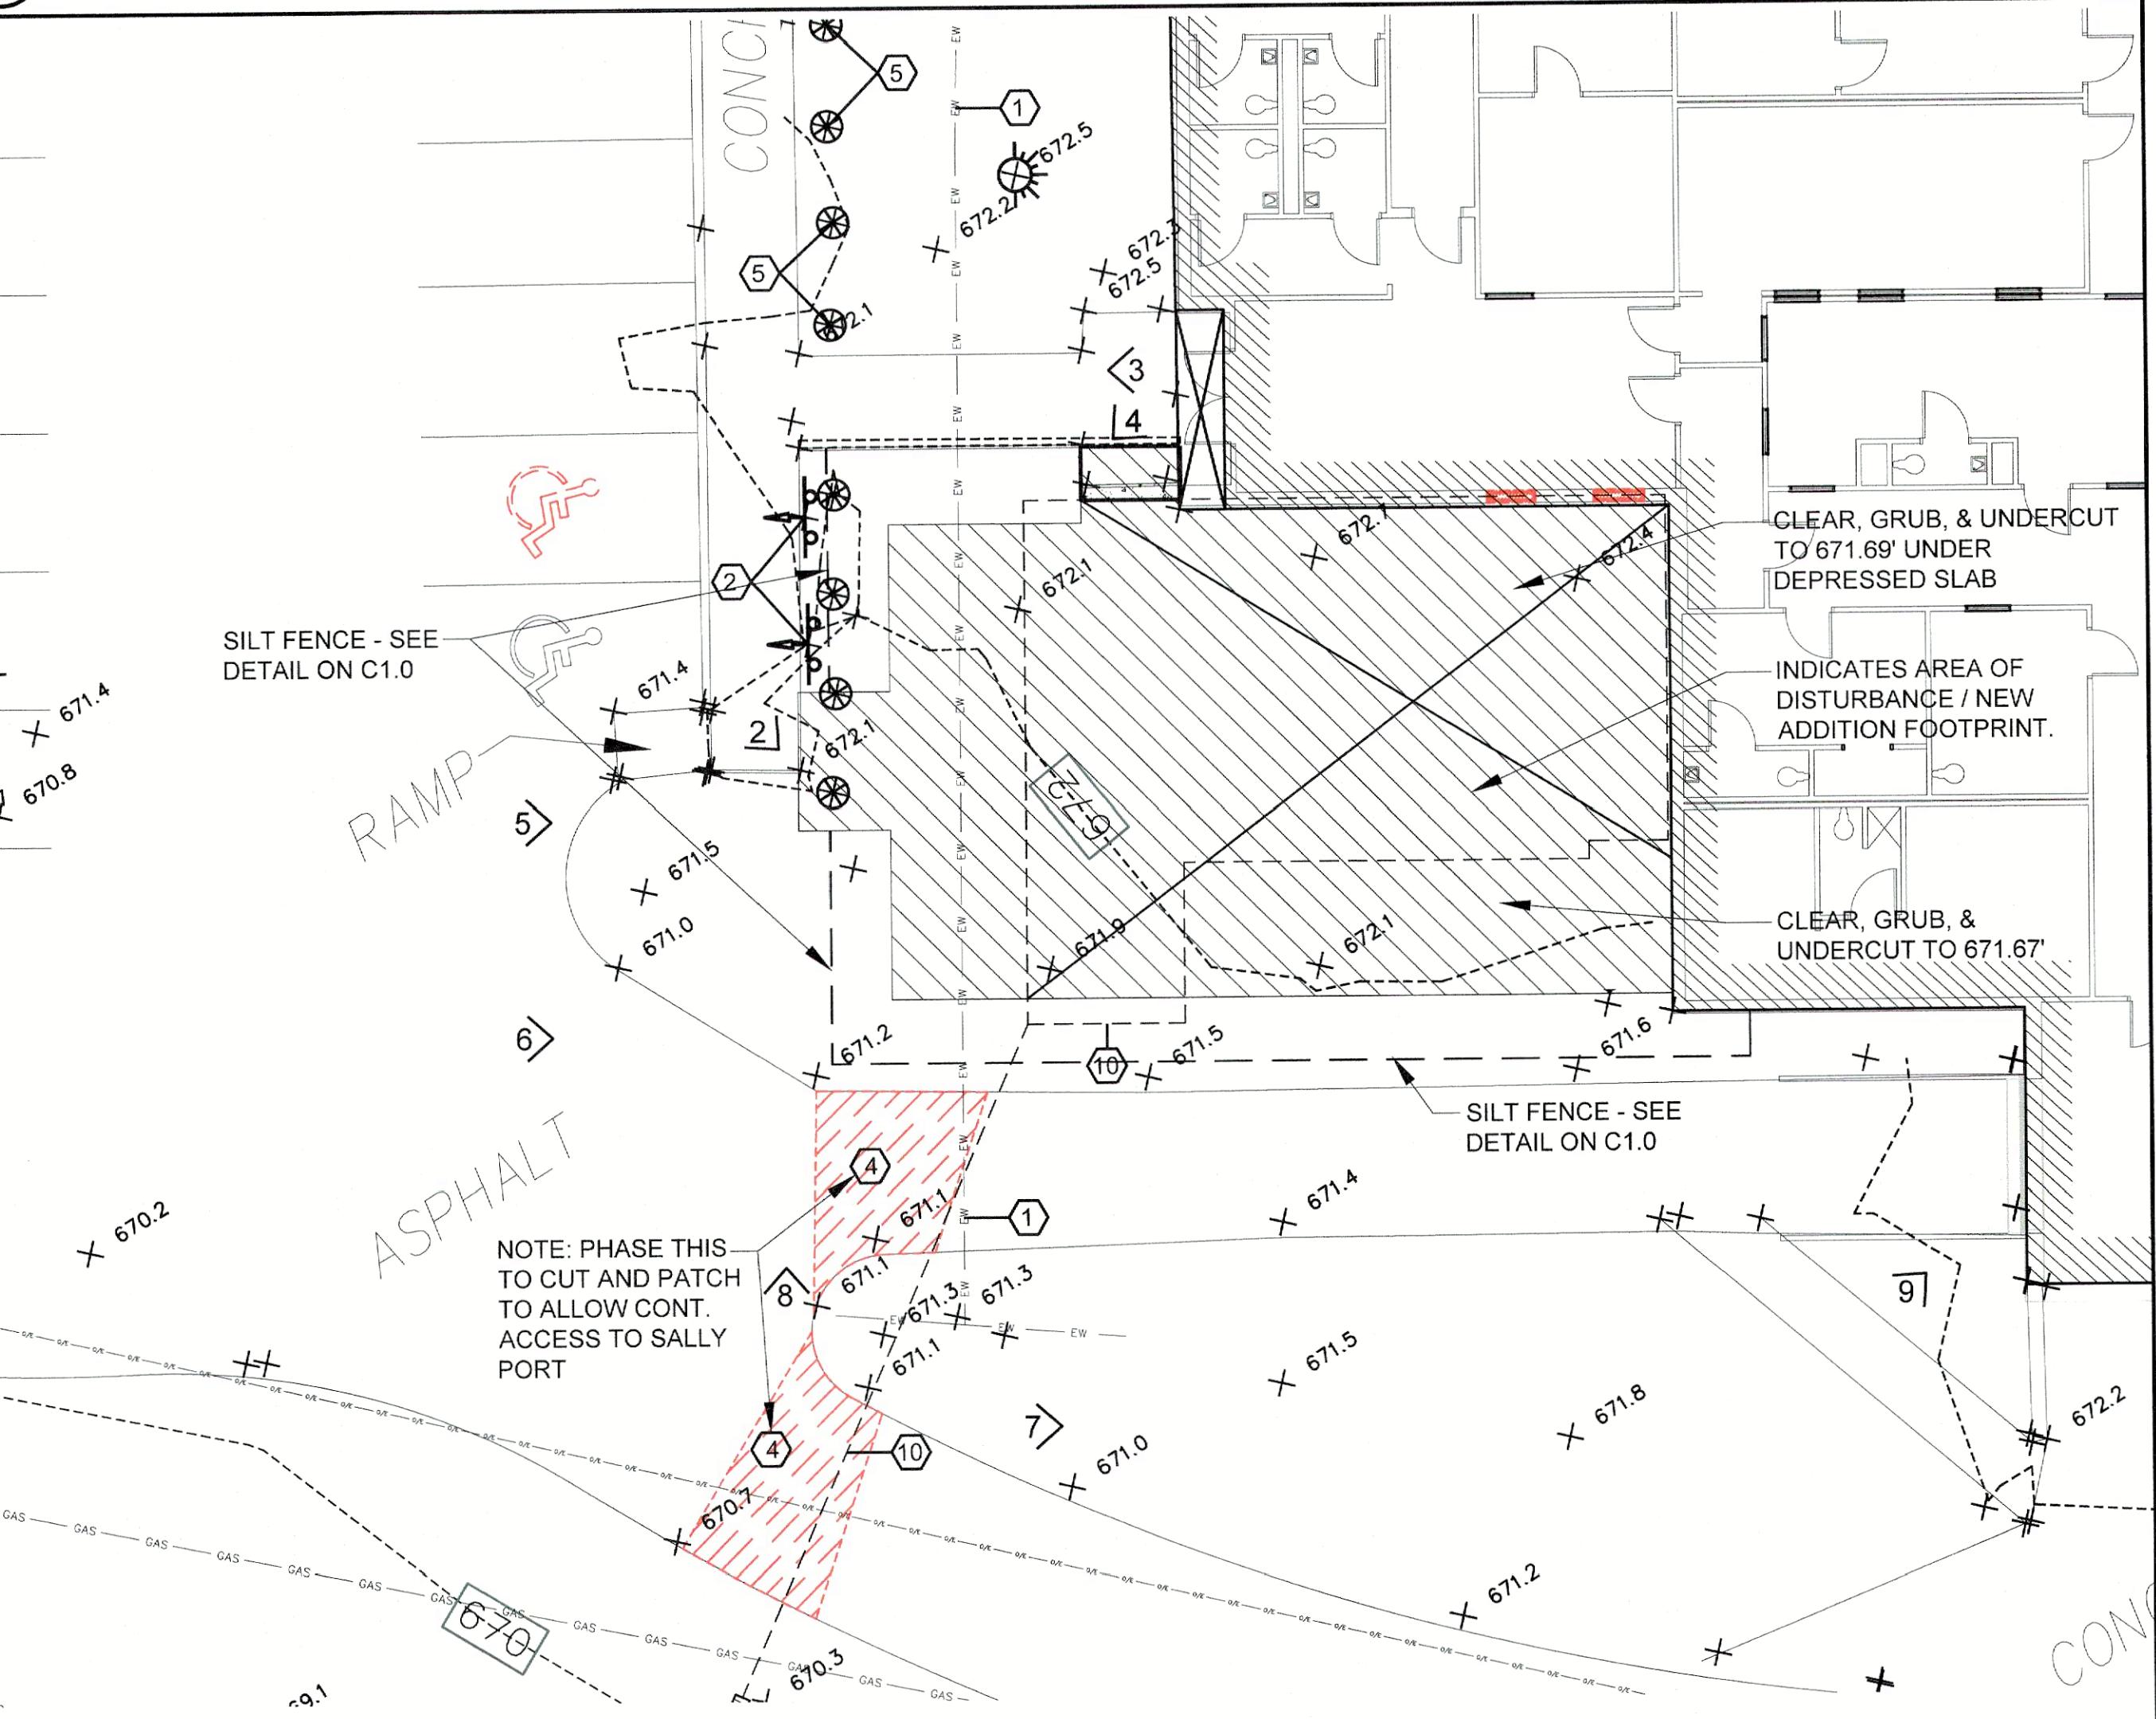


B
C1.0
LARGE SCALE SITE DEMOLITION
SCALE: 1' = 10'

Sheet Description

Sheet Number

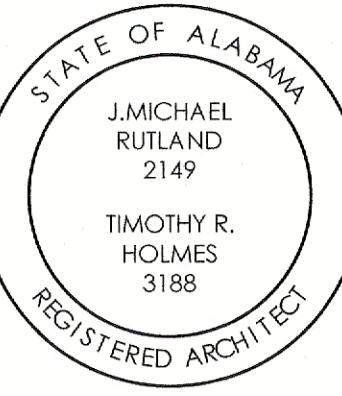

TALLAPOOSA CO E911 ADDITION TO THE TALLAPOOSA COUNTY JAIL FACILITY
DADEVILLE, AL

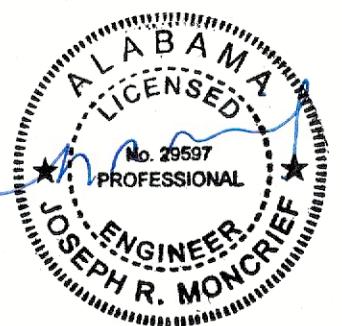

CONSTRUCTION DOCUMENTS

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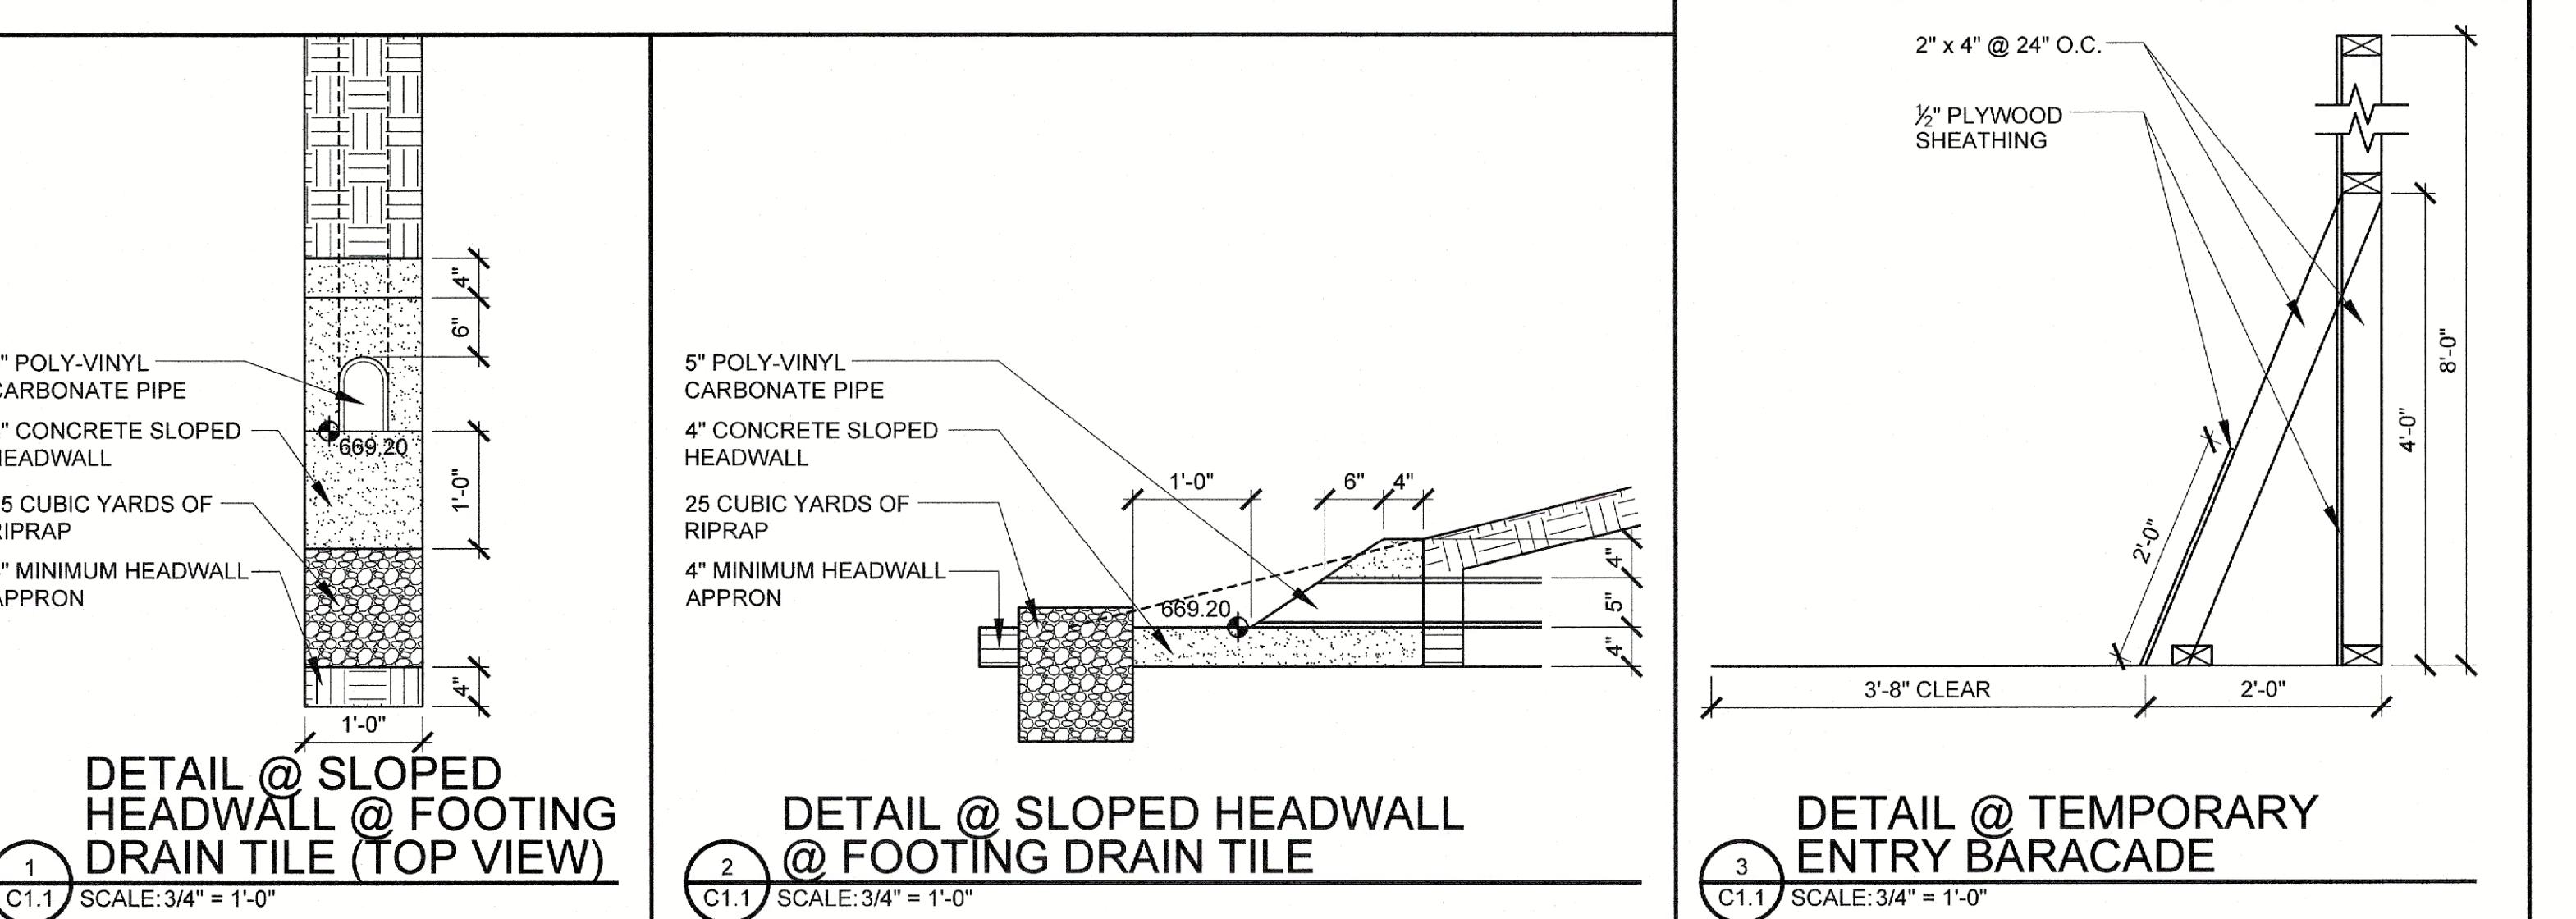
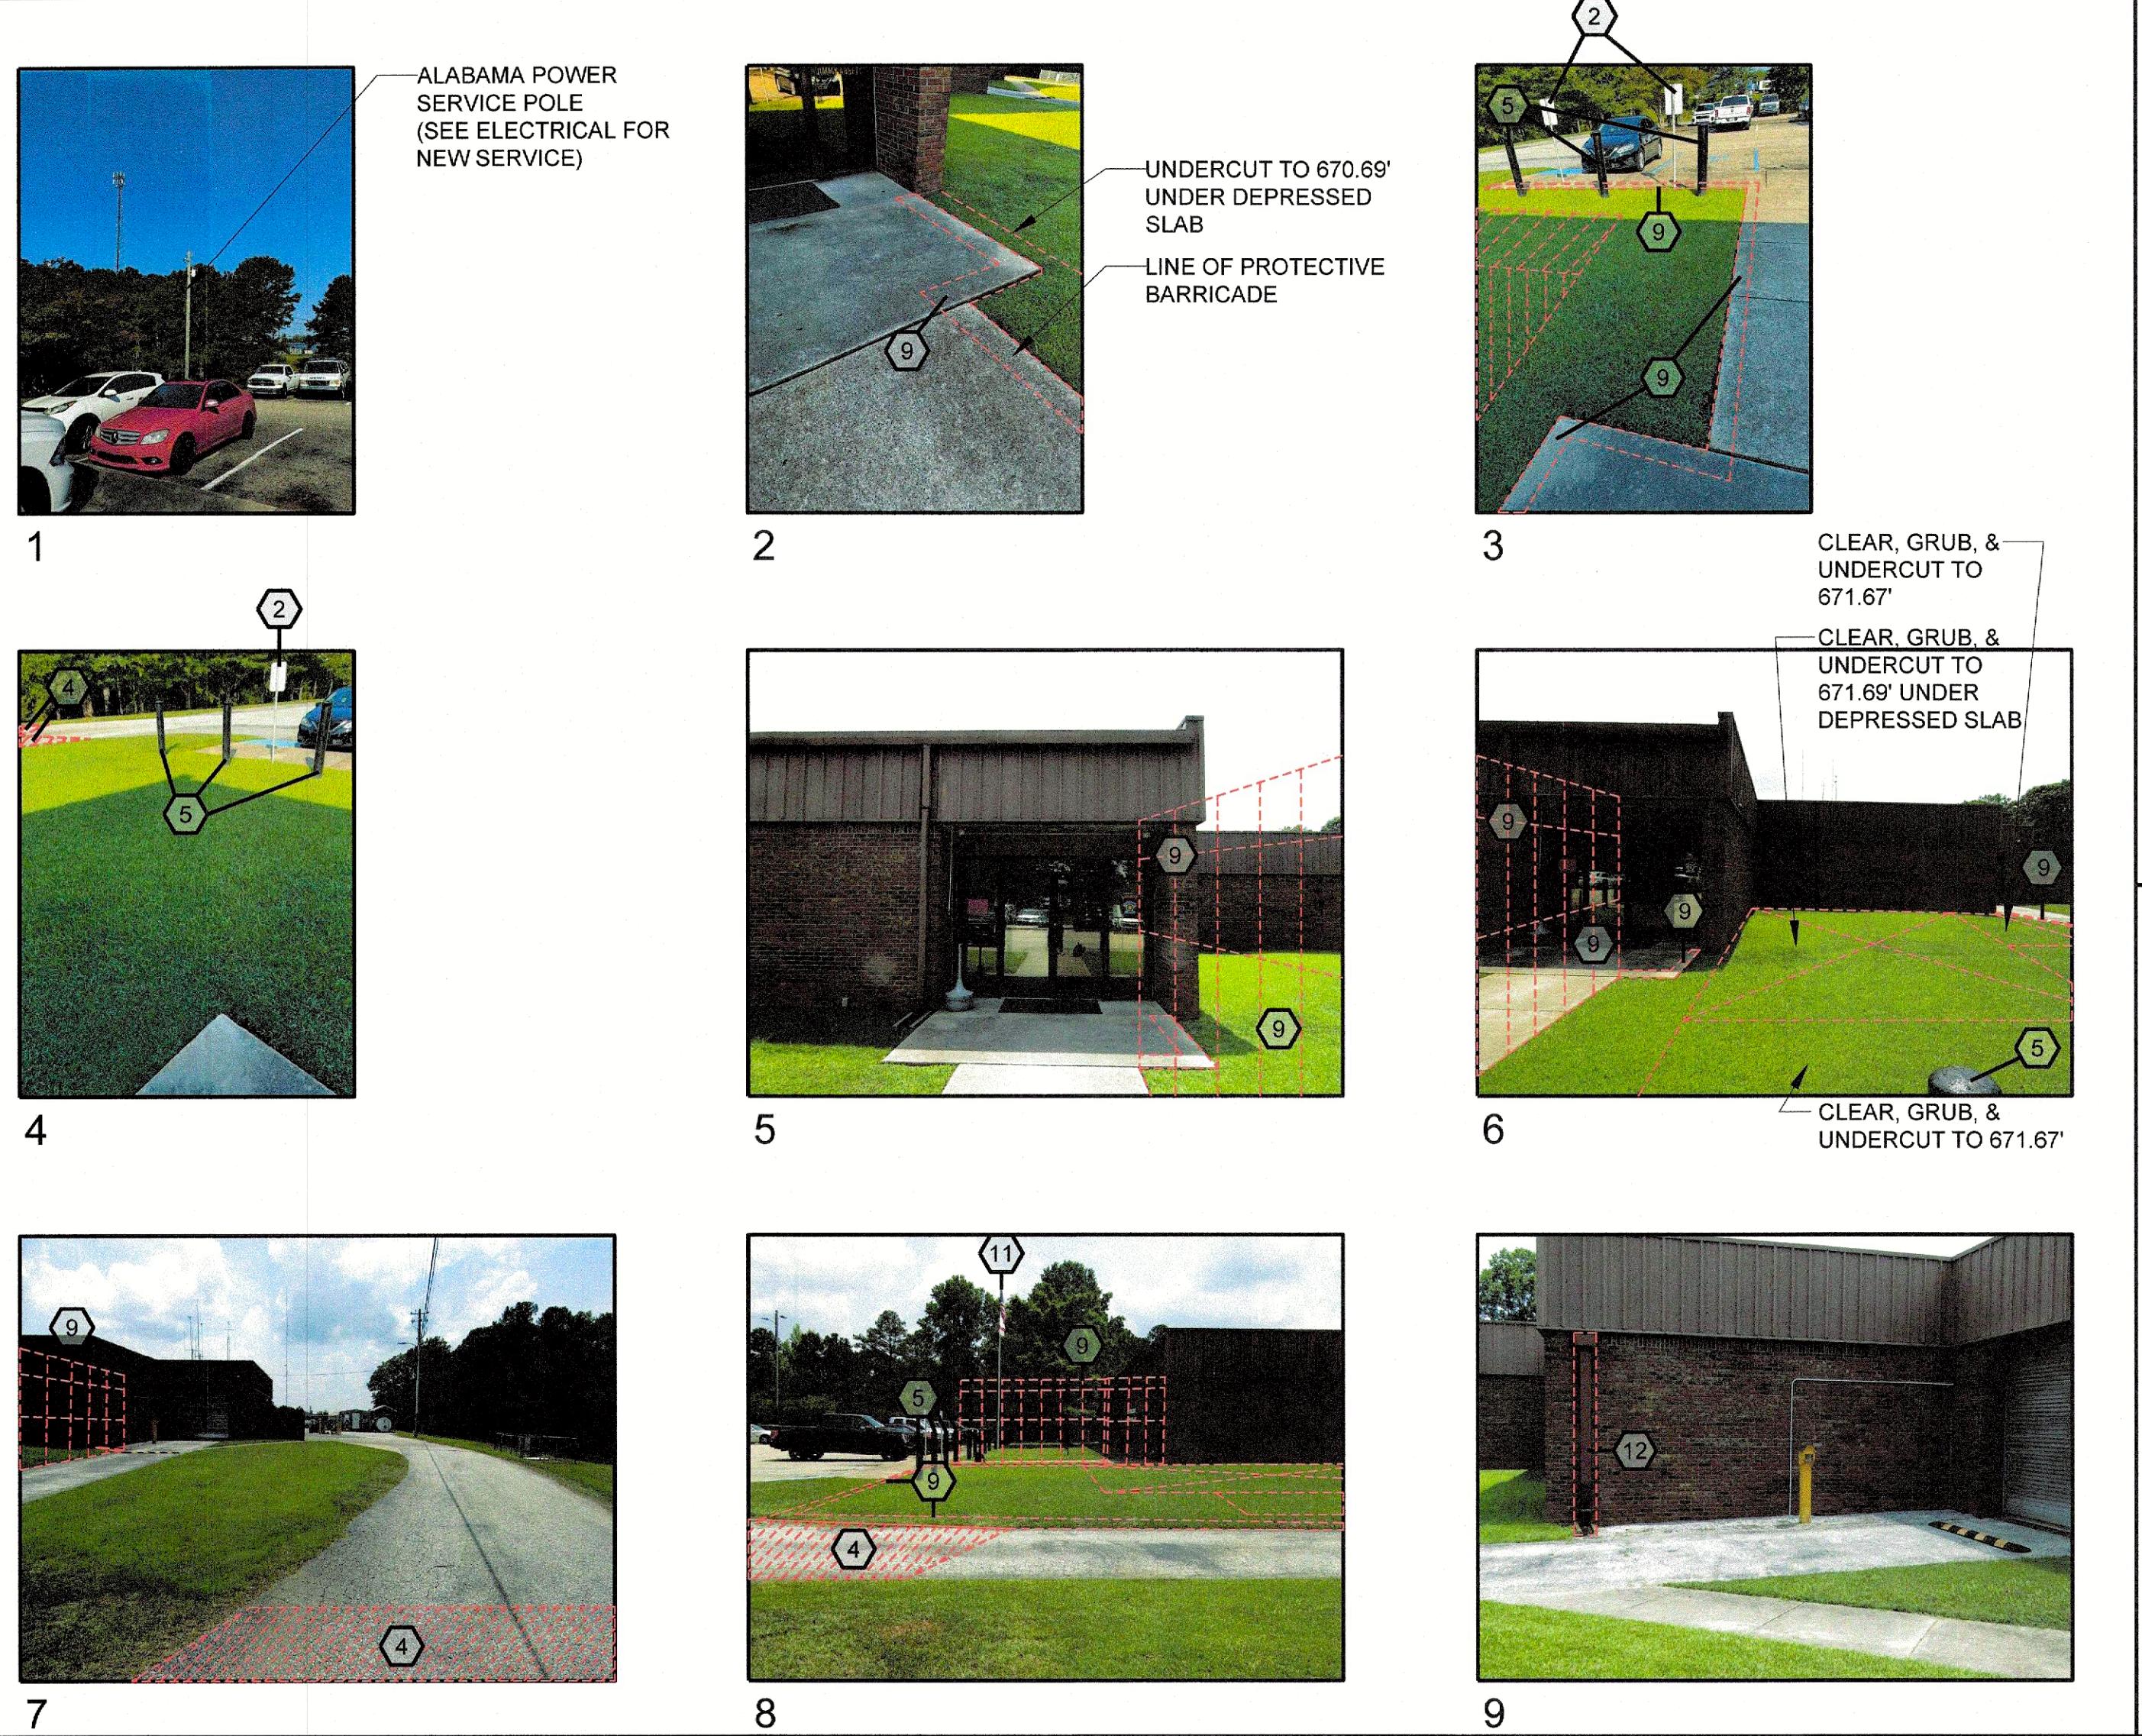
Sheet Description

PHOTOS & DETAILS

Sheet Number

C1.1

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SITE AND LANDSCAPING CONSTRUCTION

GENERAL NOTES:

- THE CONTRACTOR IS RESPONSIBLE FOR REPAIRS OR DAMAGE TO ANY EXISTING IMPROVEMENTS DURING CONSTRUCTION, AND HAS CUT NOT LIMITED TO, DRAINAGE, UTILITIES, PAVING, STRIPPING, CURB, ETC., AND ALL REPAIRS SHALL BE EQUAL TO OR BETTER THAN EXISTING CONDITIONS. THE REMOVAL/DEMOLITION OF HAZARDOUS MATERIALS IS THE RESPONSIBILITY OF THE CONTRACTOR.
- MATERIALS AND CONSTRUCTION METHODS FOR STREETS AND STORM DRAINAGE CONSTRUCTION SHALL BE IN ACCORDANCE WITH CITY OF DADEVILLE / ALDOT REGULATORY AGENCY.
- THE CONTRACTOR SHALL REVIEW SOIL REPORTS AND BORINGS PRIOR TO BIDDING THE PROJECT AND COMMENCING CONSTRUCTION. NOTE: UNDERCUT TO 670'9" UNDER DEPRESSED SLAB AS SHOWN AS DOCUMENTS.
- THE CONTRACTOR SHALL USE EACH PLAN IN CONJUNCTION WITH THE ENTIRE SET OF DRAWINGS AND SPECIFICATIONS. THE REMOVAL OR DEMOLISH ANYTHING WITHOUT VERIFICATION AND COORDINATION WITH ALL ELECTRICAL, PLUMBING, MECHANICAL, GENERAL TRADES, AND UTILITY COMPANIES AS THEY EFFECT THE OVERALL PROJECT.
- REFER TO ARCHITECTURAL, PLUMBING, MECHANICAL, AND ELECTRICAL DRAWINGS FOR BUILDING DIMENSIONS, UTILITY ENTRANCES.
- THE CONTRACTOR SHALL REFER TO ARCHITECT'S PLANS FOR EXACT DIMENSIONS, SLOPE PAVING, COLUMNS, DOOR LOCATIONS, SIDEWALKS, EXIT PORCHES, RAMPS, DRAINAGE CONNECTIONS, AND UTILITY ENTRANCE LOCATIONS.
- ALL WORK SHALL BE DONE IN ACCORDANCE WITH THE PLANS AND SPECIFICATIONS.
- ALL WORK AND MATERIALS SHALL COMPLY WITH ALL CITY OF DADEVILLE / ALDOT REGULATORY AGENCY'S REGULATIONS AND CODES AND OSHA STANDARDS.
- PRIOR TO ANY WORK ON-SITE, THE CONTRACTOR SHALL CONTACT THE ONE CALL SYSTEM. THE CONTRACTOR IS RESPONSIBLE FOR ALL UTILITY REMOVALS. IF APPLICABLE, WHETHER LOCATED BY THE ONE CALL SYSTEM OR NOT.
- NOTE: CITY OF DADEVILLE PERMITS COST IS WAIVED FOR THIS PROJECT.

EROSION CONTROL NOTES:

- PRIOR TO CONSTRUCTION, THE EROSION AND SEDIMENT CONTROL MEASURES SHOWN ON THE SITE PLAN SHALL BE IN PLACE CLEARING AND GRUBBING OPERATIONS WILL BE ENGAGED IN ONLY AS NECESSARY TO ALLOW THE PLACEMENT OF EROSION AND SEDIMENT CONTROL MEASURES AS SHOWN UNTIL ALL SUCH MEASURES ARE IN PLACE. LAND DISTURBING ACTIVITIES SHALL BE KEPT TO A MINIMUM AND WILL NOT EXTEND BEYOND THE LIMITS SHOWN.
- SILT FENCES SHALL BE CLEANED OR REPLACED WHEN TRAPPED SEDIMENT REACHES 50 PERCENT OF THE ABOVE GROUND FENCE HEIGHT OR PER MANUFACTURER'S SPECIFICATIONS.
- SEDIMENT AND EROSION CONTROL MEASURES WILL BE INSPECTED ON A WEEKLY BASIS AND AS PARED, ADJUSTED AND MAINTAINED AS NEEDED, OR REQUIRED AT NO ADDITIONAL EXPENSE TO THE OWNER TO PROVIDE EROSION AND SEDIMENT CONTROL FOR THE DURATION OF CONSTRUCTION AND UNTIL ALL DISTURBED AREAS ARE STABILIZED.
- ALL EROSION CONTROL MEASURES EXCEPT ANY REQUIRED RIP RAP ARE TEMPORARY DEVICES. THESE TEMPORARY DEVICES SHALL BE REMOVED PRIOR TO COMPLETION OF CONSTRUCTION ONCE STABILIZATION OF ALL GRASSED AREAS IS COMPLETE.
- ADDITIONAL DEVICES MAY BE REQUIRED AS DEEMED NECESSARY BY A/E.
- ALL GRADED AREAS SHALL BE STABILIZED WITH A PERMANENT FAST GROWING COVER AND/OR MULCH UPON COMPLETION OF GRADING OPERATIONS. COMPLETION OF GRADING OPERATIONS DOES NOT MEAN AT THE END OF THE PROJECT, AS SOON AS FINAL GRADES ARE ESTABLISHED IN AN UNPAVED AREA, THE CONTRACTOR SHALL STABILIZE WITH A TEMPORARY GRASS OR PERMANENT SOIL. IF A TEMPORARY GRASS IS APPLIED, IT WILL BE THE CONTRACTOR'S RESPONSIBILITY TO APPLY A PERMANENT SEED OR SOD AT THE PROPER TIME OF YEAR AS SHOWN ON DRAWINGS.
- FILL SLOPES SHOULD BE PLANTED AS SOON AS AN AREA OF THE SITE IS BROUGHT TO FINAL GRADE. SURFACE RUNOFF SHALL BE INTERCEPTED AT THE TOP OF TEMPORARY AND PERMANENT SLOPES DURING CONSTRUCTION SO THAT WATER IS NOT ALLOWED TO FLOW OVER THE SLOPE FACE.
- THE GENERAL CONTRACTOR AND THE GRADING CONTRACTOR SHALL REVIEW THEIR PROPOSED GRADING SEQUENCE TO INSURE THAT THE LEAST AMOUNT OF LAND POSSIBLE AT ANY ONE TIME IS DISTURBED WITH OUT PERMANENT STABILIZATION.
- THE CONTRACTOR SHALL BE RESPONSIBLE TO ENSURE COMPLIANCE WITH ALL PERMIT REQUIREMENTS. THIS INCLUDES, BUT IS NOT LIMITED TO, INSPECTION REQUIREMENTS.
- NOTE: THE CITY OF DADEVILLE BUILDING PERMIT WILL BE WAIVED FOR THIS PROJECT.

GENERAL DEMOLITION NOTES & SPECIFICATIONS:

- THE CONTRACTOR IS RESPONSIBLE TO VERIFY EXISTING UTILITIES PRIOR TO DEMOLITION AND EXCAVATION.
- THE CONTRACTOR IS RESPONSIBLE TO COMPLY WITH ALL LOCAL, STATE AND FEDERAL REGULATIONS IN THE REMOVAL/DEMOLITION OF HAZARDOUS MATERIALS.
- THE CONTRACTOR IS RESPONSIBLE FOR ALL REGISTRATIONS, PERMITS, AND FEES REQUIRED TO REMOVE AND PROPERLY DISPOSE OF ALL MATERIALS.
- THE CONTRACTOR IS RESPONSIBLE FOR OBTAINING APPROVALS AND NOTIFICATIONS TO ALL LOCAL, STATE AND FEDERAL AUTHORITIES.
- THE CONTRACTOR SHALL BE RESPONSIBLE FOR THE DISCONNECTION OF THE UTILITY SERVICES TO ANY EXISTING STRUCTURES PRIOR TO DEMOLITION OF ANY BUILDINGS. THE CONTRACTOR SHALL COORDINATE WITH RESPECTIVE UTILITY COMPANIES PRIOR TO THE REMOVAL AND/OR RELOCATION OF UTILITIES.
- THE CONTRACTOR SHALL COORDINATE WITH THE UTILITY COMPANY CONCERNING IMPROVEMENTS DURING CONSTRUCTION, SUCH AS BUT NOT LIMITED TO, DRAINAGE, UTILITIES, PAVING, STRIPPING, CURB, ETC., AND ALL REPAIRS SHALL BE EQUAL TO OR BETTER THAN EXISTING CONDITIONS.
- THE CONTRACTOR SHALL COORDINATE THE INSTALLATION OF ALL UNDERGROUND UTILITIES WITH HIS WORK. ALL UNDERGROUND UTILITIES (WATER, GAS, SANITARY SEWER, STORM SEWER, ELECTRICAL CONDUIT, AND ANY OTHER MISCELLANEOUS UTILITIES) SHALL BE IN PLACE PRIOR TO THE PLACEMENT OF BASE COURSE MATERIAL, AND THE PLACEMENT OF ANY APPROPRIATE SOIL STABILIZATION TECHNIQUE.
- THE CONTRACTOR SHALL PROVIDE BOLLARDS FOR PROTECTION OF ALL ABOVE GROUND UTILITIES AND APPURTENANCES ADJACENT TO DRIVE AREAS.
- THE CONTRACTOR SHALL MATCH EXISTING PAVEMENT IN GRADE AND ALIGNMENT.
- ALL DIMENSIONS SHOWN TO BUILDING ARE TO FACE OF STRUCTURAL FOUNDATIONS.
- ALL CURB DIMENSIONS ARE TO THE FACE OF GUTTER OR CURB UNLESS OTHERWISE NOTED.
- PAVING... CONCRETE & CRUSHED STONE PAVING:**

 - NOTIFY A/E THREE (3) DAYS PRIOR TO POUR OF INITIAL SECTION OF DRIVEWAY PAVING. CLIENT REPRESENTATIVE TO APPROVE INITIAL POUR.
 - TESTING OF MATERIALS REQUIRED FOR THE CONSTRUCTION OF THE PAVING IMPROVEMENTS SHALL BE PERFORMED BY AN AGENCY, APPROVED BY THE OWNER, FOR TESTING MATERIALS. IT SHALL BE THE CONTRACTOR'S RESPONSIBILITY TO ENSURE, BY THE STANDARD TESTING PROCEDURES, THAT THE WORK CONSTRUCTED MEETS THE REQUIREMENTS OF THE PROJECT SPECIFICATIONS AND THE SAME TESTING COST WILL BE BY GENERAL CONTRACTOR.
 - SEPARATE PAVING / PAVING / PATCHING FOR LOCATION OF PROPOSED SLEEVING AND CONDUITS. EXTRA CONDUIT SHALL BE PLACED UNDER DRIVEWAYS FOR FUTURE USE.
 - ALL DISCREPANCIES FOUND BY CONTRACTOR RELATED TO UNDERGROUND UTILITIES OR OTHER APPURTENANCES SHALL BE RESOLVED TO THE SATISFACTION OF A/E PRIOR TO BACKFILL MATERIAL. ALL SELECT BACKFILL MATERIAL SHALL BE PLACED AND COMPAKTED PER THE REQUIREMENTS OF SPECIFICATIONS AND THE OWNERS GEOTECHNICAL ENGINEER.
 - THE CONTRACTOR IS RESPONSIBLE FOR WALKING SITE AND DETERMINING EXTENTS OF DEMOLITION WORK PRIOR TO BID DATE.
 - THE CONTRACTOR SHALL COORDINATE FOR ELECTRICAL SERVICES ON-SITE WITH THE POWER COMPANY. POWER COMPANY IS RESPONSIBLE FOR THE DISCONNECTION AND REMOVAL OF EXISTING SERVICES UNLESS OTHERWISE NOTED.
 - LIMITS OF PAVEMENT SHOWN TO BE REMOVED ARE APPROXIMATE AND FOR REFERENCE ONLY. THE CONTRACTOR SHALL FIELD VERIFY THE LIMITS OF PAVEMENT TO DETERMINE THE EXTENT OF THE EXISTING PAVEMENT TO BE REMOVED.
 - SOIL TESTS FOR RECYCLED MATERIALS SHALL BE FIRST GIVEN TO THE OWNER. ANY MATERIALS RETAINED BY THE OWNER SHALL BE REMOVED FROM THE SITE AND DISPOSED OF BY THE CONTRACTOR AT THE CONTRACTOR'S EXPENSE.
 - CONDITIONS EXISTING AT TIME OF INSPECTION FOR BIDDING PURPOSE WILL BE MAINTAINED BY OWNER AS FAR AS PRACTICAL.
 - THE CONTRACTOR IS TO MAINTAIN AND PROTECT ALL EXISTING UTILITIES FROM DAMAGE DURING DEMOLITION OPERATIONS.
 - REMOVE DEBRIS IN A MANNER THAT WILL PREVENT SPILLAGE ON ADJACENT SURFACES AND AREAS WITHIN LOADING THE COUNTY TRUCKS FOR HAUL OFF.
 - PROMPTLY DISPOSE OF DEMOLISHED MATERIALS. DO NOT ALLOW DEMOLISHED MATERIALS TO ACCUMULATE ON-SITE. COORDINATE WITH OWNER FOR REMOVAL BY COUNTY TRUCKS.
 - DO NOT BURN DEMOLISHED MATERIALS.
 - IT IS UNDERSTOOD THAT ALL ABOVE GROUND ITEMS TO BE REMOVED INCLUDE THEIR ASSOCIATED BELOW GROUND COMPONENTS (I.E. FOUNDATIONS, UTILITY CONNECTIONS, ETC.).
 - ALL TREES INSIDE THE LIMITS OF DISTURBANCE ARE TO BE REMOVED UNLESS NOTED OTHERWISE.
 - EXISTING STRUCTURES WITHIN CONSTRUCTION LIMITS ARE TO BE ABANDONED, REMOVED, OR RELOCATED PER PLANS. ALL COST SHALL BE INCLUDED IN BASE BID.

SITE PLAN NOTES:

- THE CONTRACTOR SHALL BE RESPONSIBLE FOR ALL RELOCATIONS, INCLUDING BUT NOT LIMITED TO, ALL UTILITIES, STORM DRAINAGE, ETC. AS REQUIRED FOR ALL SITE IMPROVEMENTS. ALL WORK SHALL BE IN ACCORDANCE WITH THE CONTRACT DOCUMENTS.
- EXISTING UTILITY LINES SHOWN ARE APPROXIMATE LOCATIONS ONLY. THE CONTRACTOR SHALL FIELD VERIFY ALL EXISTING UTILITY LINE LOCATIONS PRIOR TO ANY CONSTRUCTION. ANY DEVIATIONS FROM THE DESIGN LOCATIONS SHALL BE REPORTED TO THE ARCHITECT OR ENGINEERS PRIOR TO CONSTRUCTION.
- THE CONTRACTOR IS RESPONSIBLE FOR THE PROTECTION OF ALL AREAS INDICATED TO REMAIN UNDISTURBED OR TO REMAIN AS BUFFERS, ALL PROPERTY CORNERS, AND COORDINATION OF A REGISTERED LAND SURVEYOR TO REPLACE ALL PINS ELIMINATED OR DAMAGED DURING CONSTRUCTION.
- THE CONTRACTOR IS RESPONSIBLE FOR REPAIRS OR DAMAGE TO ANY EXISTING IMPROVEMENTS DURING CONSTRUCTION, SUCH AS BUT NOT LIMITED TO, DRAINAGE, UTILITIES, PAVING, STRIPPING, CURB, ETC., AND ALL REPAIRS SHALL BE EQUAL TO OR BETTER THAN EXISTING CONDITIONS.
- THE CONTRACTOR SHALL COORDINATE THE INSTALLATION OF ALL UNDERGROUND UTILITIES WITH HIS WORK. ALL UNDERGROUND UTILITIES (WATER, GAS, SANITARY SEWER, STORM SEWER, ELECTRICAL CONDUIT, AND ANY OTHER MISCELLANEOUS UTILITIES) SHALL BE IN PLACE PRIOR TO THE PLACEMENT OF BASE COURSE MATERIAL, AND THE PLACEMENT OF ANY APPROPRIATE SOIL STABILIZATION TECHNIQUE.
- THE CONTRACTOR SHALL PROVIDE BOLLARDS FOR PROTECTION OF ALL ABOVE GROUND UTILITIES AND APPURTENANCES ADJACENT TO DRIVE AREAS.
- THE CONTRACTOR SHALL MATCH EXISTING PAVEMENT IN GRADE AND ALIGNMENT.
- ALL DIMENSIONS SHOWN TO BUILDING ARE TO FACE OF STRUCTURAL FOUNDATIONS.
- ALL CURB DIMENSIONS ARE TO THE FACE OF GUTTER OR CURB UNLESS OTHERWISE NOTED.
- PAVING... CONCRETE & CRUSHED STONE PAVING:**



 - NOTIFY A/E THREE (3) DAYS PRIOR TO POUR OF INITIAL SECTION OF DRIVEWAY PAVING. CLIENT REPRESENTATIVE TO APPROVE INITIAL POUR.
 - TESTING OF MATERIALS REQUIRED FOR THE CONSTRUCTION OF THE PAVING IMPROVEMENTS SHALL BE PERFORMED BY AN AGENCY, APPROVED BY THE OWNER, FOR TESTING MATERIALS. IT SHALL BE THE CONTRACTOR'S RESPONSIBILITY TO ENSURE, BY THE STANDARD TESTING PROCEDURES, THAT THE WORK CONSTRUCTED MEETS THE REQUIREMENTS OF THE PROJECT SPECIFICATIONS AND THE SAME TESTING COST WILL BE BY GENERAL CONTRACTOR.
 - SEPARATE PAVING / PAVING / PATCHING FOR LOCATION OF PROPOSED SLEEVING AND CONDUITS. EXTRA CONDUIT SHALL BE PLACED UNDER DRIVEWAYS FOR FUTURE USE.
 - ALL DISCREPANCIES FOUND BY CONTRACTOR RELATED TO UNDERGROUND UTILITIES OR OTHER APPURTENANCES SHALL BE RESOLVED TO THE SATISFACTION OF A/E PRIOR TO BACKFILL MATERIAL. ALL SELECT BACKFILL MATERIAL SHALL BE PLACED AND COMPAKTED PER THE REQUIREMENTS OF SPECIFICATIONS AND THE OWNERS GEOTECHNICAL ENGINEER.
 - THE CONTRACTOR IS RESPONSIBLE FOR WALKING SITE AND DETERMINING EXTENTS OF DEMOLITION WORK PRIOR TO BID DATE.
 - THE CONTRACTOR SHALL COORDINATE FOR ELECTRICAL SERVICES ON-SITE WITH THE POWER COMPANY. POWER COMPANY IS RESPONSIBLE FOR THE DISCONNECTION AND REMOVAL OF EXISTING SERVICES UNLESS OTHERWISE NOTED.
 - LIMITS OF PAVEMENT SHOWN TO BE REMOVED ARE APPROXIMATE AND FOR REFERENCE ONLY. THE CONTRACTOR SHALL FIELD VERIFY THE LIMITS OF PAVEMENT TO DETERMINE THE EXTENT OF THE EXISTING PAVEMENT TO BE REMOVED.
 - SOIL TESTS FOR RECYCLED MATERIALS SHALL BE FIRST GIVEN TO THE OWNER. ANY MATERIALS RETAINED BY THE OWNER SHALL BE REMOVED FROM THE SITE AND DISPOSED OF BY THE CONTRACTOR AT THE CONTRACTOR'S EXPENSE.
 - CONDITIONS EXISTING AT TIME OF INSPECTION FOR BIDDING PURPOSE WILL BE MAINTAINED BY OWNER AS FAR AS PRACTICAL.
 - THE CONTRACTOR IS TO MAINTAIN AND PROTECT ALL EXISTING UTILITIES FROM DAMAGE DURING DEMOLITION OPERATIONS.
 - REMOVE DEBRIS IN A MANNER THAT WILL PREVENT SPILLAGE ON ADJACENT SURFACES AND AREAS WITHIN LOADING THE COUNTY TRUCKS FOR HAUL OFF.
 - PROMPTLY DISPOSE OF DEMOLISHED MATERIALS. DO NOT ALLOW DEMOLISHED MATERIALS TO ACCUMULATE ON-SITE. COORDINATE WITH OWNER FOR REMOVAL BY COUNTY TRUCKS.
 - DO NOT BURN DEMOLISHED MATERIALS.
 - IT IS UNDERSTOOD THAT ALL ABOVE GROUND ITEMS TO BE REMOVED INCLUDE THEIR ASSOCIATED BELOW GROUND COMPONENTS (I.E. FOUNDATIONS, UTILITY CONNECTIONS, ETC.).
 - ALL TREES INSIDE THE LIMITS OF DISTURBANCE ARE TO BE REMOVED UNLESS NOTED OTHERWISE.
 - EXISTING STRUCTURES WITHIN CONSTRUCTION LIMITS ARE TO BE ABANDONED, REMOVED, OR RELOCATED PER PLANS. ALL COST SHALL BE INCLUDED IN BASE BID.

GRADING PLAN NOTES:

- EXISTING CONTOURS INTERVAL IS SHOWN AT TWO FEET (2').
- IT SHALL BE THE RESPONSIBILITY OF THE CONTRACTOR TO NOTIFY A/E OF ANY UTILITY CONFLICTS WITH THE PROPOSED IMPROVEMENTS SHOWN ON THE PLANS.
- ALL CUT OR FILL SLOPES SHALL BE 4:1 OR FLATTER UNLESS OTHERWISE NOTED.
- THE CONTRACTOR SHALL VERIFY HORIZONTAL AND VERTICAL LOCATION OF ALL EXISTING STORM SEWER STRUCTURES, PIPES AND ALL UTILITIES PRIOR TO CONSTRUCTION.
- CLEARING AND GRUBBING LIMITS SHALL INCLUDE ALL AREAS DISTURBED BY GRADING OPERATIONS. THE CONTRACTOR IS RESPONSIBLE FOR THE PROTECTION OF ALL UNDISTURBED AREAS, ALL PROPERTY CORNERS, AND COORDINATION OF A REGISTERED LAND SURVEYOR TO REPLACE ALL PINS ELIMINATED OR DAMAGED DURING CONSTRUCTION.
- EXISTING DRAINAGE STRUCTURES TO REMAIN ARE TO BE INSPECTED AND REPAVED AS NEEDED, AND EXISTING PIPES TO BE CLEANED OUT TO REMOVE ALL SILTS AND DEBRIS.
- THE CONTRACTOR IS RESPONSIBLE FOR REPAIRS OF DAMAGE TO ANY EXISTING IMPROVEMENTS DURING CONSTRUCTION, SUCH AS BUT NOT LIMITED TO, DRAINAGE, UTILITIES, PAVING, STRIPPING, CURB, ETC., AND ALL REPAIRS SHALL BE EQUAL TO OR BETTER THAN EXISTING CONDITIONS.
- THE CONTRACTOR SHALL COORDINATE THE INSTALLATION OF ALL UNDERGROUND UTILITIES WITH HIS WORK. ALL UNDERGROUND UTILITIES (WATER, GAS, SANITARY SEWER, STORM SEWER, ELECTRICAL CONDUIT, AND ANY OTHER MISCELLANEOUS UTILITIES) SHALL BE IN PLACE PRIOR TO THE PLACEMENT OF BASE COURSE MATERIAL, AND THE PLACEMENT OF ANY APPROPRIATE SOIL STABILIZATION TECHNIQUE.
- THE CONTRACTOR SHALL PROVIDE BOLLARDS FOR PROTECTION OF ALL ABOVE GROUND UTILITIES AND APPURTENANCES ADJACENT TO DRIVE AREAS.
- THE CONTRACTOR SHALL MATCH EXISTING PAVEMENT IN GRADE AND ALIGNMENT.
- PROPOSED SPOT ELEVATIONS REPRESENT FINISHED PAVEMENT OR GROUND SURFACE GRADE UNLESS OTHERWISE NOTED ON DRAWINGS.
- THE CONTRACTOR SHALL TRIM, TACK, AND MATCH EXISTING PAVEMENT AT LOCATIONS WHERE NEW PAVEMENT MEETS EXISTING PAVEMENT.
- REFERENCE STRUCTURAL SPECIFICATIONS AND GEOTECHNICAL REPORT FOR BUILDING PAD PREPARATION AND COMPAKTING.
- THE CONTRACTOR IS RESPONSIBLE FOR REPAIRS OF DAMAGE TO ANY EXISTING IMPROVEMENTS DURING CONSTRUCTION, SUCH AS BUT NOT LIMITED TO, UTILITIES, PAVING, STRIPPING, CURB, ETC. REPAIRS SHALL BE EQUAL TO OR BETTER THAN EXISTING CONDITIONS.
- THE CONTRACTOR SHALL COORDINATE FOR RELOCATING LOGS PROVIDED BY THE CLIENT.
- THE CONTRACTOR SHALL RELOCATE LOGS PROVIDED BY THE CLIENT.
- ALL STORM SEWER MANHOLES IN PAVED AREAS SHALL BE FLUSH WITH PAVEMENT AND SHALL HAVE TRAFFIC BEARING RINGS AND COVERS.
- EXISTING MANHOLE TOPS, VALVE BOXES, ETC. TO REMAIN ARE TO BE ADJUSTED AS REQUIRED TO MATCH PROPOSED GRADES. IF NECESSARY, RE-ADJUSTMENTS SHALL BE PERFORMED UPON COMPLETION OF PAVING AND FINE GRADING TO ENSURE A SMOOTH TRANSITION.
- THERE WILL BE NO N.P.D.E.S. PERMIT FOR STORM WATER DISCHARGE ASSOCIATED WITH CONSTRUCTION ACTIVITIES FOR THIS SITE. SITE IS 69 ACRES.
- THE CONTRACTOR SHALL ASSURE POSITIVE DRAINAGE AWAY FROM BUILDING AND FOR ALL NATURAL AND PAVED AREAS.

UTILITY NOTES:


- THE CONTRACTOR IS SPECIFICALLY CAUTIONED THAT THE LOCATION AND/OR ELEVATION OF EXISTING UTILITIES (ABOVE AND BELOW GROUND) AS SHOWN ON THESE PLANS IS BASED ON RECORD ON EITHER THE VARIOUS UTILITY COMPANIES, VISUAL OBSERVATIONS AT THE SITE, EXISTING SURVEYS AND/OR WHERE POSSIBLE. MEASUREMENTS TAKEN IN THE FIELD THE INFORMATION IS NOT TO BE RELIED ON AS BEING EXACT OR COMPLETE. IT SHALL BE THE RESPONSIBILITY OF THE CONTRACTOR TO DETERMINE THE EXACT LOCATIONS OF EXISTING UTILITIES (ABOVE AND BELOW GROUND) BEFORE BEGINNING ANY CONSTRUCTION. THE CONTRACTOR MUST CALL THE APPROPRIATE UTILITY COMPANY AT LEAST EIGHTY-FOUR HOURS (48 HRS) BEFORE ANY EXCAVATION TO REQUEST EXACT FIELD LOCATION OF UTILITIES. IT SHALL BE THE RESPONSIBILITY OF THE CONTRACTOR TO RELOCATE ALL EXISTING UTILITIES WHICH CONFLICT WITH THE PROPOSED IMPROVEMENTS SHOWN ON THE PLANS.
- THE CONTRACTOR SHALL VERIFY HORIZONTAL AND VERTICAL LOCATION OF ALL EXISTING STORM SEWER STRUCTURES, PIPES AND ALL UTILITIES PRIOR TO CONSTRUCTION. THE DESIGN LOCATIONS SHALL BE REPORTED TO THE A/E OF RECORD PRIOR TO CONSTRUCTION.
- THE CONTRACTOR SHALL REMOVE OR RELOCATE WHEN APPLICABLE, ALL EXISTING BUILDINGS, FOUNDATIONS, CONNECTING IMPROVEMENTS, DRAINPIPES, SANITARY SEWER PIPE, POWER POLES AND GUY WIRES, WATER METERS AND WATER LINES, WELLS, SIDEWALKS, SIGN POLES, UNDERGROUND GAS, SEPTIC TANKS, AND ASPHALT, SHOWN AND NOT SHOWN, WITHIN CONSTRUCTION LIMITS AND WHERE NEEDED, TO ALLOW FOR FILL MATERIAL, UNLESS OTHERWISE NOTED, TO BE REMOVED AS UNCLASSIFIED EXCAVATION.
- THE CONTRACTOR IS RESPONSIBLE FOR REPAIRS OF DAMAGE TO ANY EXISTING IMPROVEMENTS DURING CONSTRUCTION, SUCH AS BUT NOT LIMITED TO, UTILITIES, PAVING, STRIPPING, CURB, ETC. REPAIRS SHALL BE EQUAL TO OR BETTER THAN EXISTING CONDITIONS.
- THE CONTRACTOR SHALL COORDINATE FOR RELOCATING LOGS PROVIDED BY THE CLIENT.
- THE CONTRACTOR SHALL COORDINATE FOR RELOCATING LOGS PROVIDED BY THE CLIENT.
- THE CONTRACTOR SHALL ASSURE POSITIVE DRAINAGE AWAY FROM BUILDING AND FOR ALL NATURAL AND PAVED AREAS.
- THE SITE CONTRACTOR TO COORDINATE PROPOSED RELOCATIONS OF UTILITIES WITH THE RESPECTIVE UTILITY COMPANIES AND A/E INSPECTING AUTHORITIES.
- THE CONTRACTOR SHALL CONDUCT ALL REQUIRED TESTS TO THE SATISFACTION OF THE RESPECTIVE UTILITY COMPANIES AND A/E INSPECTING AUTHORITIES.
- THE SITE CONTRACTOR TO COORDINATE PROPOSED RELOCATIONS OF UTILITIES WITH THE RESPECTIVE UTILITY COMPANIES AND A/E INSPECTING AUTHORITIES.
- THE CONTRACTOR SHALL PROVIDE BOLLARDS FOR PROTECTION OF ALL ABOVE GROUND UTILITIES AND APPURTENANCES ADJACENT TO DRIVE AREAS.
- IT IS THE CONTRACTOR'S RESPONSIBILITY FOR ANY AND ALL EXPENSES THAT RESULT FROM DELAYED OR FAILED TEST DURING ANY PHASE OF THE CONSTRUCTION PROCESS. THIS INCLUDES FEES INCURRED THROUGH RESCHEDULING OF ANY EQUIPMENT TO ACCOMMODATE.
- ALL WATER AND SANITARY SEWER CROSSINGS TO BE PERPENDICULAR WITH A FULL STICK OF DUCTILE IRON PIPE IN THE SEWER LINES AT THE CROSSING OR AS INDICATED ON THE PLANS.
- THE CONTRACTOR SHALL PROVIDE BOLLARDS FOR PROTECTION OF ALL ABOVE GROUND UTILITIES AND APPURTENANCES ADJACENT TO DRIVE AREAS.
- GEOTECHNICAL REPORT INCLUDED IN THESE DOCUMENTS. ALL GEOTECHNICAL GUIDANCE IN THE REPORT IS A BINDING PART OF THIS CONTRACT.

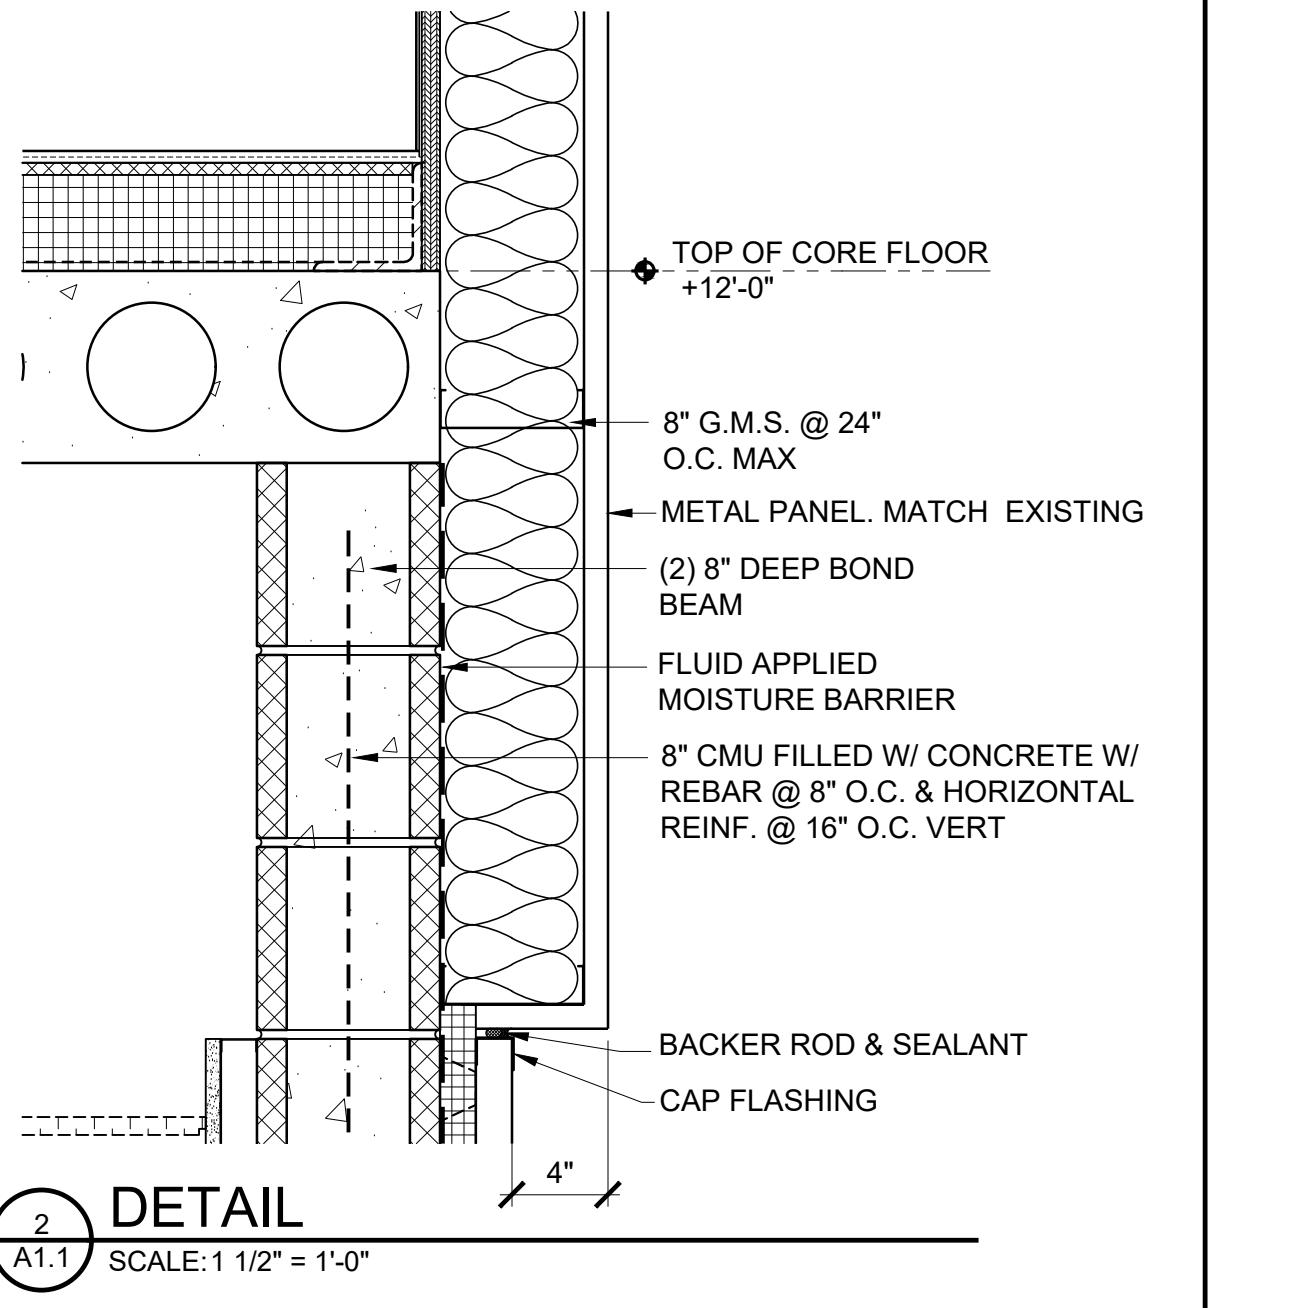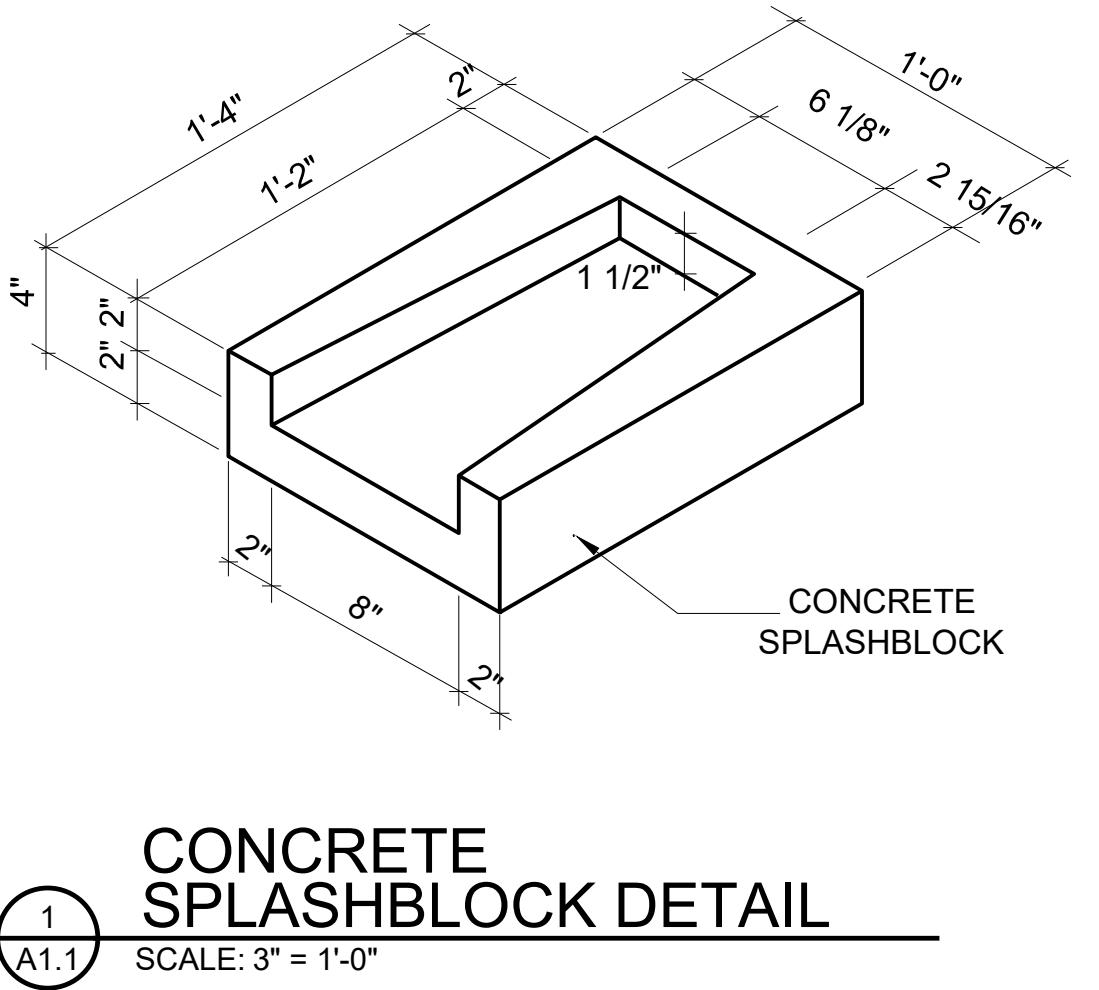

TOILET ACCESSORY SCHEDULE		ALL ACCESSORIES TO BE FROM SINGLE MANUFACTURER SERIES. BOBRICK BASIS OF DESIGN
MARK	ITEM DESCRIPTION	MOUNTING HEIGHTS
①	CHANNEL-FRAME MIRROR - BRADLEY - 781-1830	40" A.F.F. TO BOTTOM OF REFLECTIVE SURFACE
②	SURFACE MOUNTED SOAP DISPENSER - BRADLEY - 6542	47" A.F.F. TO TOP OF UNIT
③	SURFACE MOUNTED TOWEL DISPENSER - BRADLEY - 250-15	40" A.F.F. TO BOTTOM OF UNIT
④	SURFACE-MOUNTED MULTI-ROLL TOILET TISSUE DISPENSER BOBRICK - B-288	28" A.F.F. TOP OF UNIT
⑤	18" VERTICAL GRAB BAR	39"-41" A.F.F.
⑥	36" GRAB BAR	33"-36" A.F.F.
⑦	42" GRAB BAR	33"-36" A.F.F.

WORK NOTES

- FURNISH AND INSTALL RAISED COMPUTER FLOORING. SEE SPECS.
- FURNISH AND INSTALL 4" BROOMED FINISH CONCRETE SLAB. SEE STRUCTURAL FOR REINFORCING. SLOPE TO DRAIN AS INDICATED.
- FURNISH AND INSTALL 4" BROOMED FINISH CONCRETE WALK. SEE DETAILS. FLUSH W/ EXISTING CONCRETE WALK.
- FURNISH AND INSTALL 4" BROOMED FINISH CONCRETE STOOP.
- FURNISH AND INSTALL F.R. PLYWOOD BLOCKING FOR WALL MOUNTED DEVICE.
- FURNISH AND INSTALL (UNDER ALTERNATE#1) 1 1/2" FURRING CHANNELS @ 24" O.C. W/ 5/8" GYP. BOARD. M.R. GYP BOARD @ WET AREAS. CMU WALL SHALL RECEIVE PAINT IF ALTERNATE IS NOT TAKEN.
- EXTEND 3 1/2" STUD W/ 5/8" GYP. BOARD WALL TO UNDERSIDE OF STRUCTURAL CORE FLOOR DECK AND SEAL ALL PENETRATIONS AND JOINTS - SOUND BATT IN CAVITY.
- REMOVE PORTION OF EXISTING EXTERIOR WALL AS REQUIRED TO ACCOMMODATE NEW CONSTRUCTION. SEE STRUCTURAL FOR NEW HEADER DETAILS.
- FURNISH AND INSTALL 3 1/2" WALL STUDS W/ 5/8" BYP. BOARD EA. FACE. SOUND BATT IN CAVITY. EXTEND TO UNDERSIDE OF CORE FLOOR DECK. M.R. GYP BOARD @ WET LOCATIONS. (TOILET/LOCKER 102) SEAL ALL PENETRATIONS
- FURNITURE/WORK STATIONS FURNISHED AND INSTALLED BY OWNER. CONTRACTOR SHALL COORDINATE POWER/DATA W/ MFR/INSTALLER
- FURNISH AND INSTALL NEW RE-INFORCED CONCRETE FLUME. MIN. 4" THICK. FLUME TO BE SLOPED AWAY FROM BUILDING AND FLUSH WITH TOP OF EXISTING CONCRETE WALK.
- FURNISH AND INSTALL NEW BOLLARD TO MATCH EXISTING. COORDINATE FOOTINGS WITH LOCATION AND ROUTING OF ADJACENT WATER LINE. SEE PLUMBING
- RE-INSTALL EXISTING H.C. PARKING SIGNAGE.
- 3 1/2" STUD WALL W/ 5/8" GYP. BOARD EA. SIDE FROM TOP OF RECESSED CONCRETE SLAB TO UNDERSIDE OF STRUCTURAL CORE FLOOR. FIRE/ SMOKE SEAL ALL PENETRATIONS.

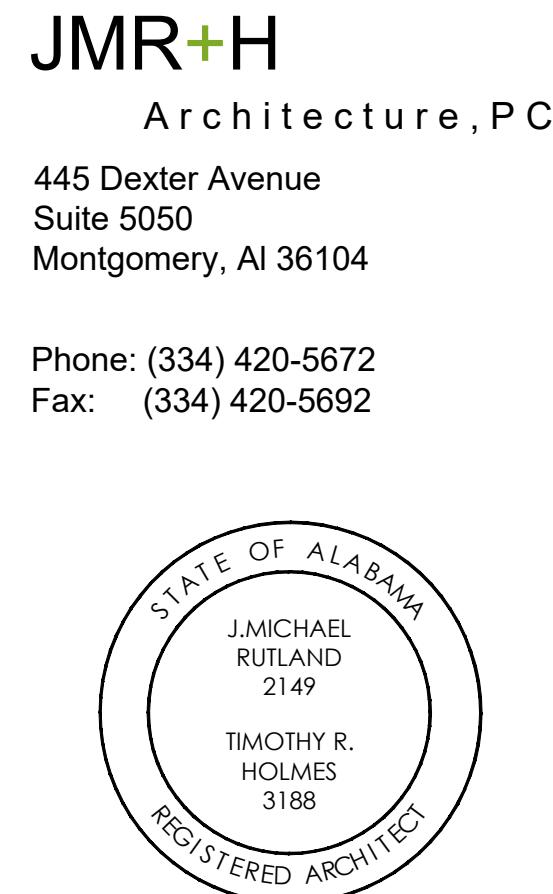

TALLAPOOSA CO E911 ADDITION TO THE TALLAPOOSA COUNTY JAIL FACILITY
 DADEVILLE, AL

CONSTRUCTION DOCUMENTS


Project Number: 25-1465
 Date: 8 JANUARY 2026
 Revisions:

Sheet Description

FLOOR PLAN

Sheet Number

A1.1

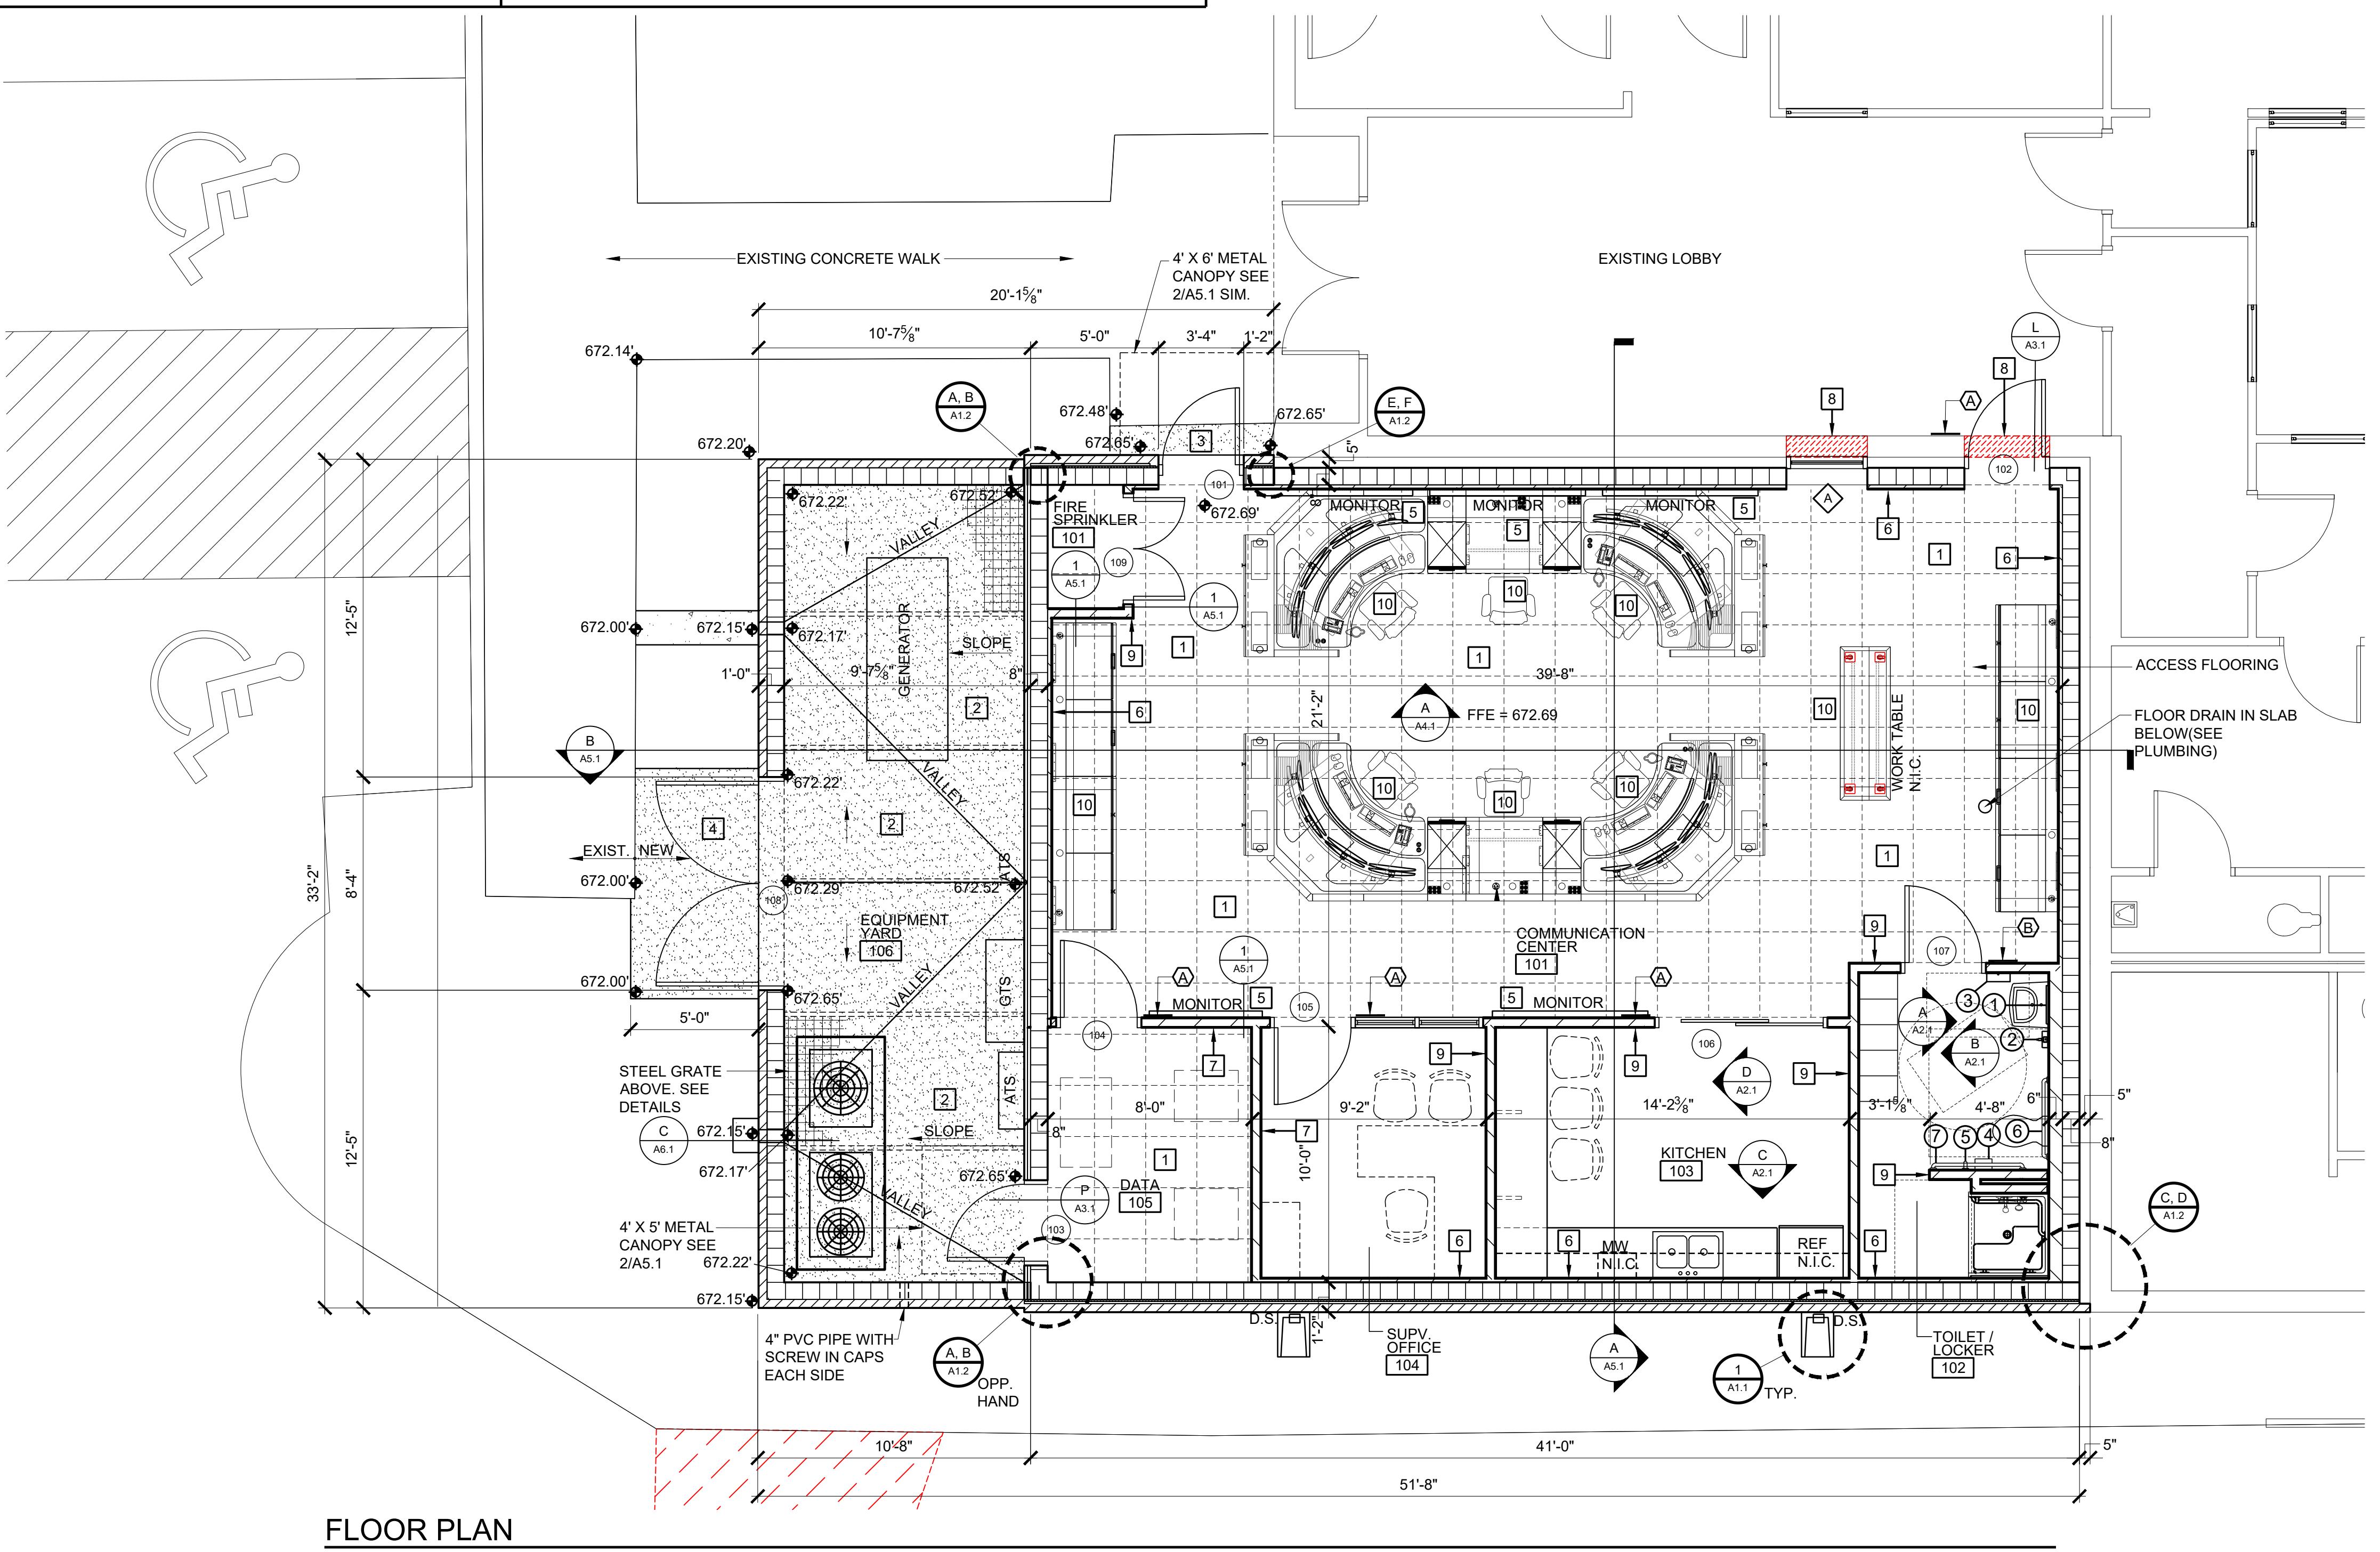

PLAN LEGEND

- ALUMINUM STOREFRONT MARK
- DOOR MARK
- HOLLOW METAL MARK
- ROOM FINISH MARK
- DETAIL OR ELEVATION NUMBER
- 205 SHEET NUMBER
- ELEVATION KEY
- SECTION KEY
- DETAIL KEY
- PLAN OR SECTION ENLARGEMENT
- STEEL STUD WALL
- C.M.U. WALL
- WALL TYPE
- FIRE EXT. CABINET

**TALLAPOOSA
CO E911
ADDITION TO
THE
TALLAPOOSA
COUNTY JAIL
FACILITY**

DADEVILLE, AL

**CONSTRUCTION
DOCUMENTS**

Project Number: 25-1465

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Revisions:







Sheet Description

PLAN DETAILS

Sheet Number

A1.2

PRINTED: 1/17/2026 @ 2:32PM

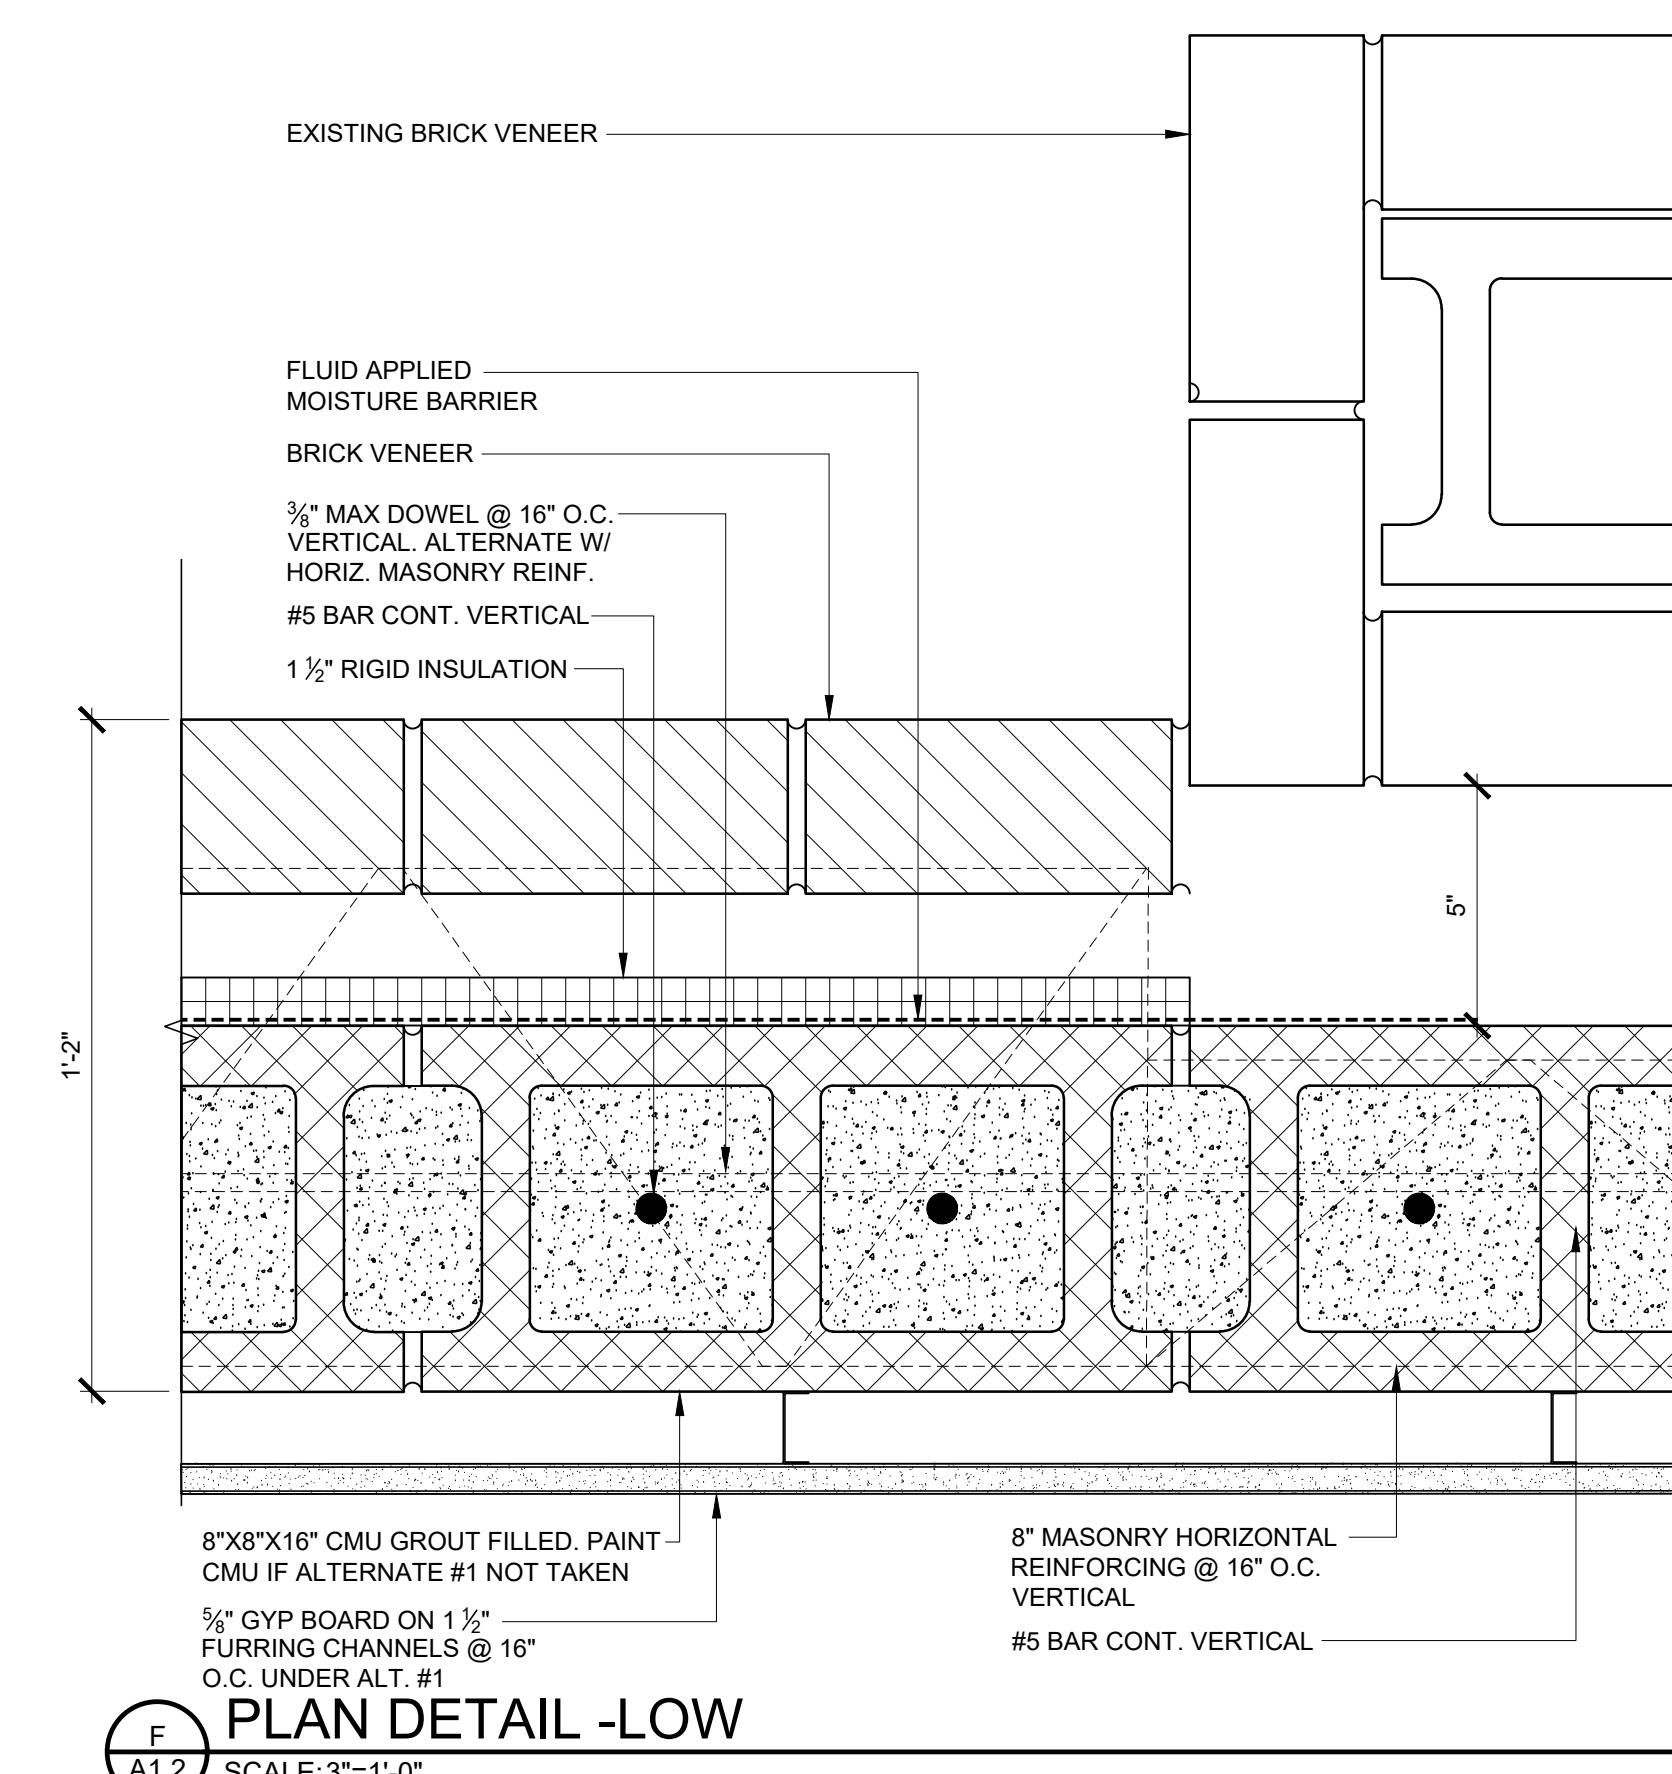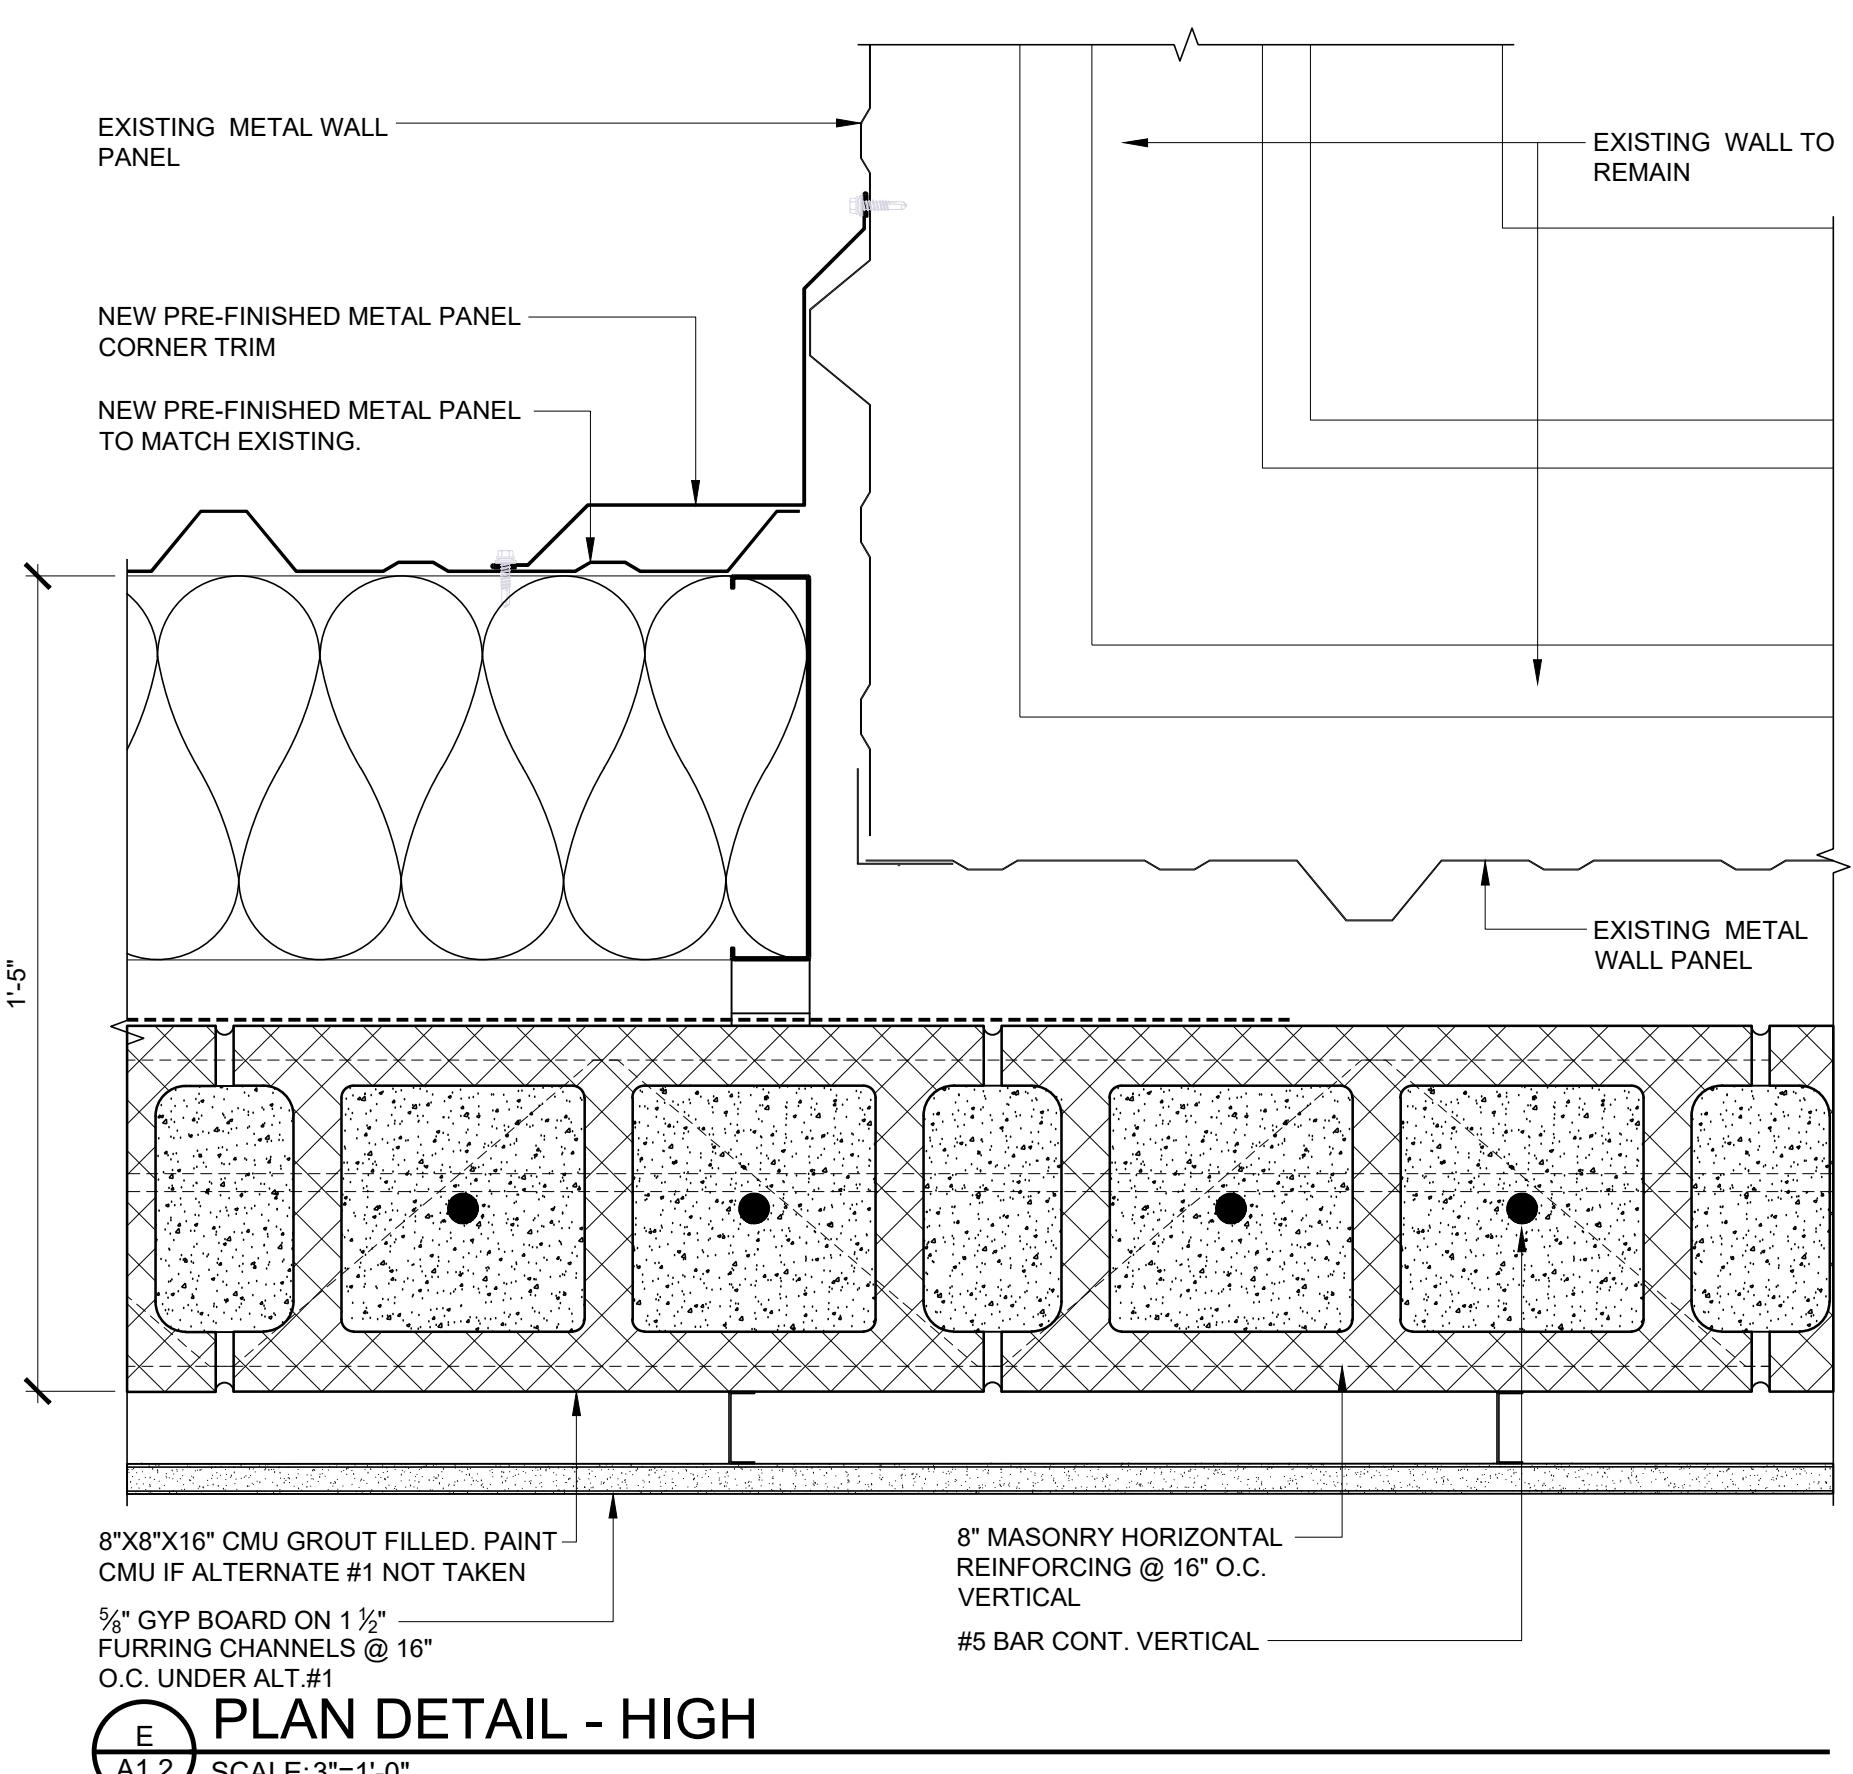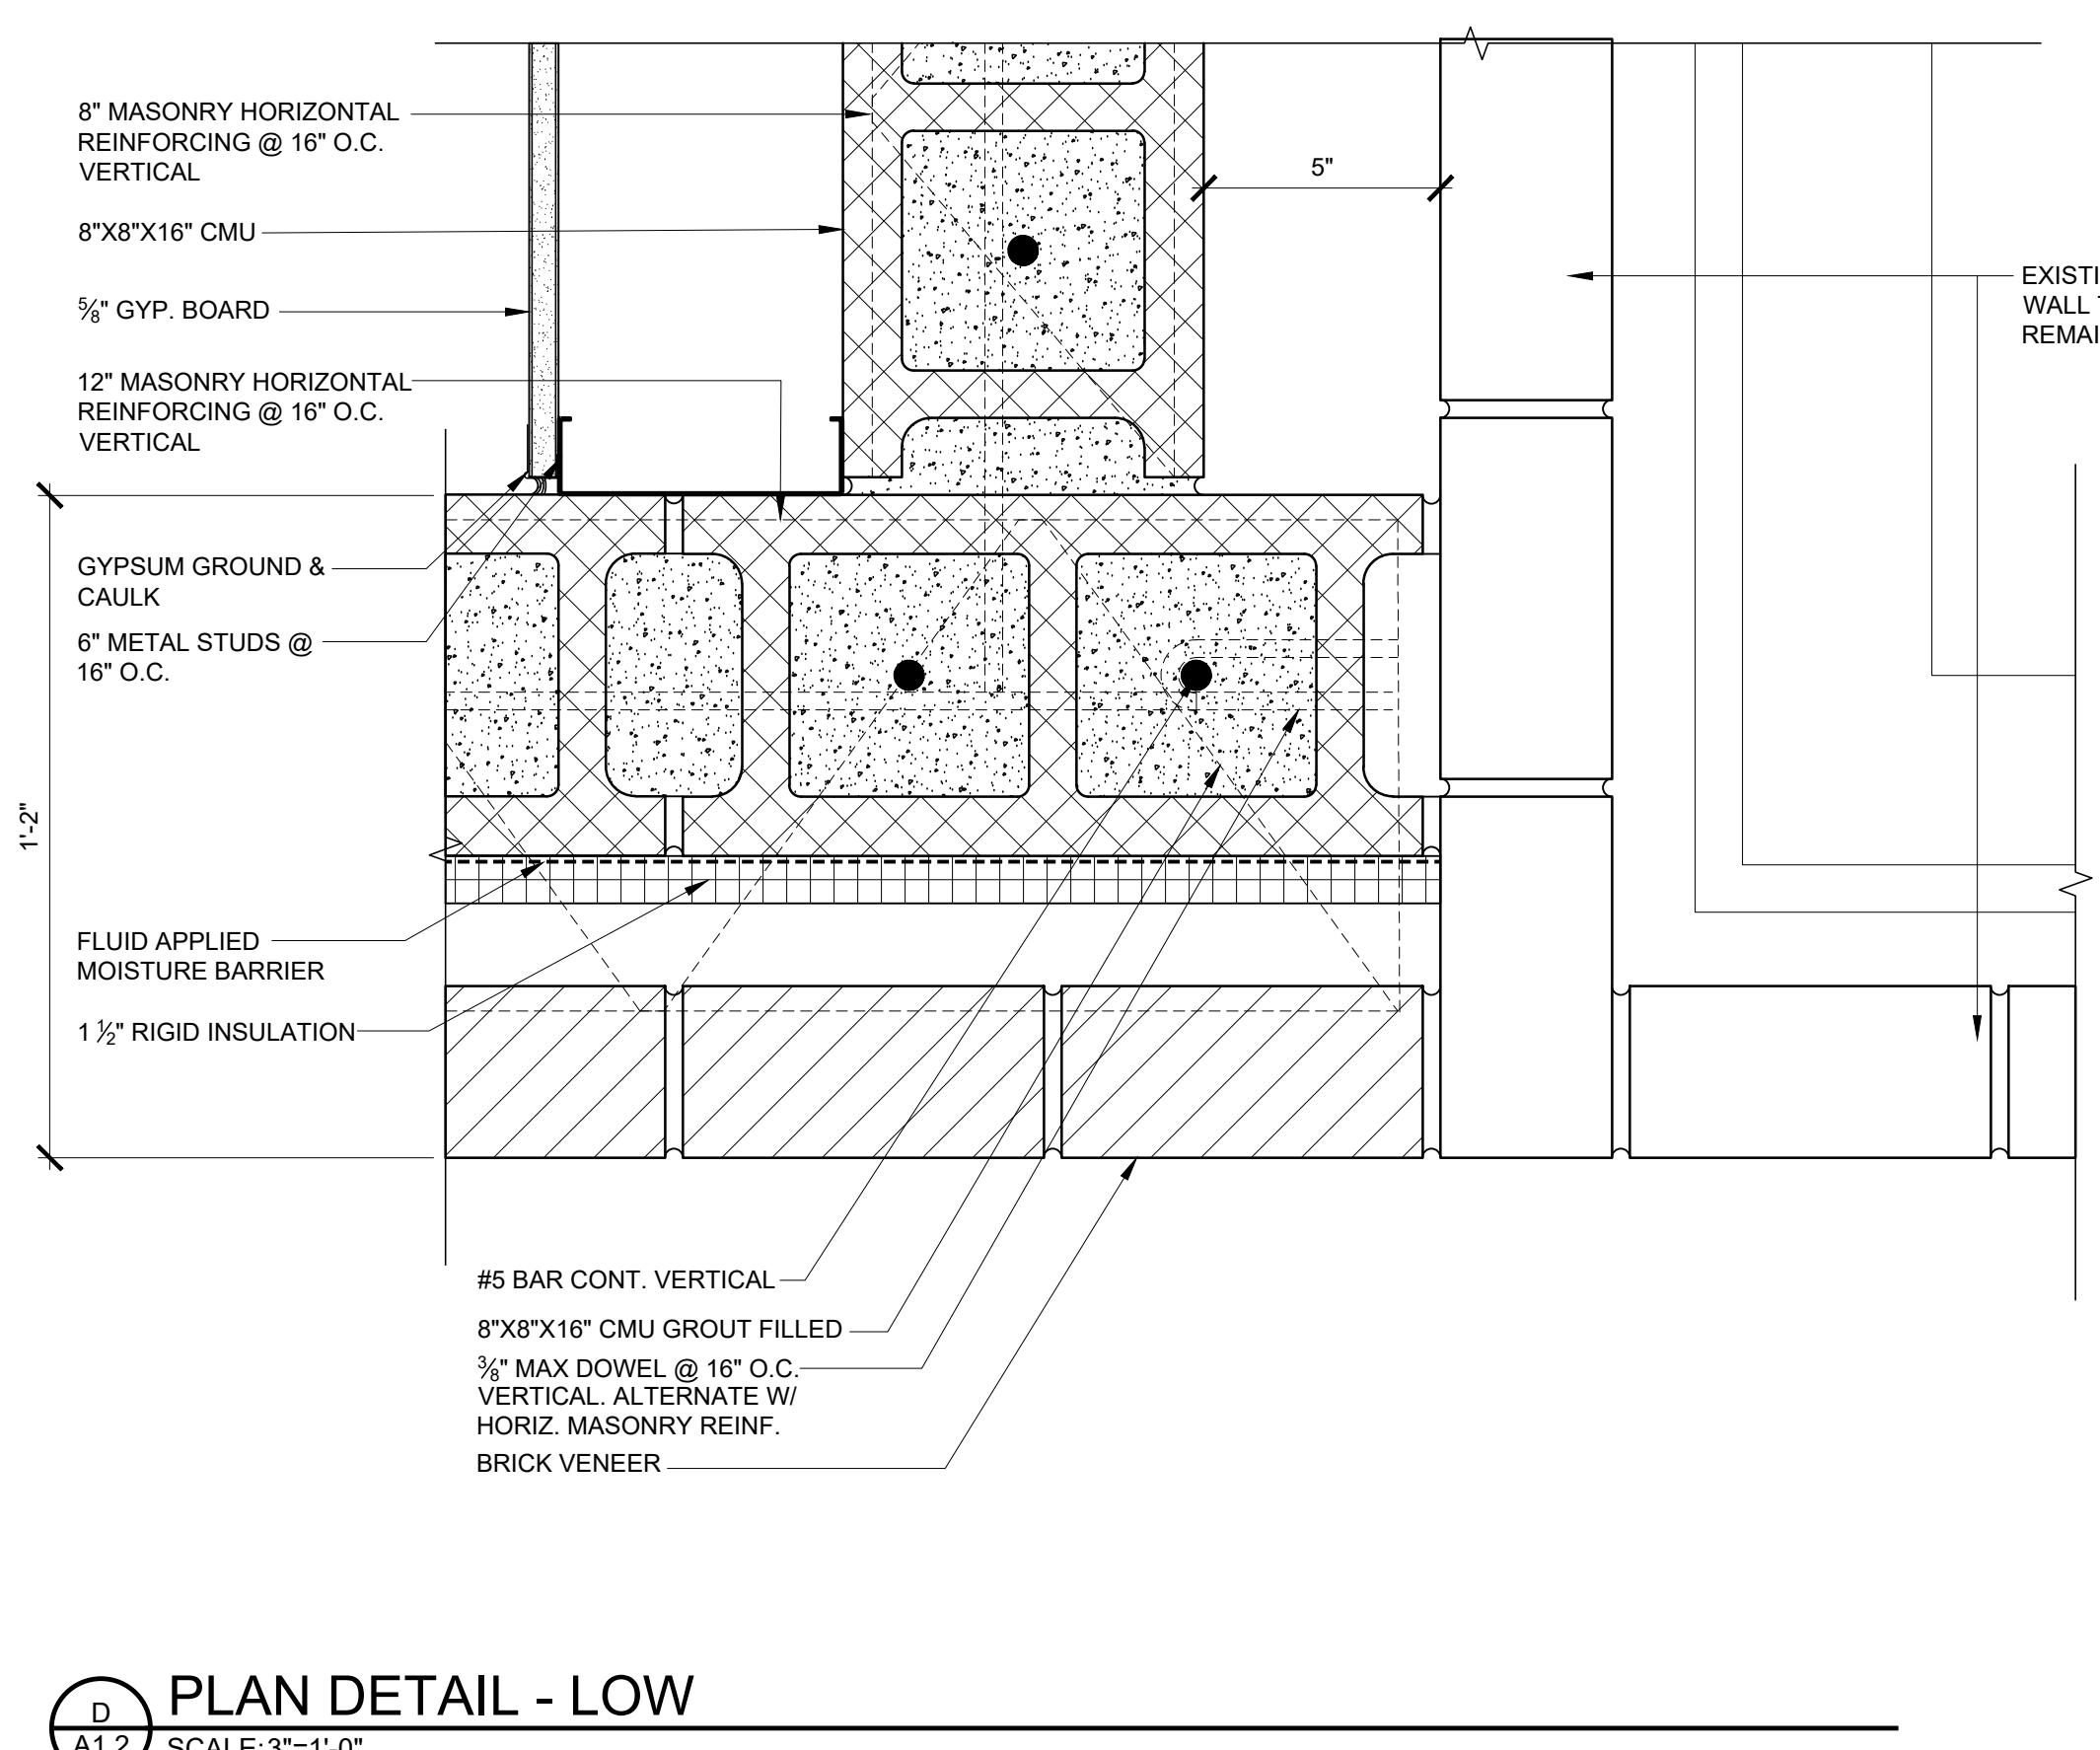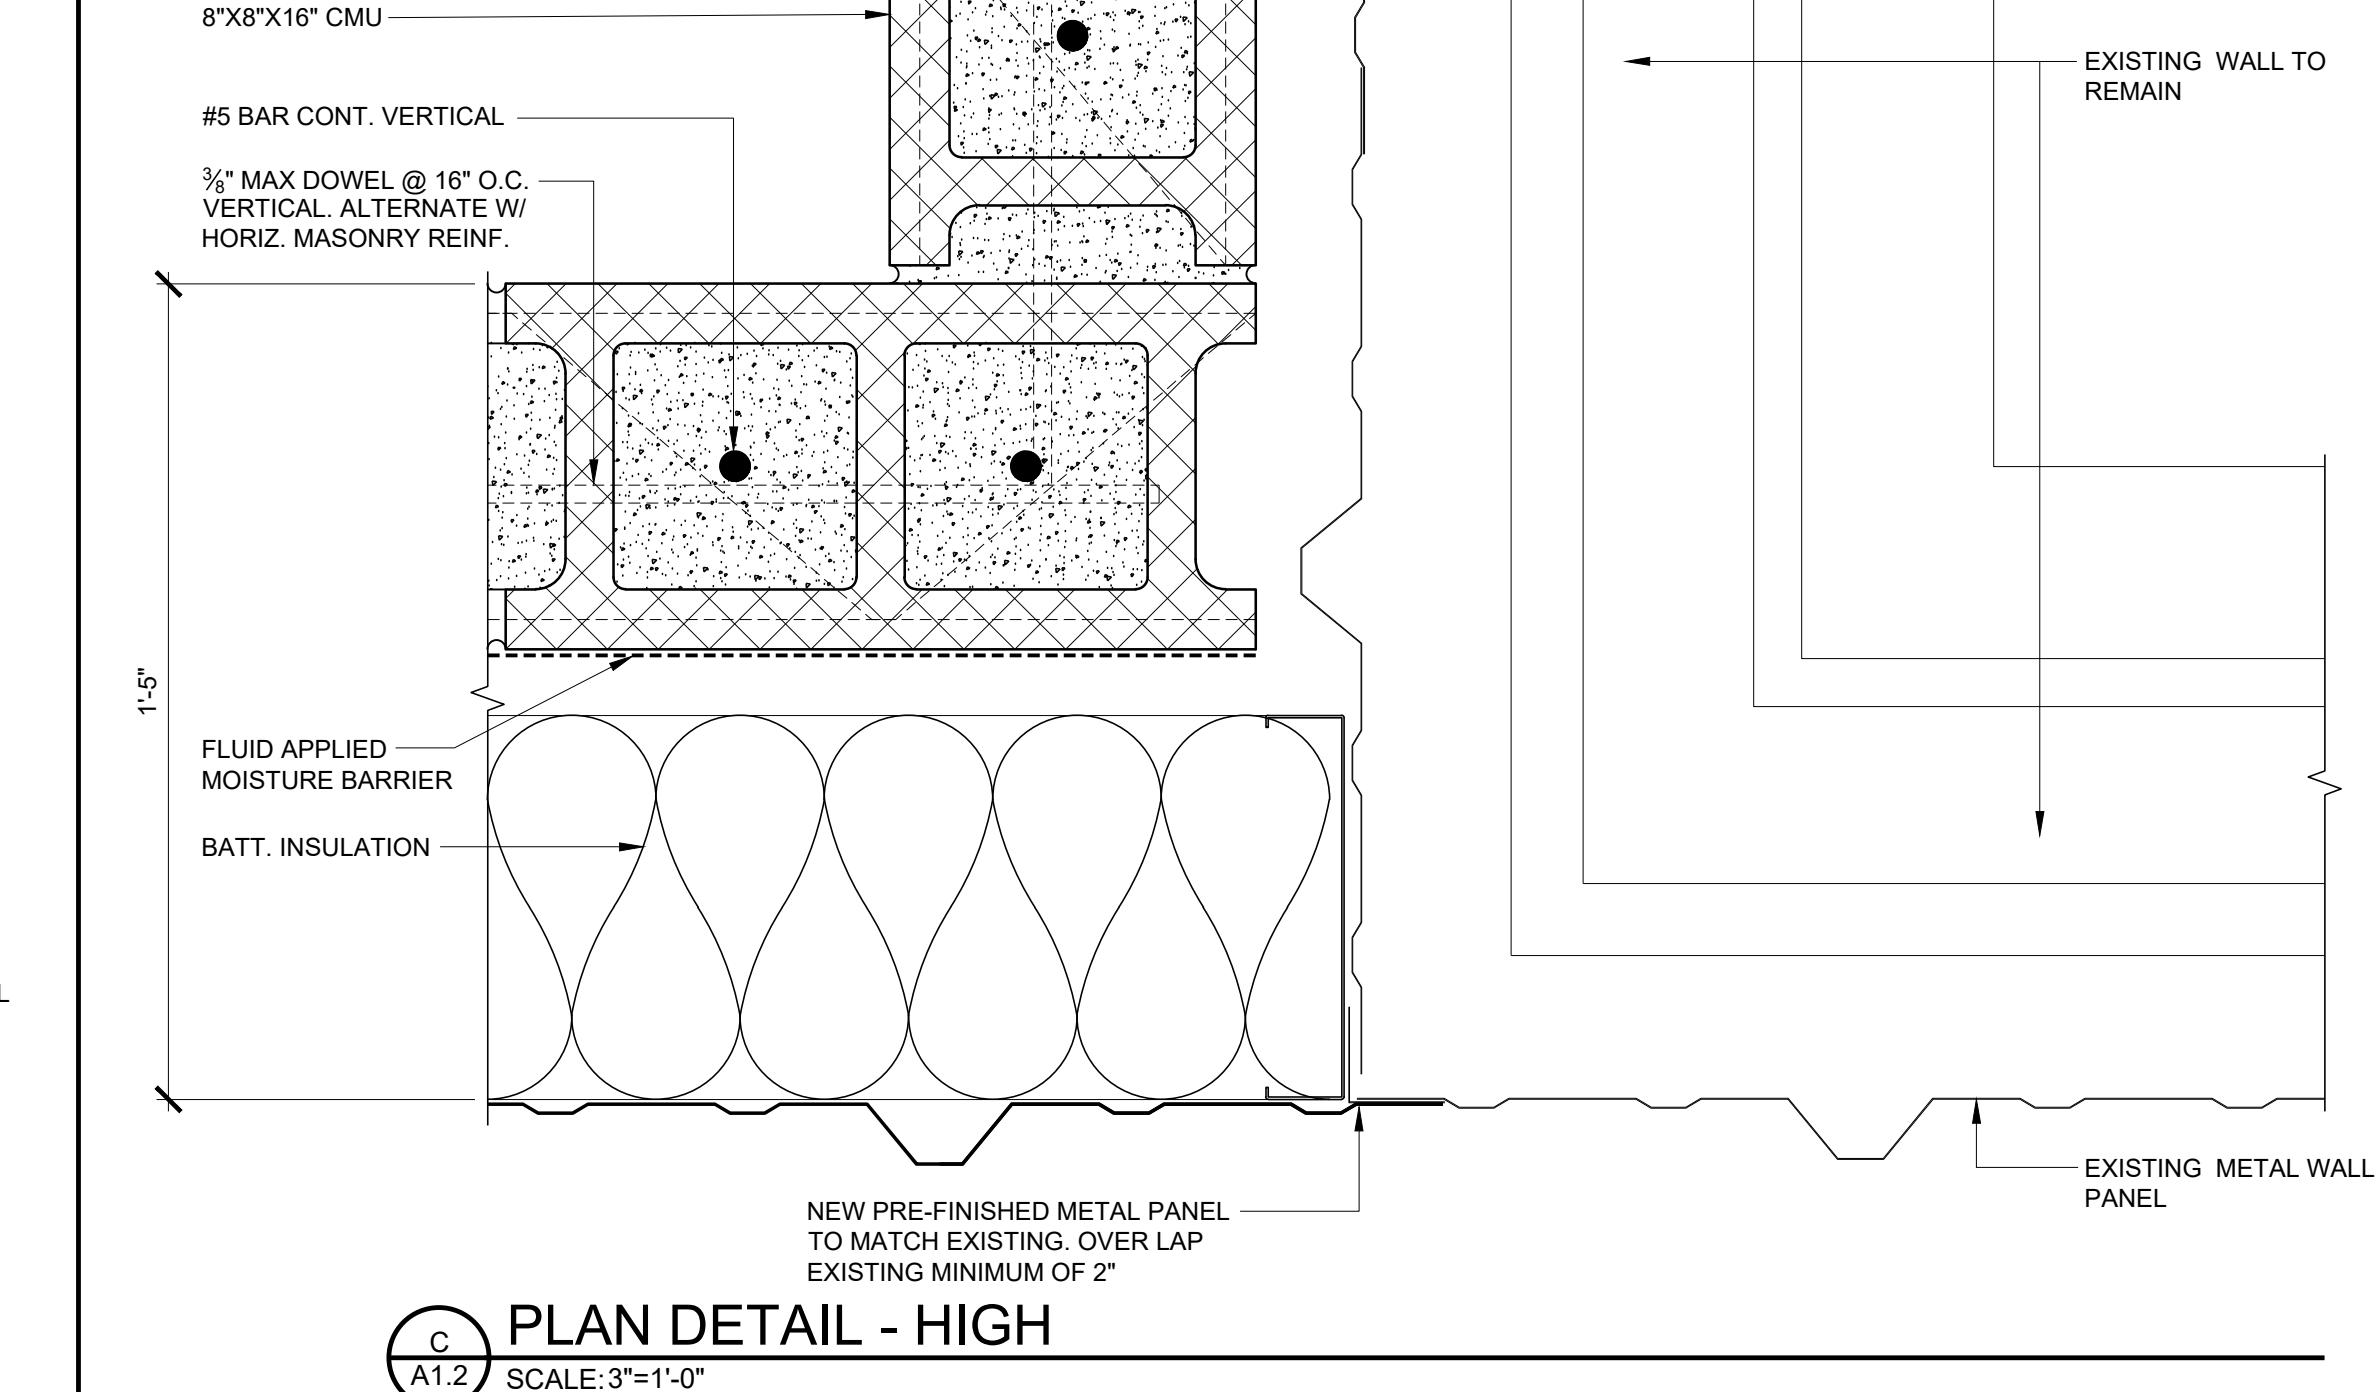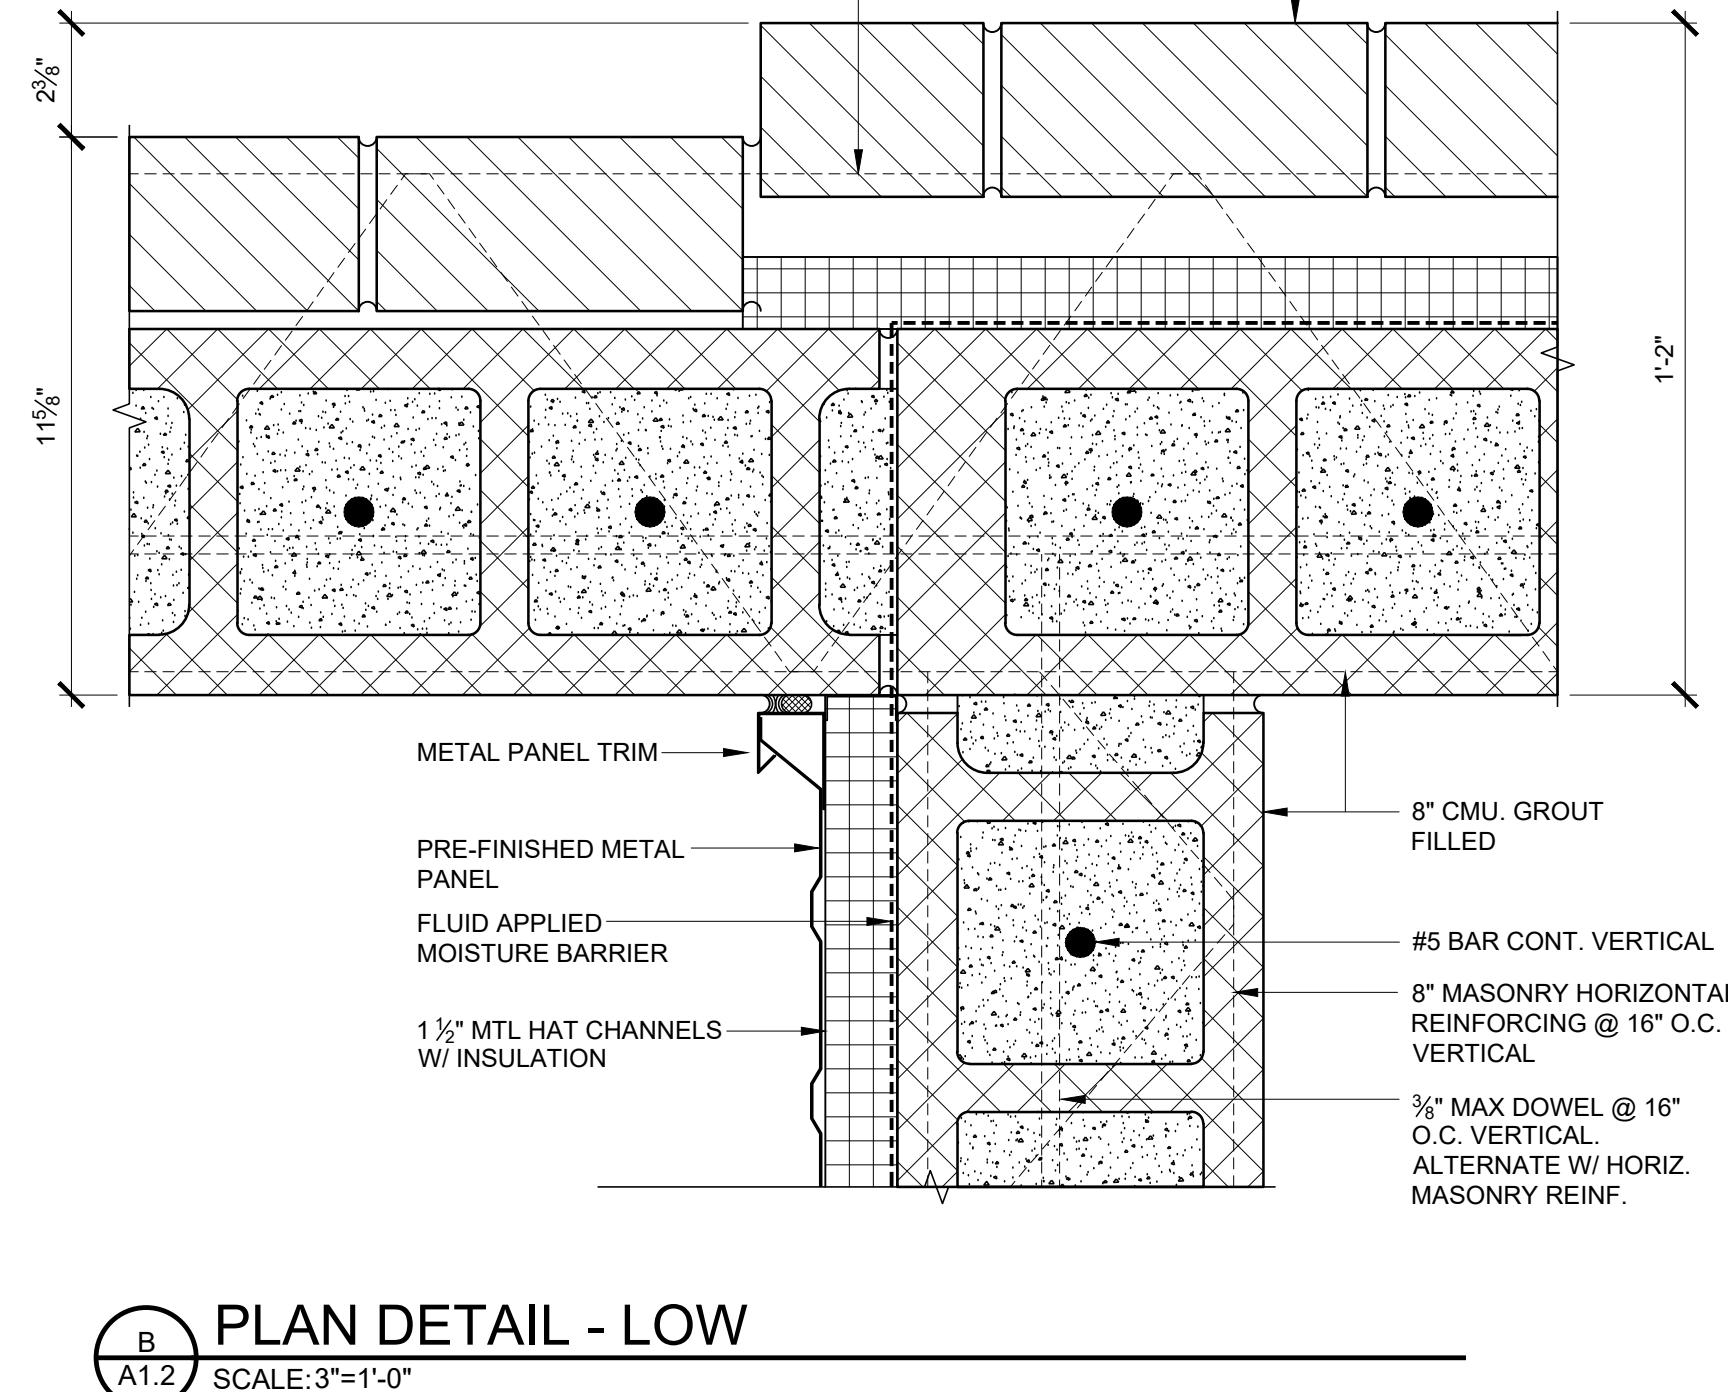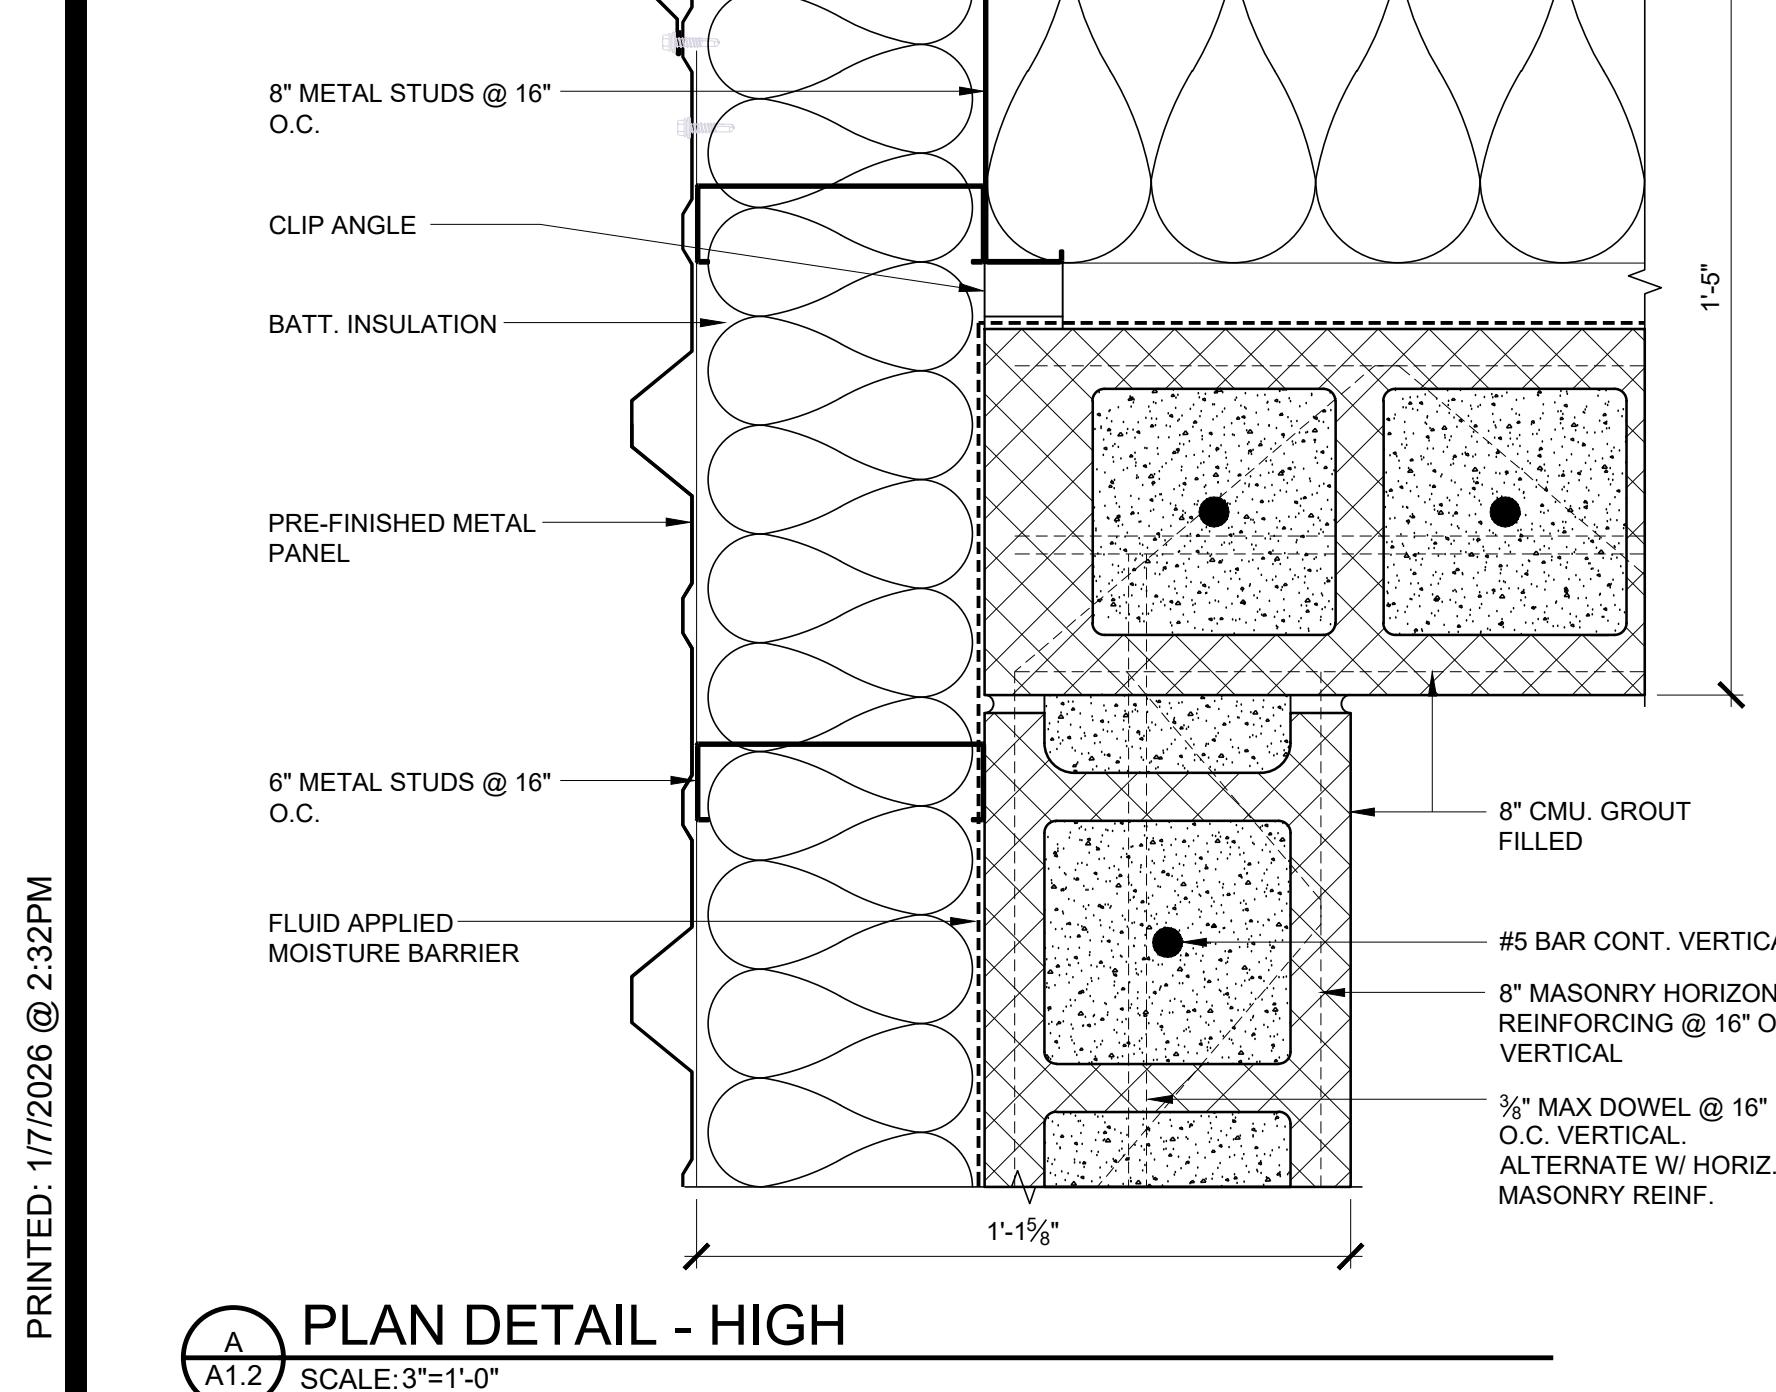

**TALLAPOOSA
CO E911
ADDITION TO
THE
TALLAPOOSA
COUNTY JAIL
FACILITY**
DADEVILLE, AL


**CONSTRUCTION
DOCUMENTS**

Project Number: 25-1465
Date: 8 JANUARY 2026
Revisions:

Sheet Description
**FINISH
SCHEDULE,
INTERIOR
ELEVATIONS,
CABINET
SECTIONS**


Sheet Number

A2.1

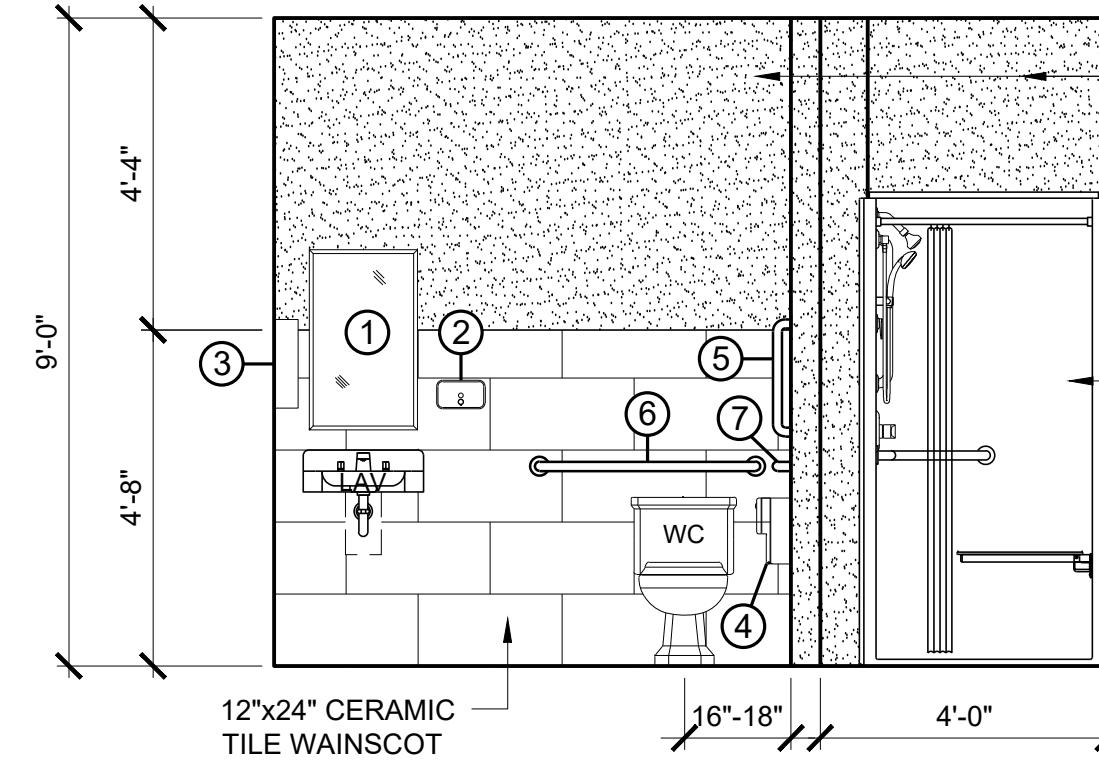


TOILET/ LOCKER 102

A2.1 SCALE: 3/8"=1'-0"

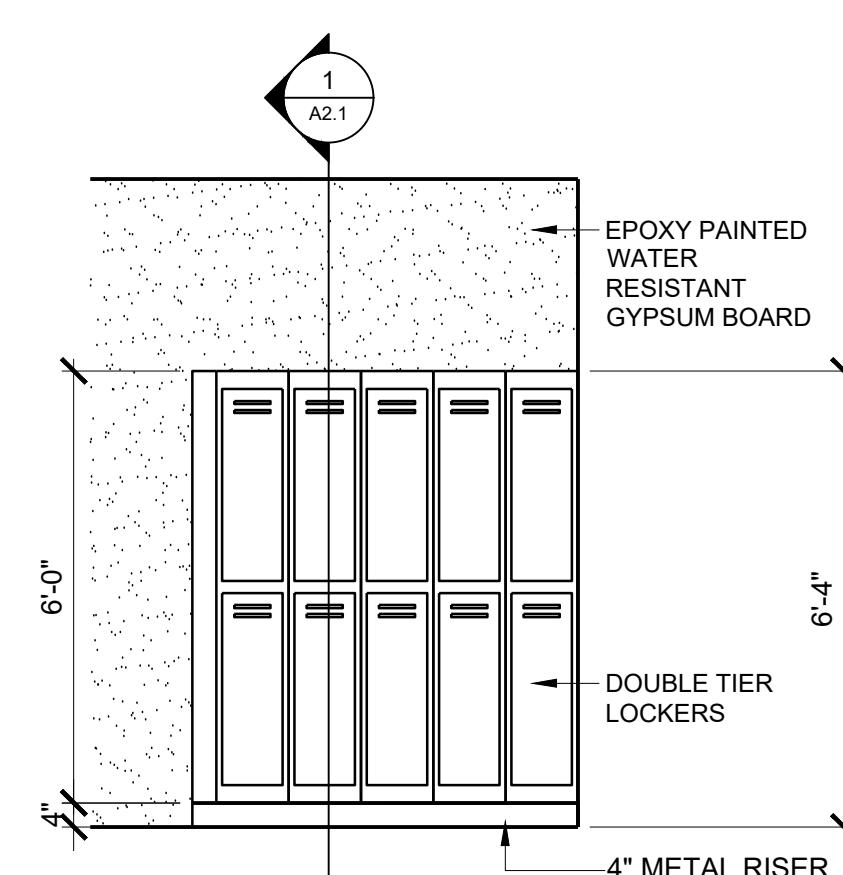


TOILET/ LOCKER 102

A2.1 SCALE: 3/8"=1'-0"

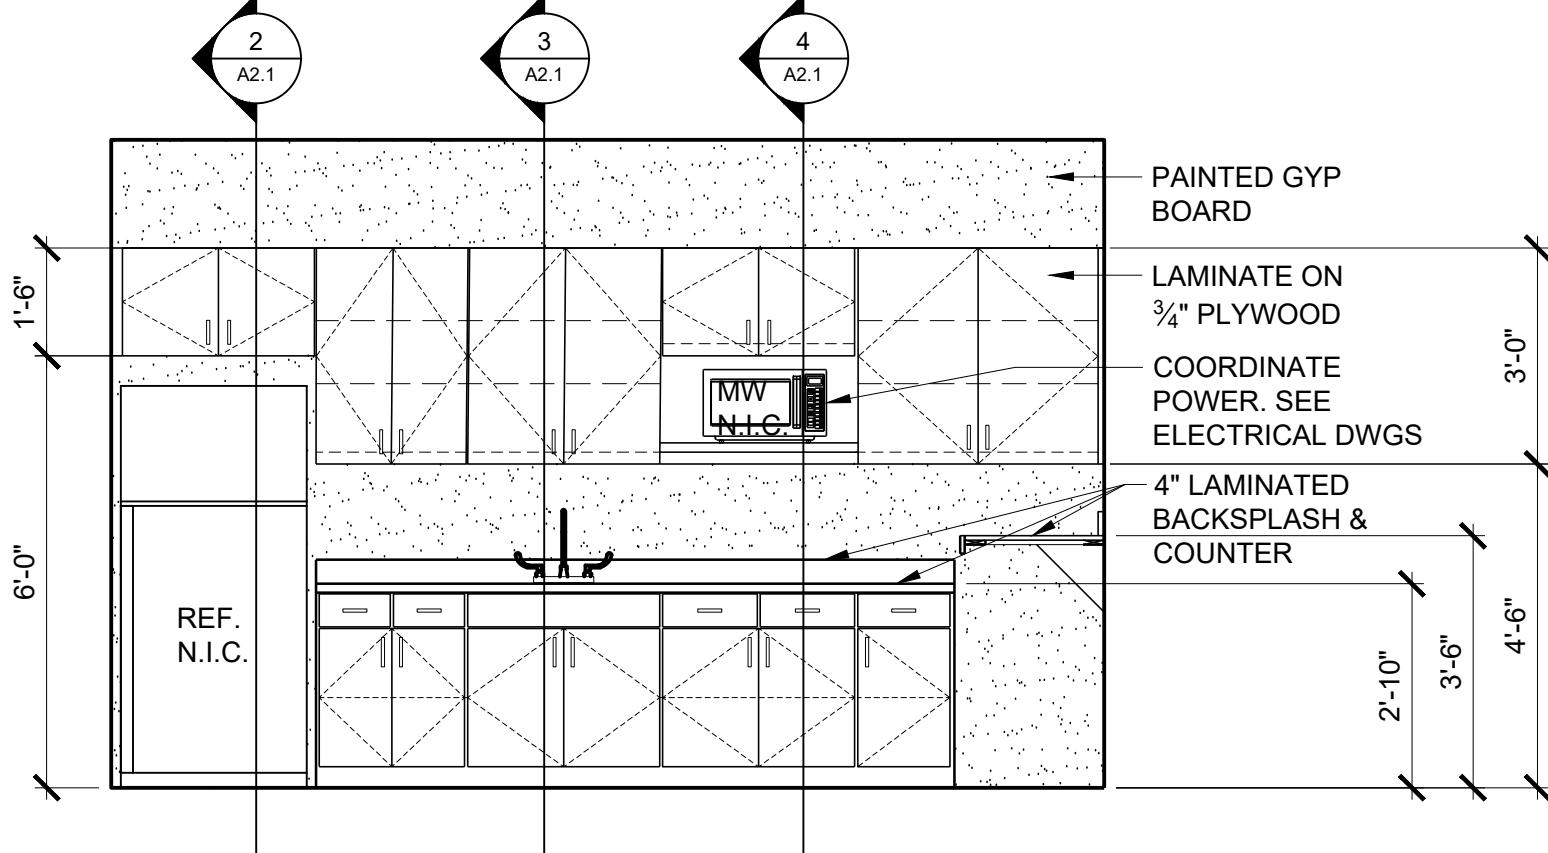


KITCHEN 103

A2.1 SCALE: 3/8"=1'-0"

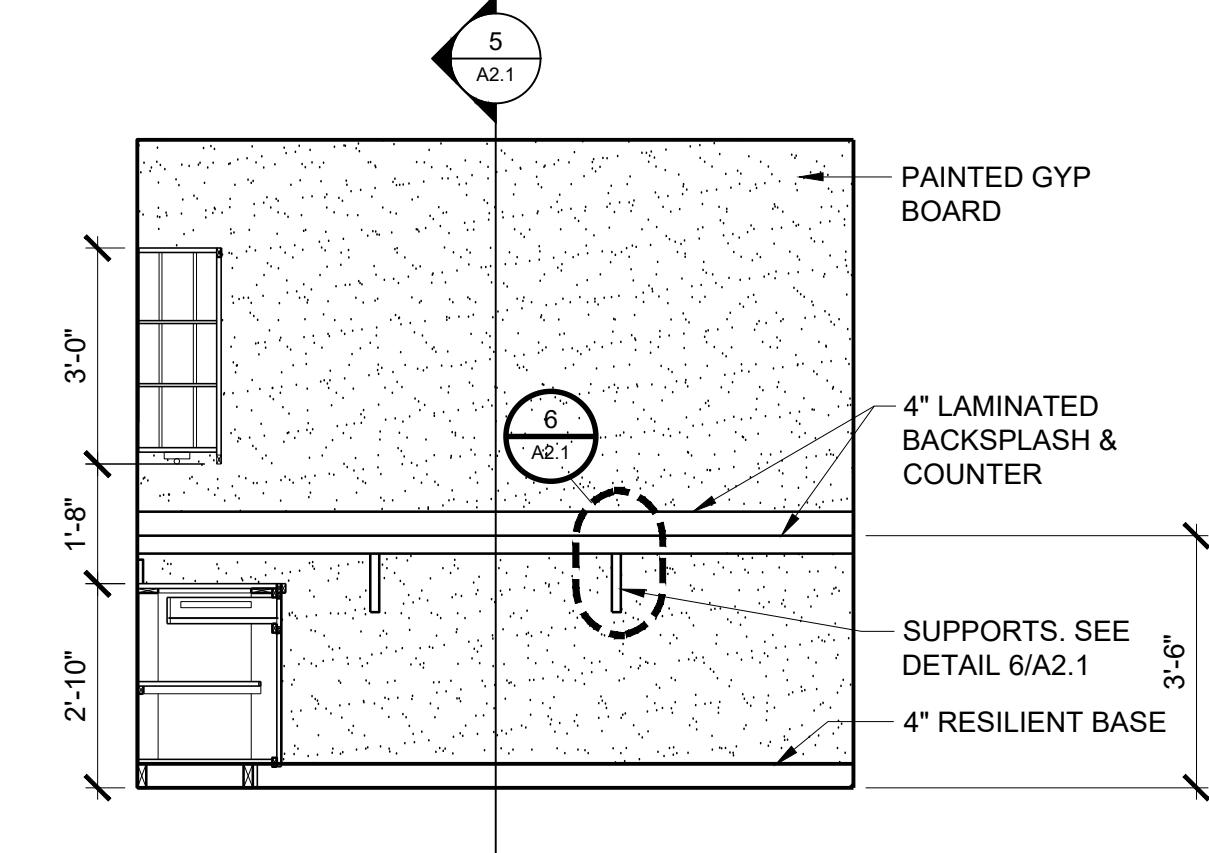


KITCHEN 103

A2.1 SCALE: 3/8"=1'-0"

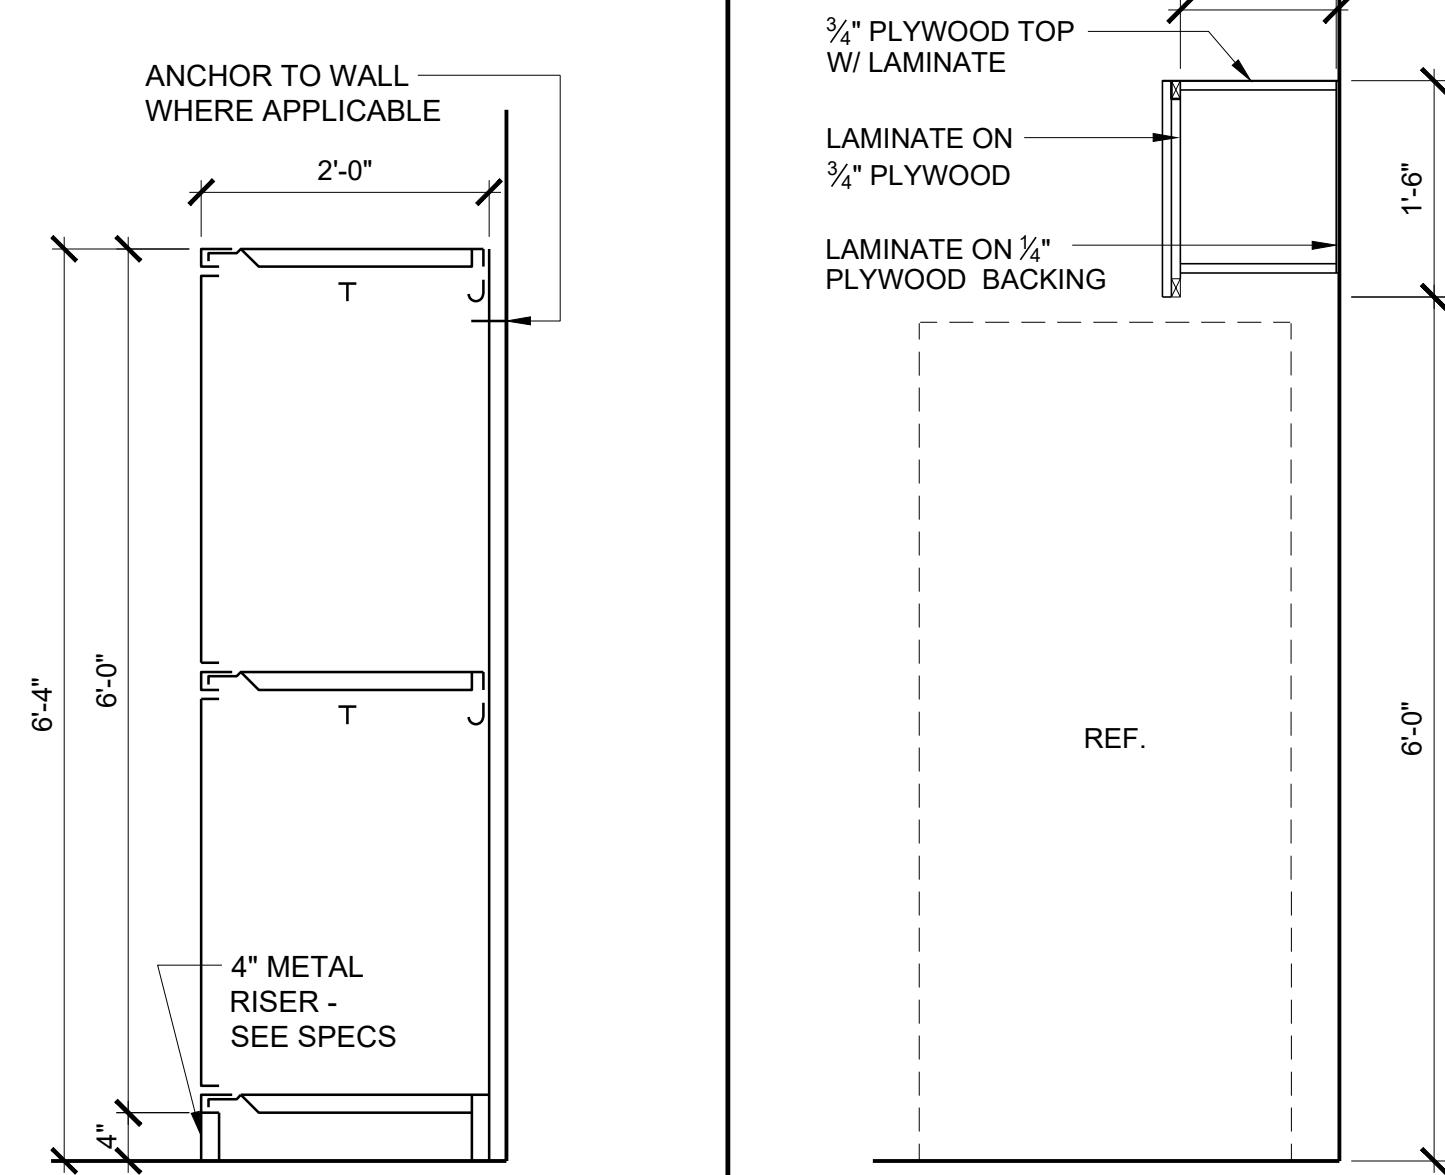


LOCKER SECTION

A2.1 SCALE: 3/4"=1'-0"

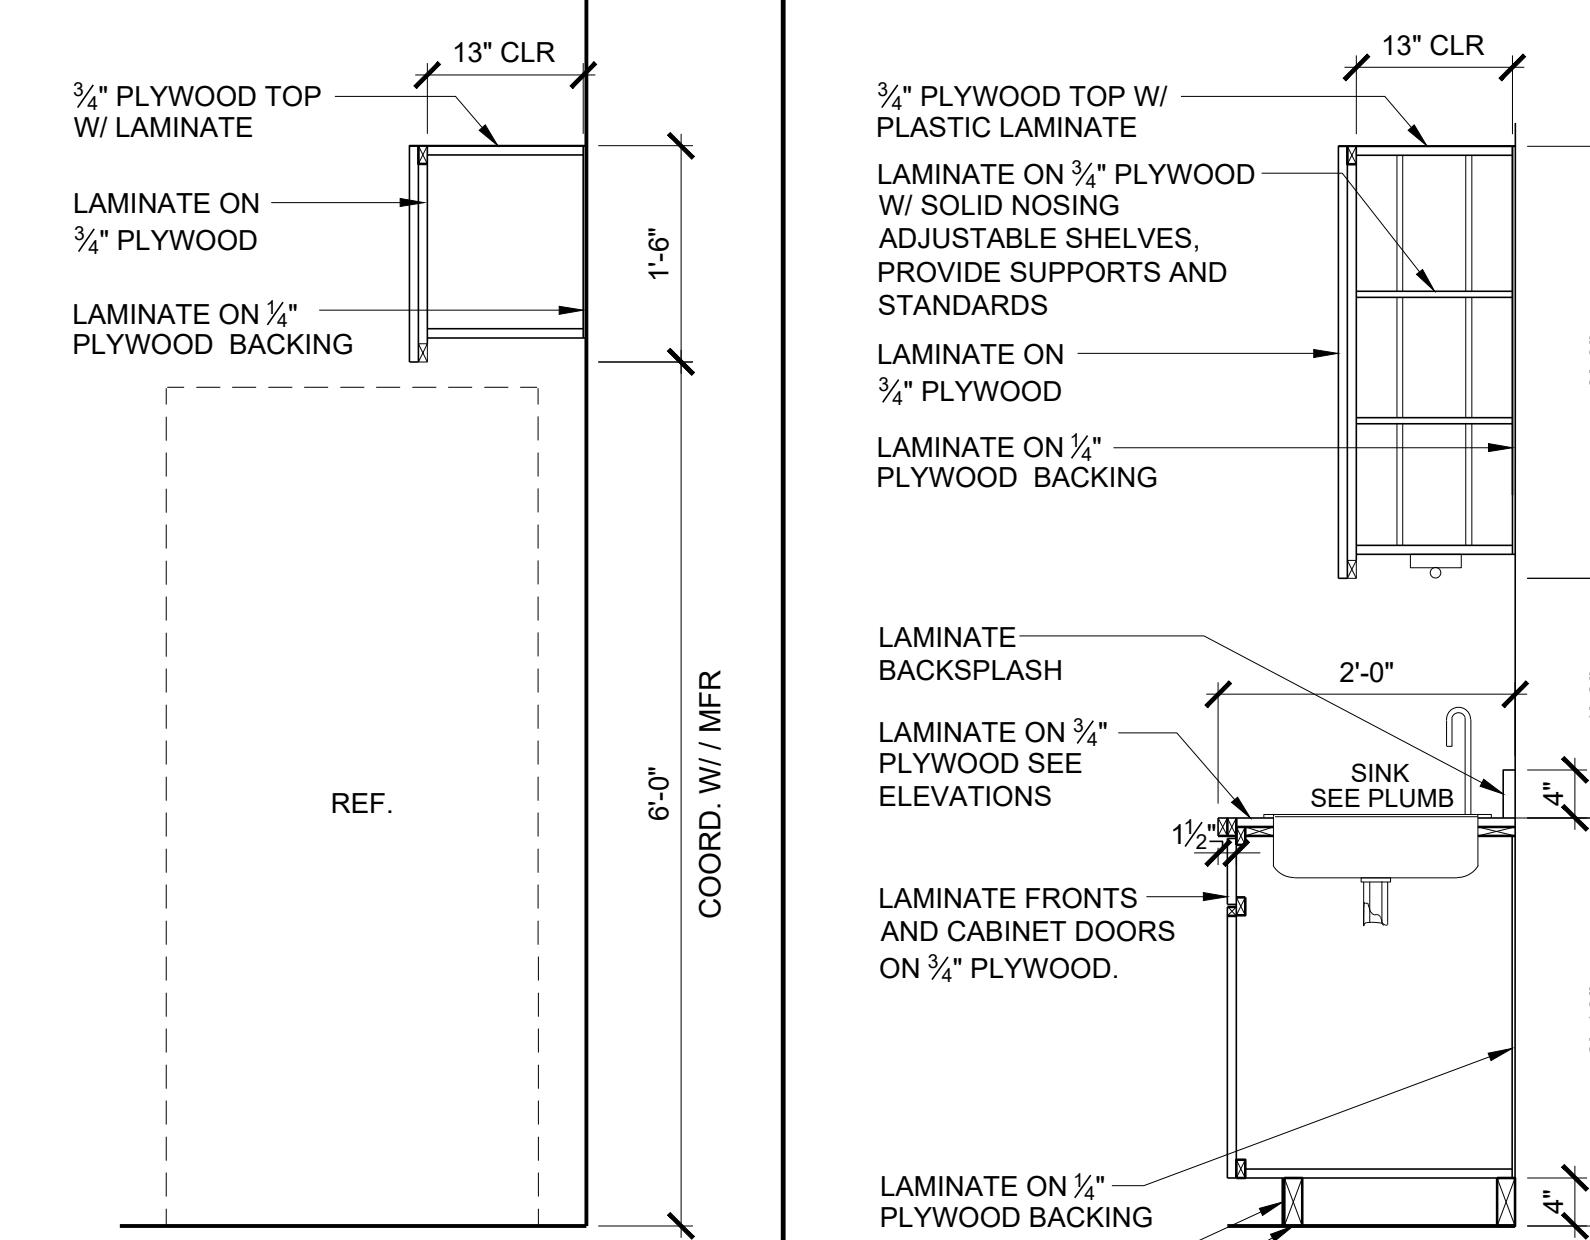

CABINET SECTION

A2.1 SCALE: 3/4"=1'-0"

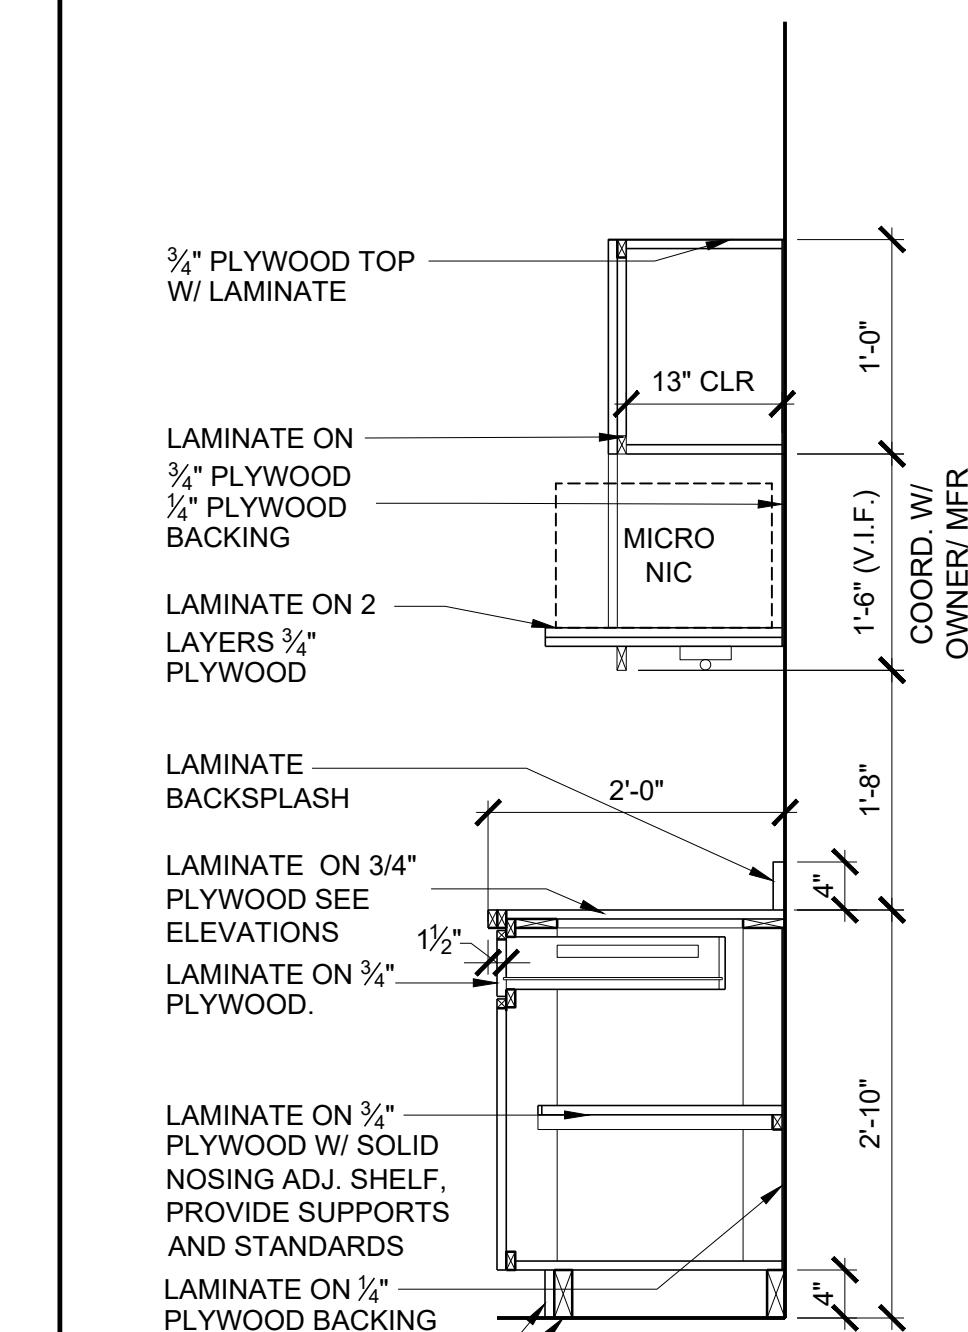

CABINET SECTION

A2.1 SCALE: 3/4"=1'-0"

FINISH SCHEDULE											
ROOM NO.	ROOM NAME	FLOORS	BASE	MILLWORK	WEST WALL	NORTH WALL	EAST WALL	SOUTH WALL	CEILINGS	HEIGHT	REMARKS
101	COMMUNICATION CENTER	HPL-1	RB-1	-	CMU-2	CMU-2	CMU-2	GWB-1	ACT-1/GWB-1	7'-2" / 9'-0"	
102	TOILET/ LOCKER	CT-1	CB-1	-	GWB-2	GWB-2	GWB-2	GWB-1	9'-0"		
103	KITCHEN	LVT-1	RB-1	L-1/L-2	GWB-1	GWB-1	CMU-2	ACT-2	9'-0"		
104	SUPERVISERS OFFICE	LVT-2	RB-1	-	GWB-1	GWB-1	CMU-2	ACT-1	9'-0"		
105	DATA	HPL-1	RB-1	-	GWB-1	GWB-1	CMU-1	EXPOSED	11'-4"		
106	EQUIPMENT YARD	BF-1	RB-1	-	CMU-1	CMU-1	CMU-1	GLV-1	8'-3"		
107	FIRE SPRINKLER	HPL-1	RB-1	-	CMU-2	CMU-2	GWB-1	EXPOSED	11'-4"		

FINISH LEGEND

SYMBOL	MATERIAL	MANUFACTURER	COLOR	REMARKS
--------	----------	--------------	-------	---------

FLOORING				
BF-1	BROOM FINISH CONCRETE			
CT-1	CERAMIC TILE 4'-8" H	DALTILE PORTFOLIO		COLOR TO BE CHOSEN BY ARCHITECT
LVT-1	LUXURY VINYL TILE	TARKETT CENTIVA		COLOR TO BE CHOSEN BY ARCHITECT
LVT-2	LUXURY VINYL TILE	TARKETT CENTIVA		COLOR TO BE CHOSEN BY ARCHITECT
HPL-1	HIGH PRESSURE LAMINATE ACCESS FLOOR			COLOR TO BE CHOSEN BY ARCHITECT

BASE				
RB-1	RUBBER BASE	ROPPE		COLOR TO BE CHOSEN BY ARCHITECT
CB-1	CERAMIC BASE	DALTILE PORTFOLIO		

WALLS				
GWB-1	PAINTED GYPSUM BOARD	SHERWIN WILLIAMS		COLOR TO BE CHOSEN BY ARCHITECT
GWB-2	PAINTED GYPSUM BOARD - EPOXY	SHERWIN WILLIAMS		COLOR TO BE CHOSEN BY ARCHITECT
CWT-1	CERAMIC WALL TILE	DALTILE PORTFOLIO		COLOR TO BE CHOSEN BY ARCHITECT
CMU-1	ELASTOMERIC COATED CMU			
CMU-2	PAINTED CMU			

MILLWORK				
L-1	LAMINATE TOP	FORMICA		COLOR TO BE CHOSEN BY ARCHITECT
L-2	LAMINATE BASE	WILSONART		COLOR TO BE CHOSEN BY ARCHITECT

CEILING				
ACT-1	ACOUSTICAL TILE	ARMSTRONG SCHOOL ZONE FINE FISSURED	WHITE	
ACT-2	VINYL COATED ACOUSTICAL TILE	ARMSTRONG CLEAN ROOM FL		
GLV-1	GALVANIZED SECURE MESH SCREEN			
GWB-1	PAINTED GYPSUM BOARD - EPOXY	SHERWIN WILLIAMS		COLOR TO BE CHOSEN BY ARCHITECT

TALLAPOOSA CO E911 ADDITION TO THE TALLAPOOSA COUNTY JAIL FACILITY
DADEVILLE, AL

CONSTRUCTION DOCUMENTS

Project Number: 25-1465
Date: 8 JANUARY 2026
Revisions:


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DOOR SCHEDULE/ DETAILS

Sheet Number


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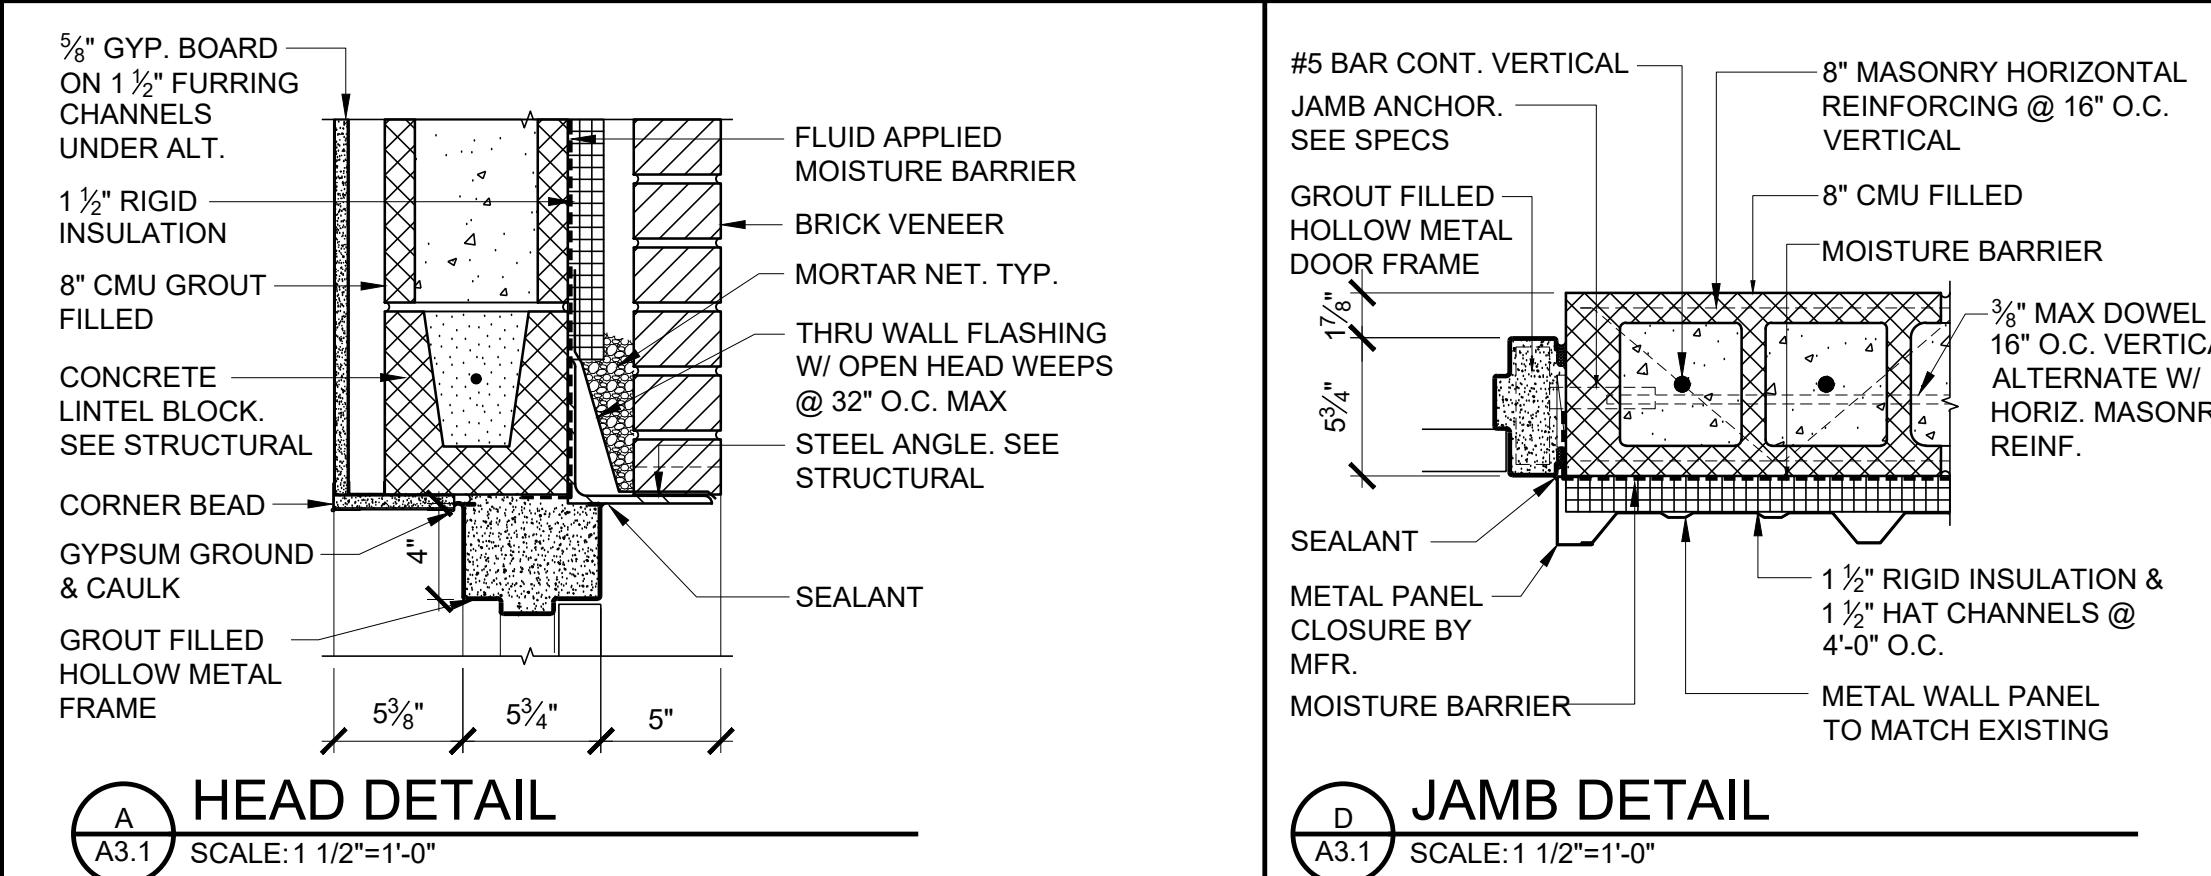
DOOR TYPES

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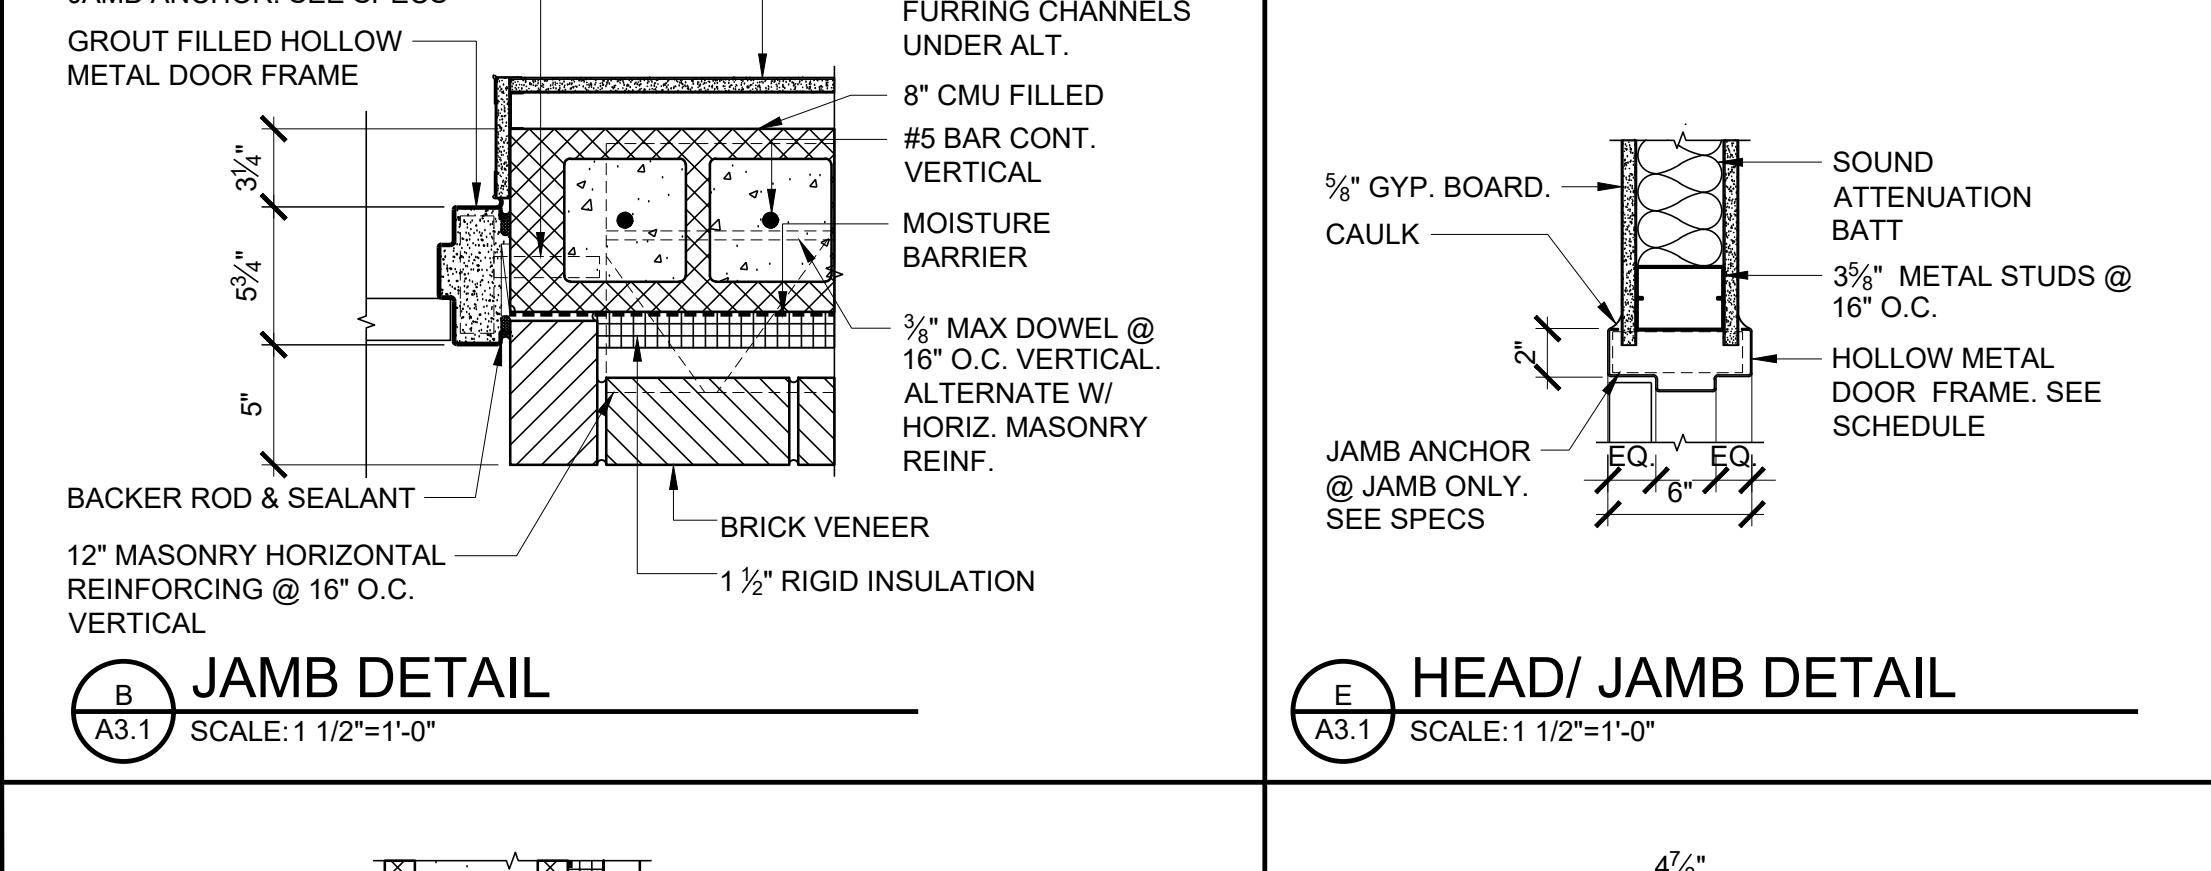
DOOR TYPES

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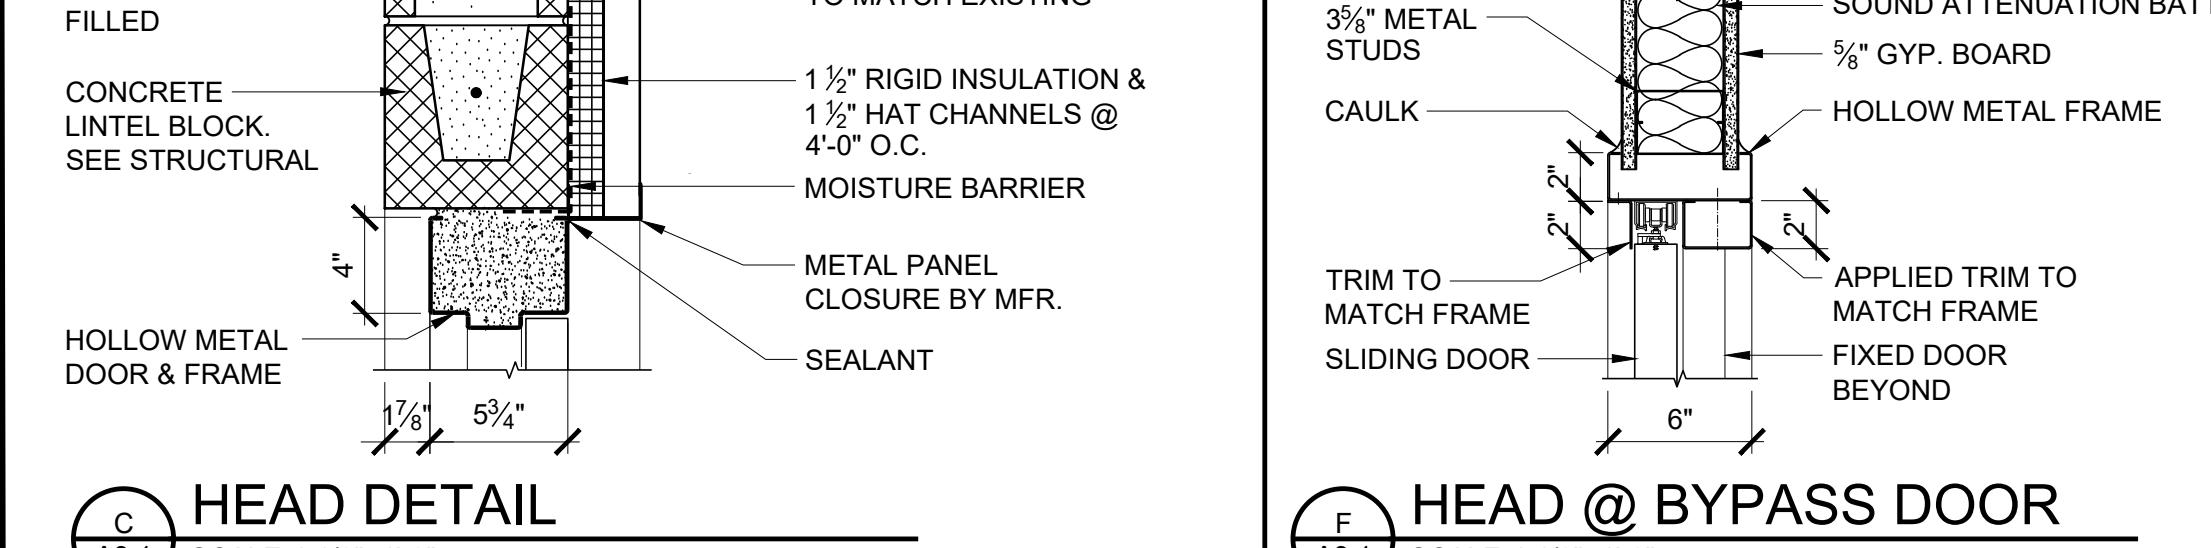
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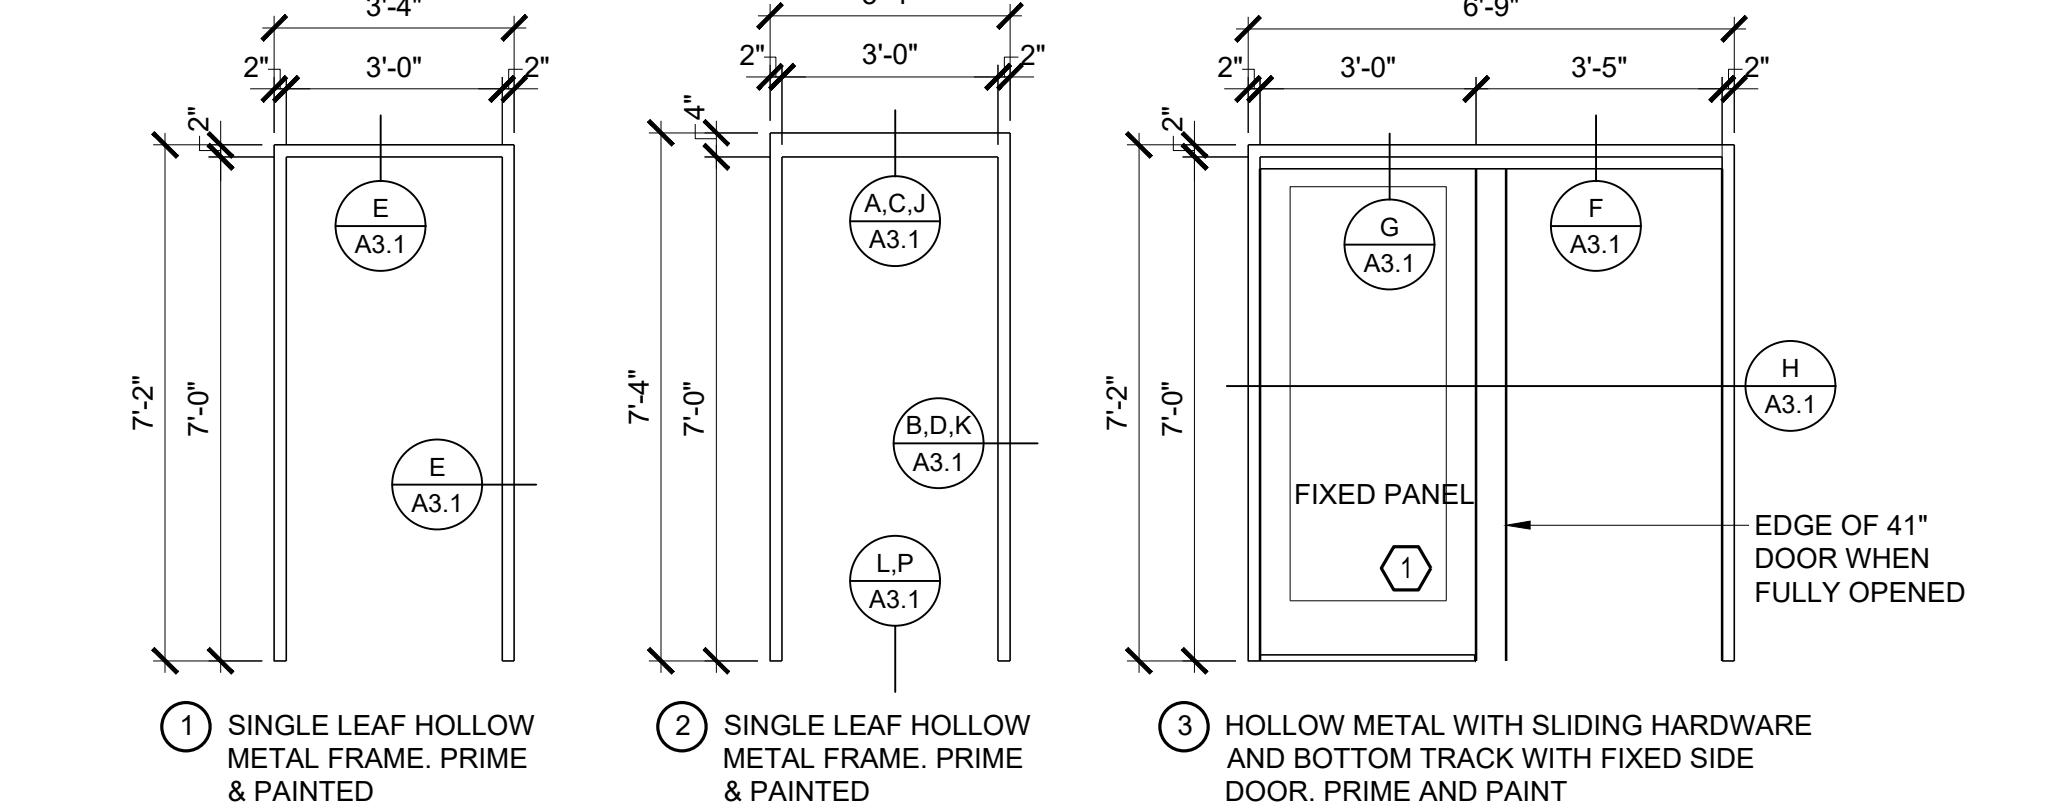
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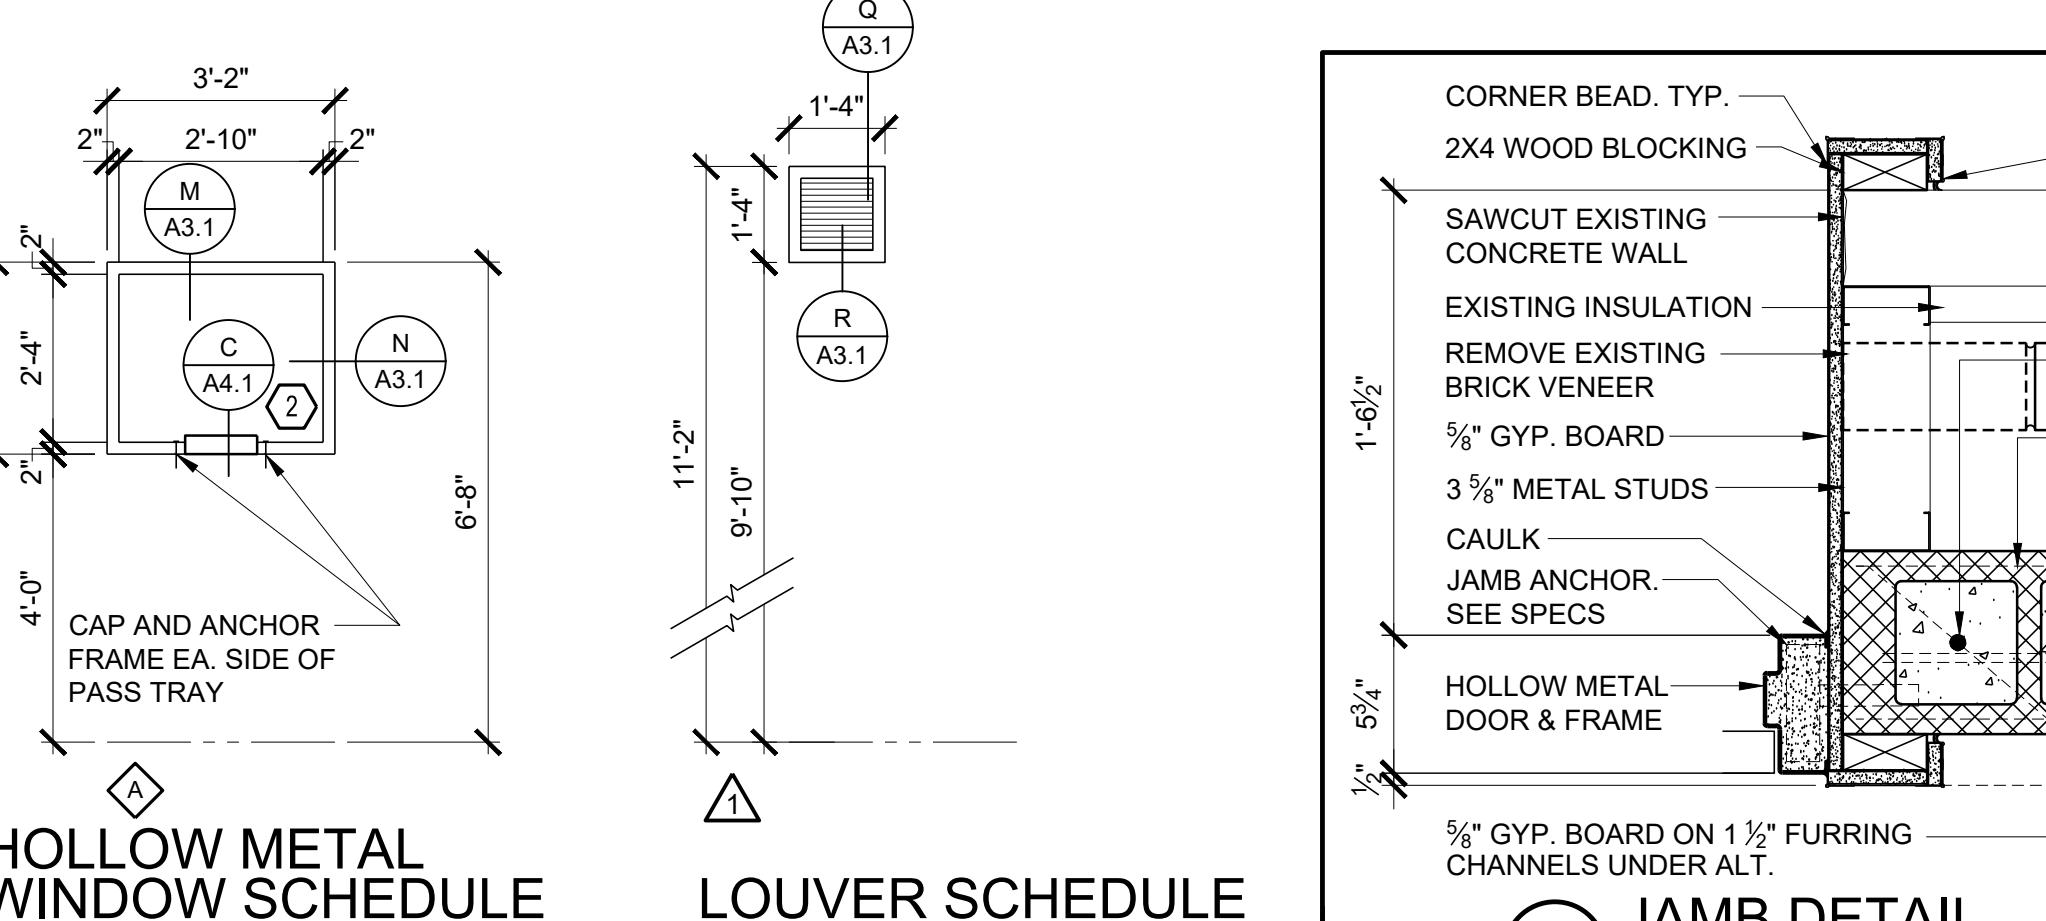
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FRAME TYPES

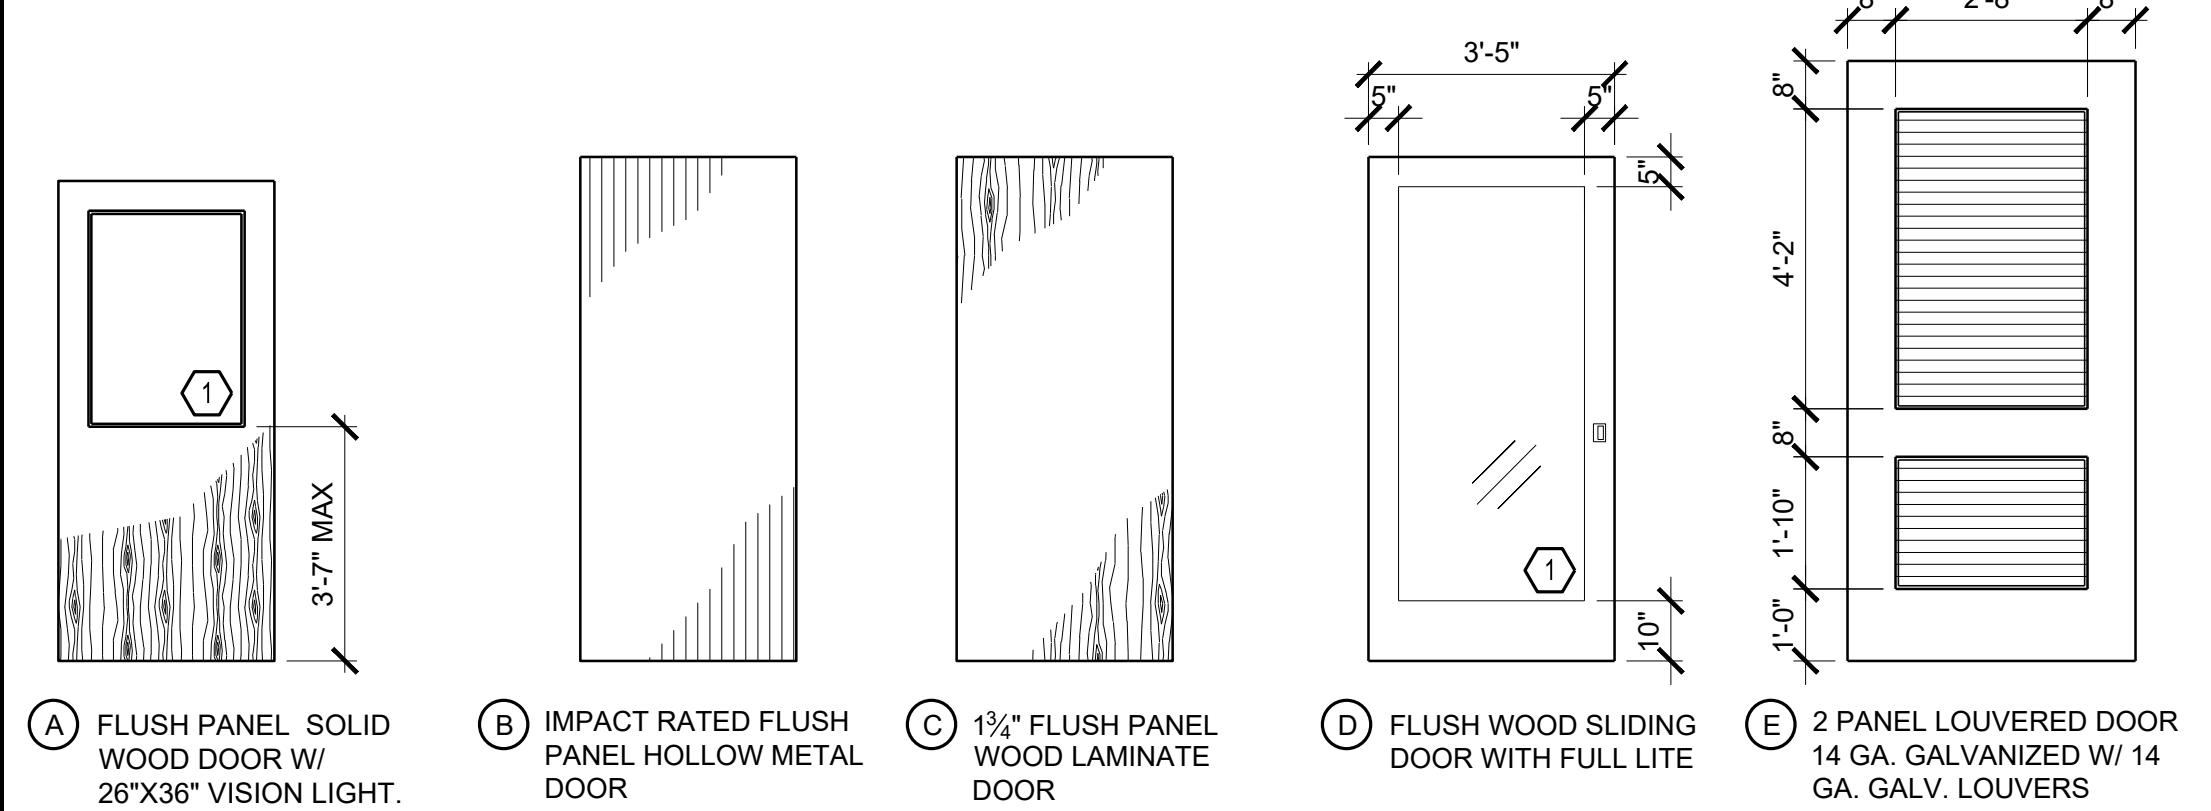SCALE: 3/8"=1'-0"

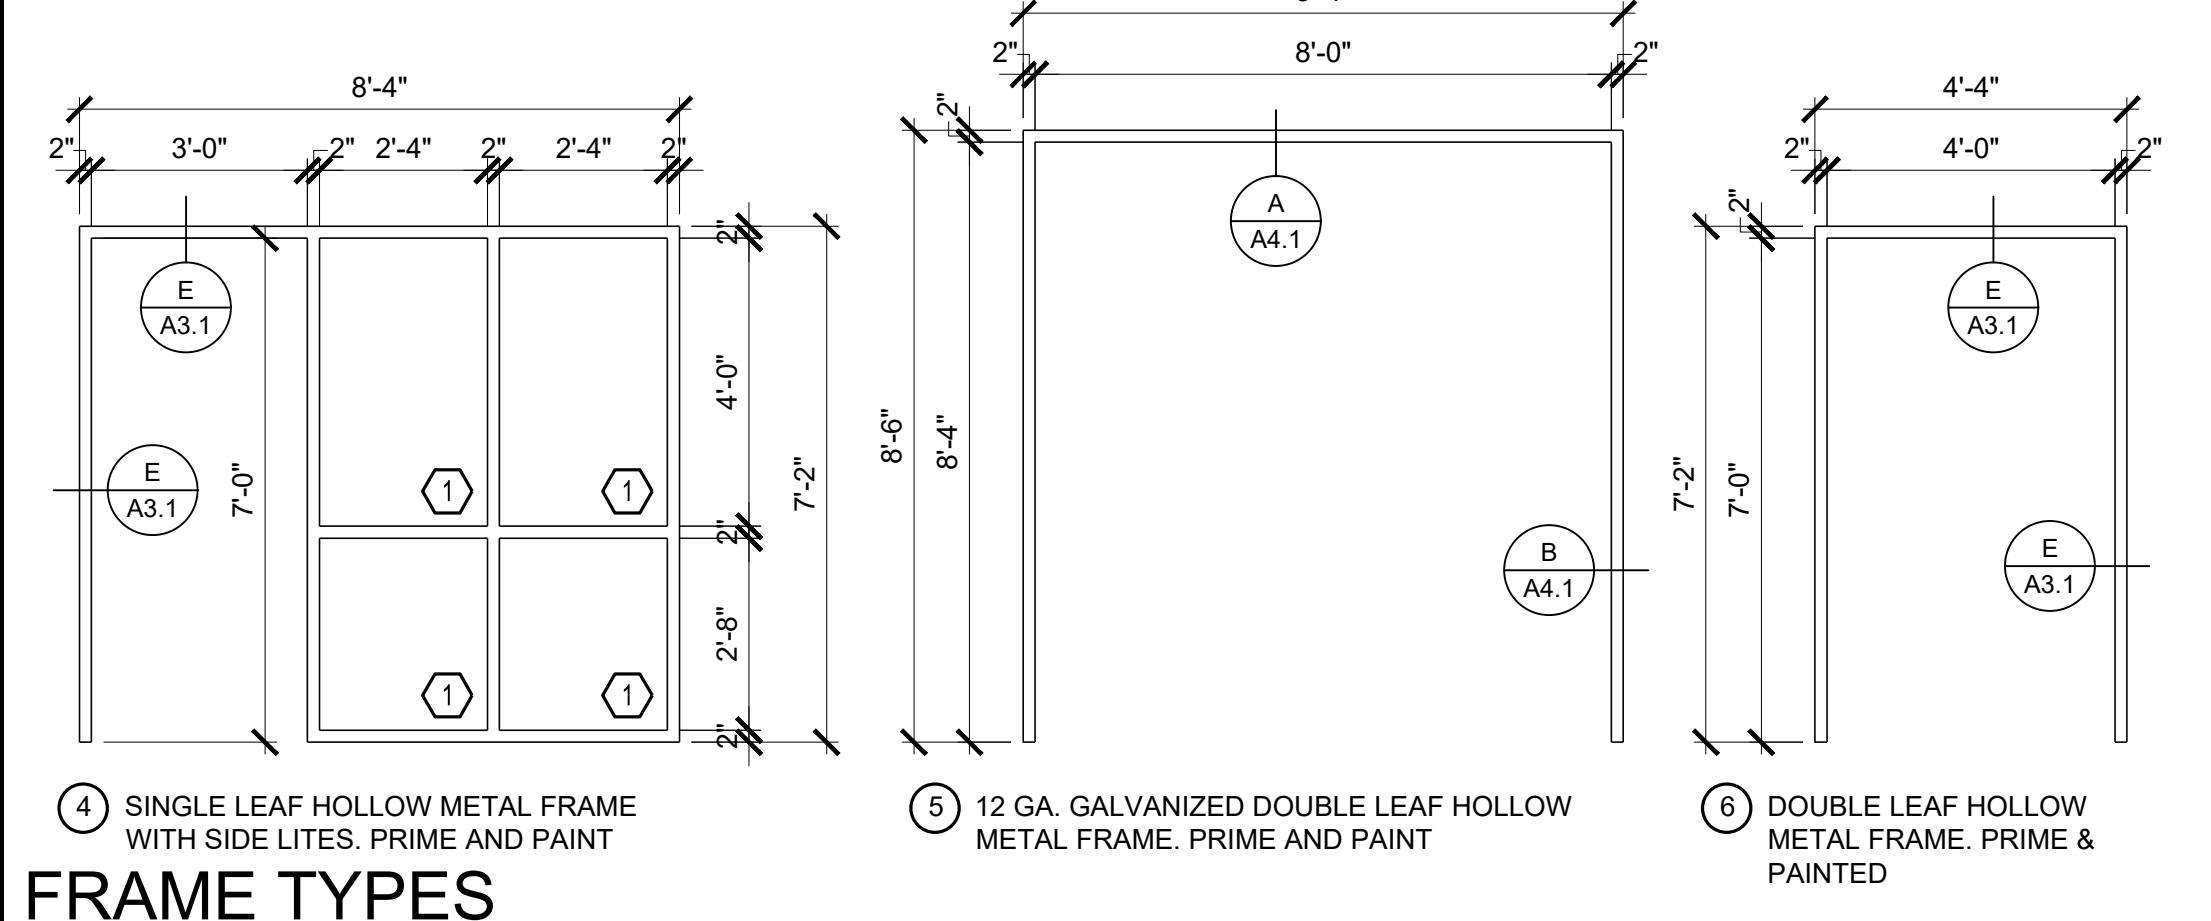

FRAME TYPES

SCALE: 3/8"=1'-0"

FRAME TYPES

SCALE: 3

**TALLAPOOSA
CO E911
ADDITION TO
THE
TALLAPOOSA
COUNTY JAIL
FACILITY**
DADEVILLE, AL

**CONSTRUCTION
DOCUMENTS**



Project Number: 25-1465
Date: 8 JANUARY 2026
Revisions:

Sheet Description



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ELEVATIONS**

Sheet Number


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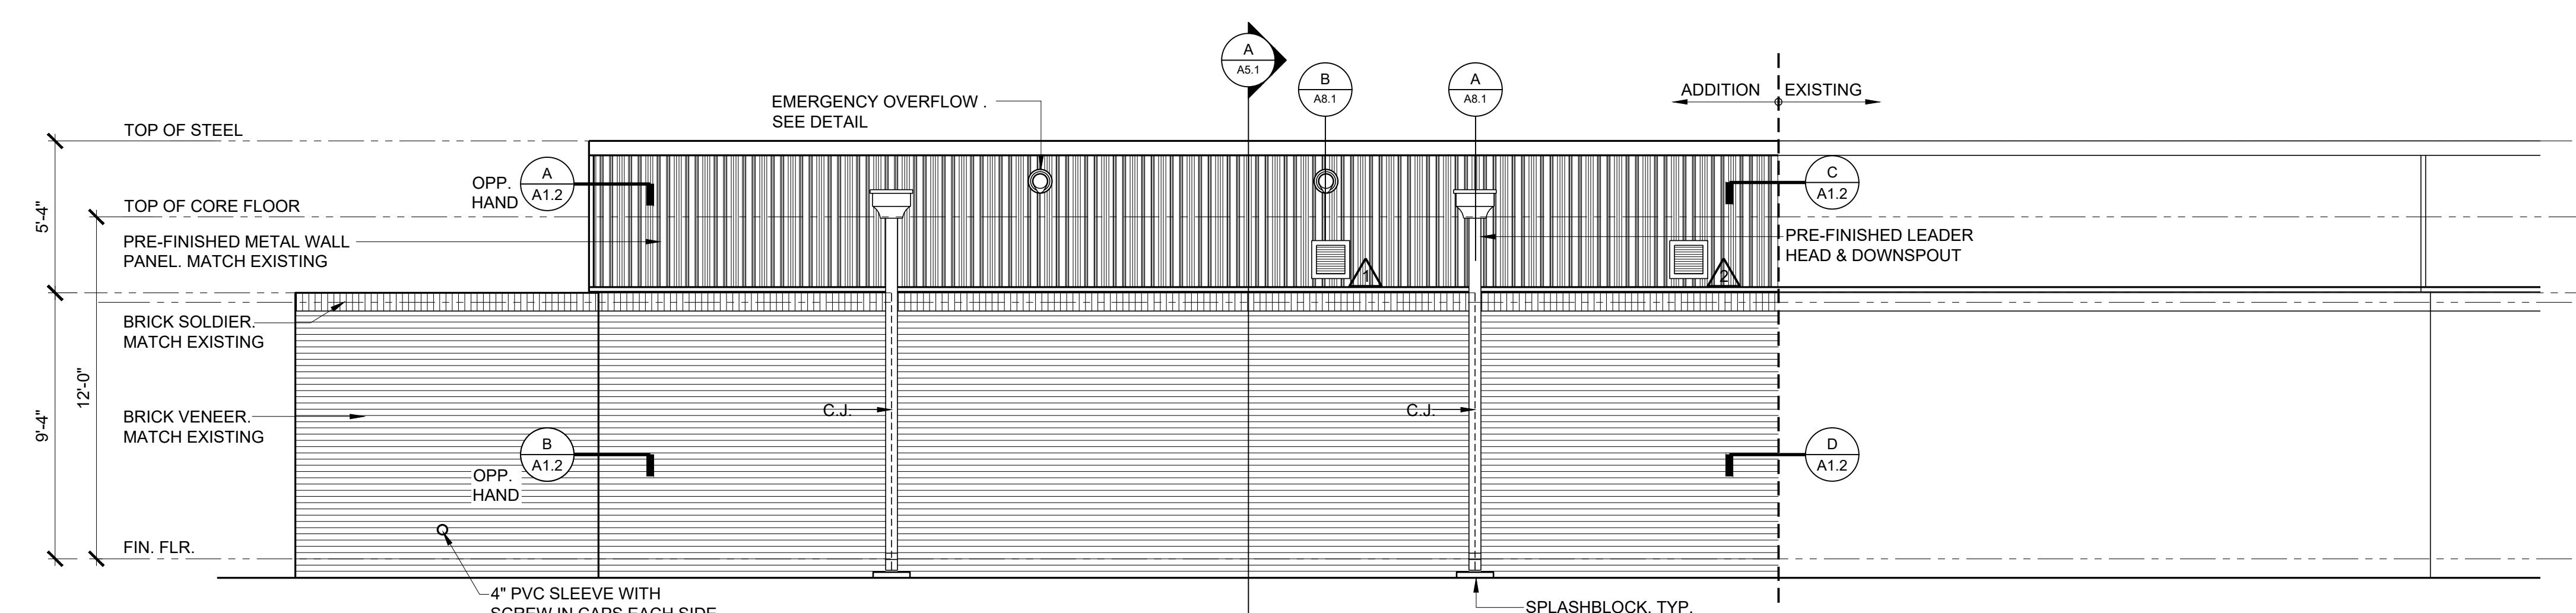
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A4.1
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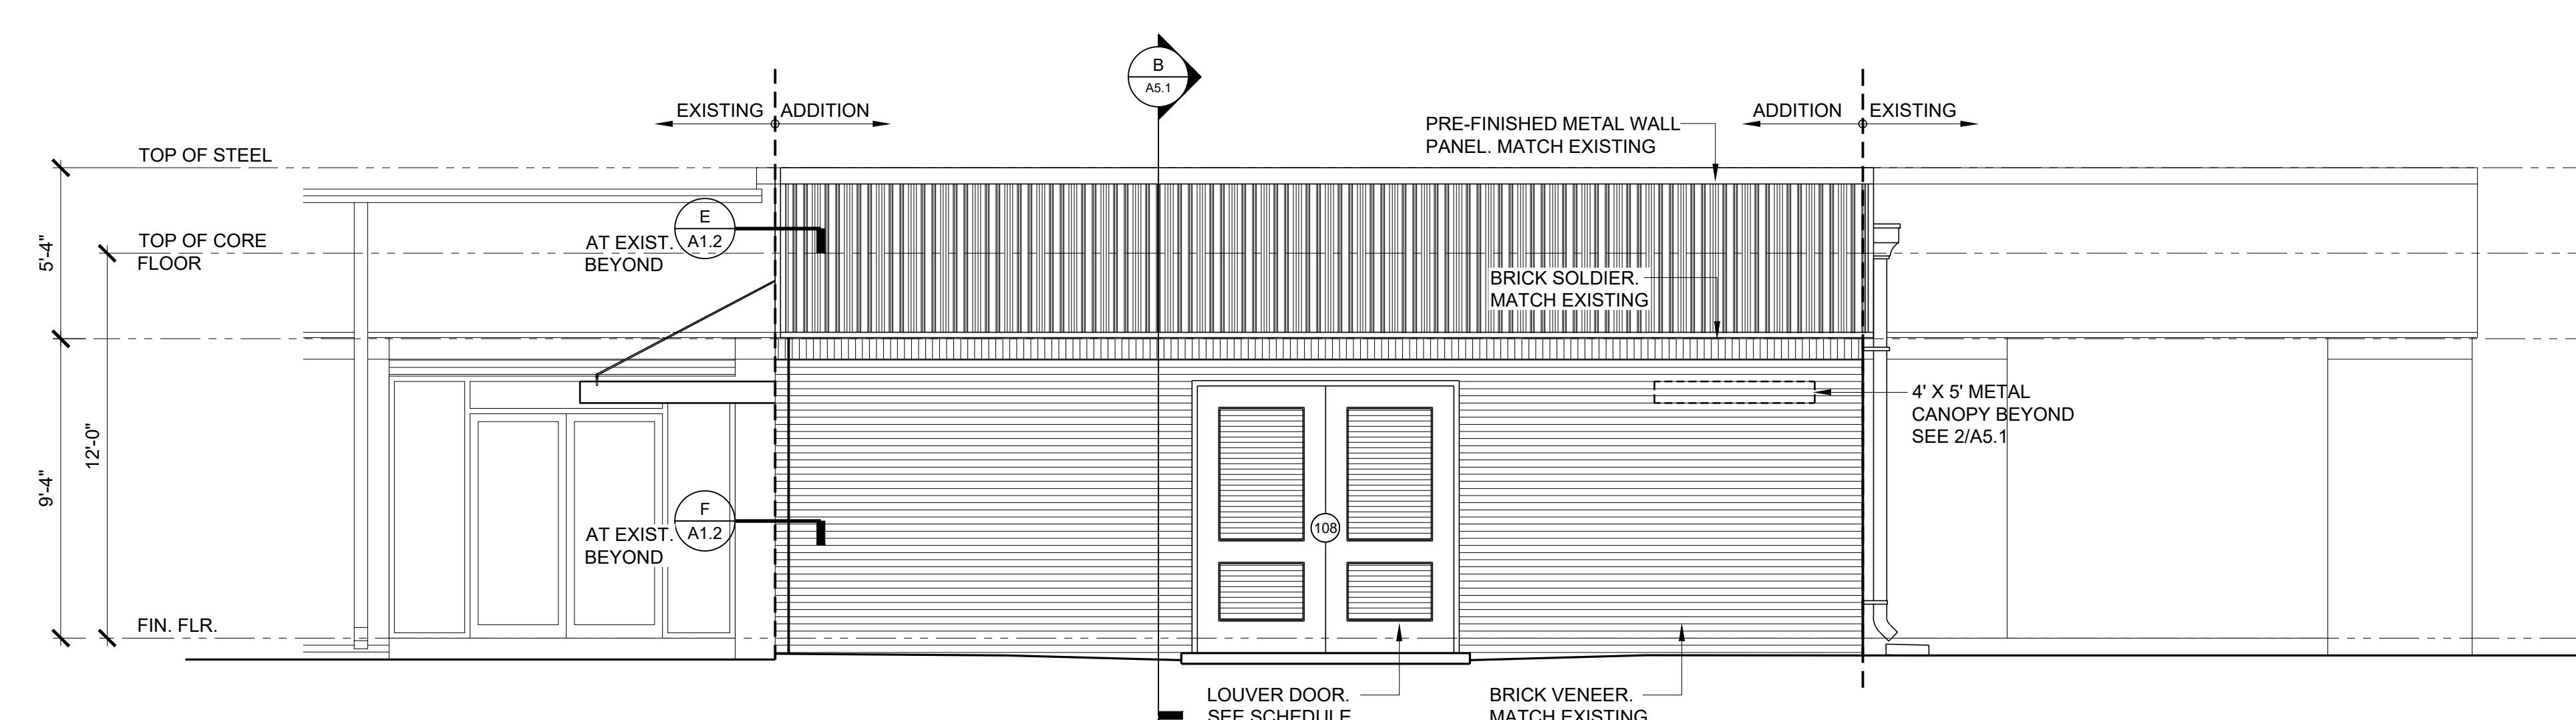
NORTH ELEVATION
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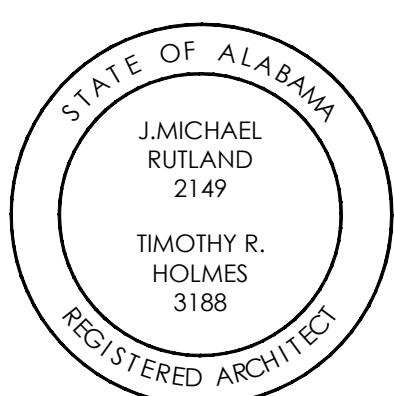
SILL DETAIL
A4.1
SCALE: 1 1/2"=1'-0"

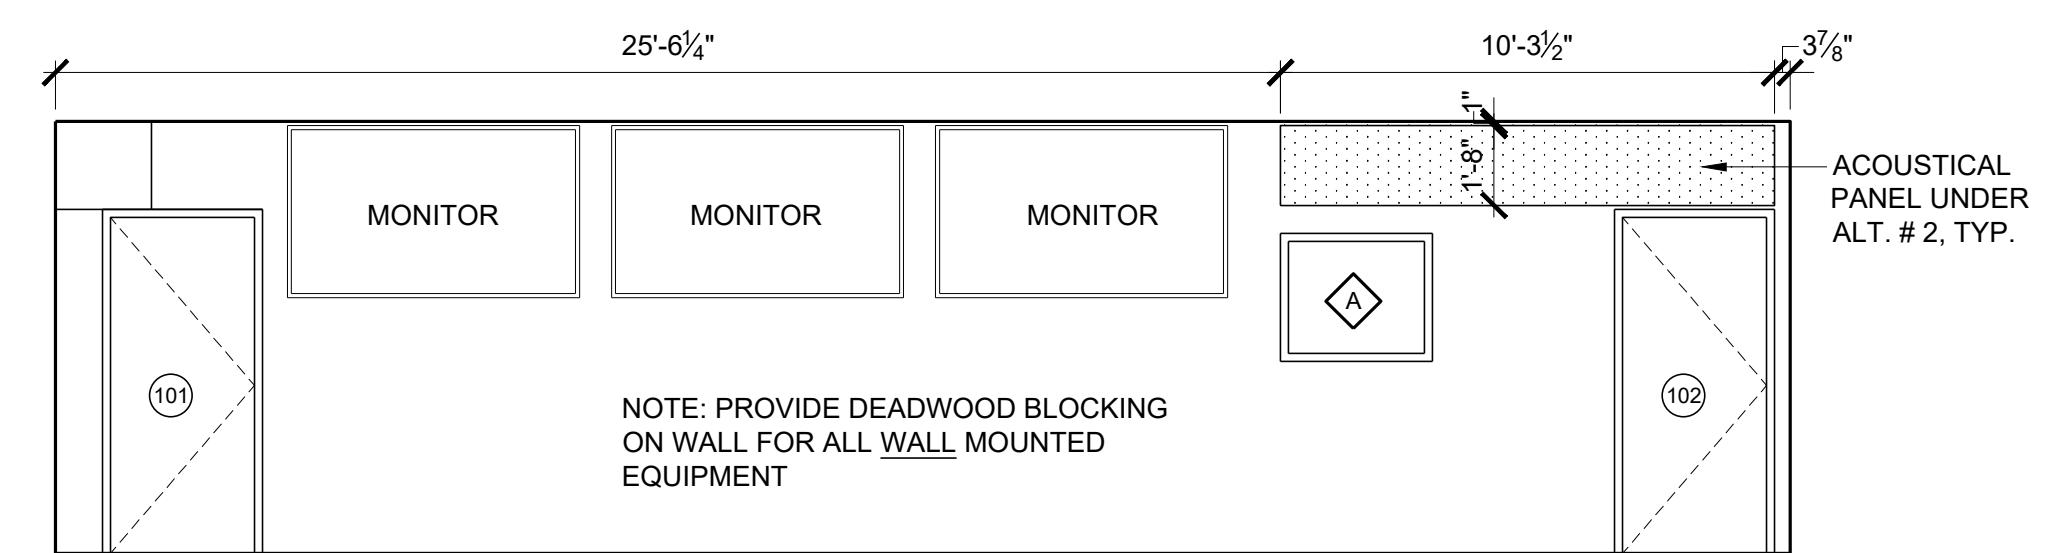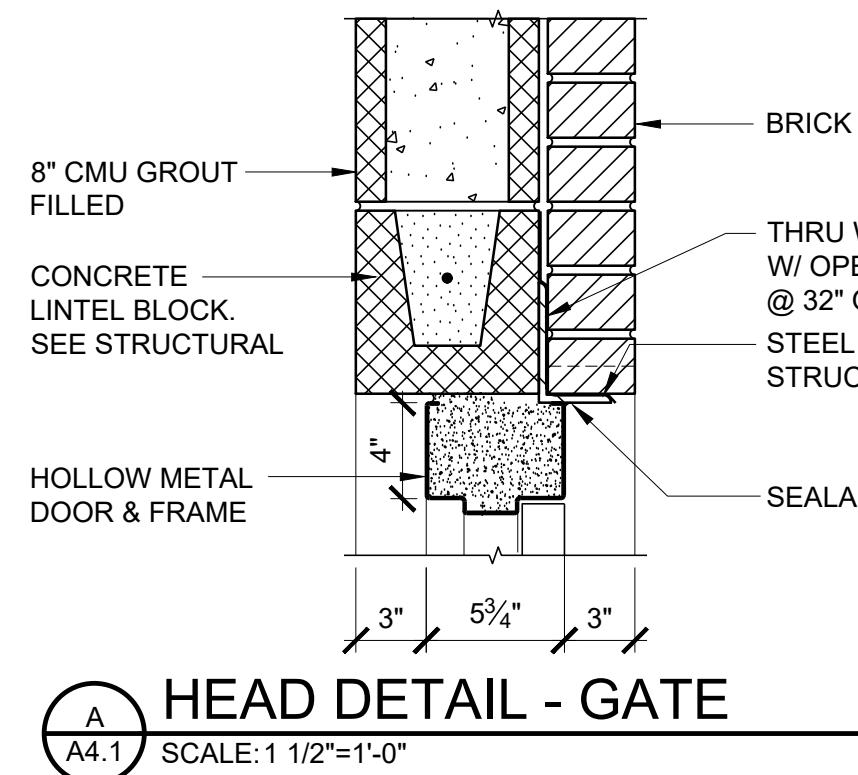

SOUTH ELEVATION
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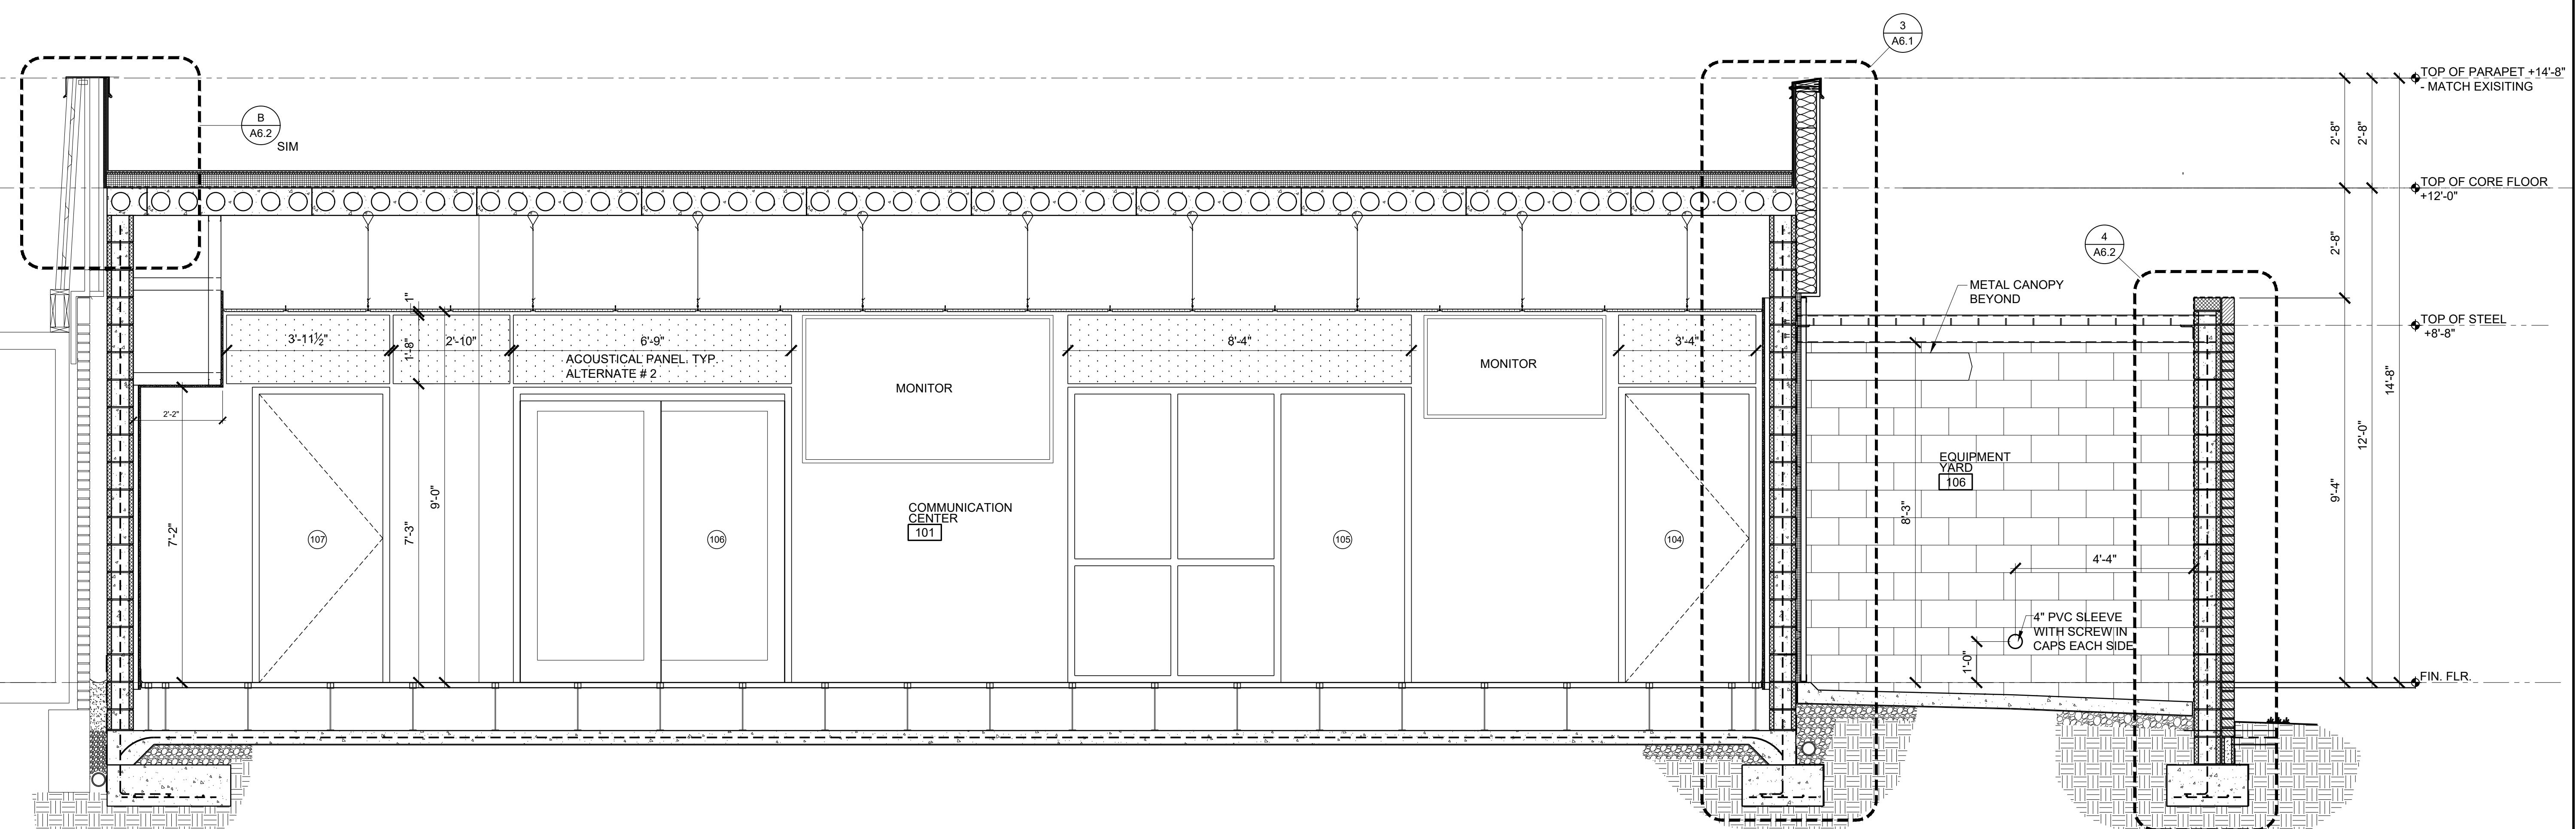
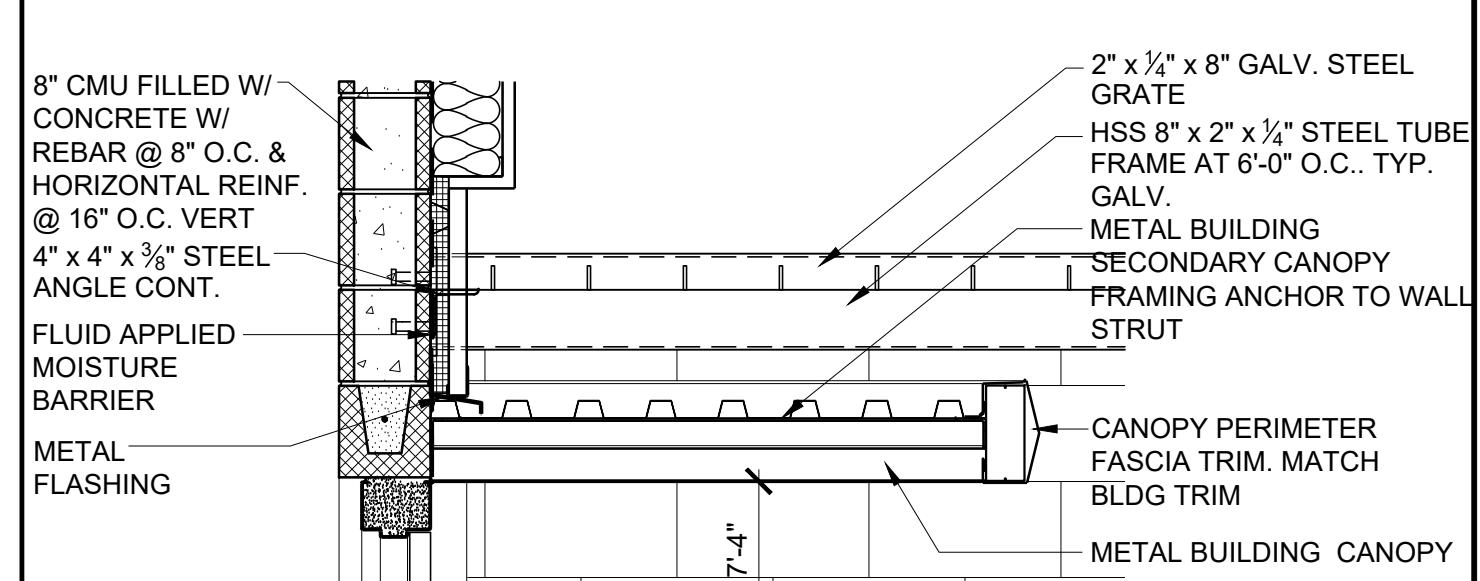
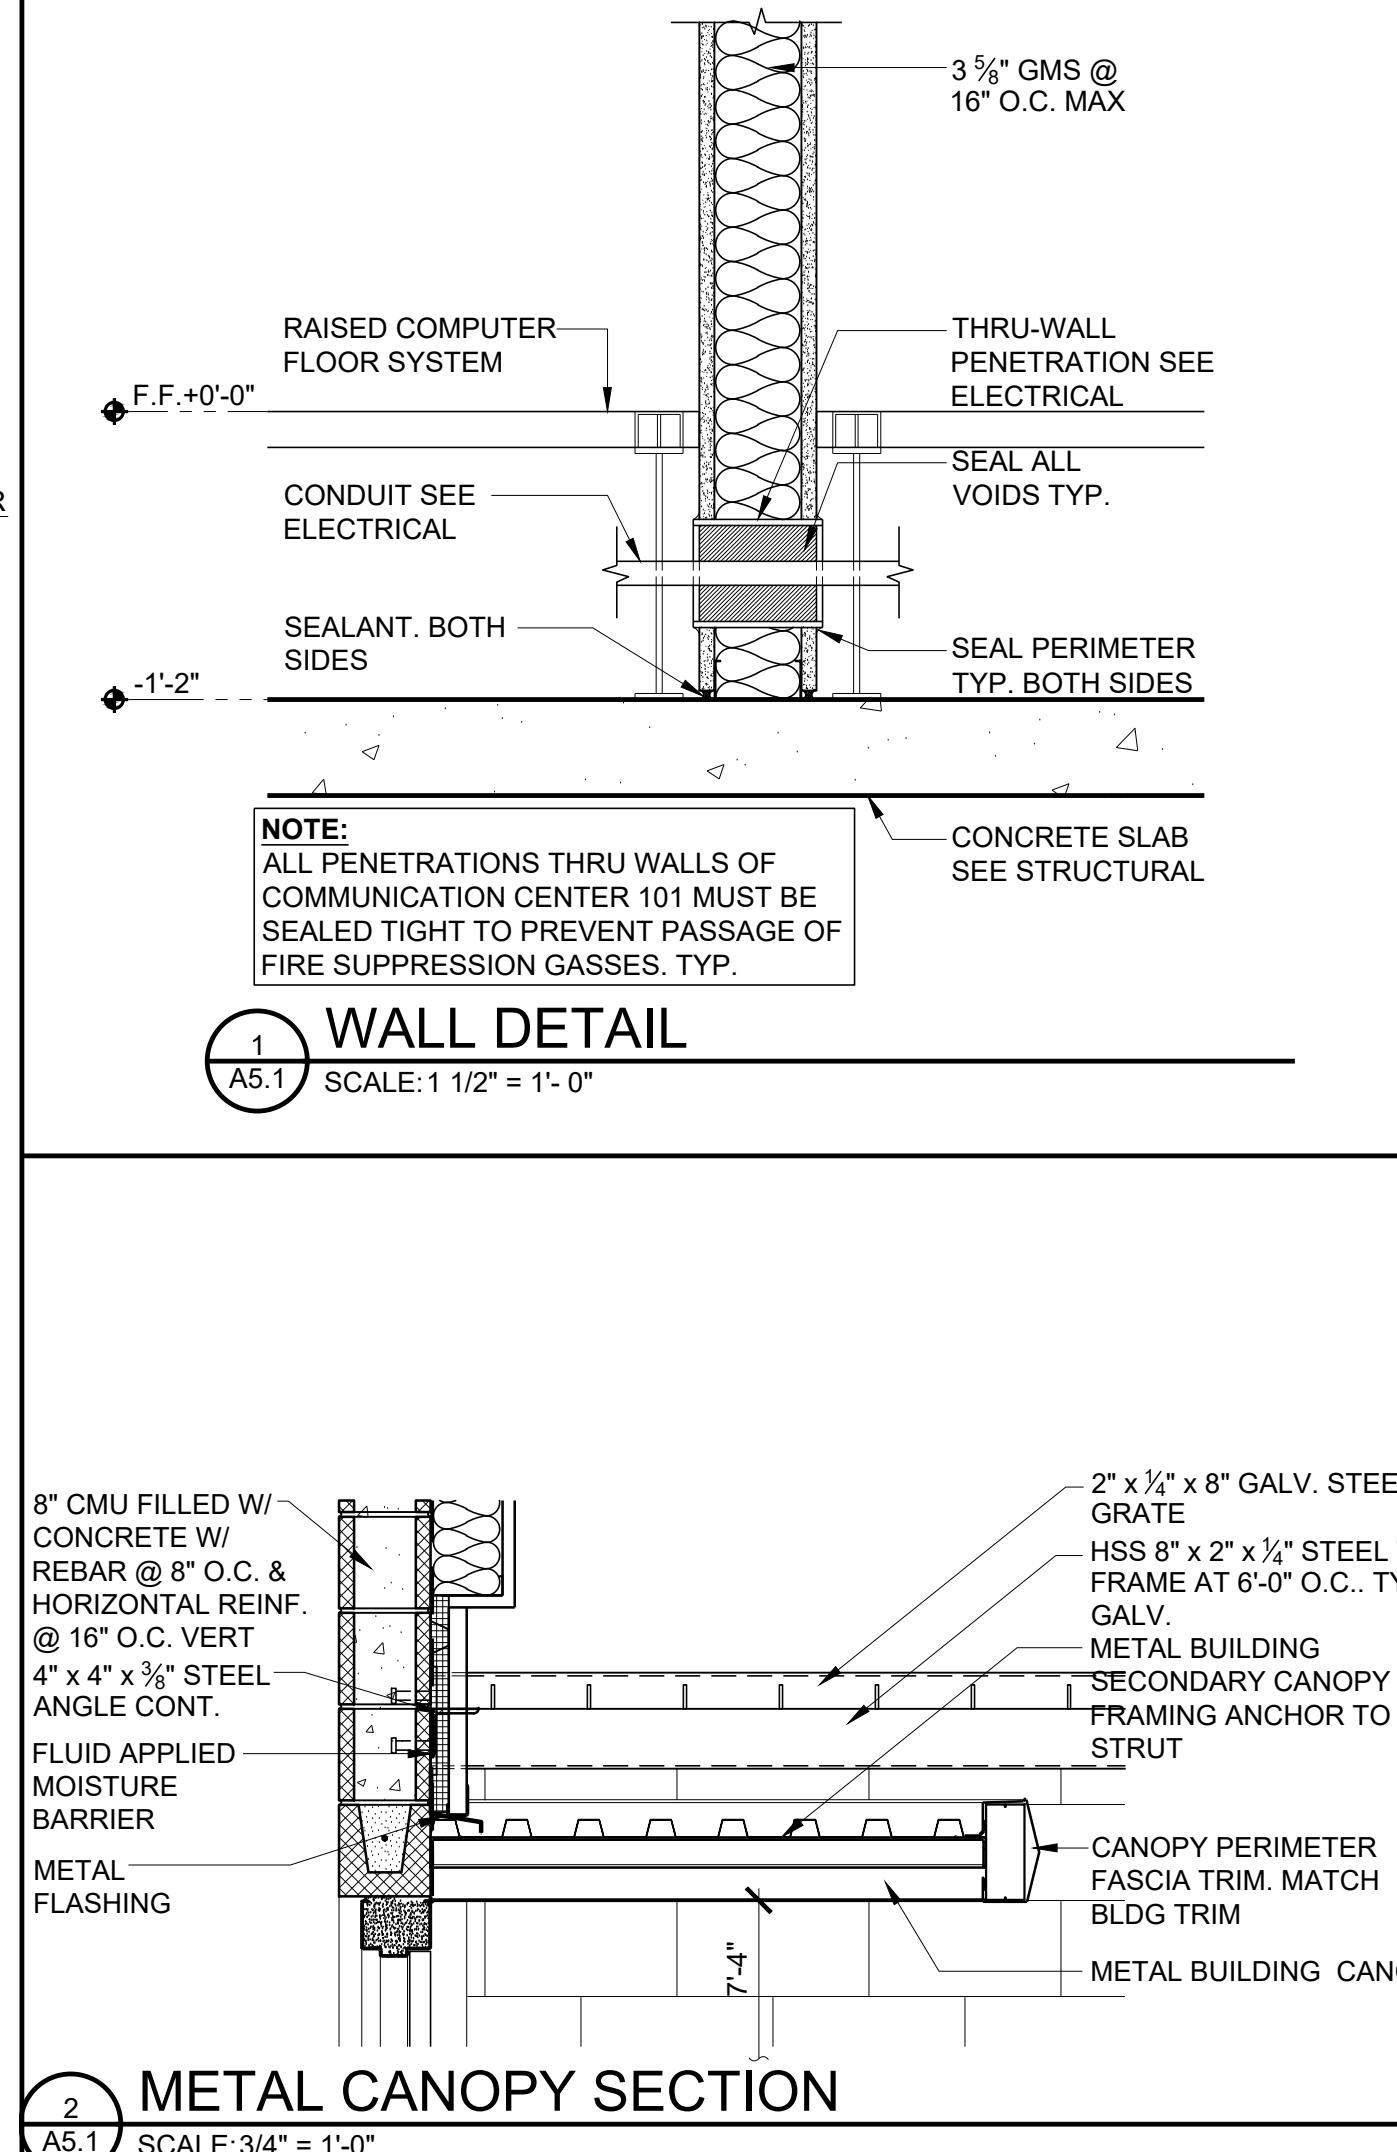
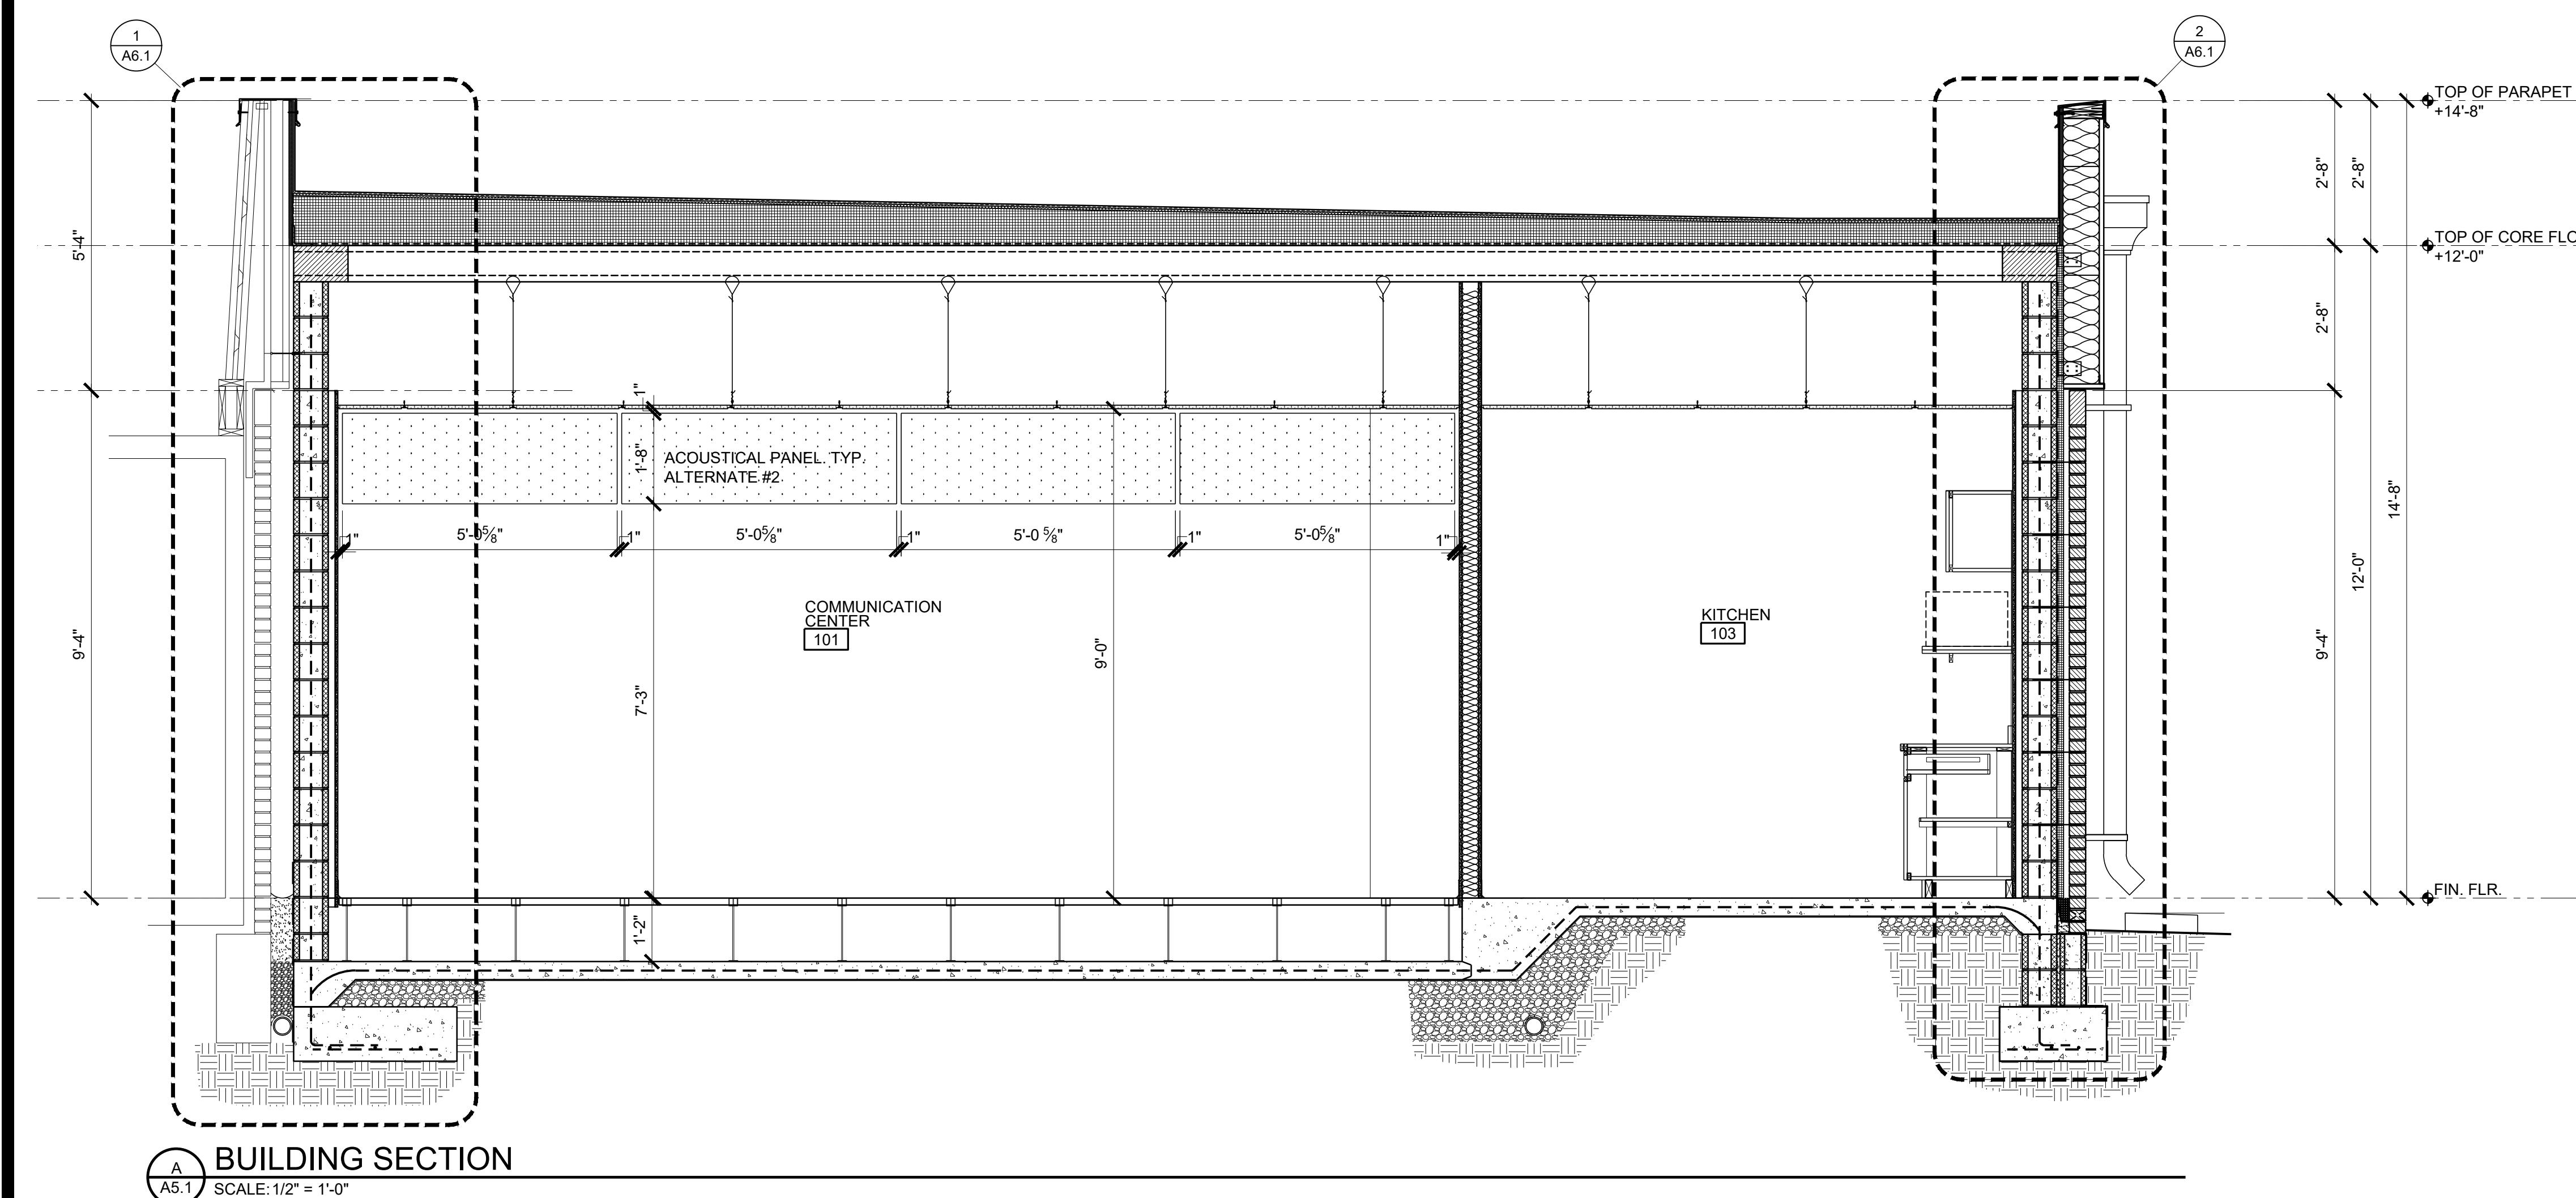
WEST ELEVATION
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TALLAPOOSA CO E911 ADDITION TO THE TALLAPOOSA COUNTY JAIL FACILITY
DADEVILLE, AL
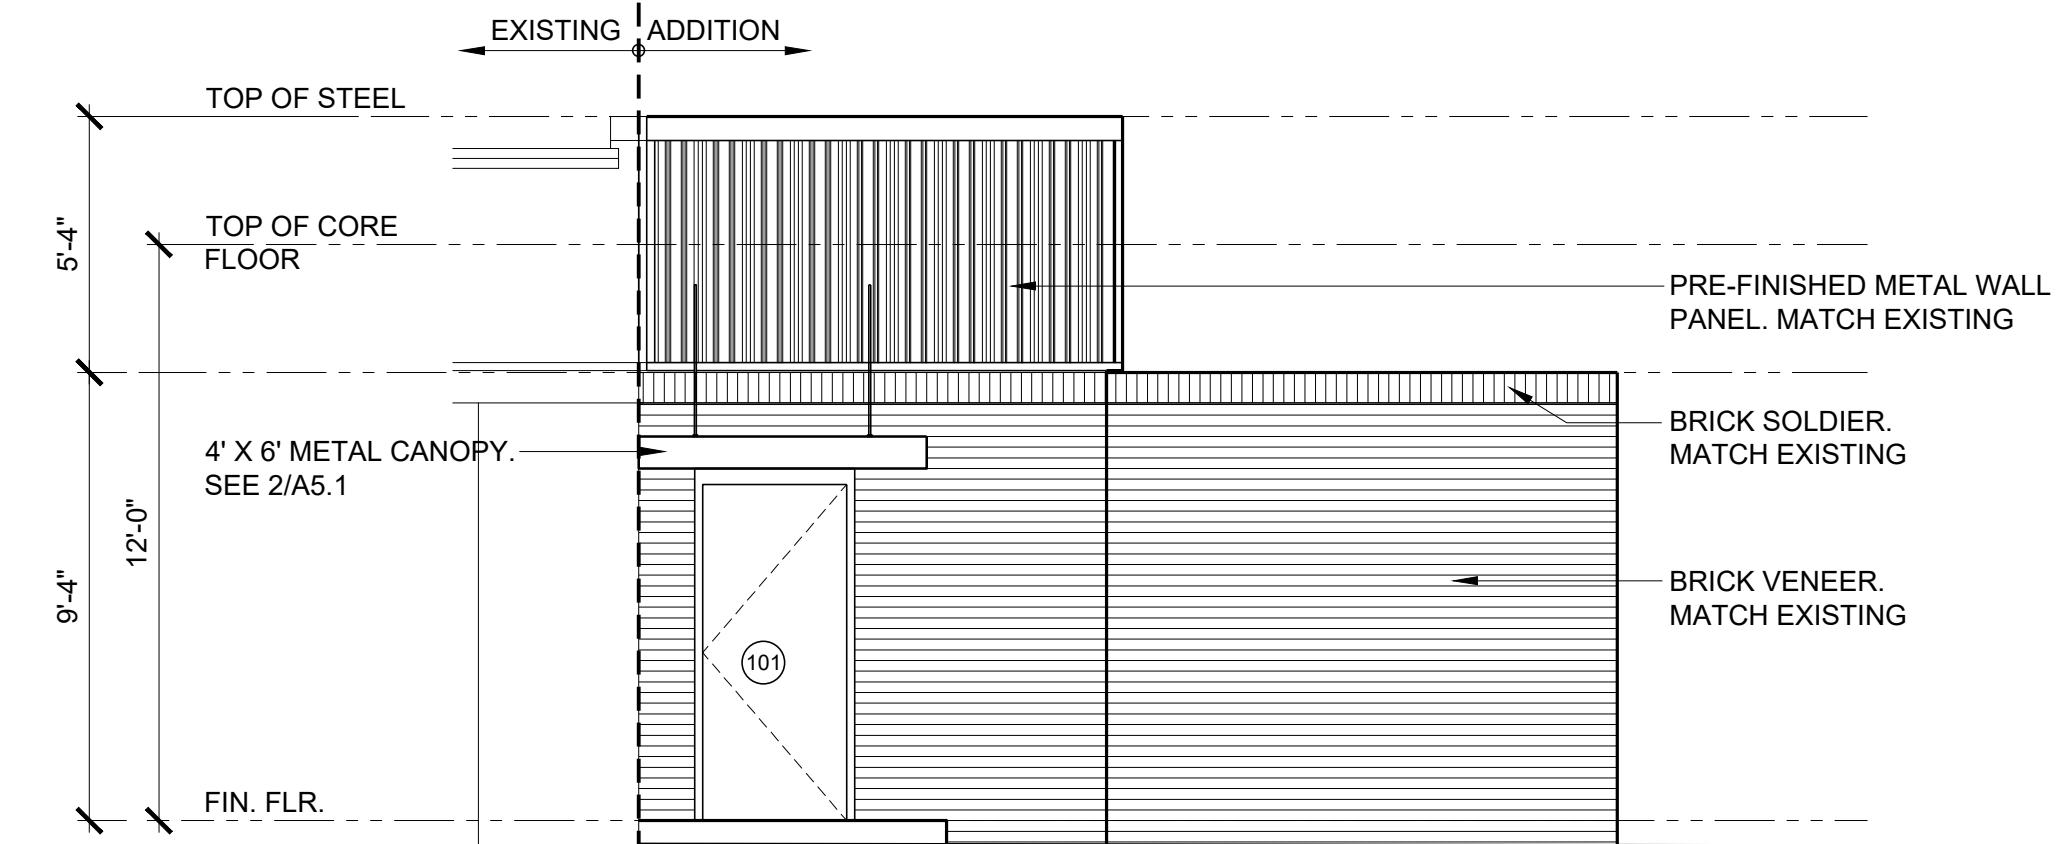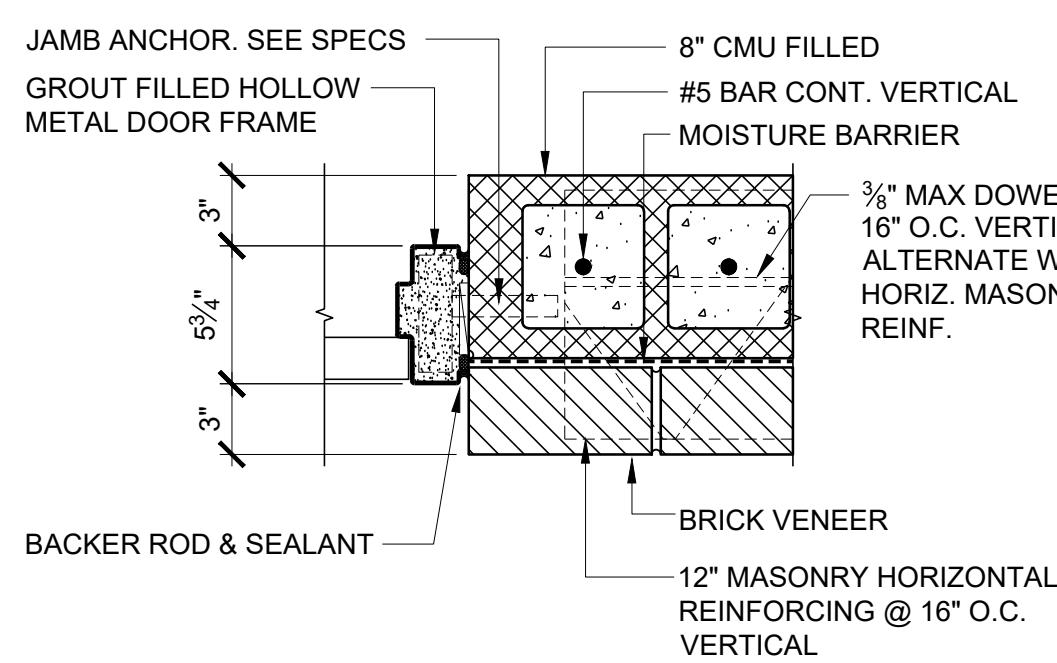
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CONSTRUCTION DOCUMENTS

Project Number: 25-1465
Date: 8 JANUARY 2026
Revisions:

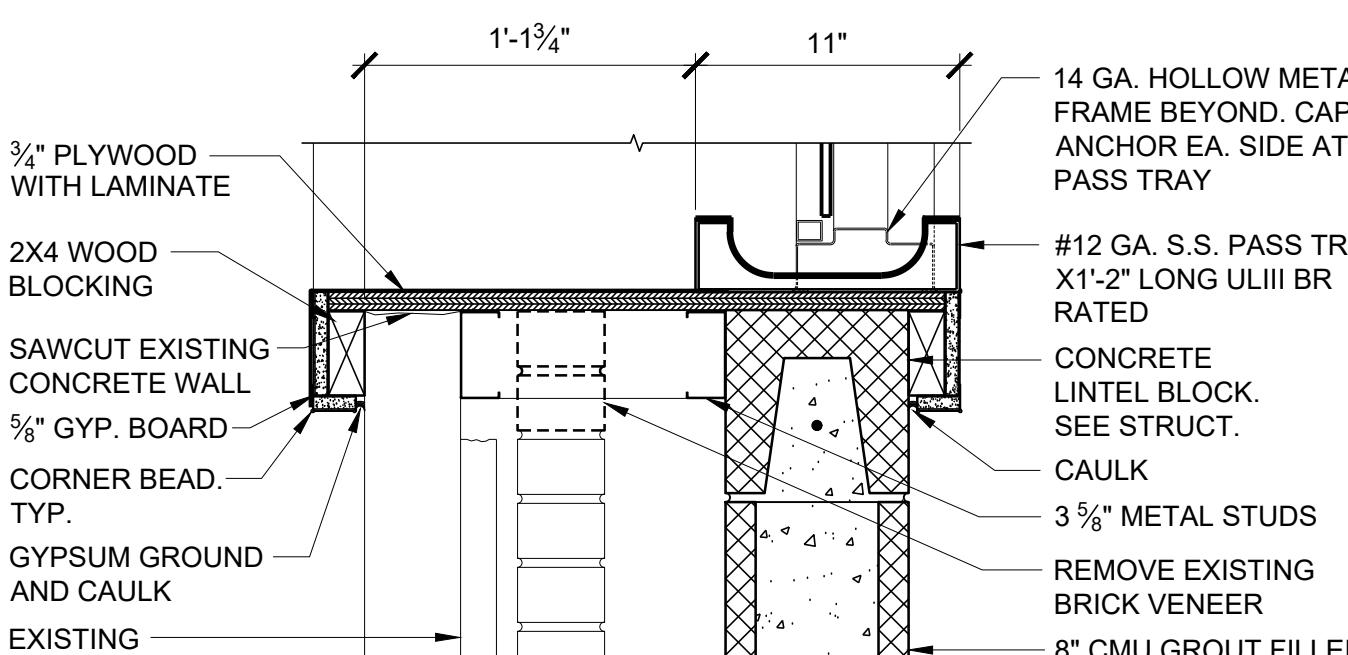Sheet Description

BUILDING SECTIONS

Sheet Number

A5.1

**TALLAPOOSA
CO E911
ADDITION TO
THE
TALLAPOOSA
COUNTY JAIL
FACILITY**
DADEVILLE, AL

**CONSTRUCTION
DOCUMENTS**



Project Number: 25-1465
Date: 8 JANUARY 2026
Revisions:







Sheet Description

WALL SECTIONS

Sheet Number

A6.1

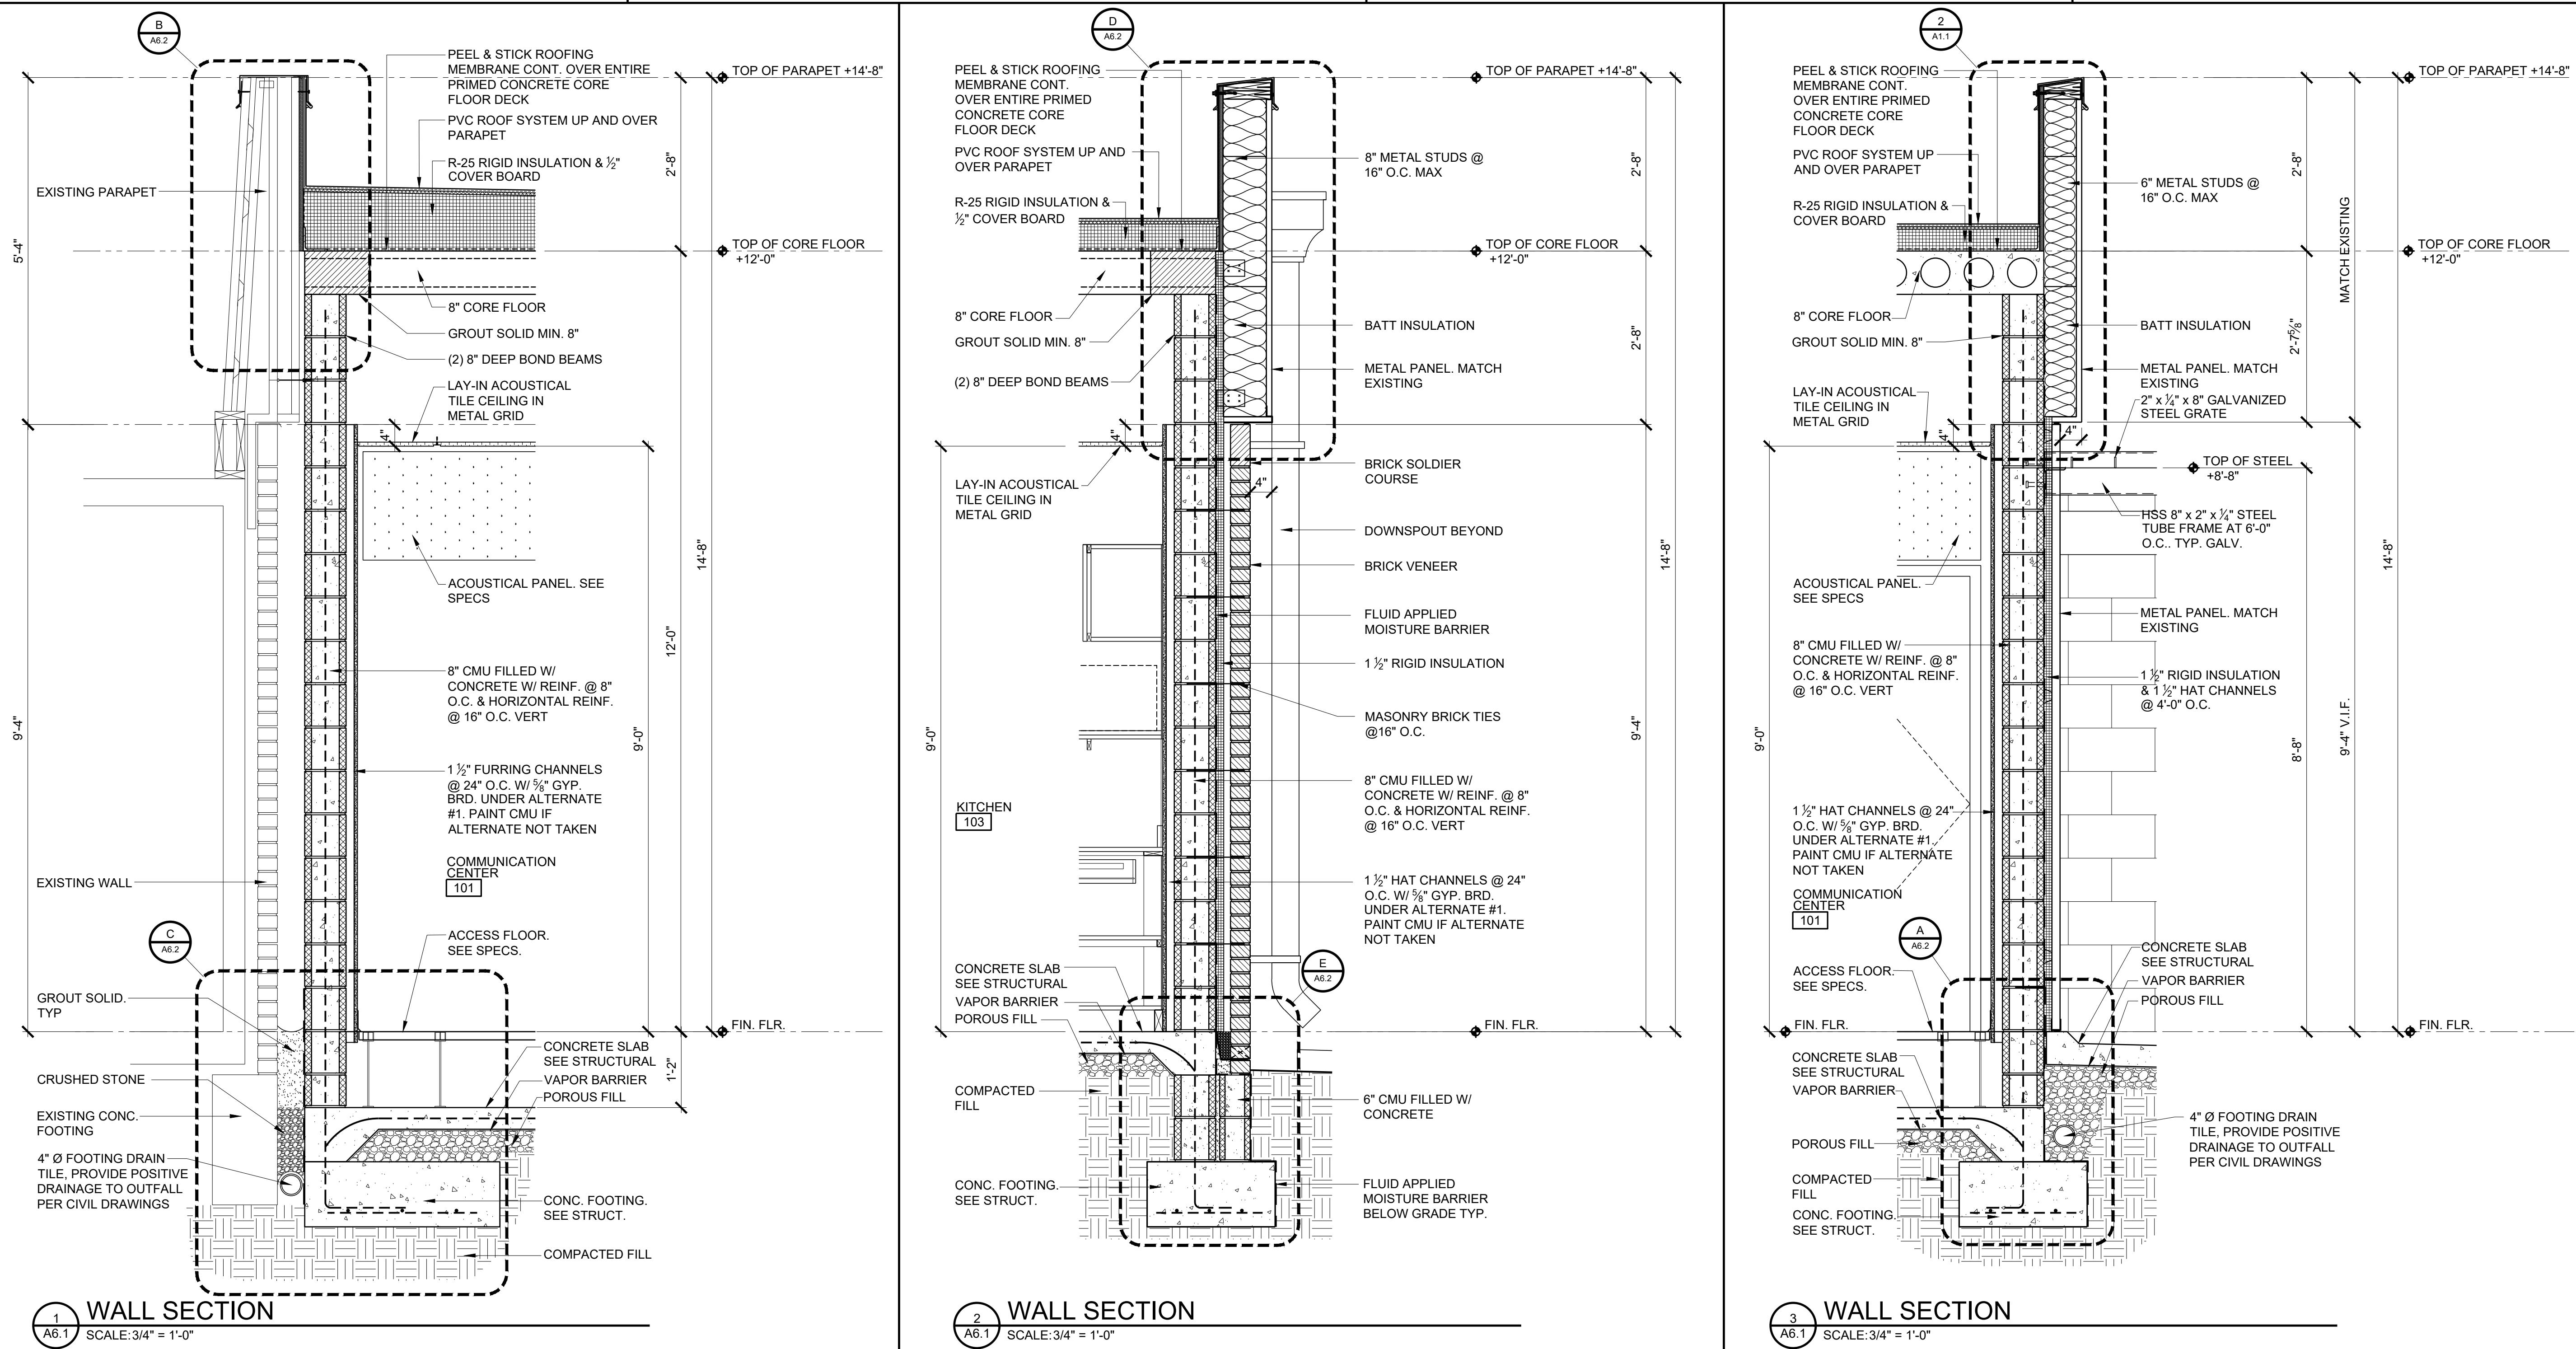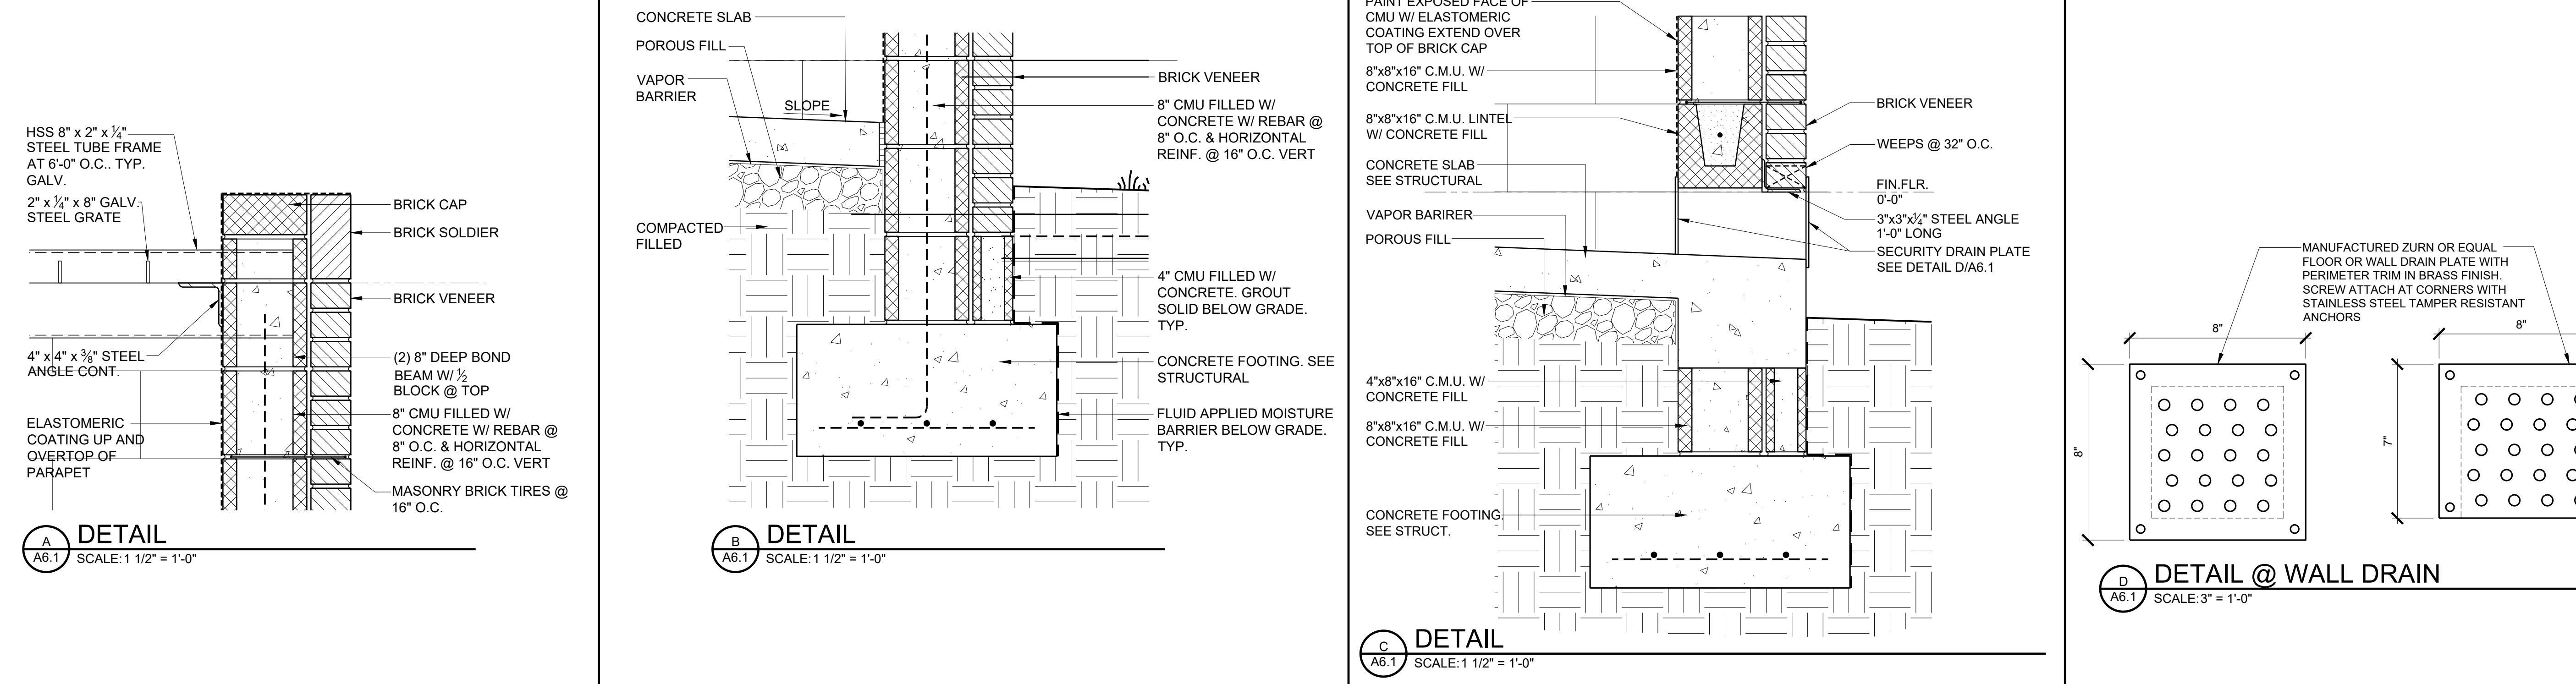

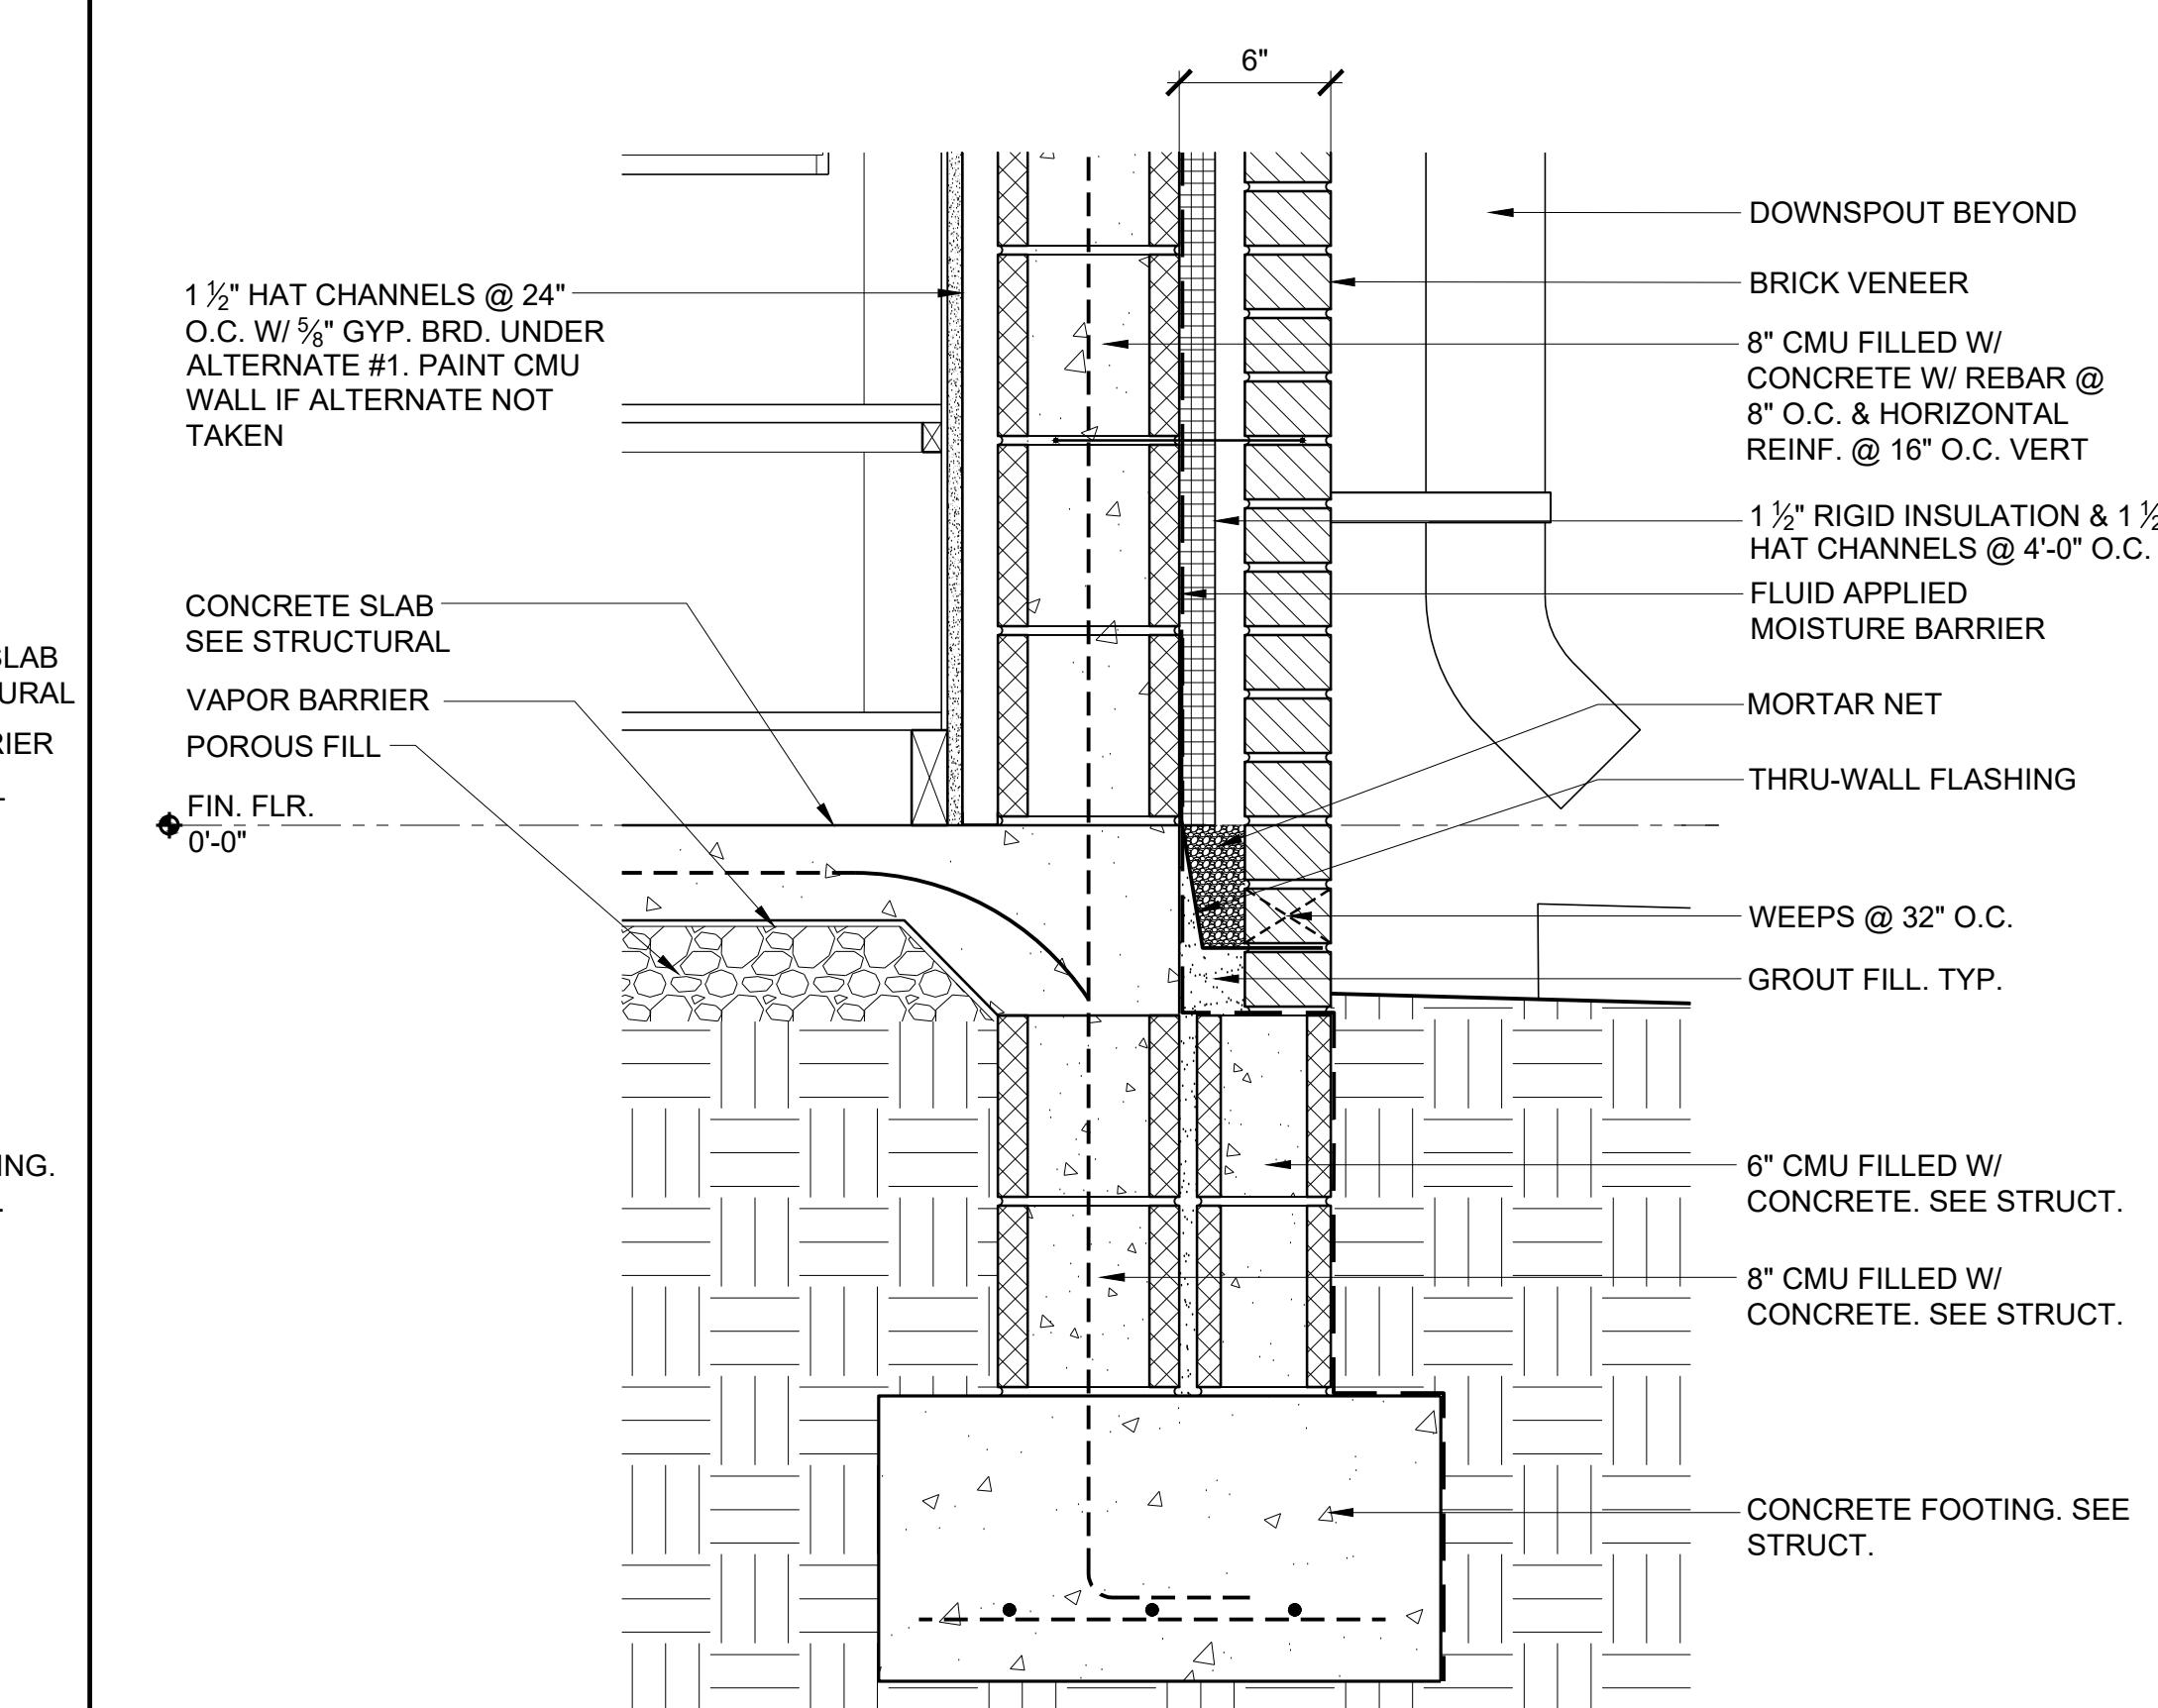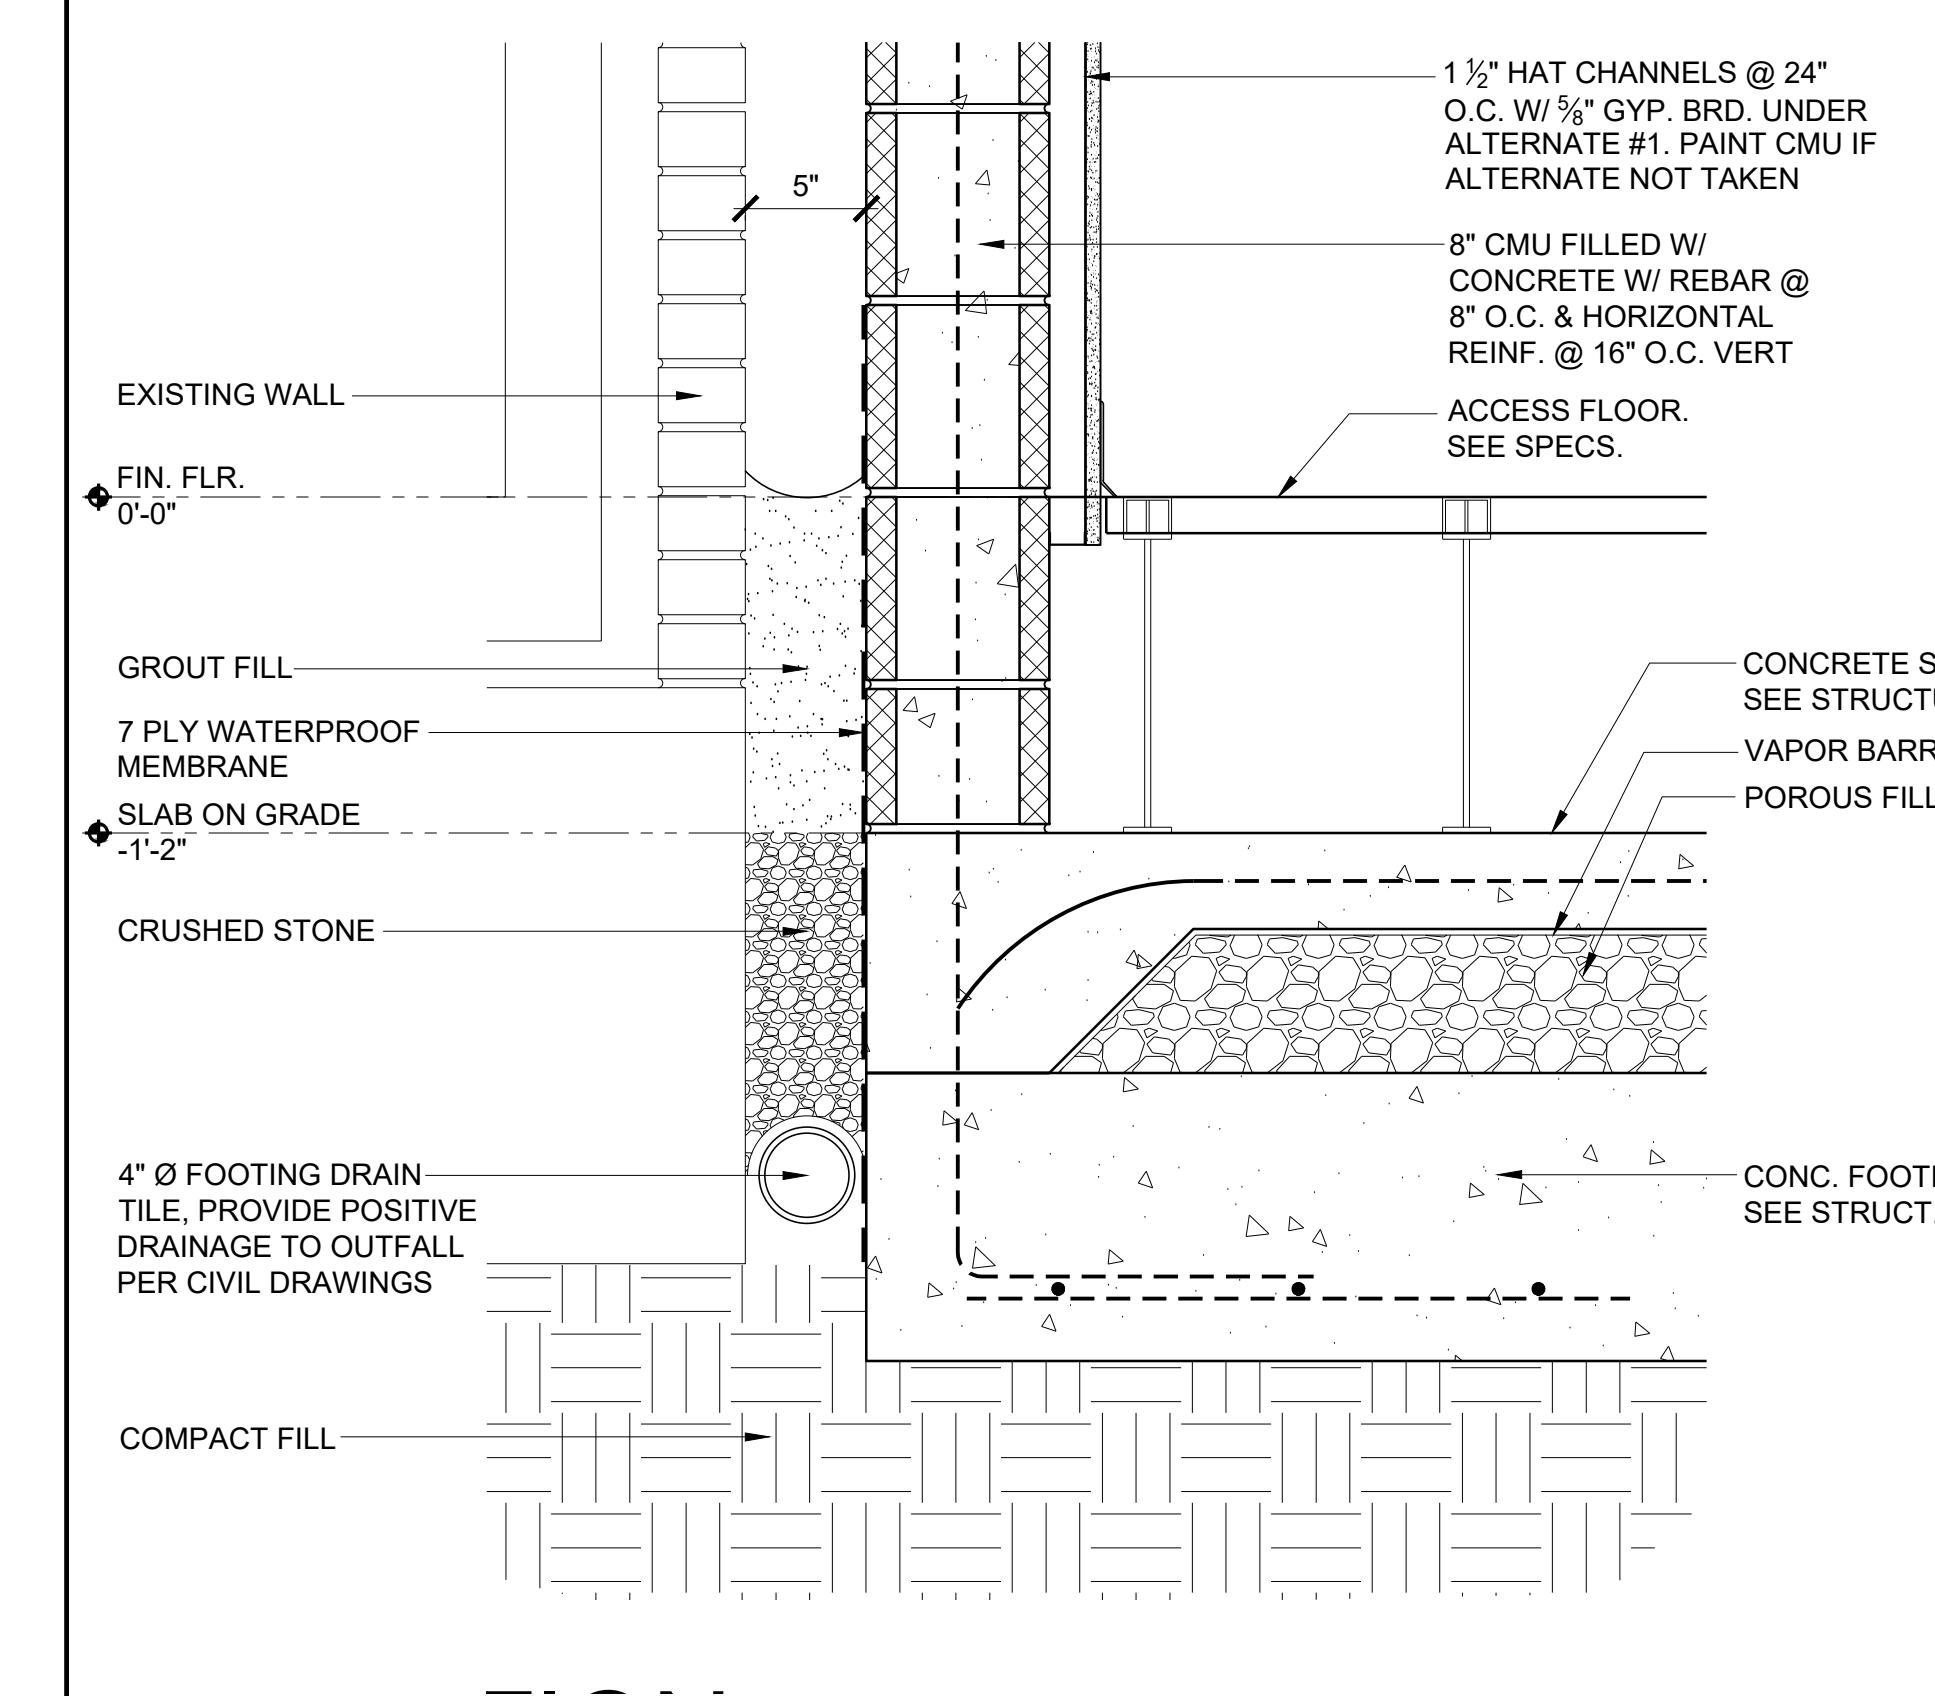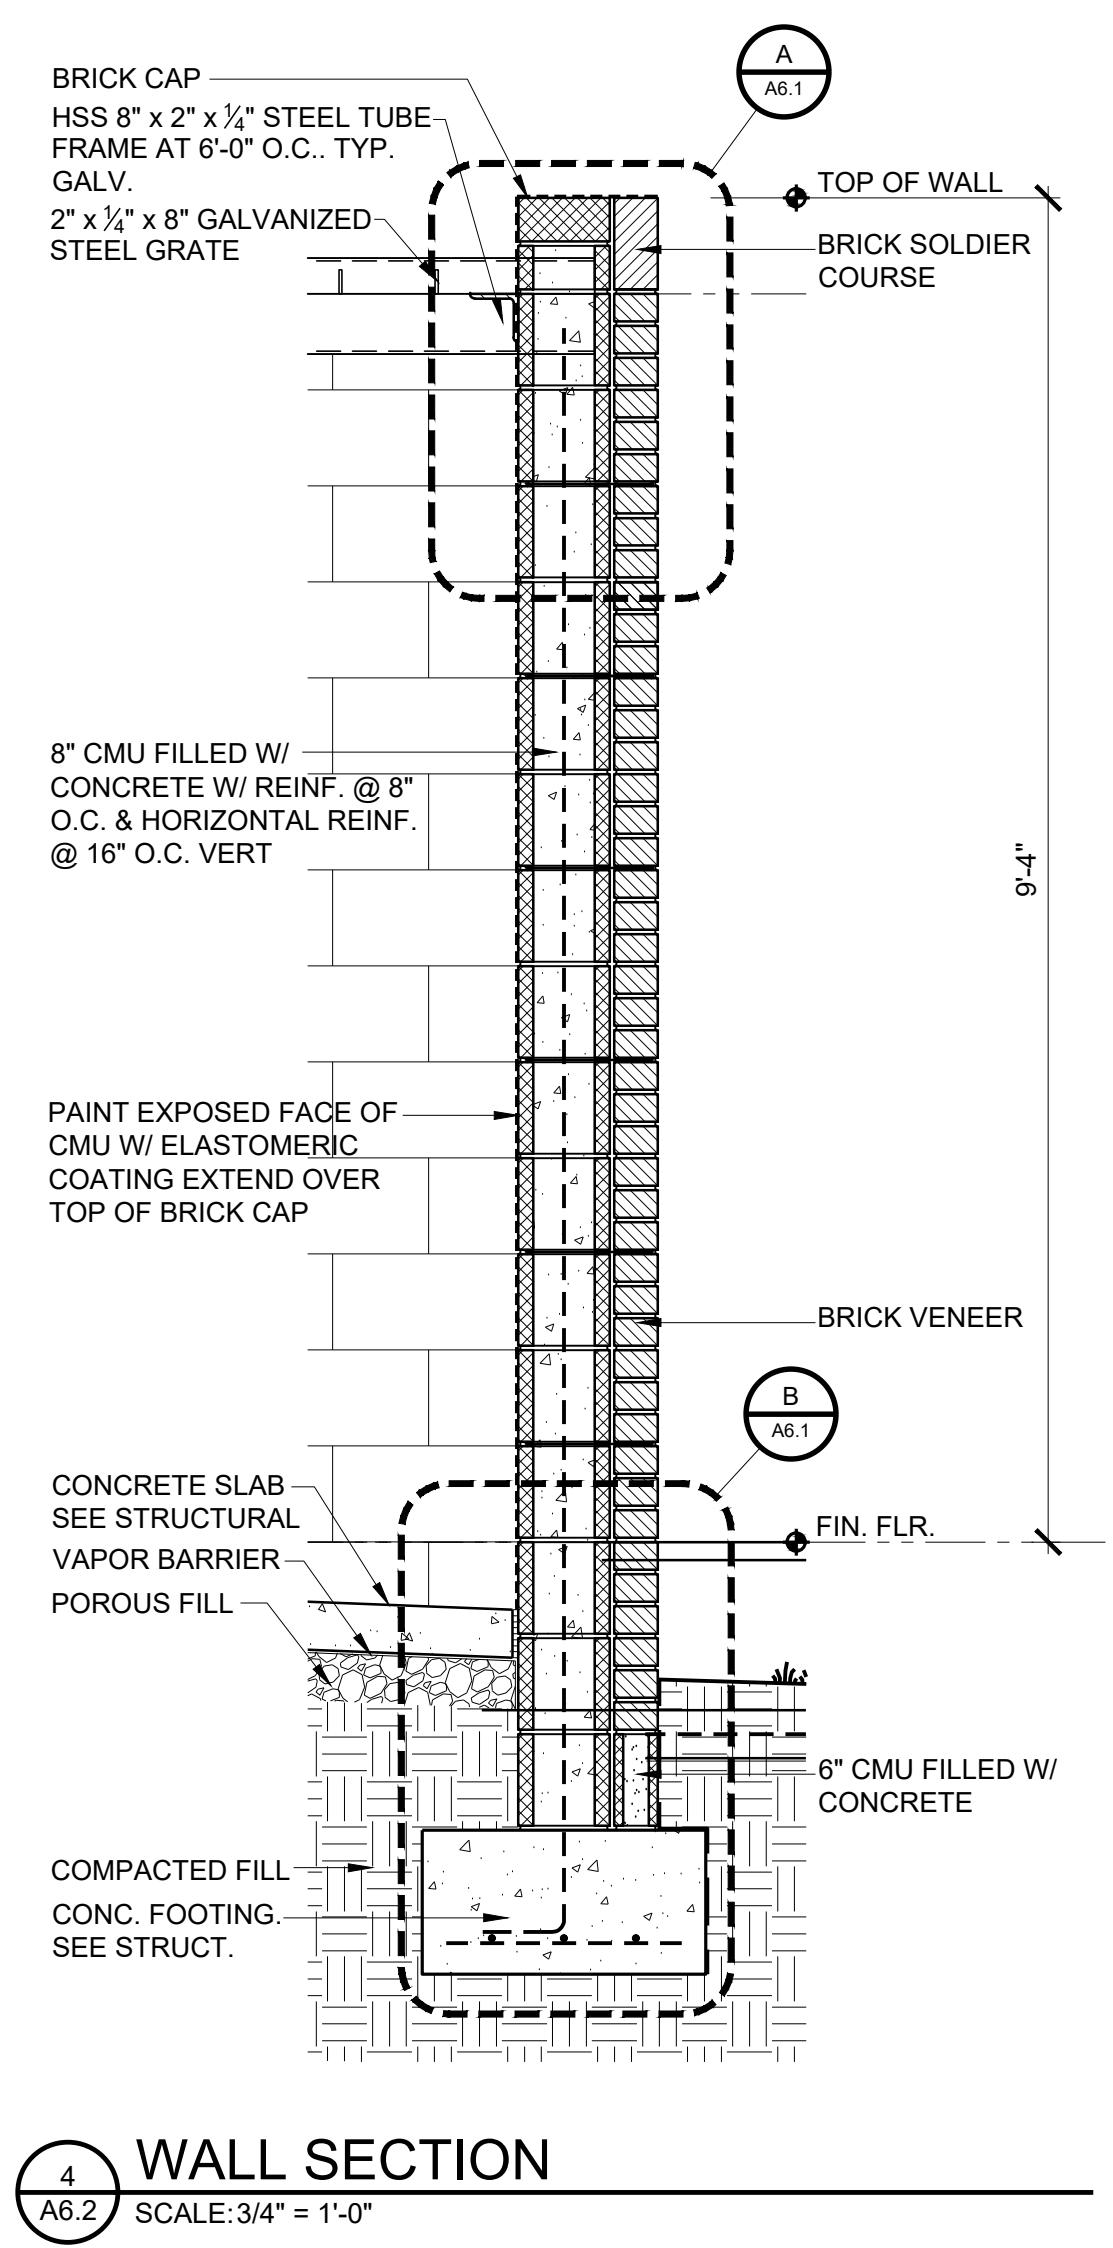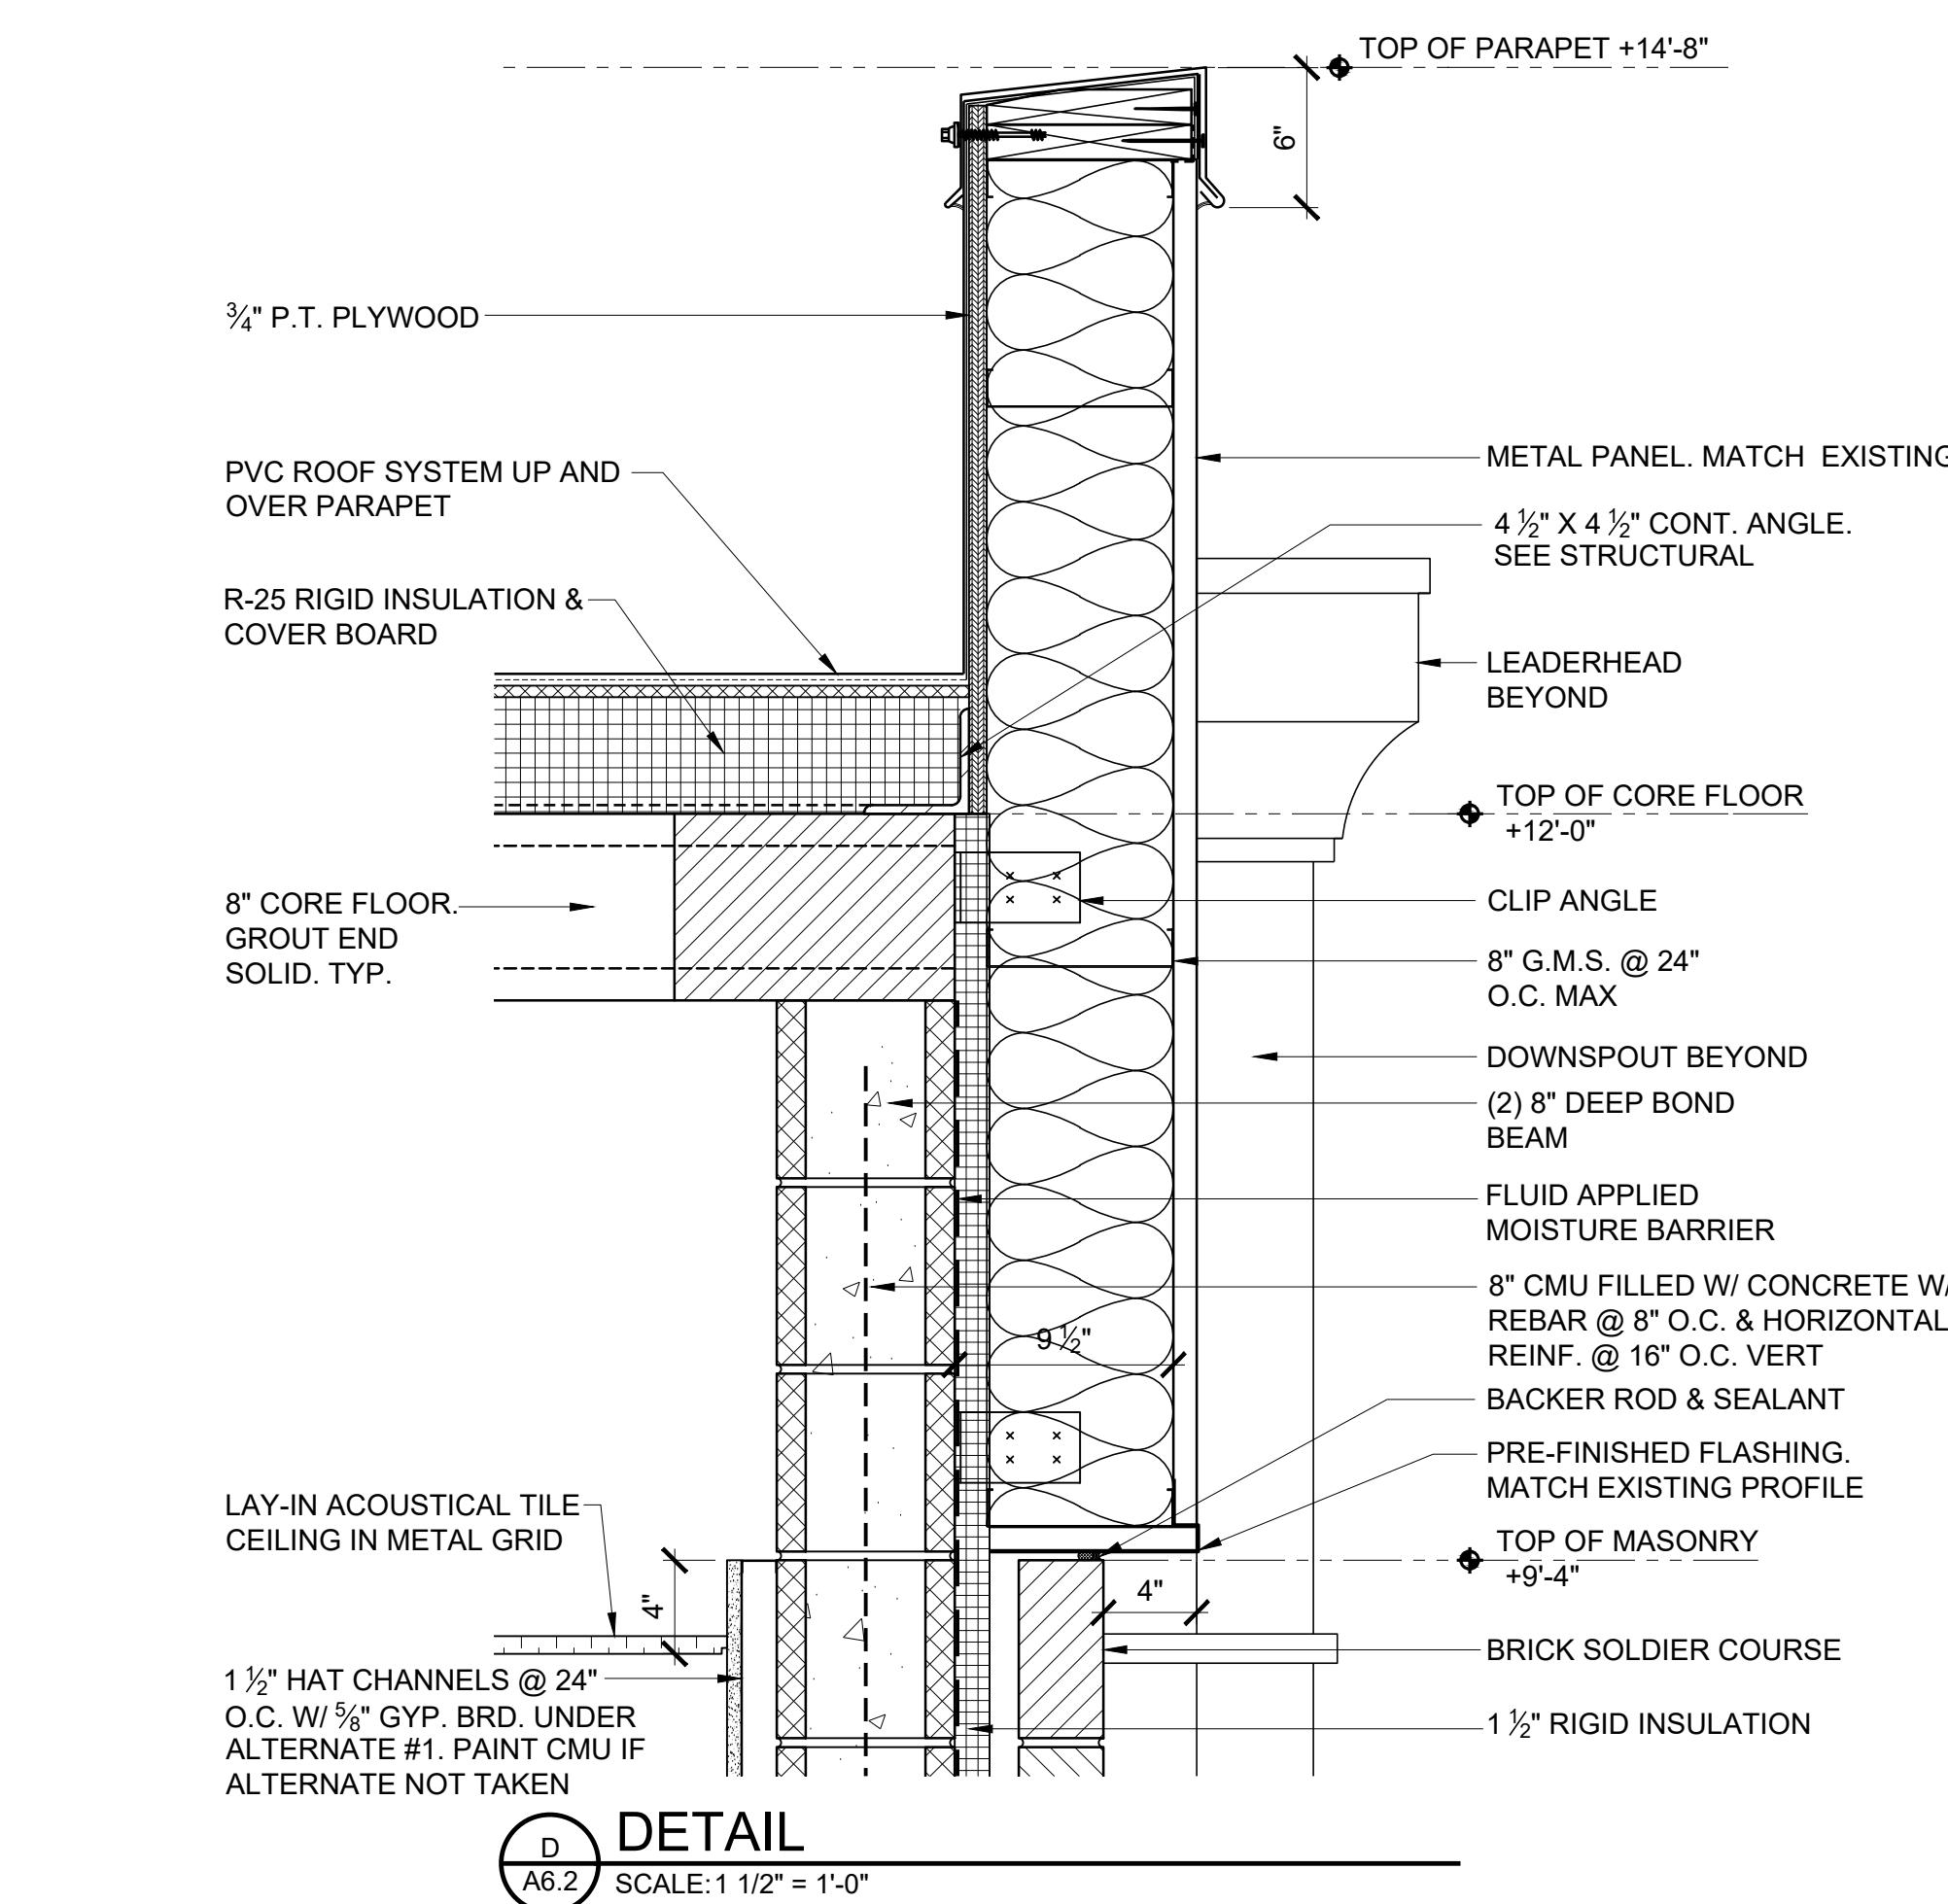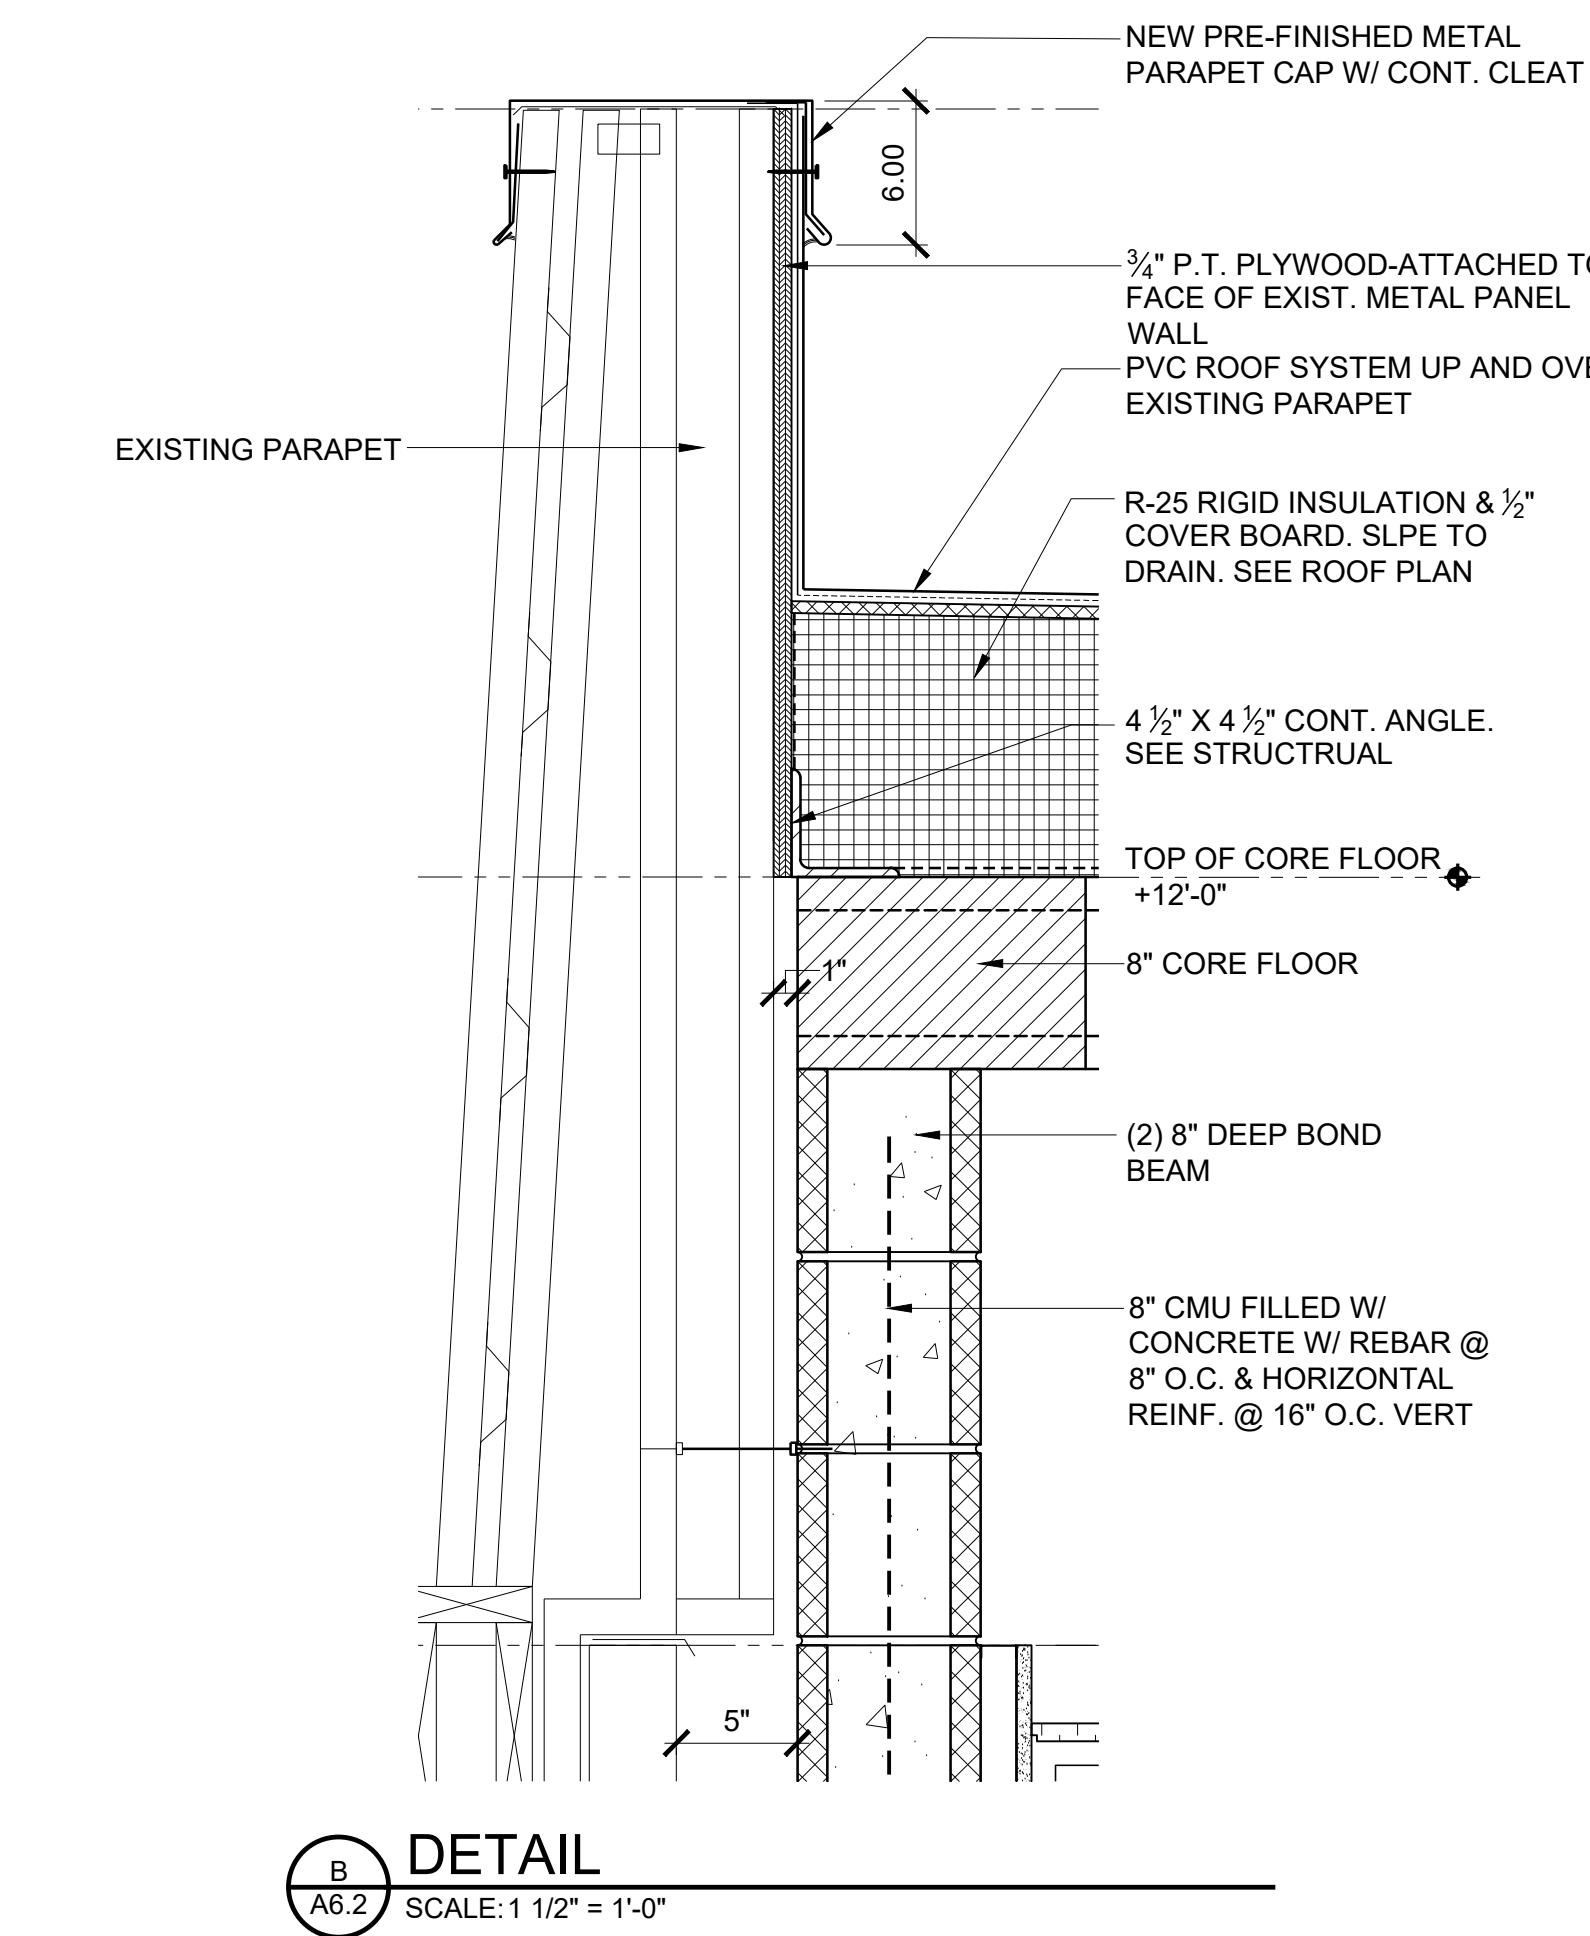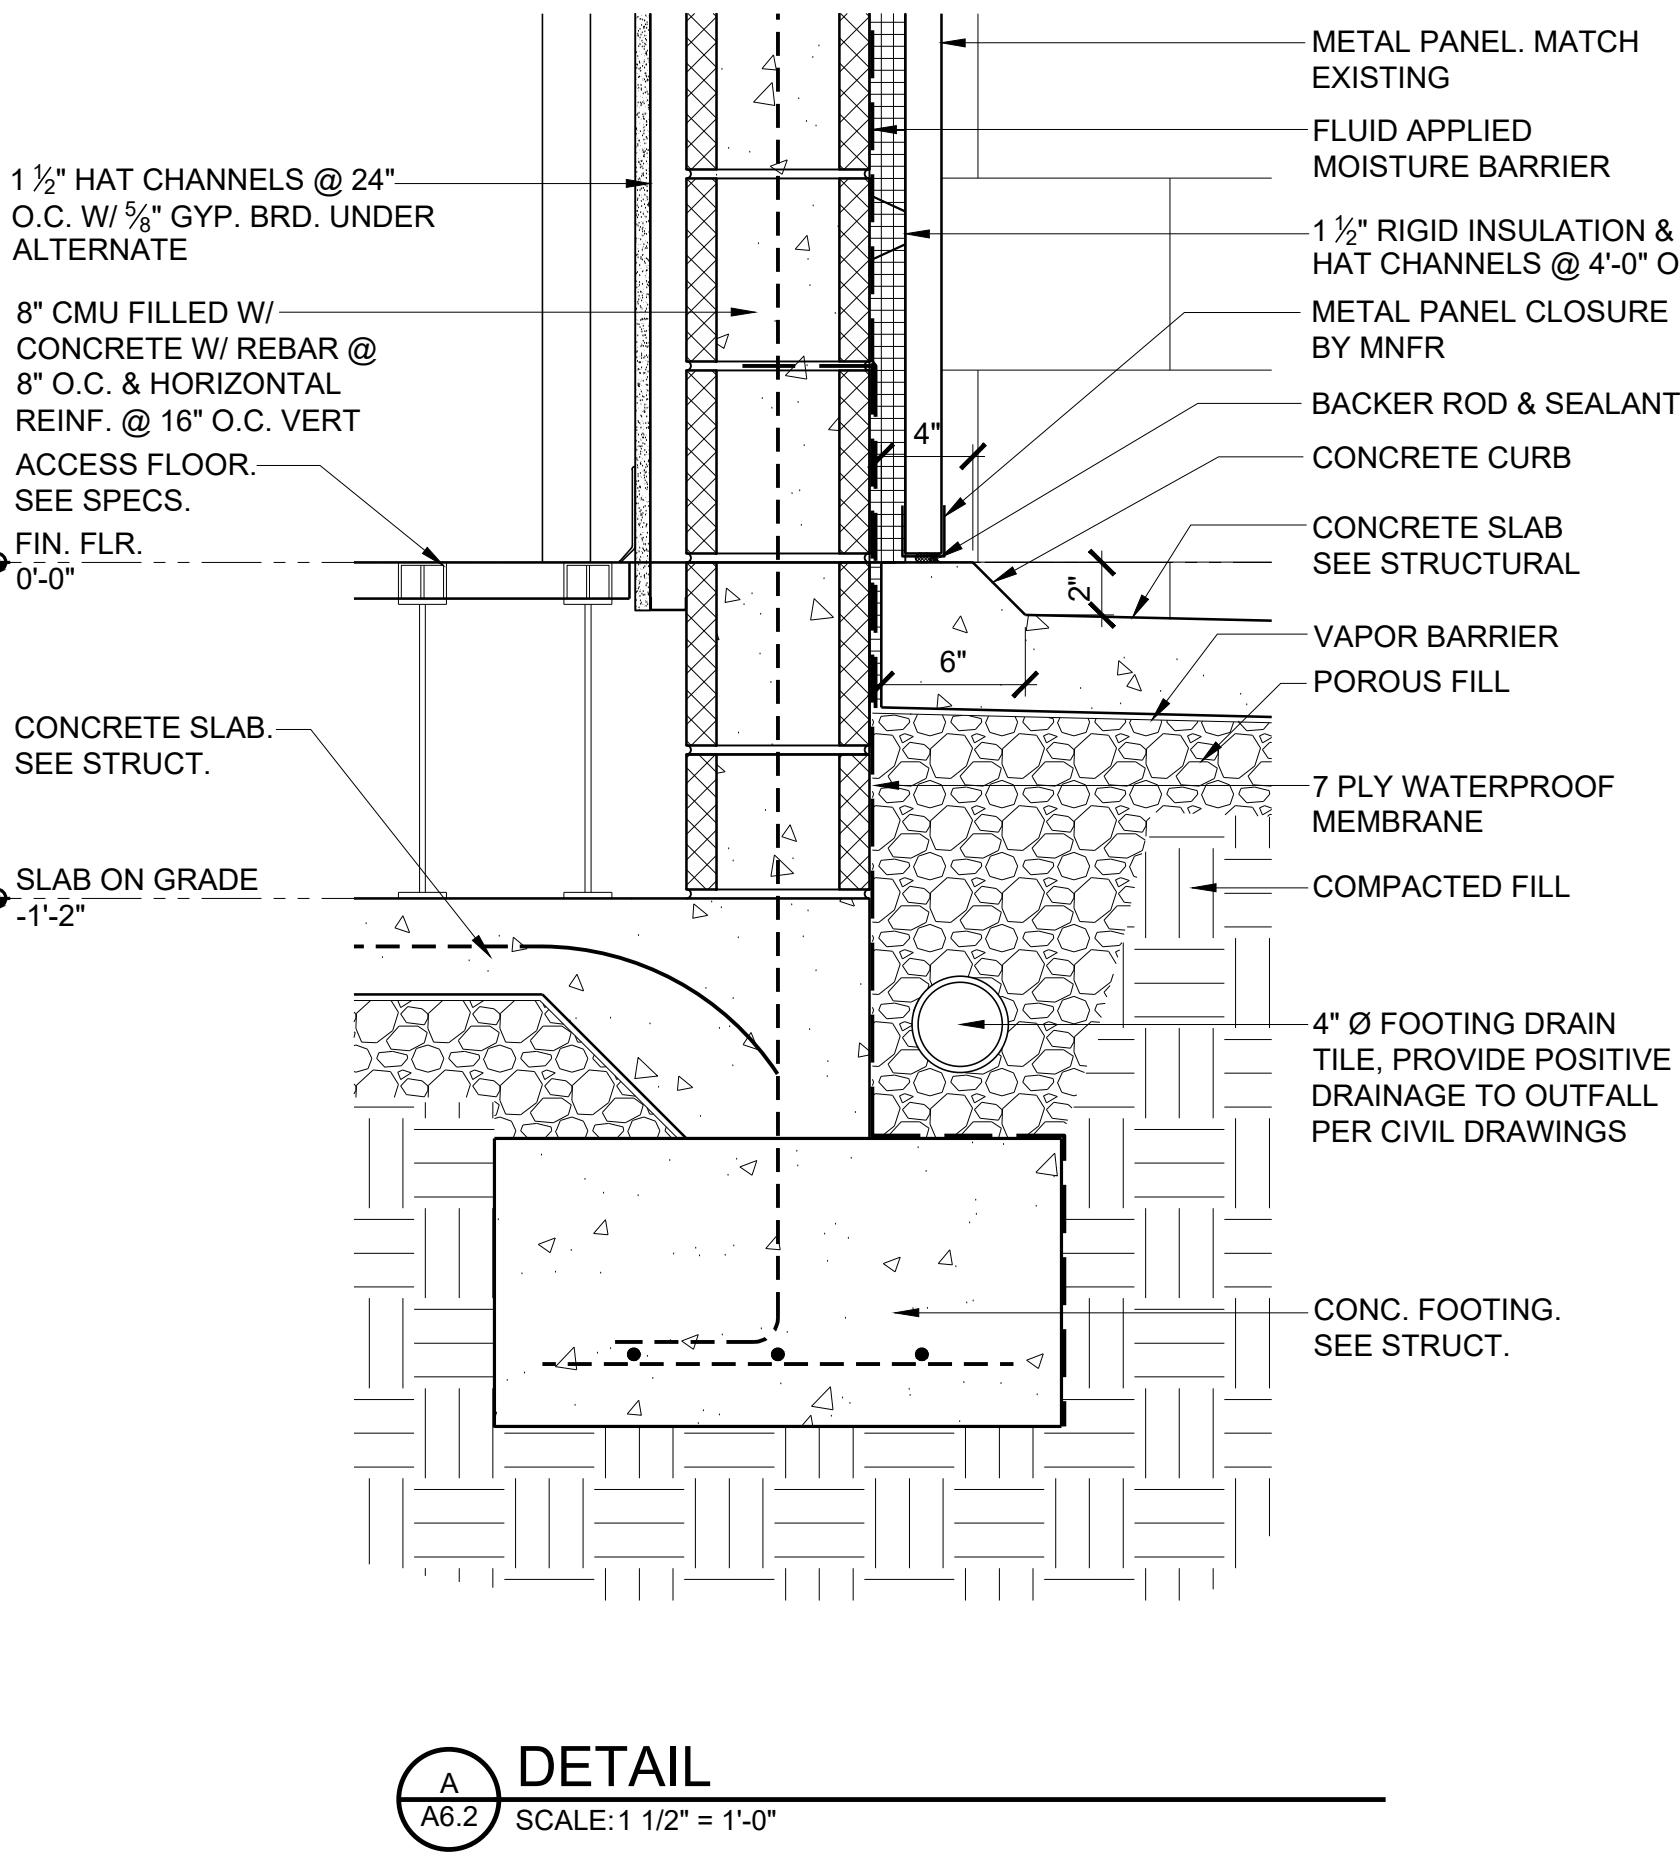

TALLAPOOSA CO E911 ADDITION TO THE TALLAPOOSA COUNTY JAIL FACILITY

DADEVILLE, AL

CONSTRUCTION DOCUMENTS

Project Number: 25-1465

Date: 8 JANUARY 2026


Revisions:

Sheet Description

WALL SECTIONS AND DETAILS

Sheet Number

A6.2

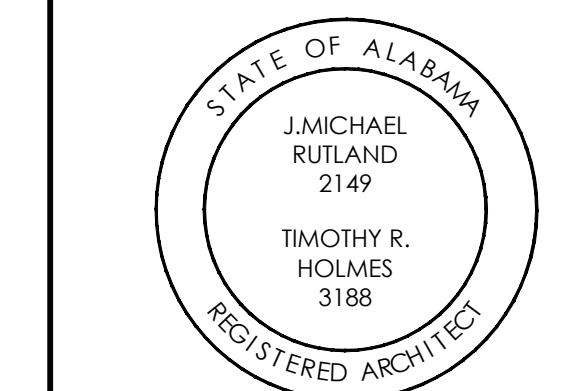

STATEMENT OF SPECIAL INSPECTIONS

SI.1 SPECIAL INSPECTIONS AND STRUCTURAL TESTING SHALL BE PROVIDED BY A QUALIFIED, INDEPENDENT AGENCY EMPLOYED BY THE OWNER FOR THE ITEMS SPECIFIED IN THIS SECTION AND IN OTHER AREAS OF THE APPROVED CONSTRUCTION DOCUMENTS.

SI.2 THE NAMES AND CREDENTIALS OF THE SPECIAL INSPECTOR(S) TO BE USED SHALL BE SUBMITTED TO THE BUILDING OFFICIAL FOR APPROVAL.

SI.3 DUTIES OF THE SPECIAL INSPECTOR:

- A. THE SPECIAL INSPECTOR SHALL REVIEW ALL WORK LISTED IN THE SCHEDULE OF SPECIAL INSPECTIONS FOR CONFORMANCE WITH THE APPROVED CONSTRUCTION DOCUMENTS AND THE APPLICABLE BUILDING CODE.
- B. THE SPECIAL INSPECTOR SHALL FURNISH SPECIAL INSPECTION REPORTS TO THE ARCHITECT/ENGINEER OF RECORD, CONTRACTOR, OWNER, AND BUILDING OFFICIAL ON A WEEKLY BASIS, OR MORE FREQUENTLY, AS REQUIRED BY THE BUILDING OFFICIAL. ALL ITEMS NOT IN COMPLIANCE SHALL BE BROUGHT TO THE PROMPT ATTENTION OF THE CONTRACTOR FOR CORRECTION AND, IF UNCORRECTED, TO THE OWNER AND BUILDING OFFICIAL.
- C. ONCE CORRECTIONS HAVE BEEN MADE BY THE CONTRACTOR, THE SPECIAL INSPECTOR SHALL SUBMIT A FINAL SIGNED REPORT TO THE BUILDING OFFICIAL STATING THAT THE WORK REQUIRING SPECIAL INSPECTION WAS, TO THE BEST OF THE SPECIAL INSPECTOR'S KNOWLEDGE, IN CONFORMANCE WITH THE APPROVED CONSTRUCTION DOCUMENTS AND WORKMANSHIP PROVISIONS OF THE APPLICABLE BUILDING CODE.

SI.4 DUTIES OF THE CONTRACTOR:

- A. THE CONTRACTOR SHALL SUBMIT A WRITTEN STATEMENT OF RESPONSIBILITY TO THE OWNER AND THE BUILDING OFFICIAL PRIOR TO COMMENCEMENT OF WORK. IN ACCORDANCE WITH THE BUILDING CODE, THE STATEMENT OF RESPONSIBILITY SHALL CONTAIN ACKNOWLEDGEMENT OF THE SPECIAL INSPECTION REQUIREMENTS CONTAINED WITHIN THIS "STATEMENT OF SPECIAL INSPECTIONS".
- B. THE CONTRACTOR SHALL NOTIFY THE RESPONSIBLE SPECIAL INSPECTOR THAT WORK IS READY FOR INSPECTION AT LEAST ONE WORKING DAY (24 HOURS MINIMUM) BEFORE SUCH INSPECTION IS REQUIRED.
- C. ALL WORK REQUIRING SPECIAL INSPECTION SHALL REMAIN ACCESSIBLE AND EXPOSED UNTIL IT HAS BEEN OBSERVED BY THE SPECIAL INSPECTOR.

SI.5 REFERENCE THE "SCHEDULES OF SPECIAL INSPECTIONS" FOR THE TYPES, EXTENTS, AND FREQUENCY OF SPECIFIC ITEMS REQUIRING SPECIAL INSPECTIONS AND STRUCTURAL TESTS AS PART OF THIS PROJECT.

SI.6 DEFINITIONS:

PERIODIC: INSPECTOR IS INTERMITTENTLY PRESENT WHERE THE WORK HAS BEEN OR IS BEING PERFORMED.

CONTINUOUS: INSPECTOR IS CONTINUOUSLY PRESENT WHEN AND WHERE THE WORK IS BEING PERFORMED.

GENERAL - SPECIAL INSPECTIONS					
SYSTEM OR MATERIAL	IBC REFERENCE	CODE OR STANDARD REFERENCE	FREQUENCY (NOTE SI.6)		REMARKS
			CONTINUOUS	PERIODIC	
FABRICATORS	1705.10 1704.2.5				SPECIAL INSPECTION IS REQUIRED FOR STRUCTURAL LOAD-BEARING MEMBERS AND ASSEMBLIES FABRICATED ON THE PREMISES OF A FABRICATOR'S SHOP, SPECIAL INSPECTIONS SHALL BE PERFORMED DURING FABRICATION. PERFORMING SPECIAL INSPECTIONS IS NOT REQUIRED, WHERE FABRICATOR HAS BEEN APPROVED AS AN APPROVED FABRICATOR, PER SECTION 1704.2.5.1.
DEFERRED SUBMITTALS				X	SPECIAL INSPECTION REQUIREMENTS FOR DEFERRED SUBMITTAL ITEMS, INCLUDING REQUIREMENTS FOR DESIGNATED SEISMIC SYSTEMS IN ACCORDANCE WITH IBC SECTION 1705.12.4 IF APPLICABLE, TO BE SPECIFIED BY THE SYSTEM ENGINEER AND INCLUDED WITH DEFERRED SUBMITTAL DOCUMENTS.
SUBMITTALS TO THE BUILDING OFFICIAL	1704.5			X	CERTIFICATES OF COMPLIANCE, REPORTS OF PRE-CONSTRUCTION TESTS, OR REPORTS OF MATERIAL PROPERTIES SHALL BE SUBMITTED TO THE BUILDING OFFICIAL.
POST INSTALLED MECHANICAL ANCHORS AND ADHESIVE ANCHORS IN HARDENED CONCRETE.				X	

SOILS/GEOTECHNICAL - SPECIAL INSPECTIONS					
SYSTEM OR MATERIAL	IBC REFERENCE	CODE OR STANDARDS REFERENCE	FREQUENCY (NOTE SI.6)		REMARKS
			CONTINUOUS	PERIODIC	
SOILS					
VERIFY MATERIALS BELOW SHALLOW FOUNDATIONS ARE ADEQUATE TO ACHIEVE THE DESIGN BEARING CAPACITY				X	
VERIFY EXCAVATIONS ARE EXTENDED TO PROPER DEPTH AND HAVE REACHED PROPER MATERIAL				X	
PERFORM CLASSIFICATION AND TESTING OF COMPACTED FILL MATERIALS				X	
VERIFY USE OF PROPER MATERIALS, DENSITIES AND LIFT THICKNESSES DURING PLACEMENT AND COMPACTION OF COMPACTED FILL			X		BY THE GEOTECHNICAL ENGINEER OR QUALIFIED SPECIAL INSPECTOR
PRIOR TO PLACEMENT OF COMPACTED FILL, INSPECT SUBGRADE AND VERIFY THAT SITE HAS BEEN PREPARED PROPERLY				X	

CONCRETE - SPECIAL INSPECTIONS					
SYSTEM OR MATERIAL	IBC REFERENCE	CODE OR STANDARD REFERENCE	FREQUENCY (NOTE SI.6)		REMARKS
			CONTINUOUS	PERIODIC	
GENERAL	1705.3 1901.6	ACI 318: 26.13			SPECIAL INSPECTIONS OF CONCRETE SHALL CONFORM TO THE REQUIREMENTS OF SECTION 1705.3 OF THE IBC AND SECTION 26.13 OF ACI 318.
REINFORCING STEEL PLACEMENT	1901.5.2	ACI 318: CH. 20, 25.2, 25.3, 26.6.1-26.6.3, 26.13.3.3		X	REINFORCING TO COMPLY WITH ALL CODE PROTECTION, SPACING AND TOLERANCE LIMITS.
WELDING REINFORCING STEEL					
1. VERIFICATION OF WELDABILITY OF REINFORCING STEEL OTHER THAN ASTM A706	1705.3.1 1705.3.2	AWS D1.4 ACI 318: 26.6.4		X	
2. INSPECT SINGLE-PASS FILLET WELDS, MAXIMUM 5/16" FILLET	1903.1 1903.2			X	
3. ALL OTHER REINFORCING STEEL WELDING,				X	
INSPECT ANCHORS/BOLTS CAST IN CONCRETE	-	ACI 318: 17.8.2		X	ALL CAST-IN-PLACE ANCHORS/BOLTS SHALL BE VISUALLY INSPECTED. REFERENCE STEEL INSPECTIONS FOR ADDITIONAL INSTALLATION, MATERIAL AND WELDING INSPECTIONS OF STEEL ITEMS EMBEDDED IN CONCRETE (HEADED STUDS, DBA'S, ETC.)
VERIFYING USE OF REQUIRED MIX DESIGN(S)	1904.1 1904.2	ACI 318: CH. 19, 26.4.3, 26.4.4		X	
CONCRETE SPECIMENS FOR TESTING		ASTM C172 ASTM C31 ACI 318: 26.5, 26.12	X		PRIOR TO CONCRETE PLACEMENT, FABRICATE CONCRETE SPECIMENS FOR TESTING. SEE THE CONCRETE TESTING TABLE FOR ADDITIONAL INFORMATION.
CONCRETE PLACEMENT		ACI 318: 26.5, 26.13.3.2(a)	X		
CONCRETE CURING		ACI 318: 26.5.3 - 26.5.5, 26.13.3.3		X	VERIFY MAINTENANCE OF SPECIFIED CURING TEMPERATURES AND TECHNIQUES
VERIFICATION OF FORMWORK		ACI 318: 26.11.1.2(b), 26.13.3.3	X		SPECIAL INSPECTIONS APPLY TO SHAPE, LOCATION AND DIMENSIONS OF THE CONCRETE MEMBER BEING FORMED

MASONRY - SPECIAL INSPECTIONS					
SYSTEM OR MATERIAL	IBC REFERENCE	CODE OR STANDARD REFERENCE	FREQUENCY (NOTE SI.6)		REMARKS
			CONTINUOUS	PERIODIC	
VERIFY COMPLIANCE WITH THE APPROVED SUBMITTALS	-	TMS 602		X	
AS MASONRY CONSTRUCTION BEGINS, VERIFY THAT THE FOLLOWING ARE IN COMPLIANCE:					
- PROPORTIONS OF SITE-PREPARED MORTAR					
- CONSTRUCTION OF MORTAR JOINTS					
- GRADE AND SIZE OF TENDONS/ANCHORAGES					
- LOCATION OF REINFORCEMENT/CONNECTORS					
PRIOR TO GROUTING, VERIFY THAT THE FOLLOWING ARE IN COMPLIANCE:					
- GROUT SPACE					
- GRADE, TYPE AND SIZE OF REINFORCEMENT/ANCHOR BOLTS					
- PLACEMENT OF REINFORCEMENT AND CONNECTORS					
- PROPORTIONS OF SITE-PREPARED GROUT					
- CONSTRUCTION OF MORTAR JOINTS					
VERIFY DURING CONSTRUCTION:					
- SIZE AND LOCATION OF STRUCTURAL ELEMENTS					
- TYPE, SIZE, AND LOCATION OF ANCHORS					
- WELDING OF REINFORCEMENT					
- PREPARATION, CONSTRUCTION, AND PROTECTION OF MASONRY DURING COLD WEATHER (BELOW 40°F) OR HOT WEATHER (ABOVE 90°F)					

CONSTRUCTION DOCUMENTS

PROJECT NUMBER 25-1465
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Revisions

Sheet Description

SPECIAL INSPECTIONS

Sheet Number

S1.1



TALLAPOOSA CO E911
ADDITION TO THE
TALLAPOOSA COUNTY JAIL
FACILITY
DADEVILLE, AL



TALLAPOOSA
CO E911
ADDITION TO
THE
TALLAPOOSA
COUNTY JAIL
FACILITY

DADEVILLE, AL

CONSTRUCTION
DOCUMENTS


PROJECT NUMBER 25-1465
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Sheet Description


TYPICAL
DETAILS

Sheet Number

S1.2

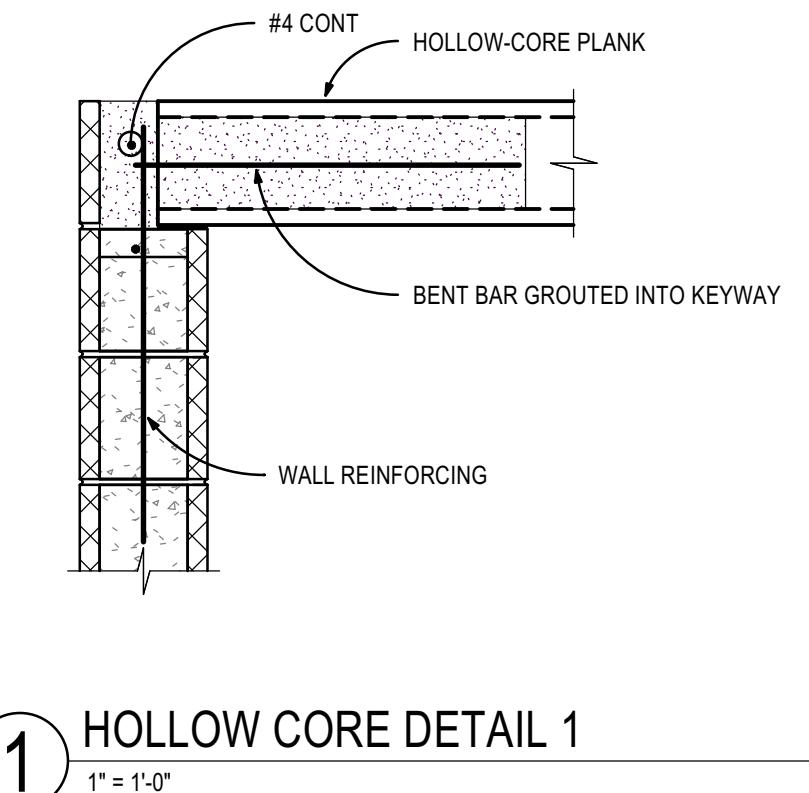

1 HOLLOW CORE DETAIL 1

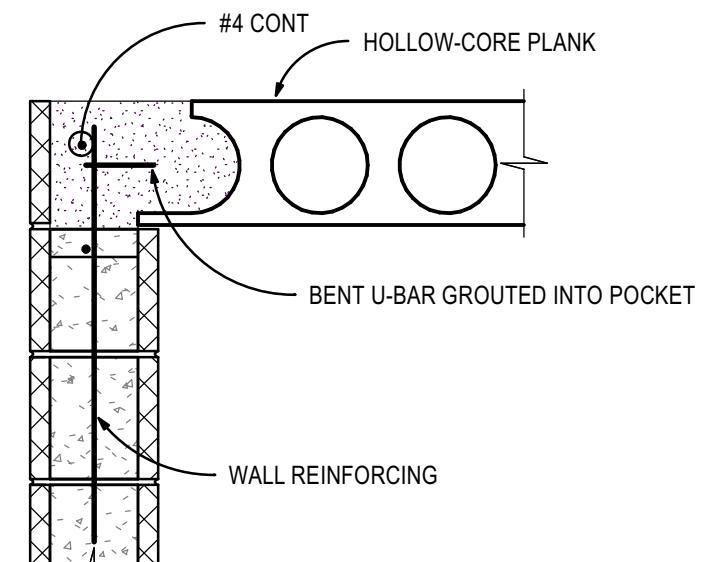


2 CONSTRUCTION JOINTS AT SLAB ON GRADE

Masonry Lintel Schedule

MAXIMUM OPENING WIDTH	BRICK LINTEL ANGLE	CMU LINTEL DIMENSIONS AND REINFORCING	
		DEPTH	8" WALL
2'-0"	L3 1/2x3 1/2x3/8	8	1#4 BOT
4'-0"	L3 1/2x3 1/2x3/8	8	1#4 BOT
6'-0"	L3 1/2x3 1/2x3/8	8	1#5 BOT & 1#4 TOP
8'-0"	L5x3 1/2x3/8	16	1#6 BOT & 1#5 TOP
10'-0"	---	16	1#7 BOT & 1#5 TOP
12'-0"	---	16	1#8 BOT & 1#5 TOP

1. DO NOT USE THIS SCHEDULE IF CONCENTRATED LOAD IS APPLIED
TO THE LINTEL AT A HEIGHT LESS THAN HALF THE SPAN ABOVE
THE LINTEL OR IF STACK BOND IS SPECIFIED.
2. PROVIDE 8" MINIMUM BEARING FOR ALL LINTELS.


5 MASONRY LINTEL SCHEDULE

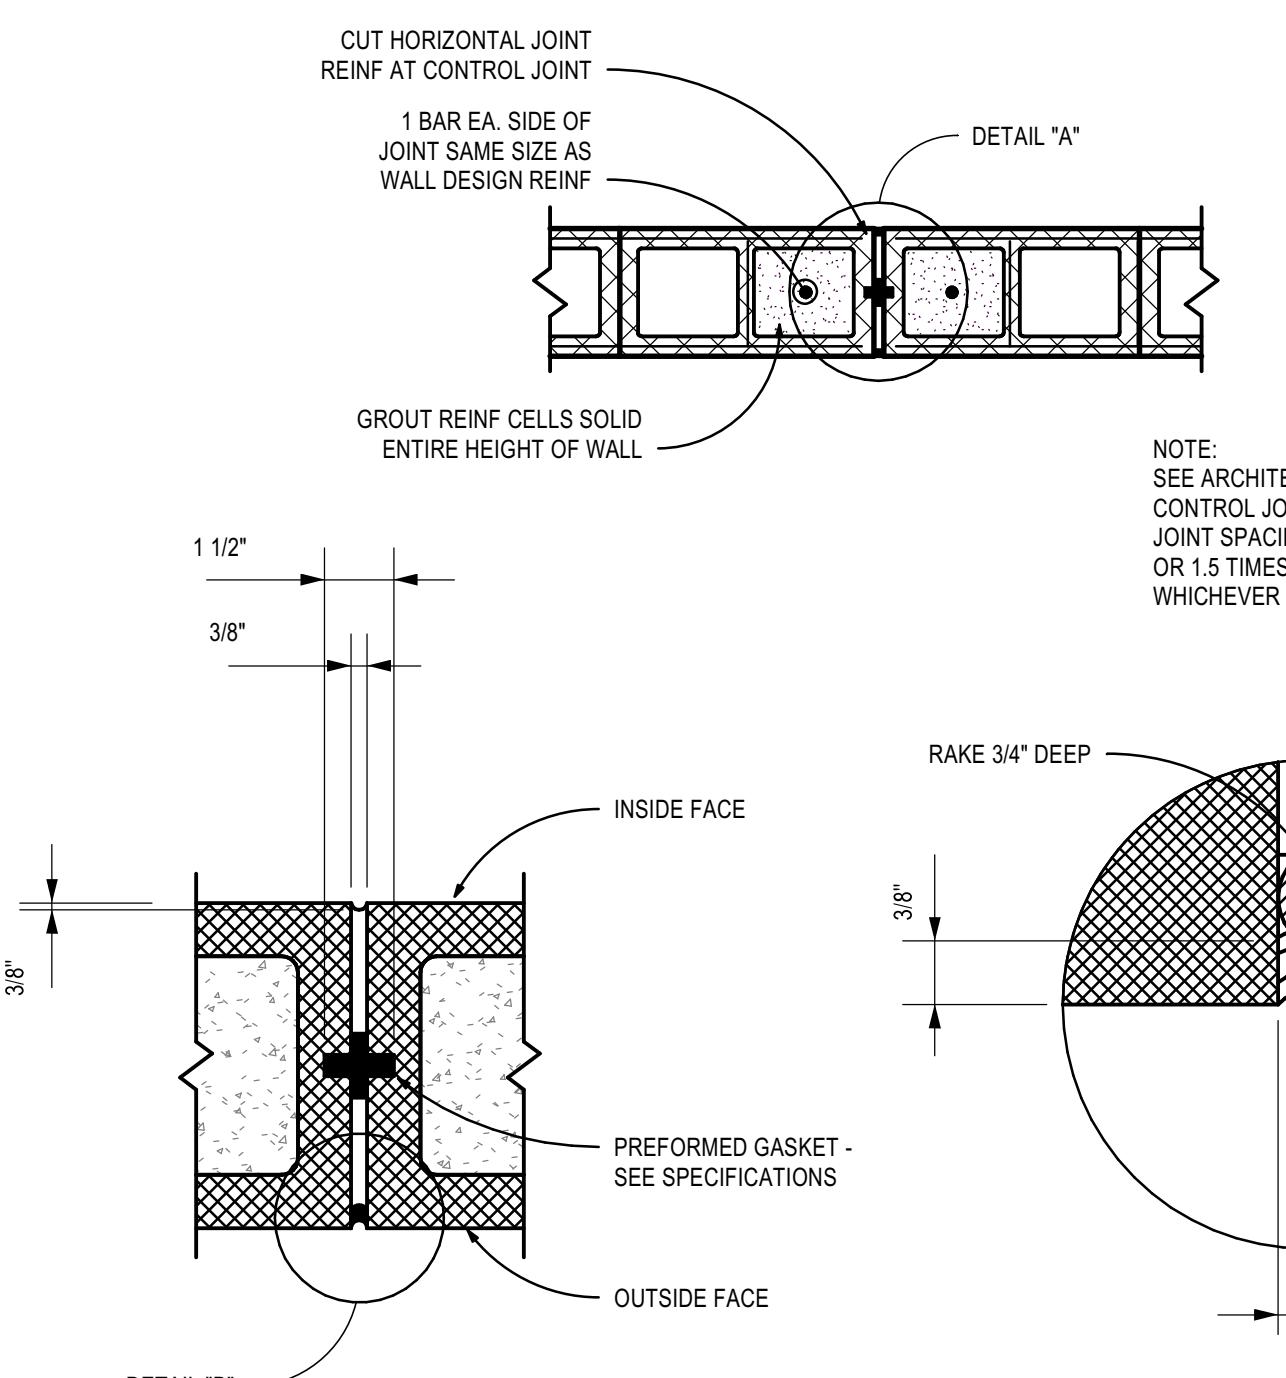

Detail "A"

Detail "B"


7 MASONRY CONTROL JOINT

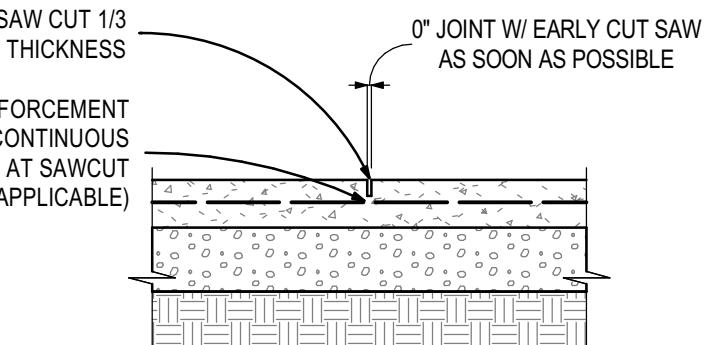

3 UNDER SLAB PREPARATION AT SLAB ON GRADE


NOTES:
1. CONTROL JOINT FILLER SEMI-RIGID EPOXY.
2. SAWCUT TO TAKE PLACE WITHIN 4-12 HOURS
OF FINISHING CONCRETE: 4 HOURS IN HOT WEATHER,
12 HOURS IN COLD WEATHER.

1' = 1'-0"

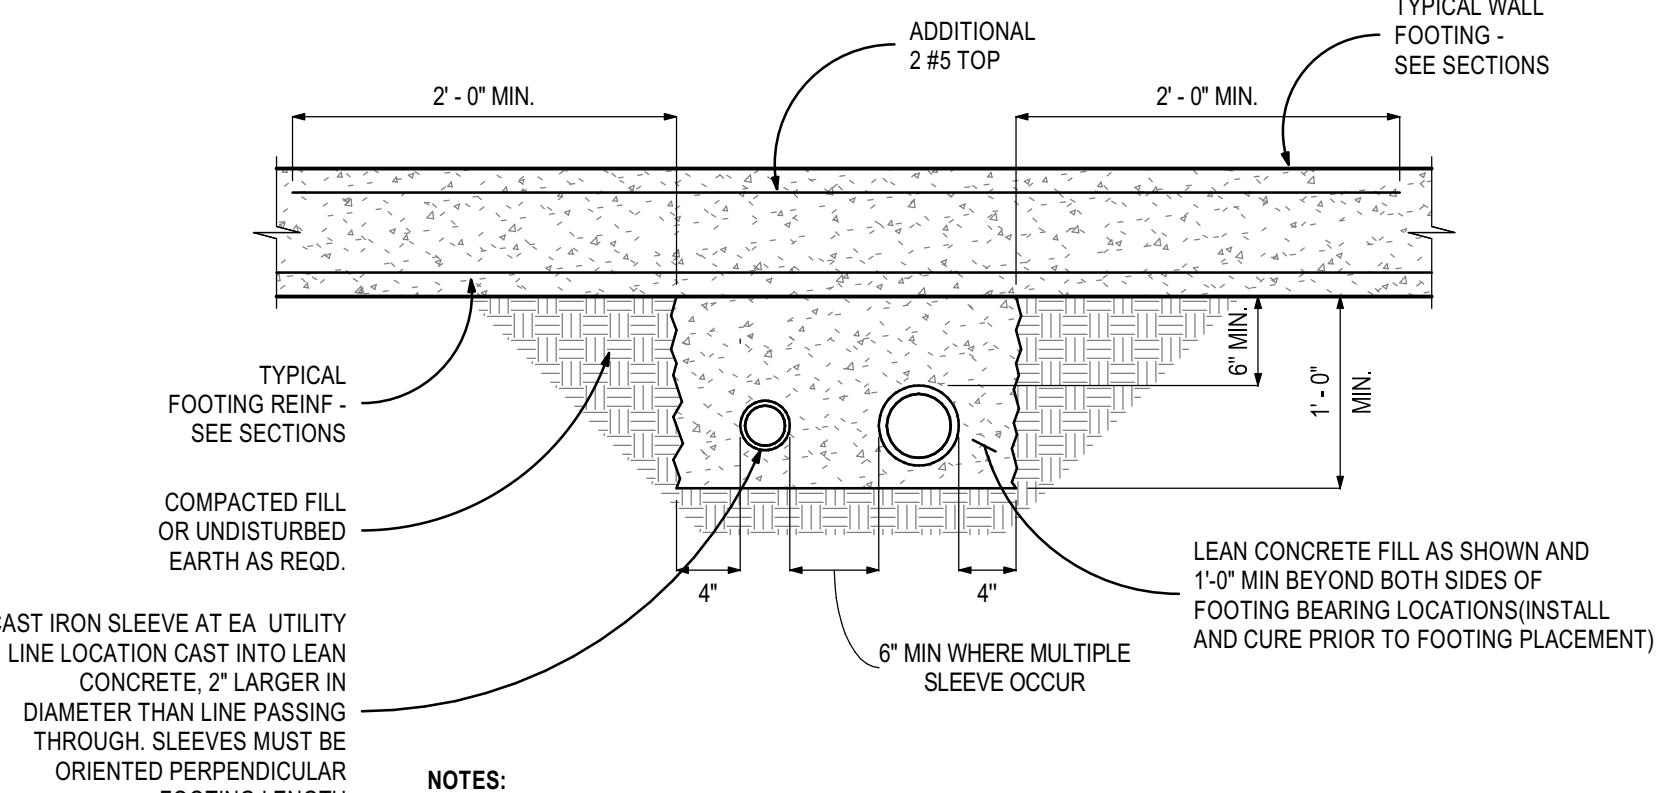


4 TYP. DETAIL FOR UTILITIES PASSING BELOW WALL
FOOTING

1' = 1'-0"

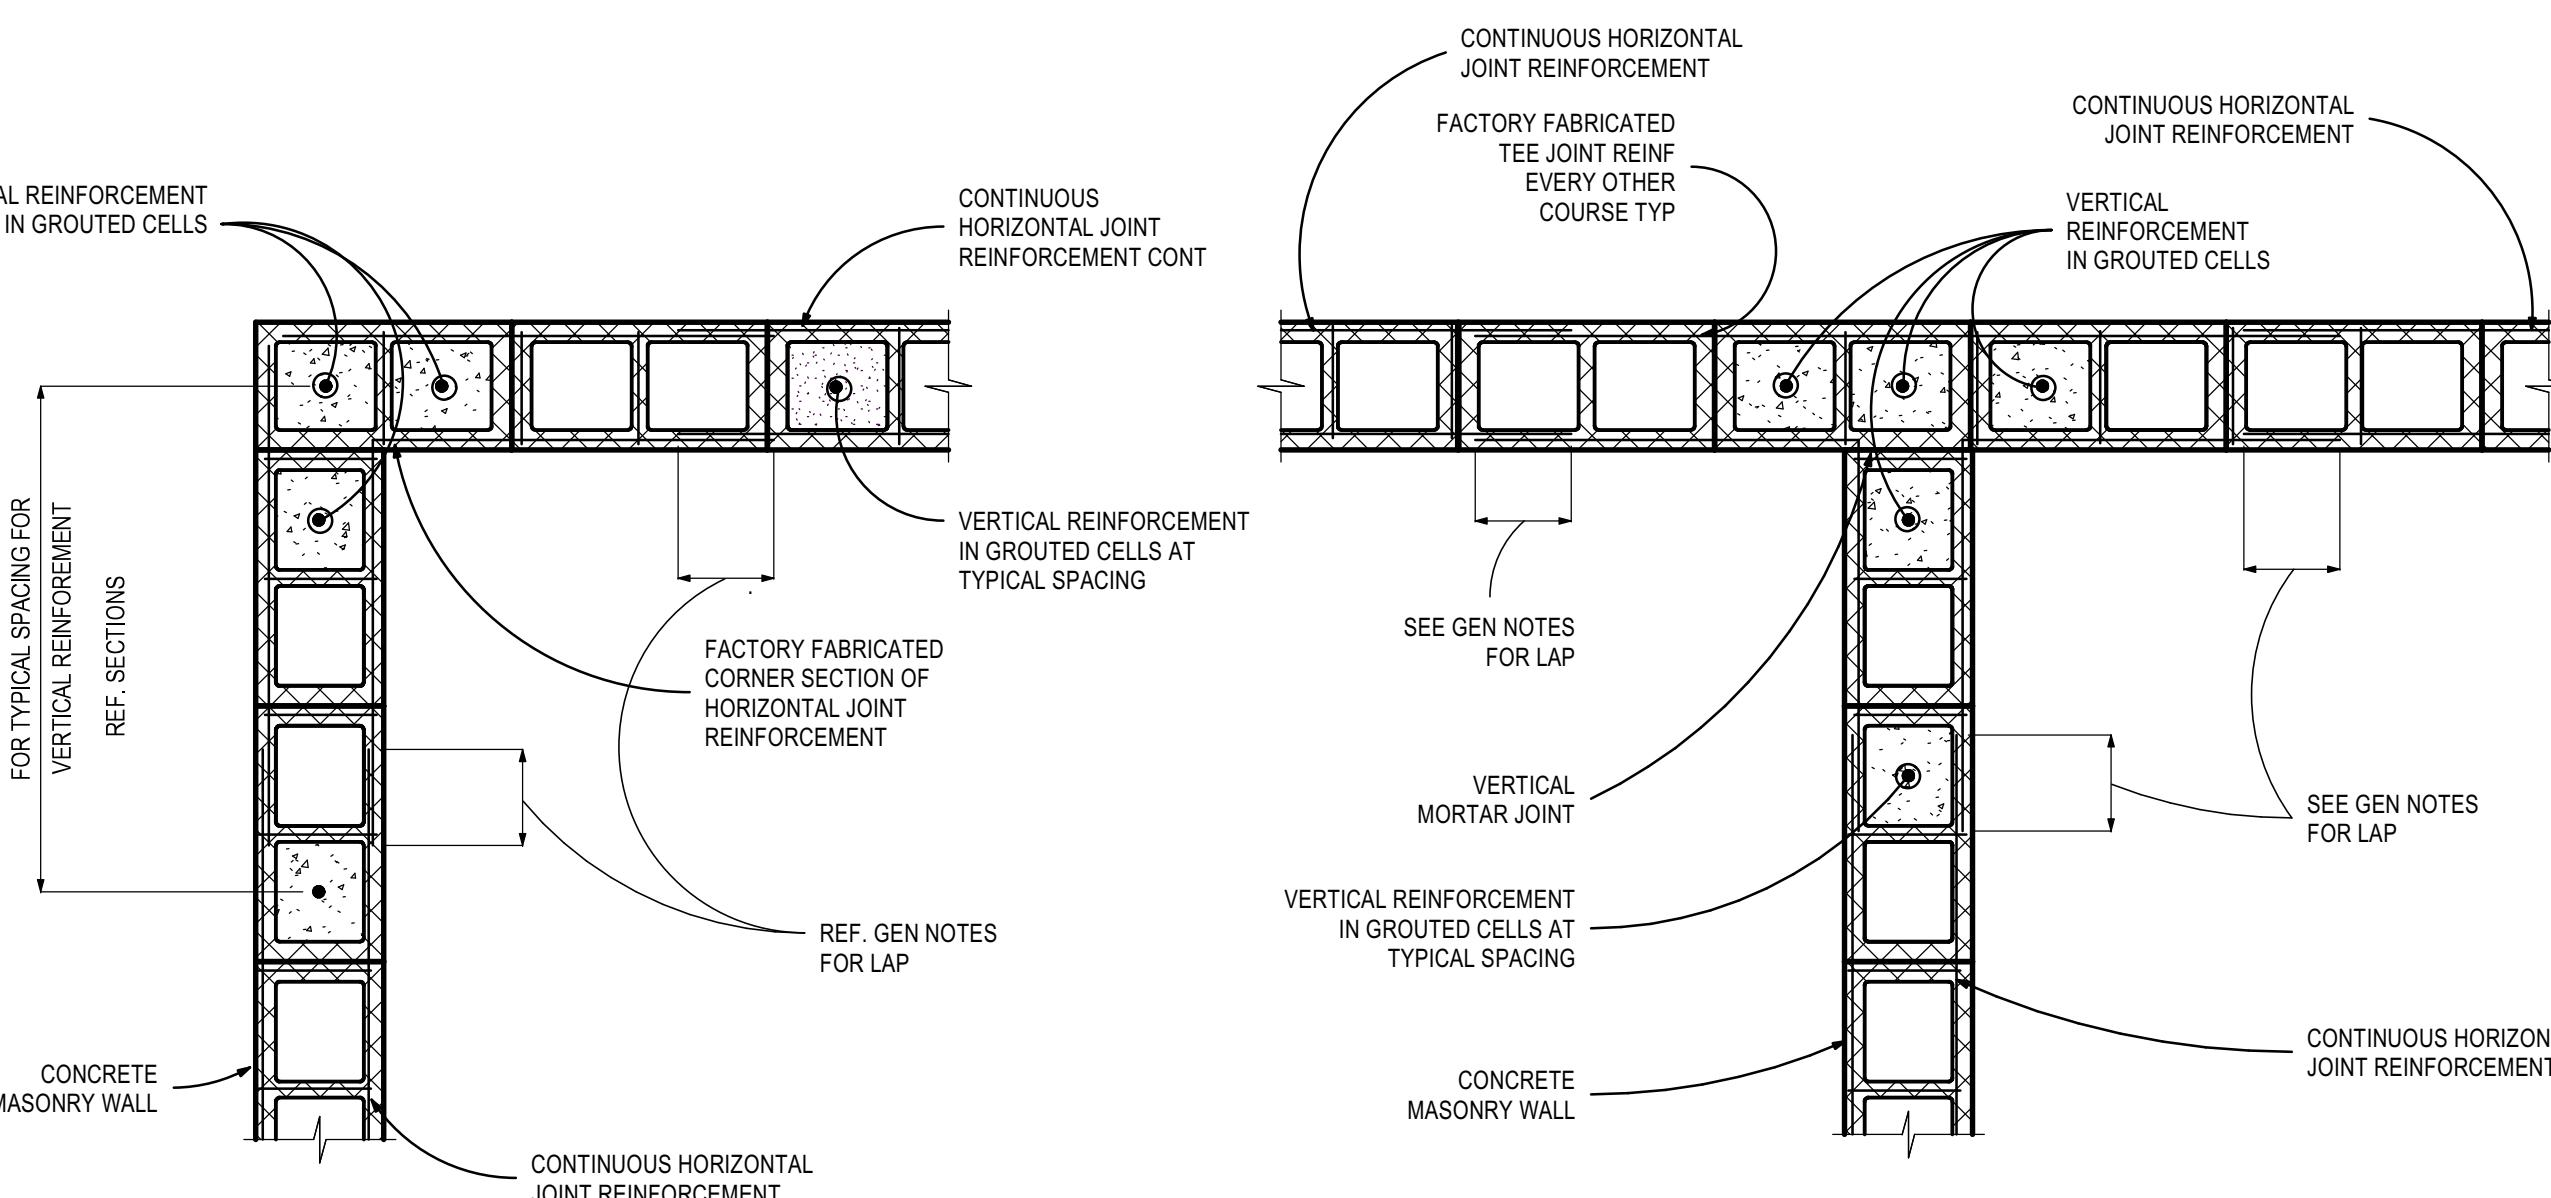

Plan Showing Joint Reinforcement
at Wall Corner

6 MASONRY WALL REINFORCING

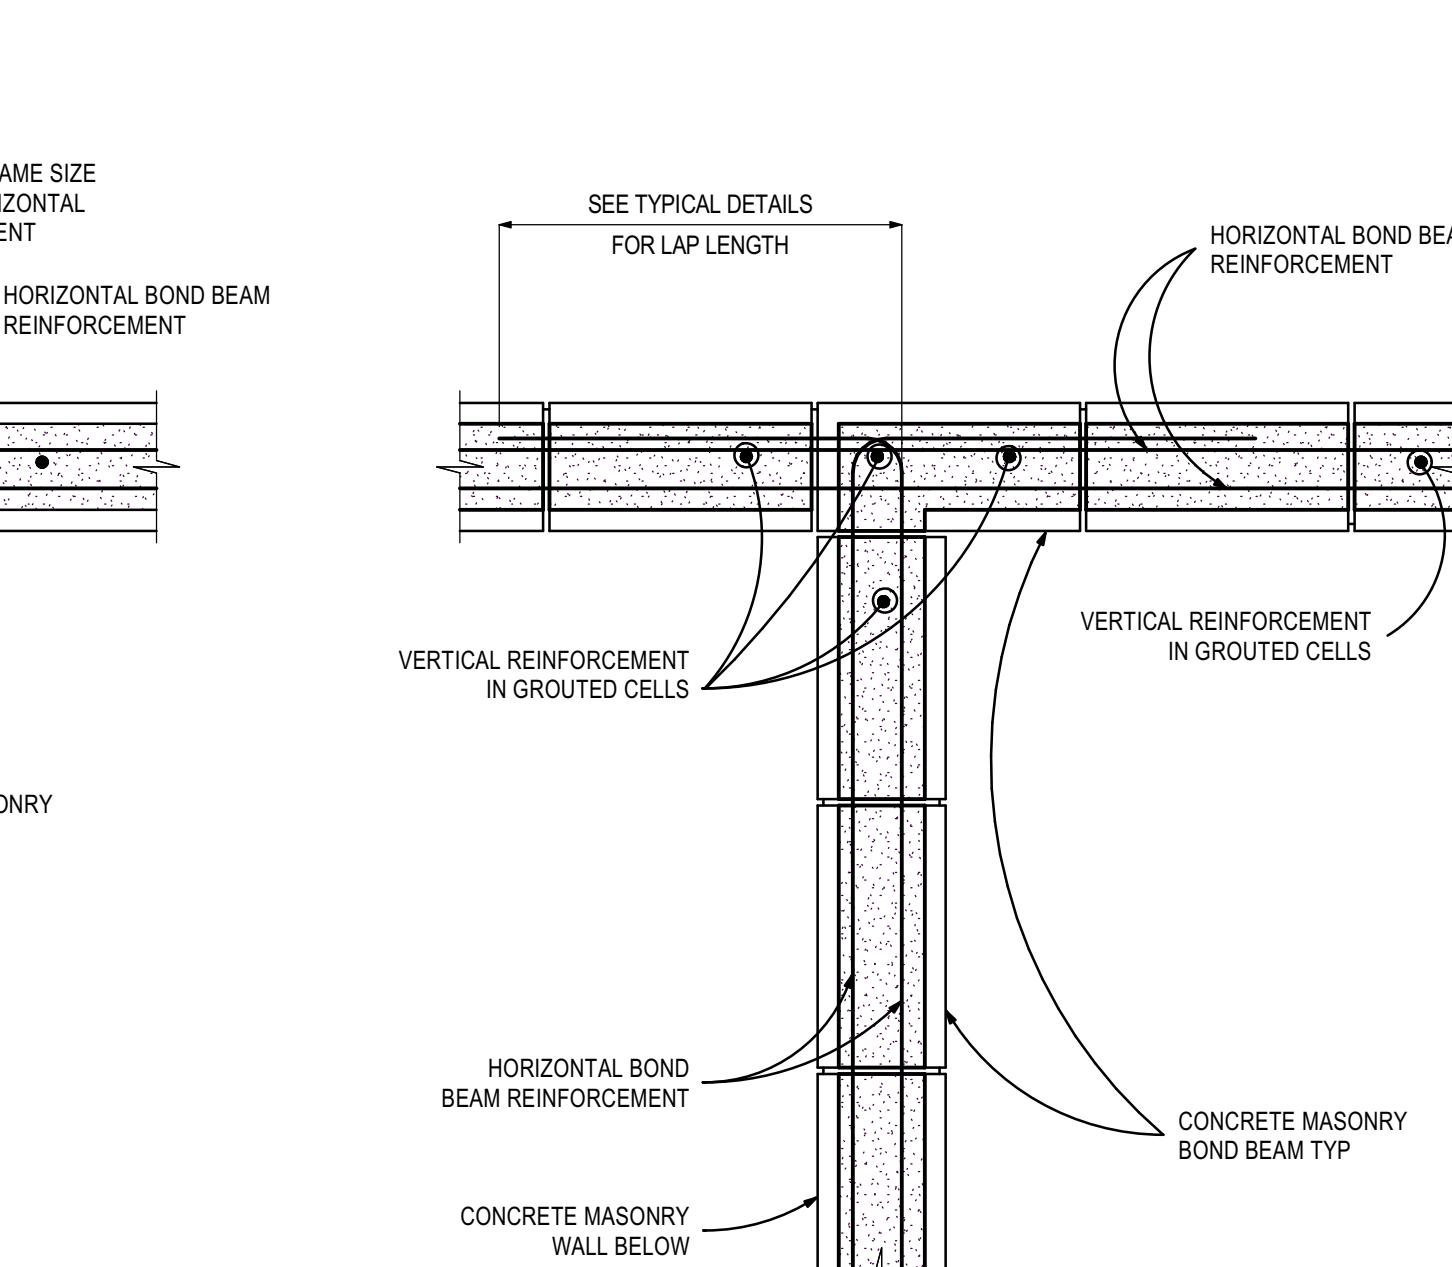

Plan Showing Bond Beam
Reinforcement at Wall Corner

BAR SIZE	fc = ALL			
	TOP BARS		BOTTOM BARS	
A	B	A	B	
#3	22"	28"	17"	22"
#4	29"	37"	22"	29"
#5	36"	47"	28"	36"
#6	43"	56"	33"	43"
#7	63"	81"	48"	63"
#8	72"	93"	55"	72"
#9	81"	105"	62"	81"
#10	91"	118"	70"	91"
#11	101"	131"	78"	101"

TOP BARS ARE HORIZONTAL REINFORCEMENT WITH MORE
THAN 12" OF CONCRETE CAST BELOW THE REINFORCEMENT.

8 MASONRY BOND BEAM REINFORCING

1' = 1'-0"

9 REBAR LAP SPLICE LENGTH

1' = 1'-0"



TALLAPOOSA
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ADDITION TO
THE
TALLAPOOSA
COUNTY JAIL
FACILITY

DADEVILLE, AL

CONSTRUCTION
DOCUMENTS


PROJECT NUMBER 25-1465
Issue Date 8 JANUARY 2026
Revisions

Sheet Description

FOUNDATION
PLAN

Sheet Number

S2.0

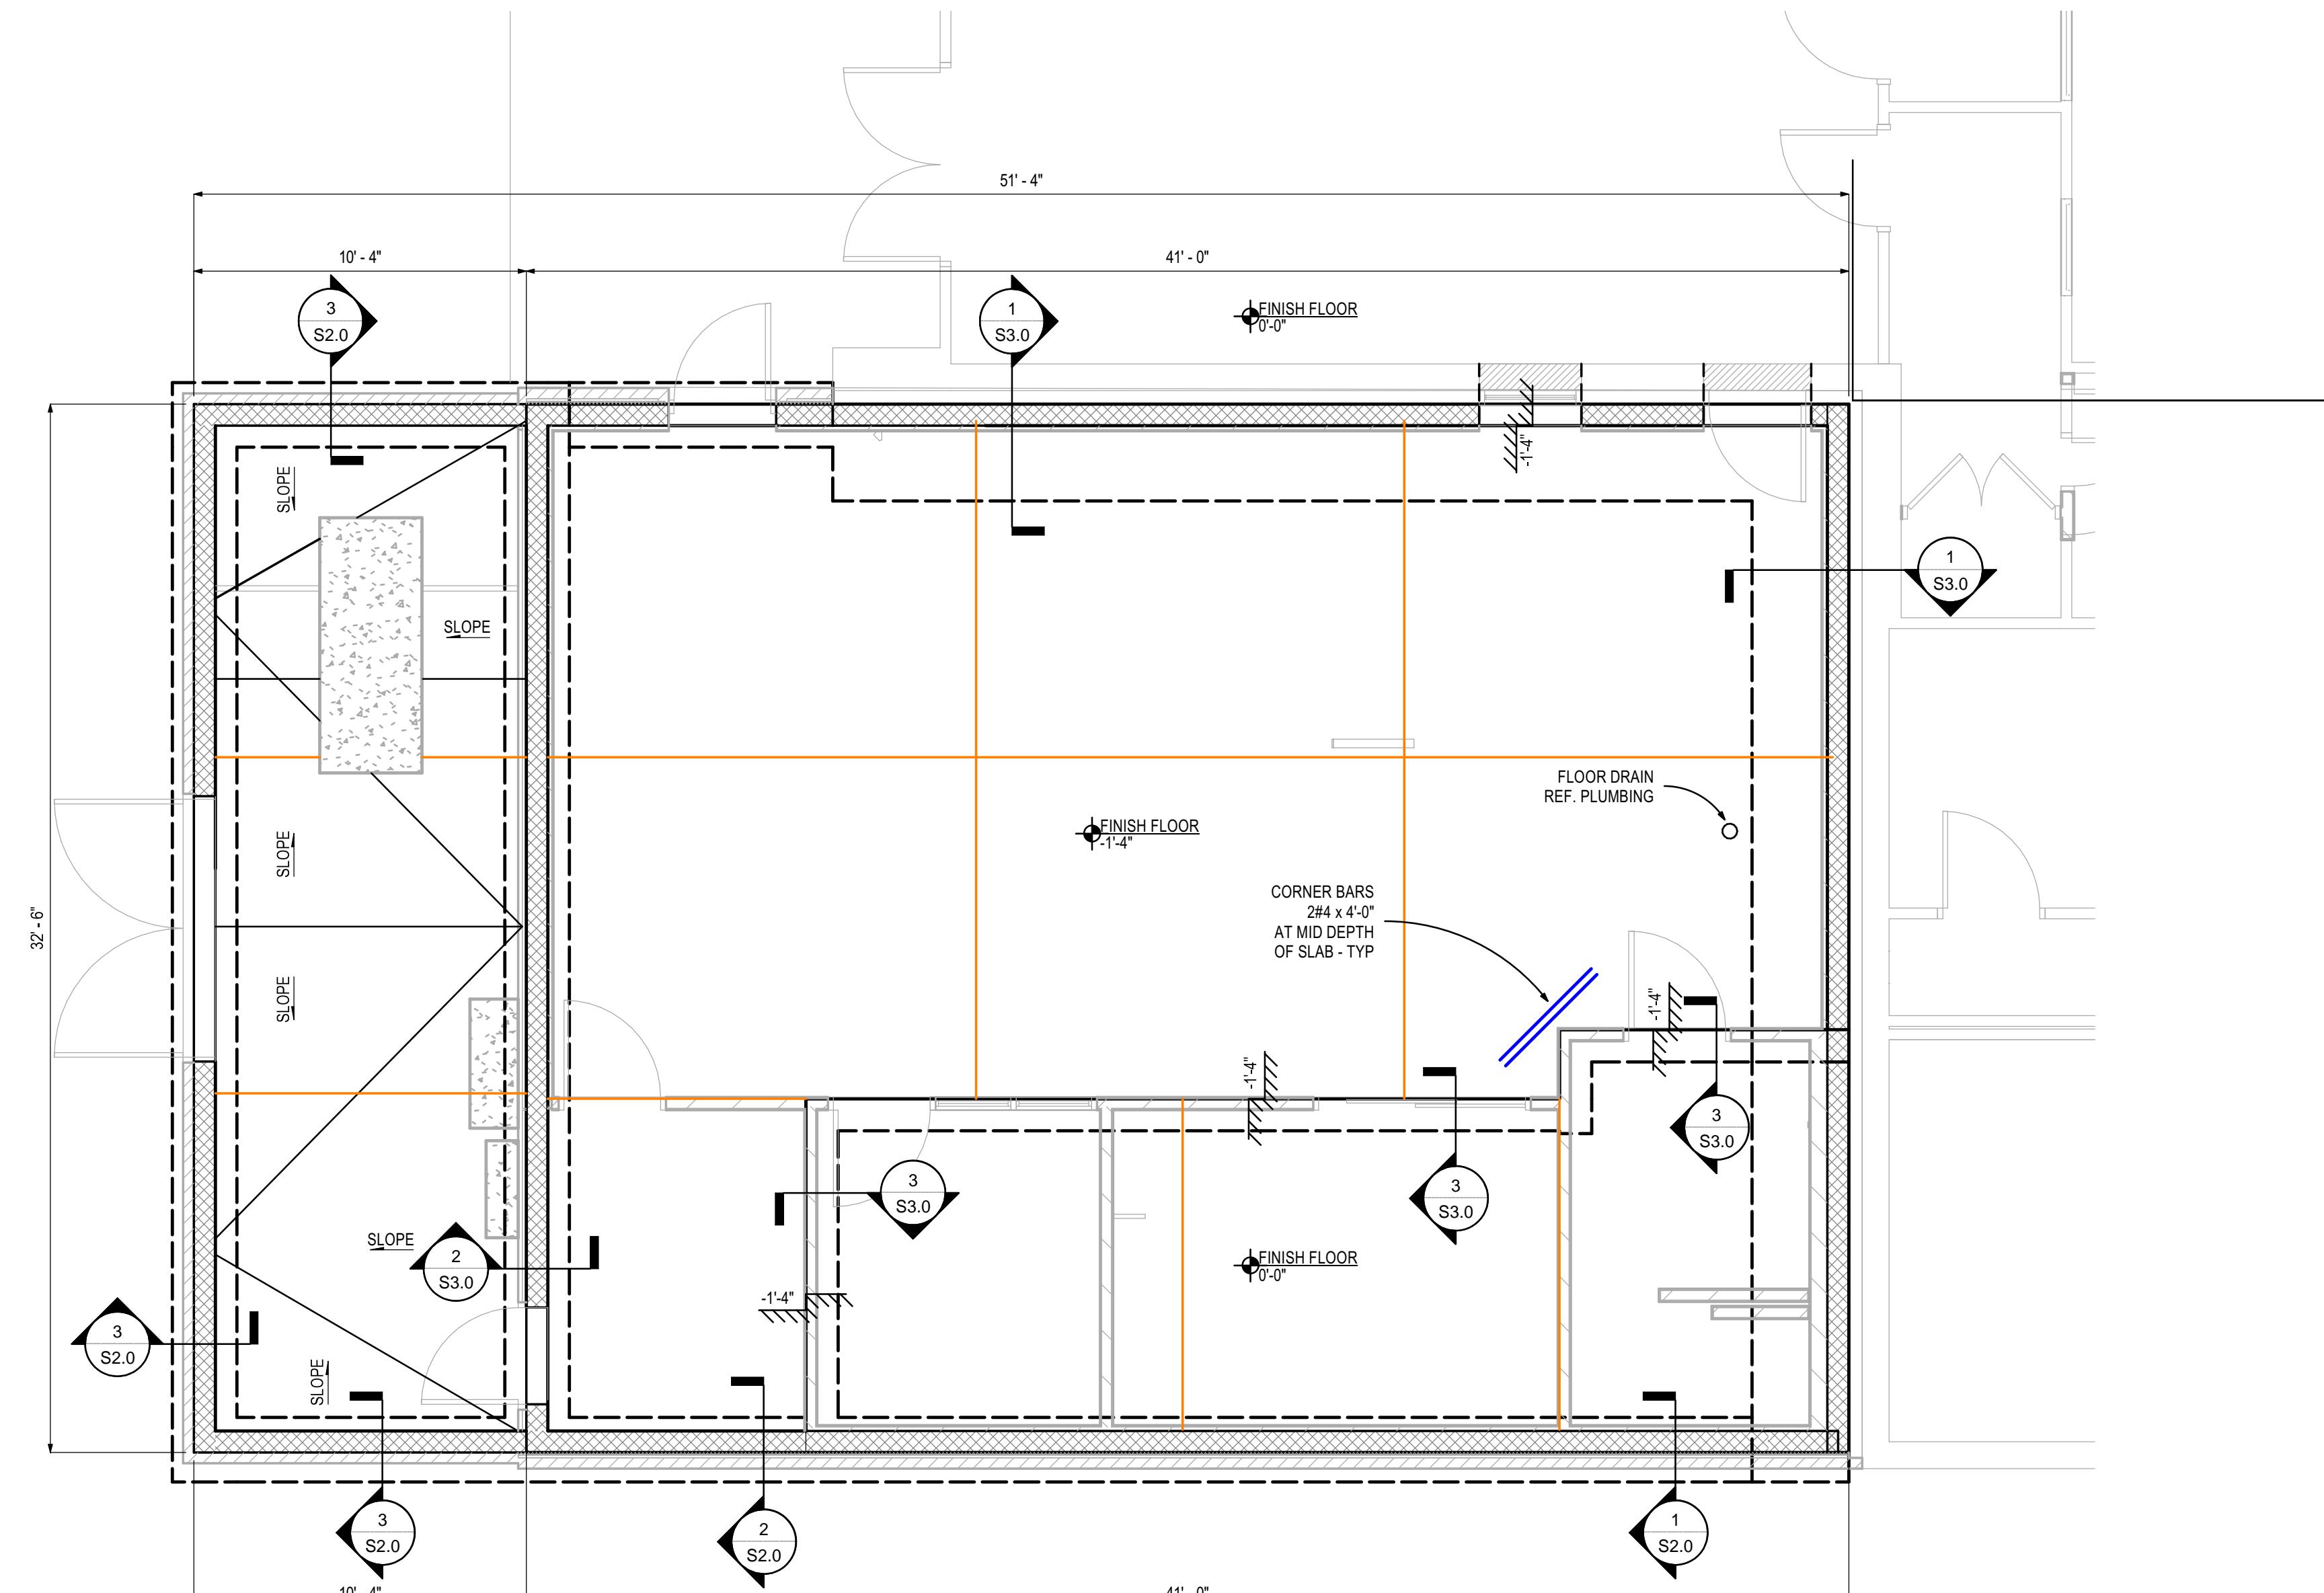


FOUNDATION PLAN




NORTH

1/4" = 1'-0"


1. FINISH FLOOR (TOP OF SLAB) ELEVATION: 0'-0", UNLESS NOTED.
2. TOP OF FOOTING: -2' - 0", UNLESS NOTED.
3. VERIFY ALL DIMENSIONS, ELEVATIONS, SLOPES, ETC. WITH ARCHITECTURAL DRAWINGS PRIOR TO THE START OF CONSTRUCTION.

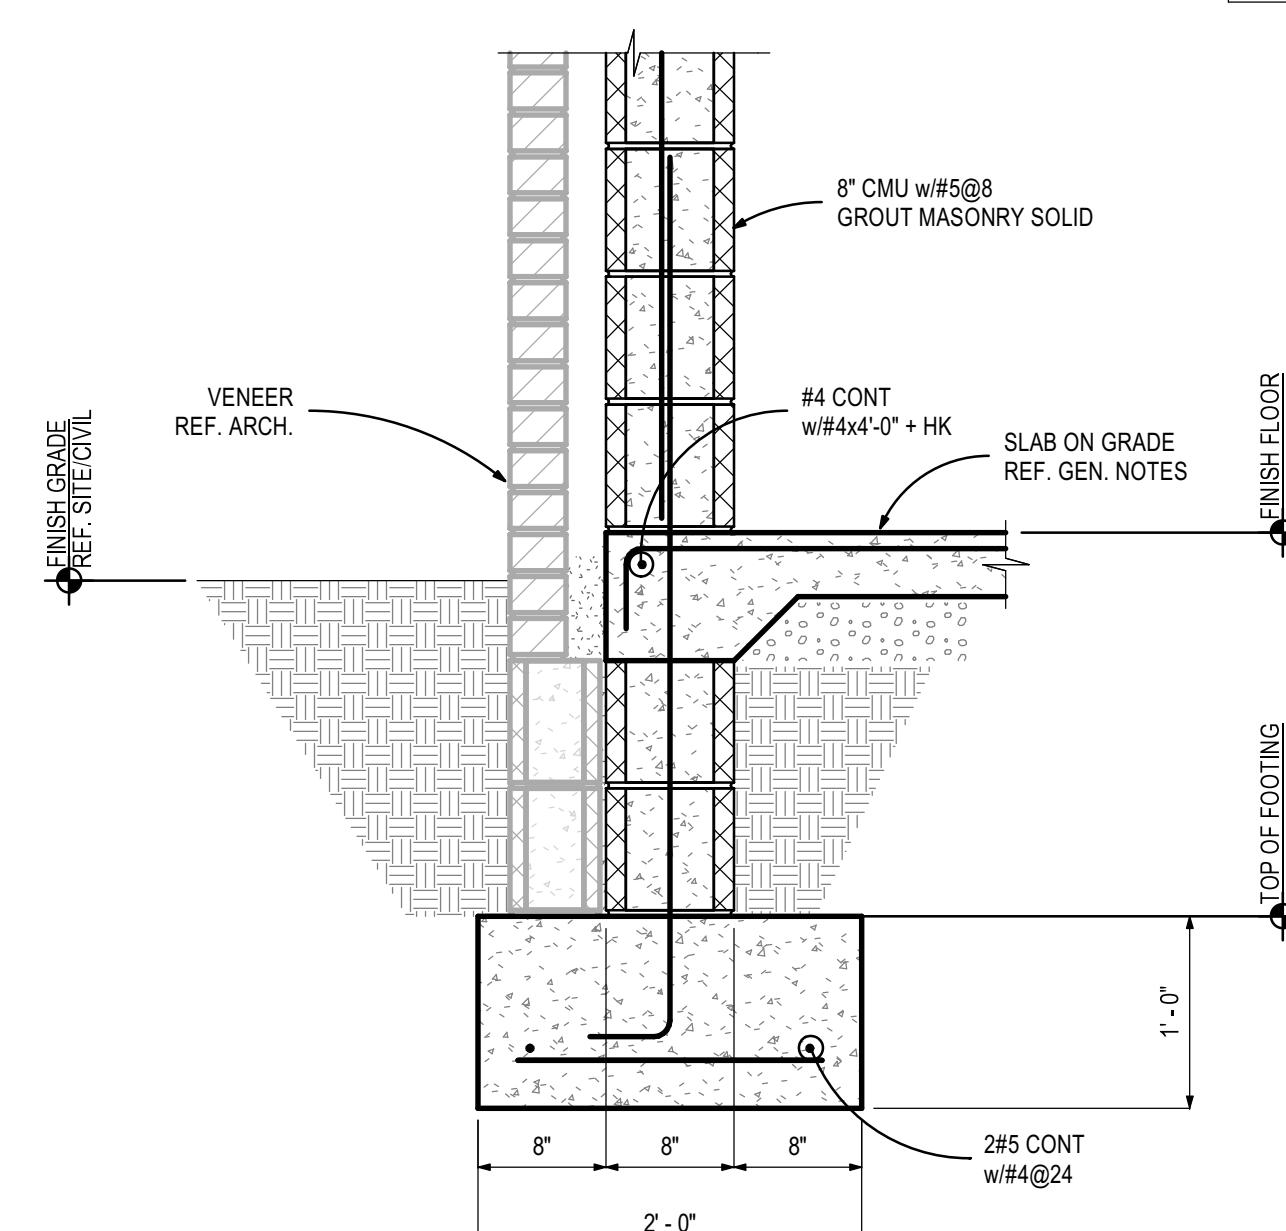

1 FOUNDATION SECTION
1" = 1'-0"

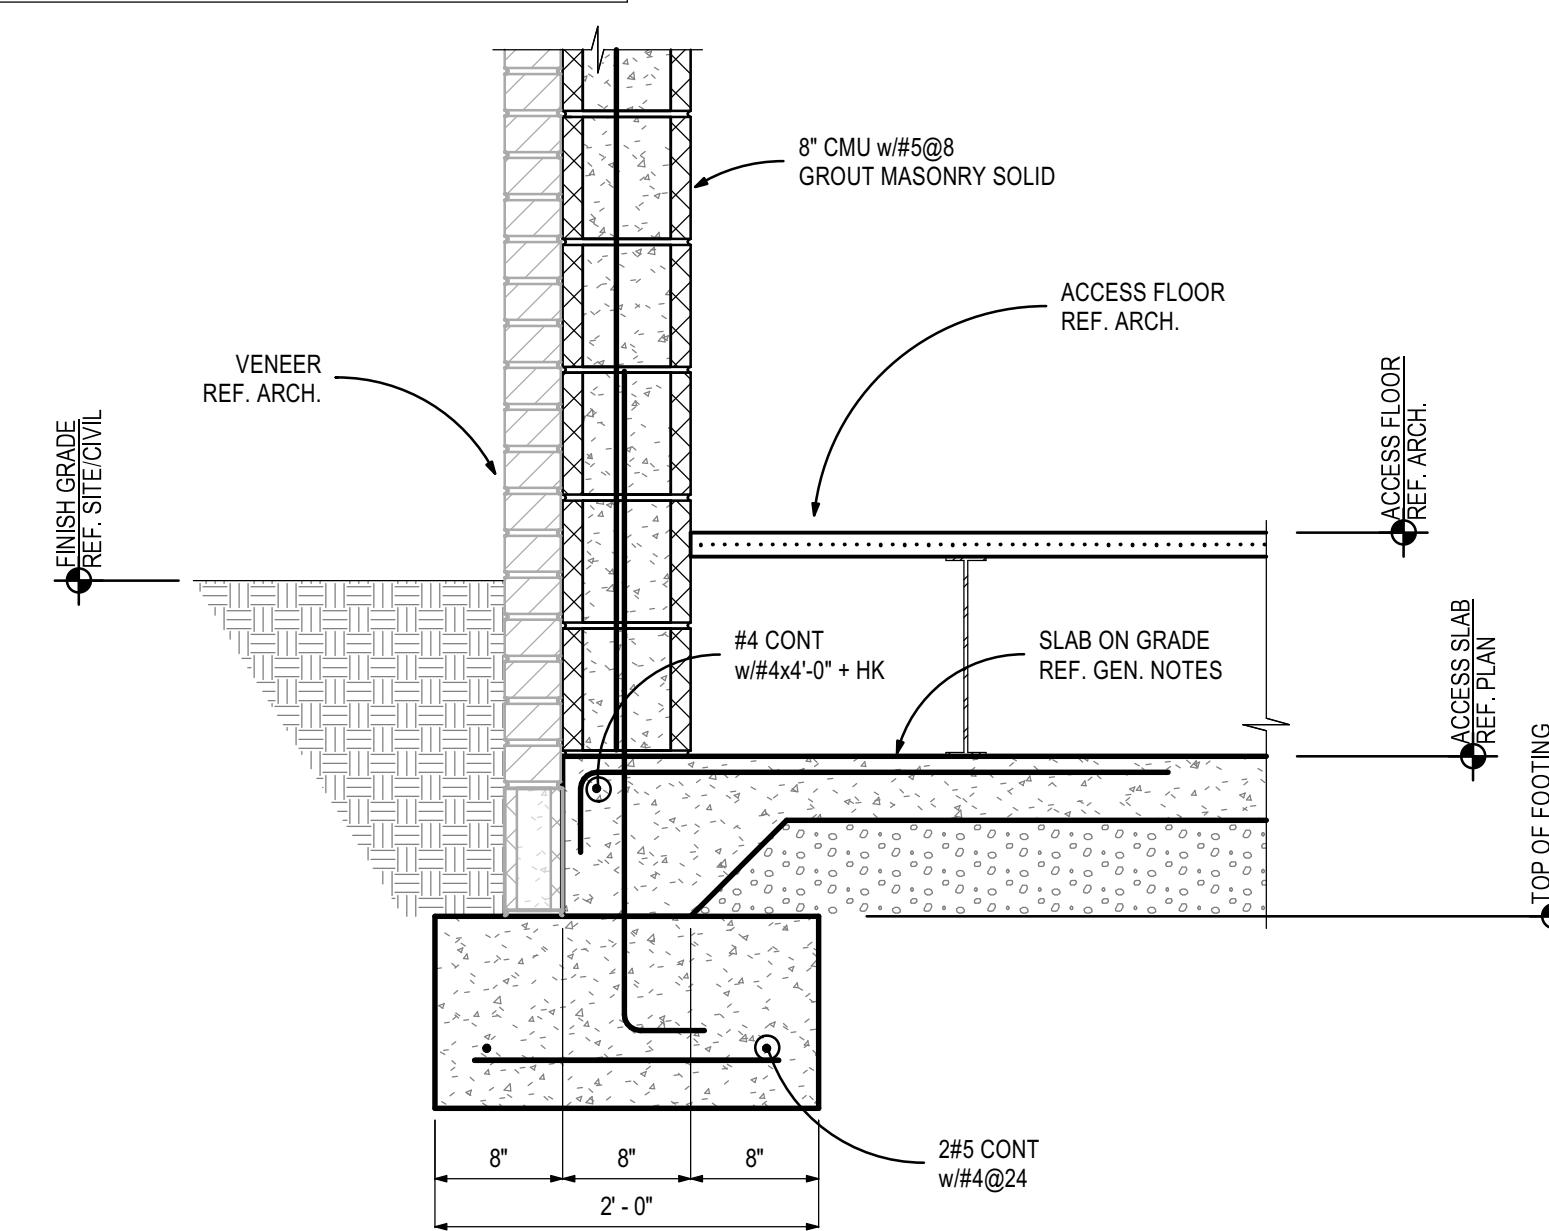

2 FOUNDATION SECTION
1" = 1'-0"

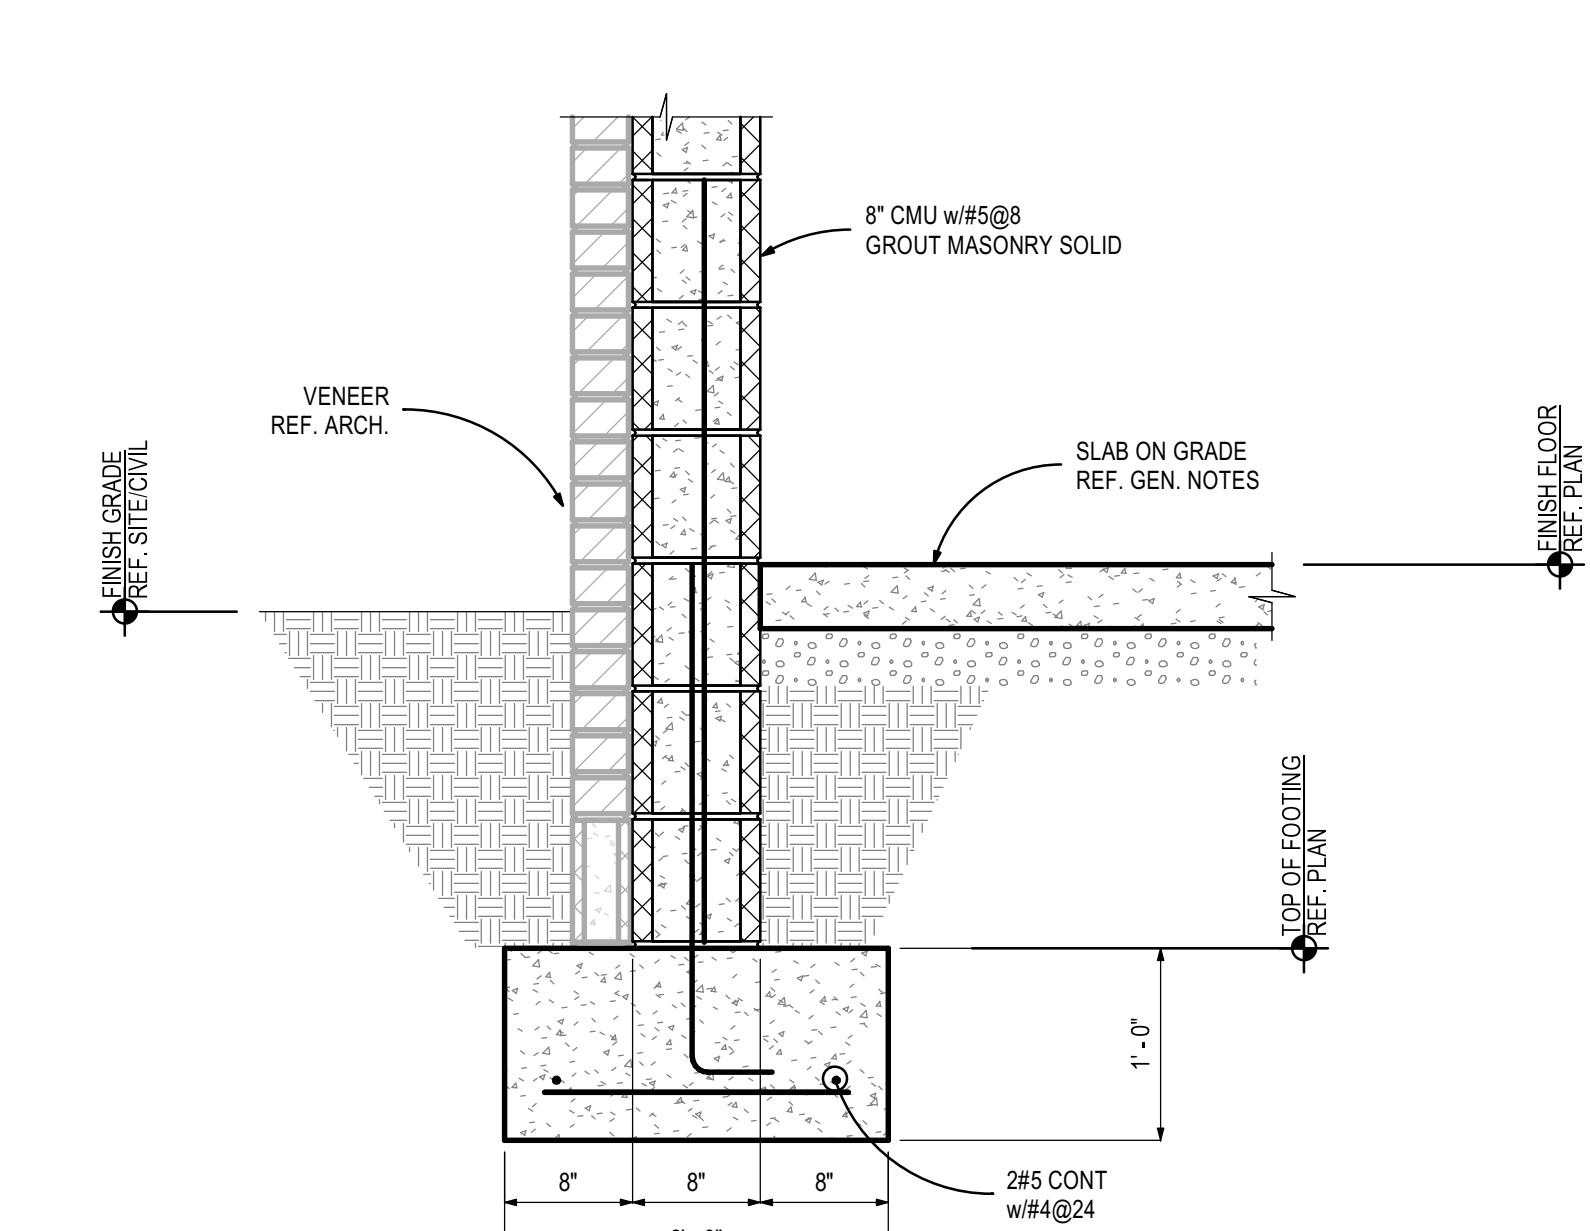

3 FOUNDATION SECTION
1" = 1'-0"





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CONSTRUCTION
DOCUMENTS

PROJECT NUMBER 25-1465
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Revisions

Sheet Description

ROOF
FRAMING
PLAN

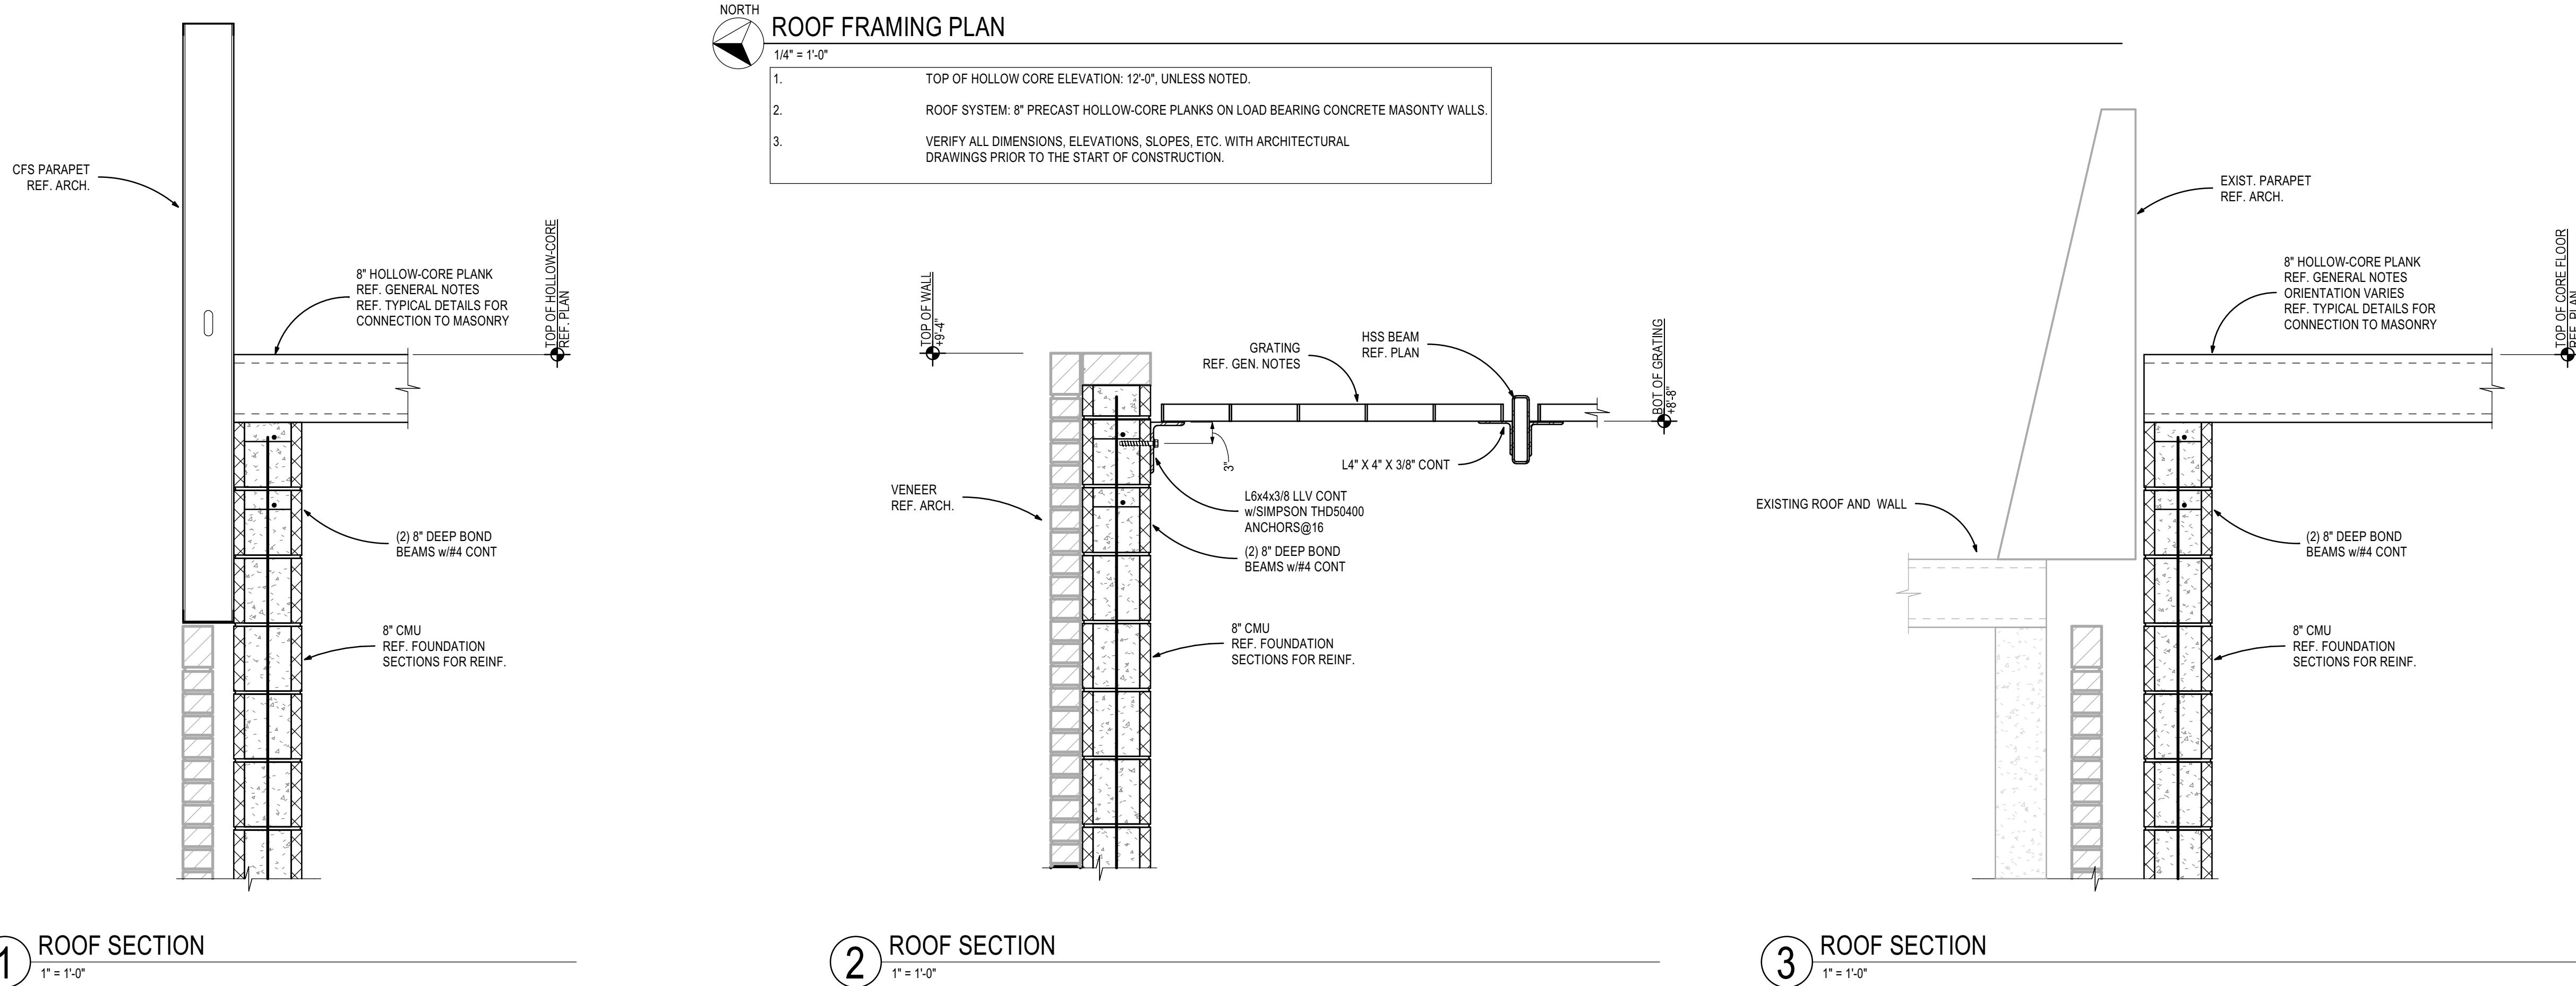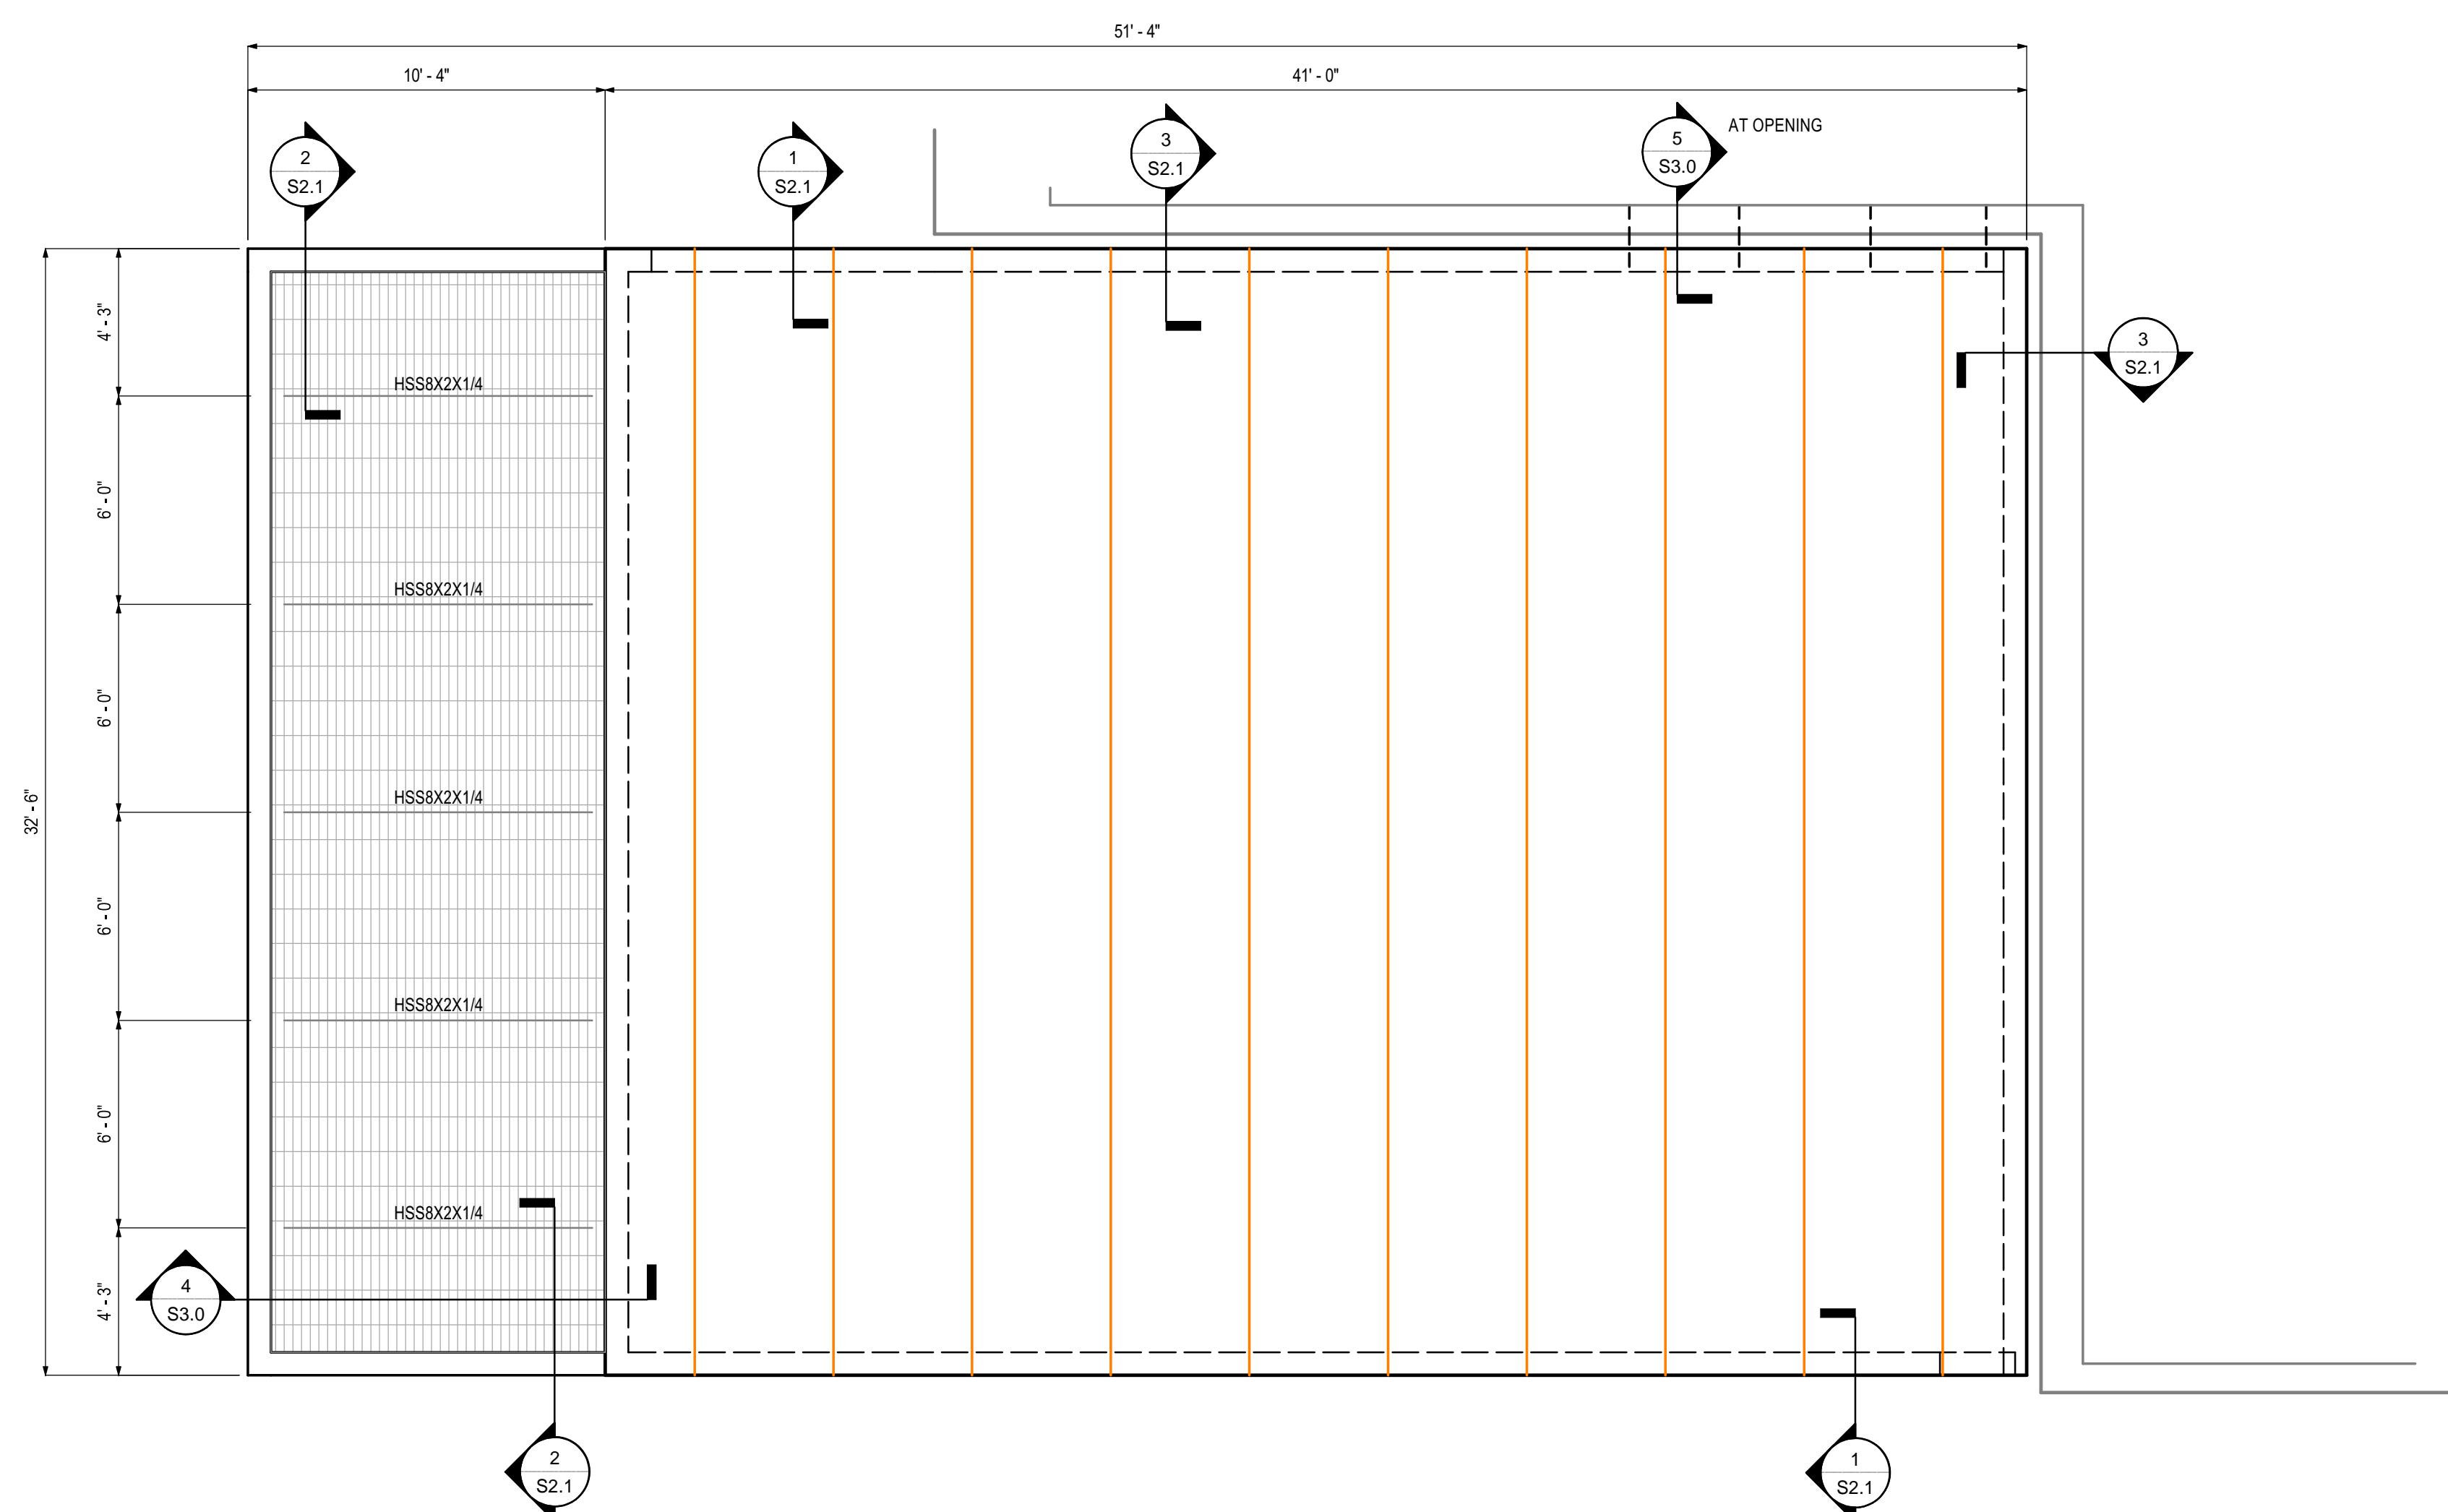Sheet Number


S2.1




TALLAPOOSA
CO E911
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DADEVILLE, AL


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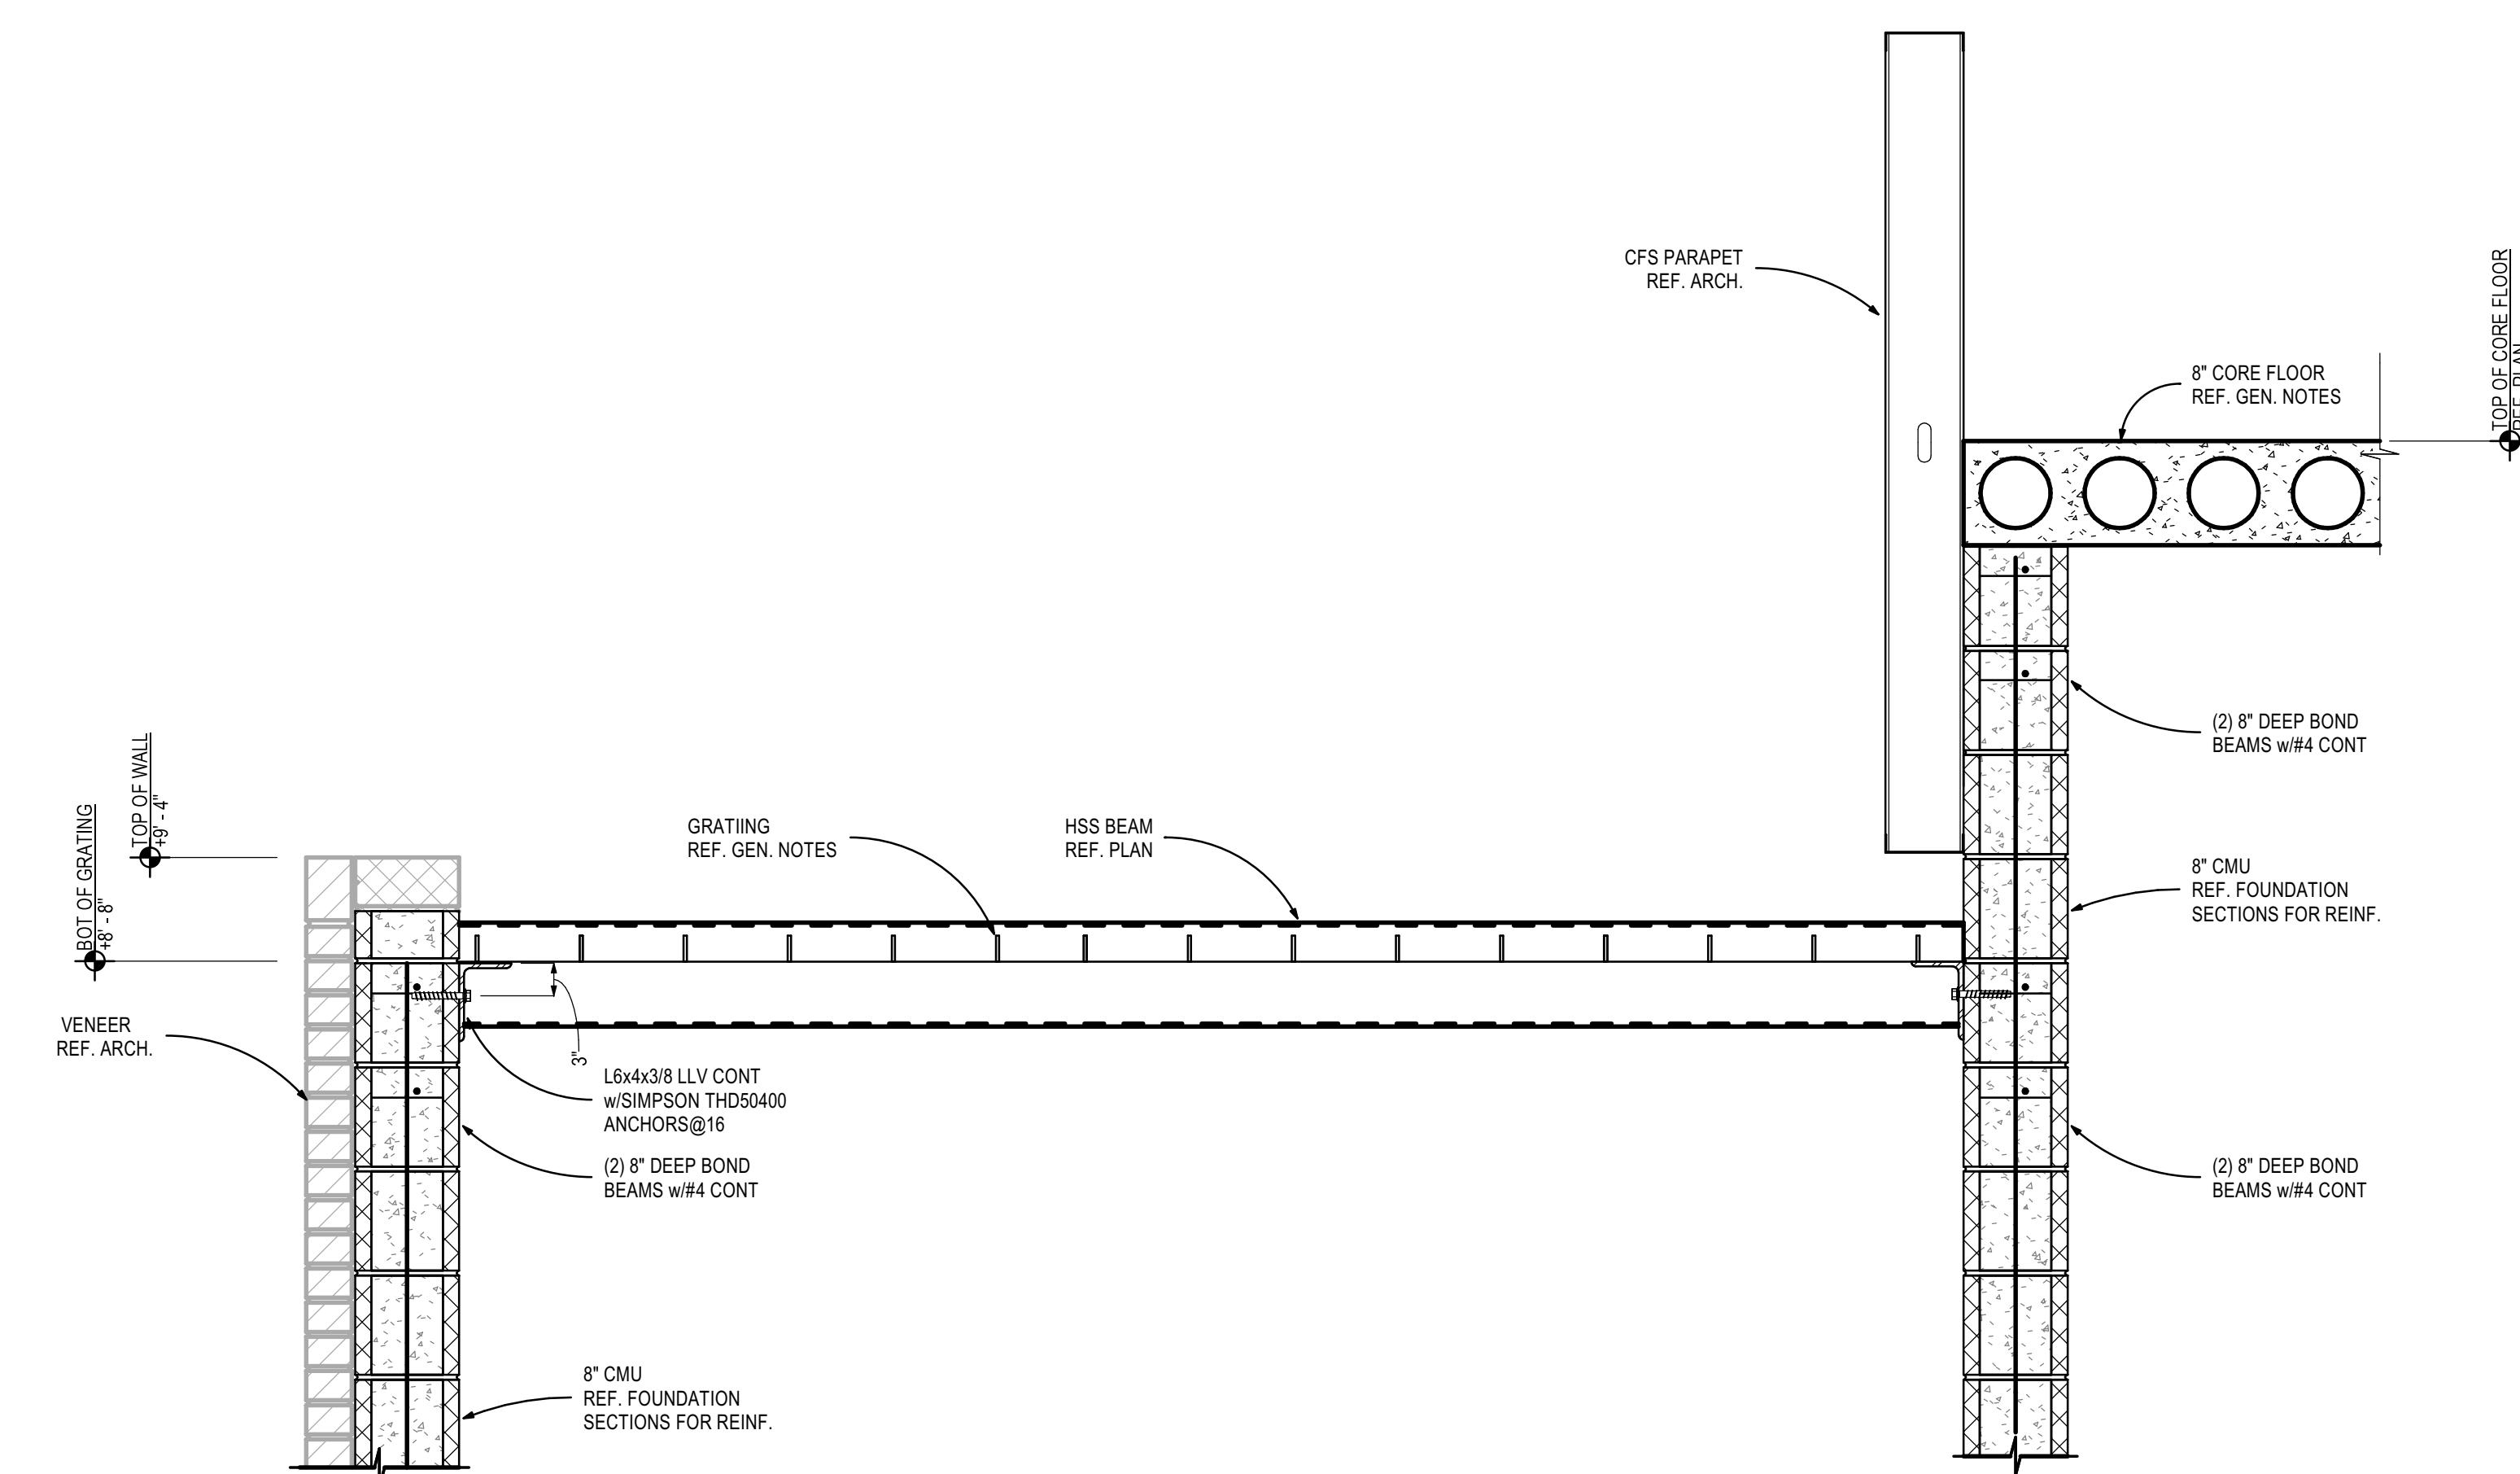
1 FOUNDATION SECTION
1" = 1'-0"

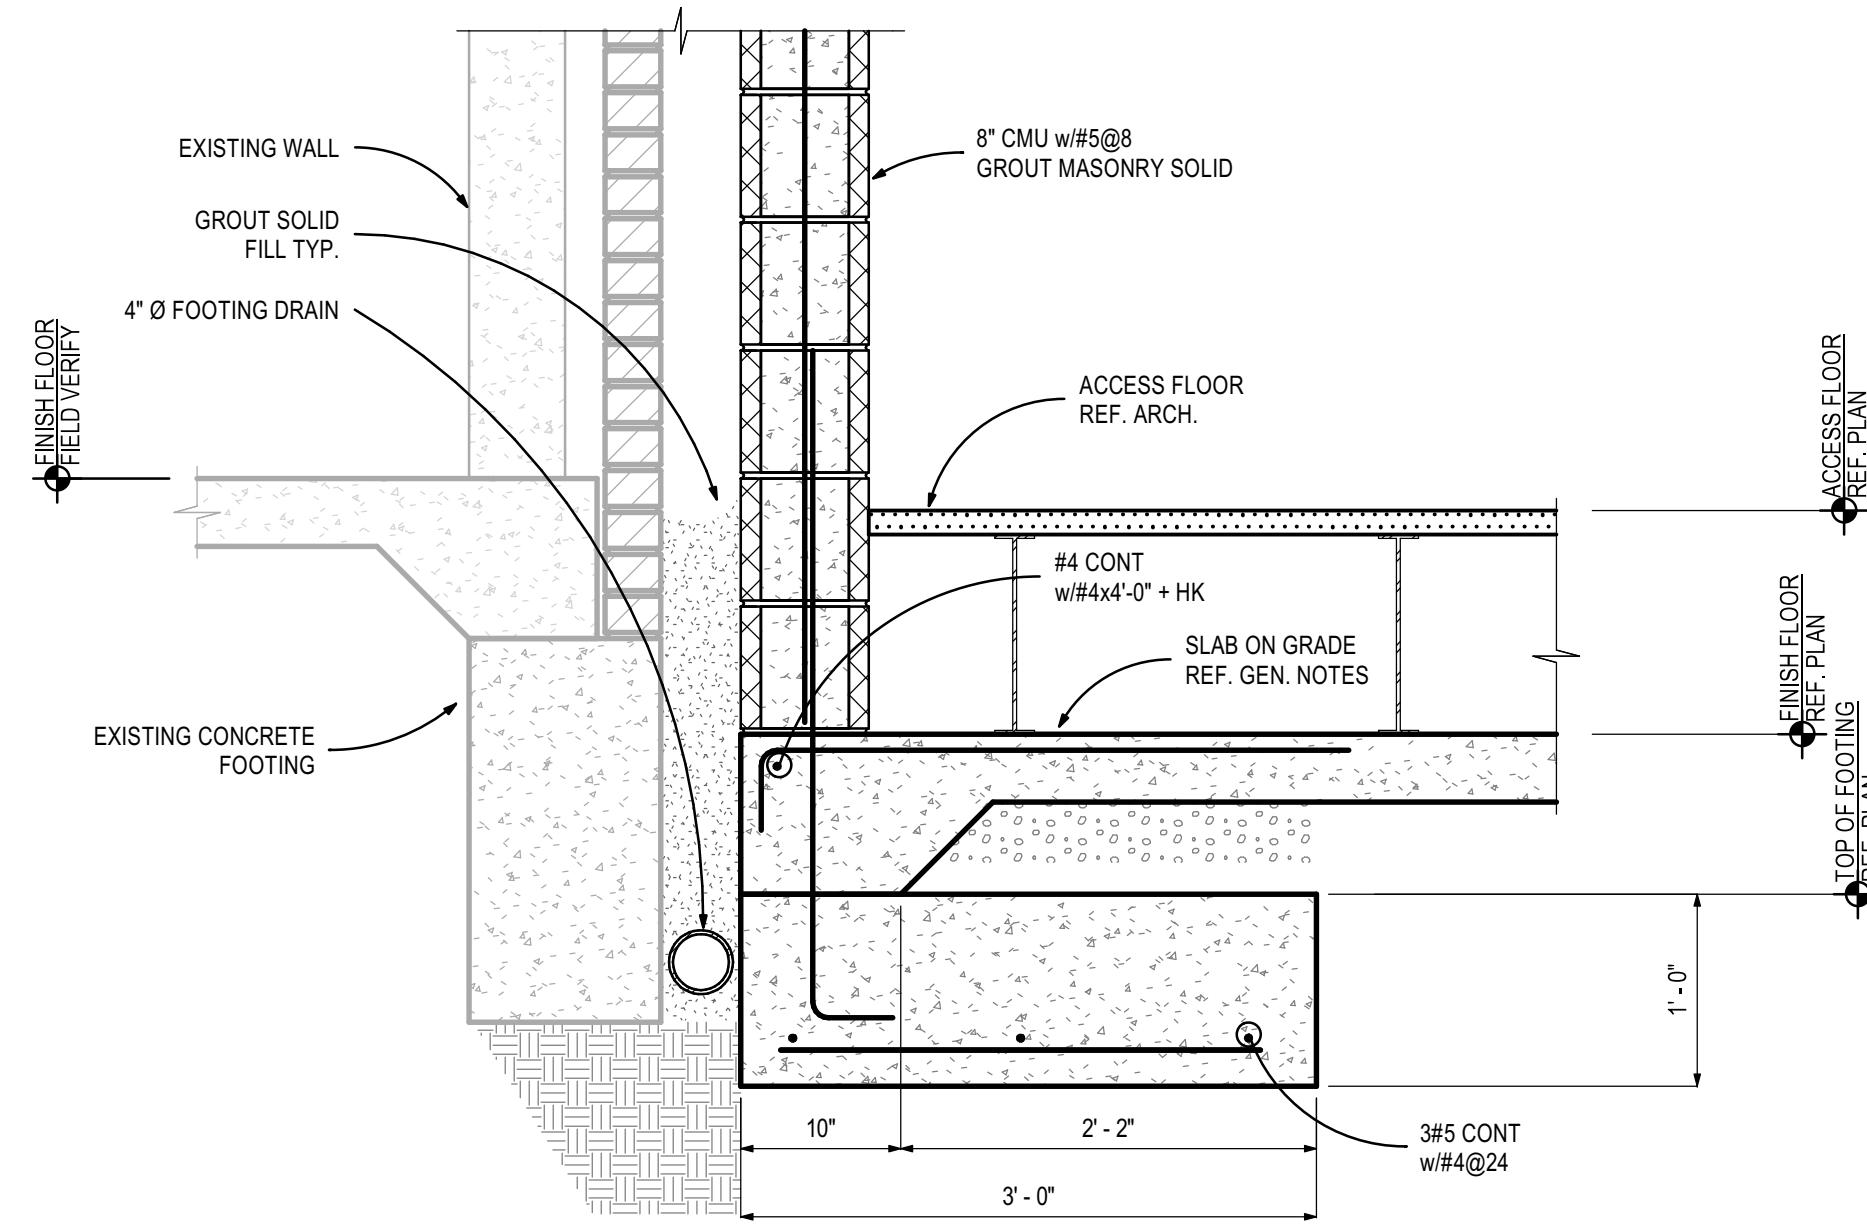


2 FOUNDATION SECTION
1" = 1'-0"

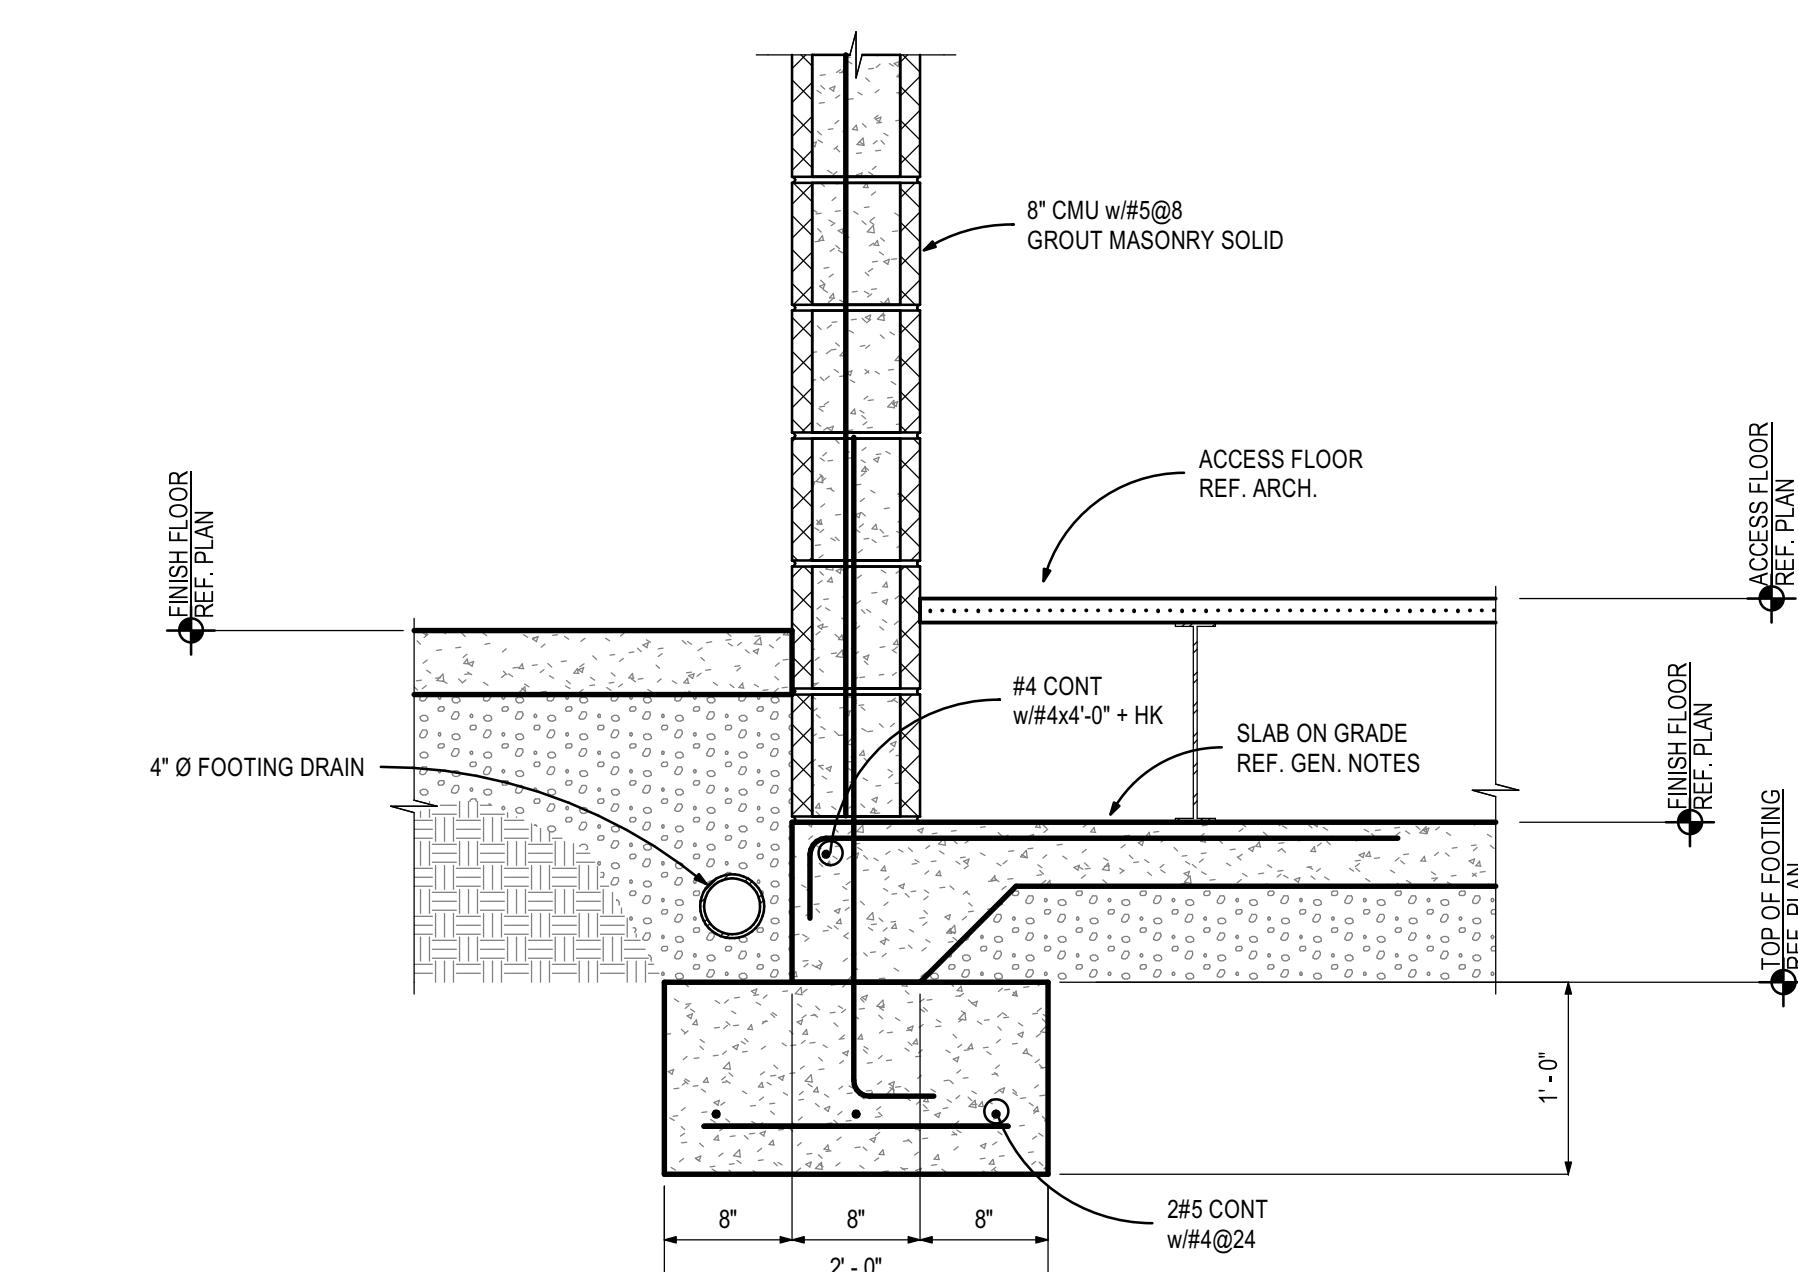

3 FOUNDATION SECTION
1" = 1'-0"

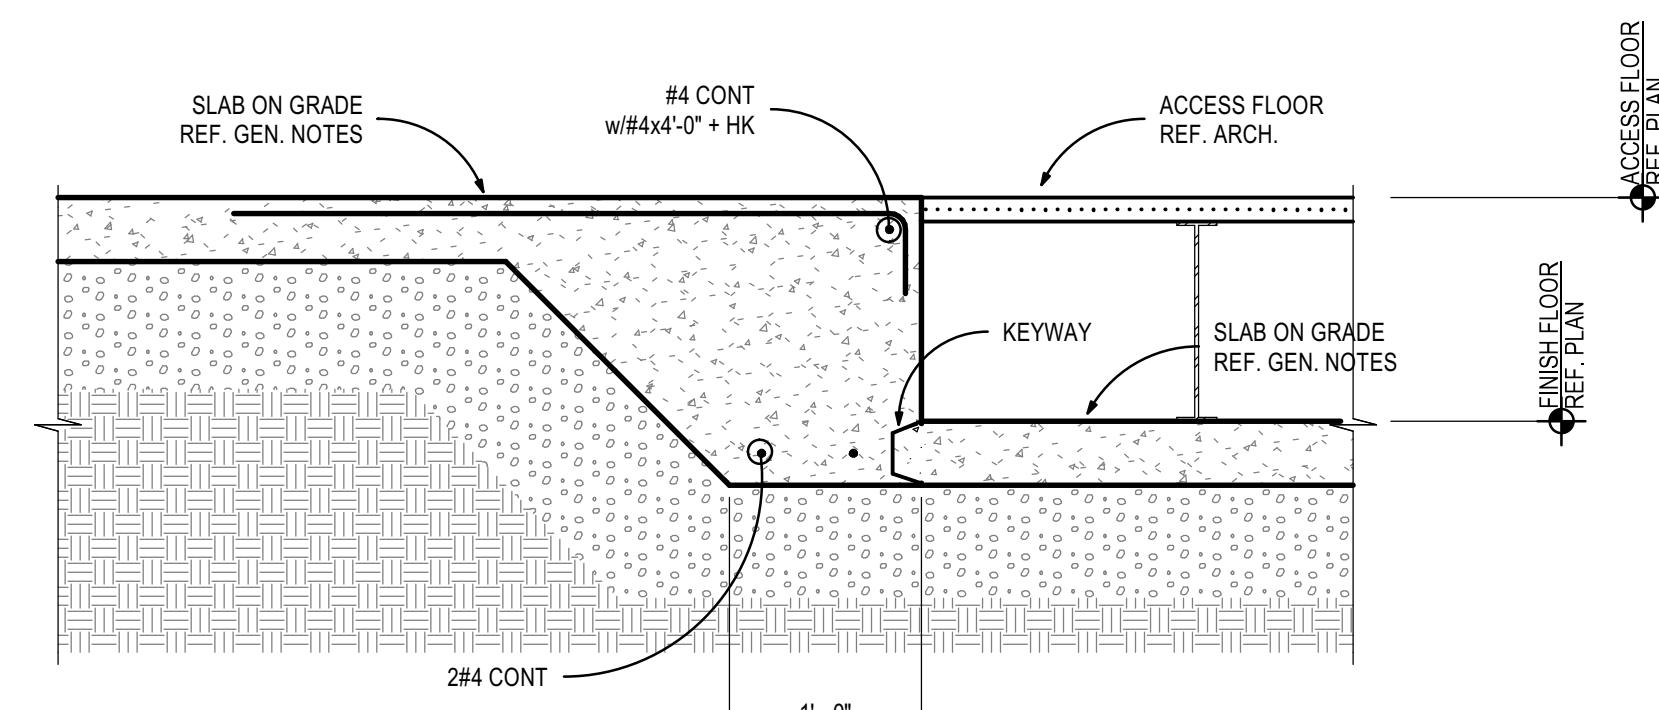

4 ROOF SECTION
1" = 1'-0"

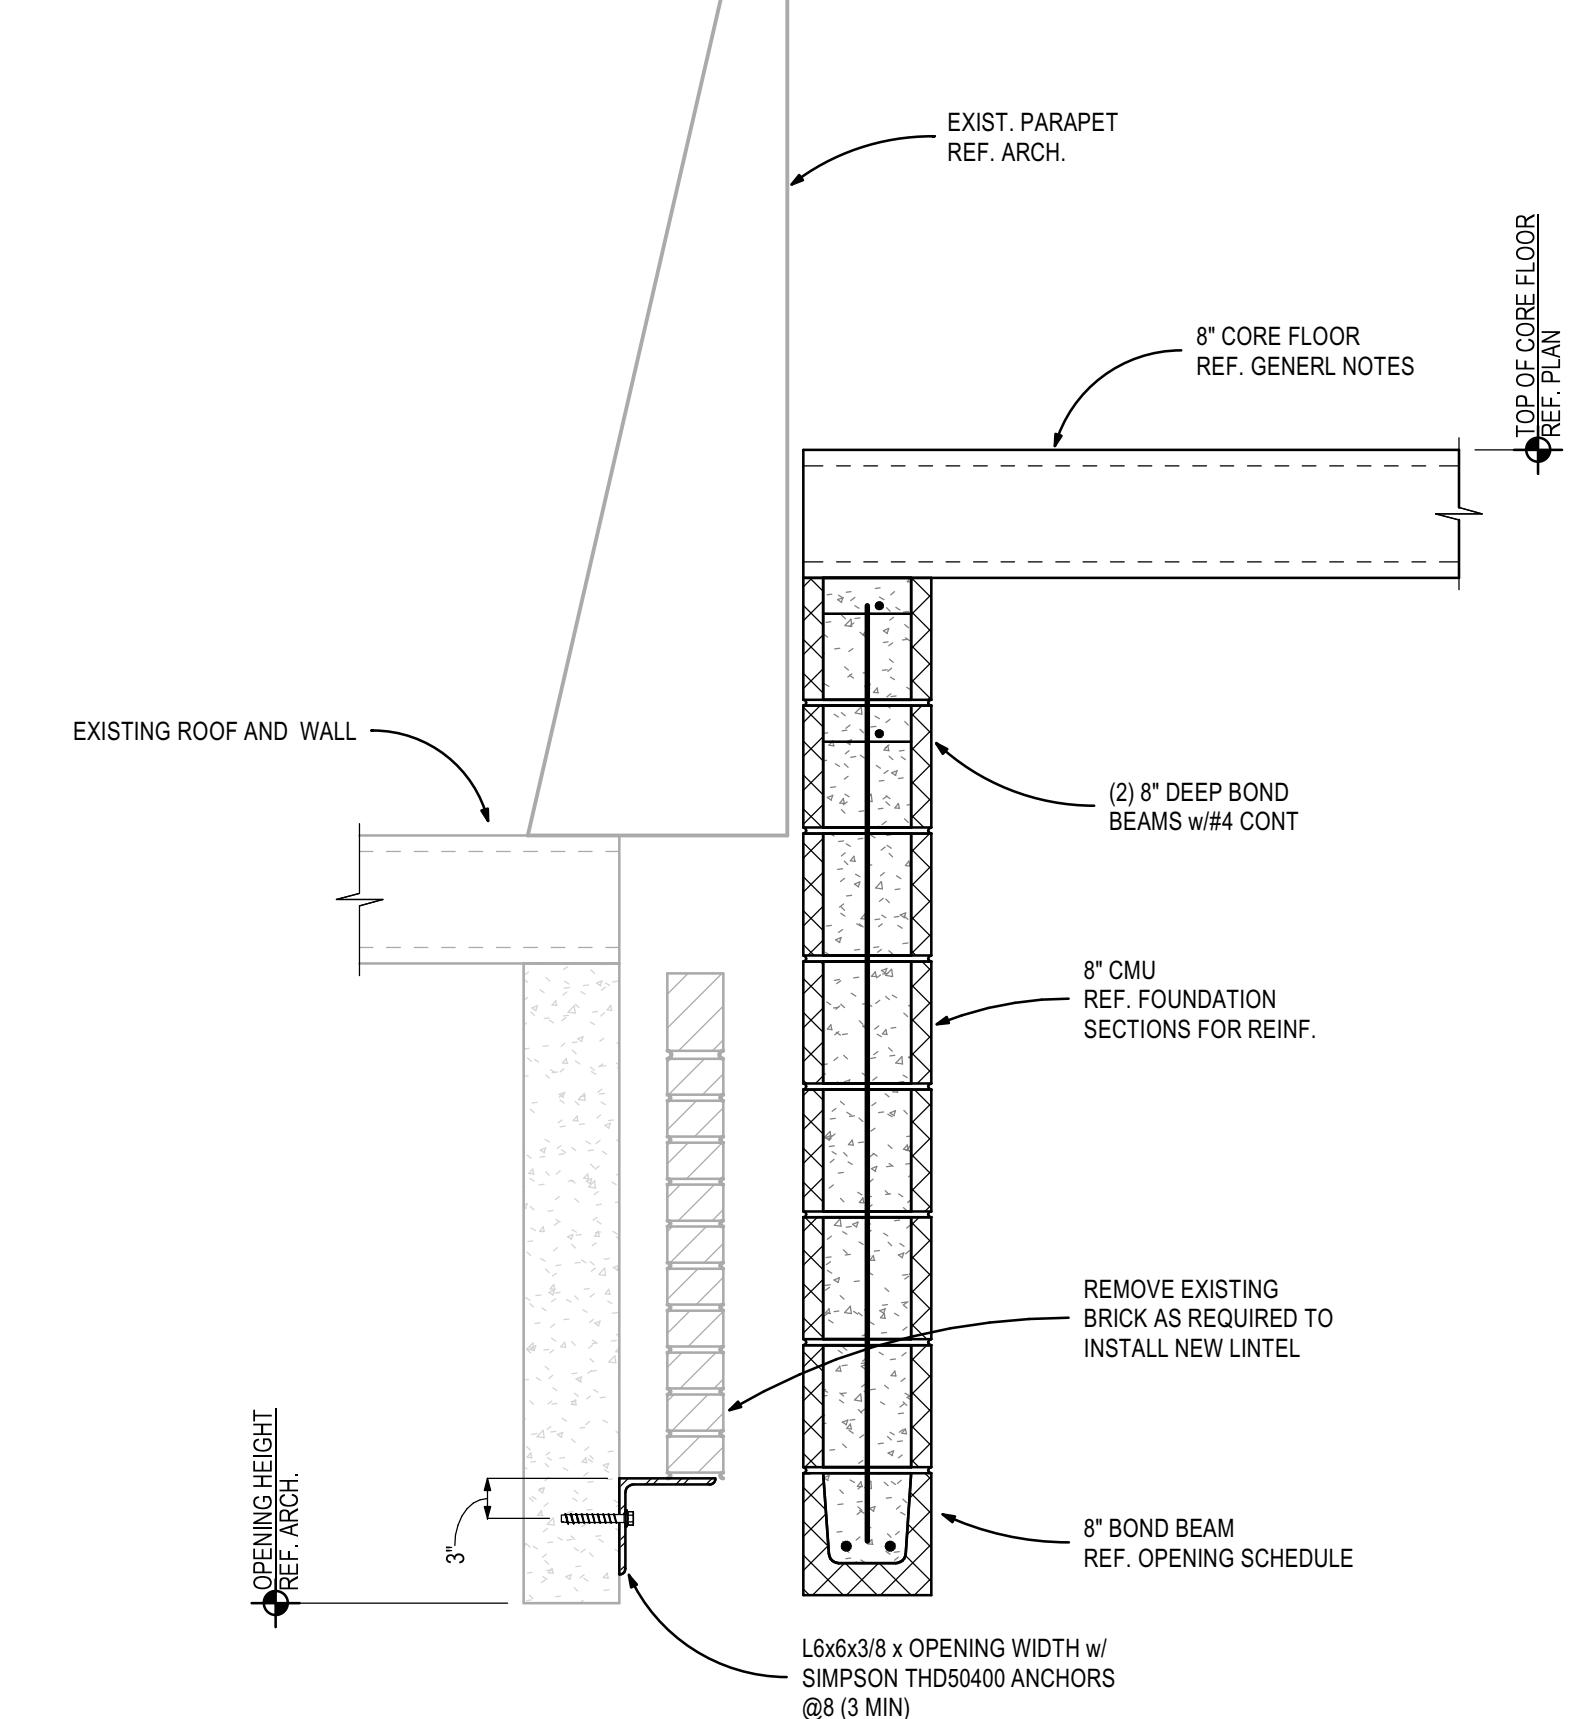

5 ROOF SECTION
1" = 1'-0"

CONSTRUCTION
DOCUMENTS

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SECTIONS
AND
DETAILS

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S3.0

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PLUMBING
SCHEDULES,
LEGEND, AND
NOTES

Sheet Number

P1.1

GENERAL PLUMBING NOTES									
1. THESE DRAWINGS ARE SCHEMATIC IN NATURE AND ARE NOT INTENDED TO SHOW ALL POSSIBLE CONDITIONS. IT IS INTENDED THAT A COMPLETE PLUMBING SYSTEM BE PROVIDED WITH ALL NECESSARY EQUIPMENT, ACCESSORIES, AND CONTROLS COMPLETELY COORDINATED WITH ALL TRADES. ALL REQUIREMENTS GIVEN IN THESE DOCUMENTS SHALL BE STRICTLY CONFORMED TO, ANY ITEMS AND LABOR REQUIRED FOR A COMPLETE PLUMBING SYSTEM IN ACCORDANCE WITH ALL APPLICABLE CODES, STANDARDS, LOCAL AUTHORITIES, AND THESE CONTRACT DOCUMENTS SHALL BE FURNISHED WITHOUT INCURRING ANY ADDITIONAL COST TO THE OWNER. CAREFULLY REVIEW ALL CONTRACT DOCUMENTS AND THE DESIGN OF OTHER TRADES BEFORE PREPARING SHOP DRAWINGS.									
2. COORDINATE ALL WORK WITH ARCHITECTURAL, STRUCTURAL, HVAC, AND ELECTRICAL TRADES. PIPE ROUTING SHOWN IS DIAGRAMMATIC. PROVIDE ALL OFFSETS, ETC., TO AVOID INTERFERENCES WITH EQUIPMENT, PIPING, DUCTWORK, LIGHTS, CONDUIT, ETC.									
3. FIELD VERIFY EXACT SIZE, MATERIAL, AND LOCATION OF ALL EXISTING UTILITIES BEFORE BEGINNING WORK.									
4. VERIFY LOCATION OF ALL FIXTURES WITH ARCHITECTURAL PLANS.									
5. VERIFY ALL FIXTURE MOUNTING HEIGHTS WITH ENGINEER AND ARCHITECT.									
6. COORDINATE ALL FLOOR PENETRATIONS WITH STRUCTURAL DRAWINGS. SET SLEEVES IN FLOORS/WALLS AND ATTACHMENTS FOR HANGERS AS CONSTRUCTION PROGRESSES. ALL PENETRATIONS MUST BE SEALED AND HELD AS TIGHT TO COLUMNS OR WALLS AS POSSIBLE.									
7. PROVIDE 12"X12" ACCESS PANEL FOR SHOCK ABSORBERS, TRAP PRIMERS, AND ALL VALVES LOCATED ABOVE NON-ACCESSIBLE CEILINGS AND INSIDE PIPE CHASES. EXACT LOCATION MUST BE COORDINATED WITH ARCHITECTURAL AND APPROVED BY ARCHITECT PRIOR TO INSTALLATION.									
8. ALL PIPING SHALL BE CONCEALED INSIDE WALLS, WITHIN PIPE CHASES, OR ABOVE CEILINGS. HOLD ALL PIPING ABOVE CEILING AS HIGH AS POSSIBLE.									
9. COORDINATE ALL UNDERGROUND PIPING WITH GRADE BEAMS, WALL FOOTINGS, AND OTHER STRUCTURAL CONDITIONS.									
10. PLUMBING CONTRACTOR SHALL MAKE FINAL CONNECTIONS TO ALL EQUIPMENT INDICATED ON DRAWINGS. FINAL CONNECTION SHALL INCLUDE ANY ADAPTORs, NIPPLES, SHUT-OFF VALVES, PRV's, SHOCK ABSORBERS, BACKFLOW PREVENTION DEVICES, REGULATORS, ETC.									
11. ALL STRUCTURAL PENETRATIONS (SLEEVES, BLOCK OUTS, ETC.) ARE TO BE LOCATED AND COORDINATED IN THE FIELD BY THE CONTRACTOR IN RELATION TO THE REQUIREMENTS OF FINAL EQUIPMENT AND FIXTURES SELECTED.									
12. CONTRACTOR SHALL MAKE FINAL CONNECTIONS TO ALL DOMESTIC WATER AND SANITARY SEWERS, UNLESS OTHERWISE NOTED.									
13. ALL PLUMBING COMPONENTS TO BE LEAD-FREE.									
14. ENCASE ALL WASTE/WATER PIPING, VALVES, WATER HEATER, OR ANY OTHER ASSOCIATED PLUMBING EQUIPMENT BELOW WALL HUNG LAVATORY, WITH TRUEBRO LAV-SHIELD (OR APPROVED EQUAL). THIS APPLIES TO ALL ADA LAVS, LAVS WITH MIXING VALVES MOUNTED BELOW LAV, AND ALL LAVS THAT INCLUDE INSTANTANEOUS ELECTRIC WATER HEATERS MOUNTED BELOW LAV. LAV GUARD SHALL INCLUDE STAINLESS STEEL TAMPER RESISTANT SCREWS. LAV-SHIELD SHALL BE ORDERED TO MATCH SPECIFIED/APPROVED LAVATORY.									
15. HORIZONTAL DRAINAGE PIPING OF 2-1/2" DIAMETER OR LESS SHALL BE INSTALLED WITH A FALL OF NOT LESS THAN 1/4" PER FOOT. PIPING 3" AND LARGER SHALL BE INSTALLED WITH A FALL OF NOT LESS THAN 1/8" PER FOOT.									
16. SET FLOOR DRAIN ELEVATION DEPRESSED BELOW FINISHED SLAB ELEVATION AS LISTED BELOW TO PROVIDE PROPER FLOOR SLOPE TO DRAIN:									
5 FOOT DRAIN RADIUS : 1/2" DEPRESSION									
10 FOOT DRAIN RADIUS : 3/4" DEPRESSION									
15 FOOT DRAIN RADIUS : 1" DEPRESSION									
20 FOOT DRAIN RADIUS : 1-1/4" DEPRESSION									
25 FOOT DRAIN RADIUS : 1-1/2" DEPRESSION									
17. ALL TRAP ARMS, P-TRAPS, ETC. EXPOSED UNDER LAVATORIES SHALL BE 18. GA. CHROME PLATED.									
18. ABOVE GROUND DRAINAGE AND VENT PIPING LOCATED WITHIN FIRE RATED WALLS SHALL BE COPPER PIPE IN ACCORDANCE WITH STANDARDS ASTM B42 AND B302 OR CAST IRON PIPE IN ACCORDANCE WITH STANDARDS ASTM A 74; ASTM A 888; CISPI 301. COORDINATE WITH ARCHITECTURAL LIFE SAFETY PLANS FOR EXACT LOCATION OF ALL FIRE WALLS.									
19. VERIFY ORIENTATION OF FLUSHING MECHANISM ON TOILET WITH ARCHITECT/ENGINEER PRIOR TO ROUGH-IN.									
20. PROVIDE WATER PRESSURE REDUCING/REGULATING VALVE ON MAIN SERVICE WHEN MAIN PRESSURE EXCEEDS 75 PSI AT ANY TIME OF DAY. COORDINATE WITH LOCAL UTILITY.									
21. PROVIDE REDUCED PRESSURE BACKFLOW PREVENTER AT ALL CONNECTIONS TO MECHANICAL EQUIPMENT, KITCHEN AND LAUNDRY EQUIPMENT, ETC., AS REQUIRED BY CODE AND BY LOCAL AUTHORITY. CONTRACTOR IS TO VERIFY WITH THE LOCAL AUTHORITY THE TYPE OF BACKFLOW PREVENTION DEVICE REQUIRED FOR ALL APPLICATIONS PRIOR TO INSTALLATION.									
22. ALL OVERHEAD WATER PIPING SHALL BE INSTALLED BELOW CEILING INSULATION.									
23. INSTALL BACKFLOW PREVENTION IN ACCORDANCE WITH CITY AND STATE REQUIREMENTS. INSTALL ON MAIN DOMESTIC WATER SERVICE TO THE BUILDING.									
24. CONTRACTOR SHALL INSTALL WATER HAMMER ARRESTER EQUAL TO ZURN SERIES 1700 AT EACH PLUMBING GROUP.									
25. CONTRACTOR TO FURNISH AND INSTALL ANTI-SIPHON VALVE ON EACH WATER HEATER.									
26. CONTRACTOR SHALL FURNISH AND INSTALL BALL VALVES FOR WATER SHUT-OFF AT FIXTURE GROUPINGS.									
27. ALL STOPS/SUPPLIES SHALL BE CHROME PLATED BRASS.									

GAS PLUMBING NOTES


- ALL GAS PIPING SHALL BE FURNISHED AND INSTALLED IN ACCORDANCE WITH NFPA 54, INTERNATIONAL FUEL GAS CODE.
- ALL EXPOSED INTERIOR OR EXTERIOR GAS LINES ARE TO BE PAINTED BY THE PLUMBING CONTRACTOR WITH ONE COAT OF LATEX PAINT. INTERIOR COLOR TO MATCH WALL. EXTERIOR COLOR TO BE SELECTED BY ARCHITECT.
- PROVIDE INSULATING UNION BETWEEN ABOVE AND BELOW GROUND GAS PIPING.
- LABEL ALL GAS PIPING IN ACCORDANCE WITH 2021 INTERNATIONAL CODES (6 FT. CENTERS).
- FURNISH AND INSTALL GAS PRESSURE REGULATING/REDUCING VALVES WITH LEAK LIMITING DEVICE AT EACH APPLIANCE. WHERE REGULATORS ARE NOT SELF-LIMITING TYPE, VENTS SHALL BE EXTENDED TO THE BUILDING EXTERIOR.

MIXING VALVE SCHEDULE				
MARK NO.	MANUFACTURER'S MODEL NO.	TEMPERATURE (°F)	INLET	OUTLET
MV-1	POWERS SERIES LFLM495	SET AT 90°-110°	1/2"	1/2"

UNLESS OTHERWISE NOTED, MIXING VALVES SHALL CONFORM TO ASSE 1070 AND ASSE 1017

PLUMBING EQUIPMENT SCHEDULE									
MARK NO.	Fixture Type	Manufacturer's Model No.	Mount	Mount Height	Waste Size	Vent Size	C.W. Size	H.W. Size	Notes
WC-1A	WATER CLOSET TANK TYPE, ADA PRESSURE ASSISTED	ZURN MODEL NO. Z5560 OR APPROVED EQUAL	FLOOR	17" TO RIM	4"	2"	1/2"	-	WHITE ELONGATED VITREOUS CHINA, BEMIS 195ESS CT WHITE OPEN FRONT SOLID PLASTIC SEAT WITH STA TIGHT FASTENING SYSTEM, BOLT CAPS 12" ROUGH-IN, ZURN Z880CR SUPPLY WITH STOP
L-1A	LAVATORY, ADA 20"X18"	ZURN MODEL NO. Z5344 OR APPROVED EQUAL	WALL	34" TO LIP	1-1/4"	1-1/4"	1/2"	1/2"	WHITE VITREOUS CHINA, OPEN GRID STRAINER, DELTA 8510LF FAUCET, W/ 0.5 GPM AERATOR (OR ZURN 27440-XL-FC), Z870PC P-TRAP W/ CLEANOUT; Z8743PC GRID DRAIN, Z1231EZ CONCEALED ARM CARRIER; Z8800 LR-PC SUPPLIES W/ STOPS
S-1	STAINLESS SINK TWO COMPARTMENT	JUST MODEL NO. DL-2133-A-GR OR APPROVED EQUAL	CABINET	-	1-1/2"	1-1/4"	1/2"	1/2"	EKAY MODEL NO. LX-335 STRAINER, DELTA MODEL 100-DST (OR ZURN Z7870C-XL) 3-HOLE INSTALLATION, Z8800 LR-PC SUPPLIES WITH STOPS, 3" P-TRAP WITH CLEANOUT, 8" BOWL DEPTH
SH-1A	SHOWER PRE-FAB, ADA	COMFORT DESIGNS MODEL NO. XST 3838 BF 1.0 RRF OR APPROVED EQUAL	FLOOR	-	2"	1-1/2"	1/2"	1/2"	DELTA MODEL T127H335 SHOWER VALVE WITH DIVERTER (OR ZURN Z7301 SS-MT-DV2P-HW15-VB) HAND SHOWER WITH 60" METAL HOSE; SUPPLY ELBOW, 24" GRAB / SLIDE BAR, FURNISH ZURN D2275 SHOWER DRAIN

PLUMBING SPECIALITY SCHEDULE									
MARK NO.	Fixture Type	Manufacturer's Model No.	Mount	Mount Height	Waste Size	Vent Size	C.W. Size	H.W. Size	Mixed Water Size
FD-1	FLOOR DRAIN	ZURN MODEL NO. ZN-415B OR APPROVED EQUAL	FLOOR	-	4"	2"	-	-	5" DIA. NICKEL BRONZE ADJUSTABLE TOP PROSET SYSTEM INC. TG34IP RETROFIT TRAP GUARD
FD-2	FLOOR DRAIN W/ CLEANOUT	ZURN MODEL NO. Z-456 OR APPROVED EQUAL	FLOOR	-	4"	2"	-	-	5" DIA. NICKEL BRONZE

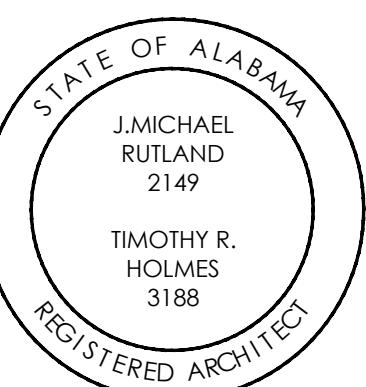

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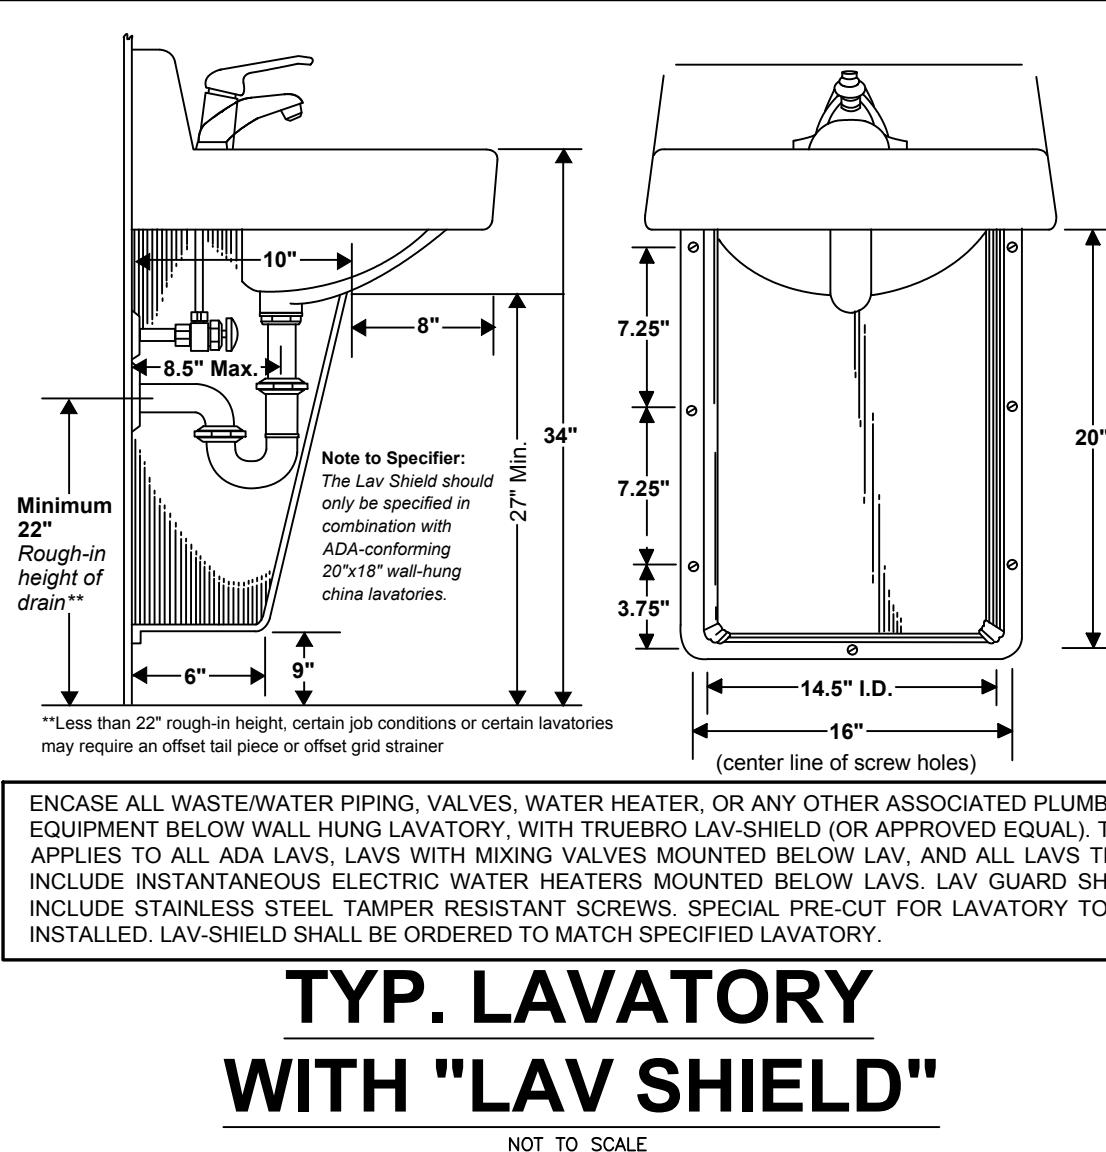
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Sheet Description

PLUMBING
DETAILS

Sheet Number

P1.2




**TYP. LAVATORY
WITH "LAV SHIELD"**
NOT TO SCALE

WIRE MUSHROOM E-STOP TO WATER HEATER CONTROL BOARD TO ENABLE/DISABLE HEATING OPERATION.
INSTALL IN ACCORDANCE WITH MANUFACTURER'S RECOMMENDATION INCLUDED WITHIN WATER HEATER INSTRUCTION MANUAL AND SERVICE HANDBOOK.

**TYP. WATER HEATER
EMERGENCY SHUT-OFF DETAIL**
NOT TO SCALE

ENCASE ALL WASTE/WATER PIPING, VALVES, WATER HEATER, OR ANY OTHER ASSOCIATED PLUMBING EQUIPMENT BELOW WALL HUNG LAVATORY, WITH TRUEBRO LAV-SHIELD (OR APPROVED EQUAL). THIS APPLIES TO ALL ADA LAVS, LAVS WITH MIXING VALVES MOUNTED BELOW LAV, AND ALL LAVS THAT INCLUDE INSTANTANEOUS ELECTRIC WATER HEATERS MOUNTED BELOW LAVS. LAV GUARD SHALL INCLUDE STAINLESS STEEL TAMPER RESISTANT SCREWS. SPECIAL PRE-CUT FOR LAVATORY TO BE INSTALLED. LAV-SHIELD SHALL BE ORDERED TO MATCH SPECIFIED LAVATORY.

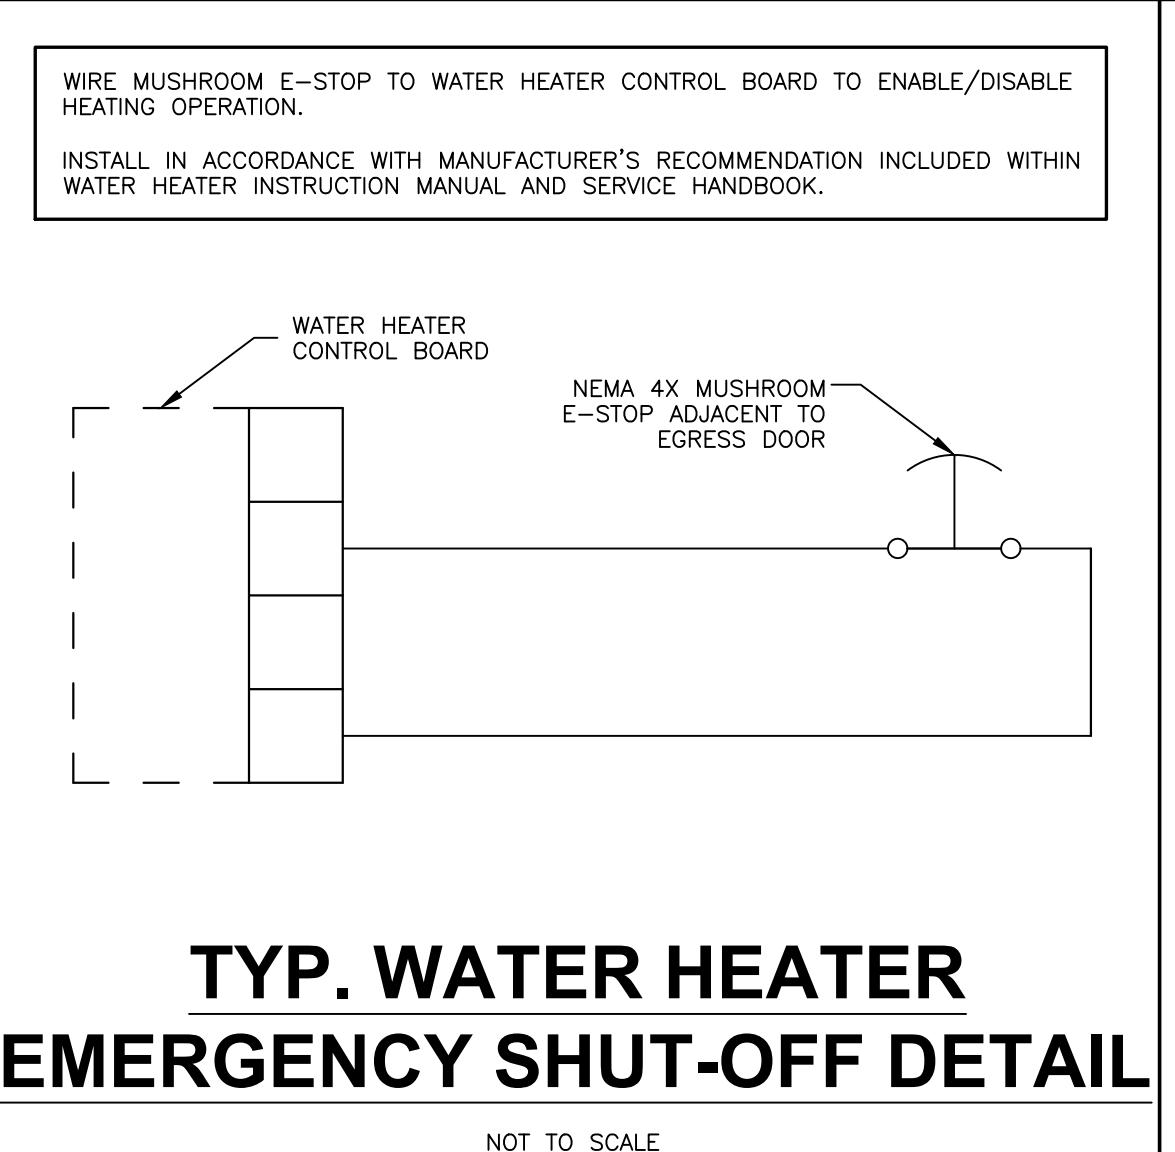


**TYPICAL MIXING
VALVE INSTALLATION**
NOT TO SCALE


LAVATORY
WATER HEATER CONTROL BOARD
NEMA 4X MUSHROOM E-STOP ADJACENT TO EGRESS DOOR

110° TEMPERED WATER TO FAUCET
COLD WATER TO FAUCET
TYPICAL MV-1 MIXING VALVE, MOUNT CONCEALED AS HIGH AS POSSIBLE BELOW LAVATORY.
1/4 TURN CHROME BALL VALVE STOPS. (TYPICAL)

MANUAL SHUT-OFF VALVE WITH A 1/8" N.P.T. PLUGGED TAPPING ACCESSIBLE FOR TEST GAGE CONNECTION TO BE INSTALLED UPSTREAM OF THE GAS SUPPLY CONNECTION TO THE APPLIANCE.
GROUND JOINT UNION
TO EQUIPMENT/CONTROLS
CONNECTION TO EQUIPMENT CONTRACTOR SHALL FURNISH AND INSTALL GAS PRESSURE REDUCING VALVE WHEN MAIN GAS DISTRIBUTION PRESSURE IS NOT 4 - 14" W.C.
FROM GAS SUPPLY
6" TRAP (Drip Leg)

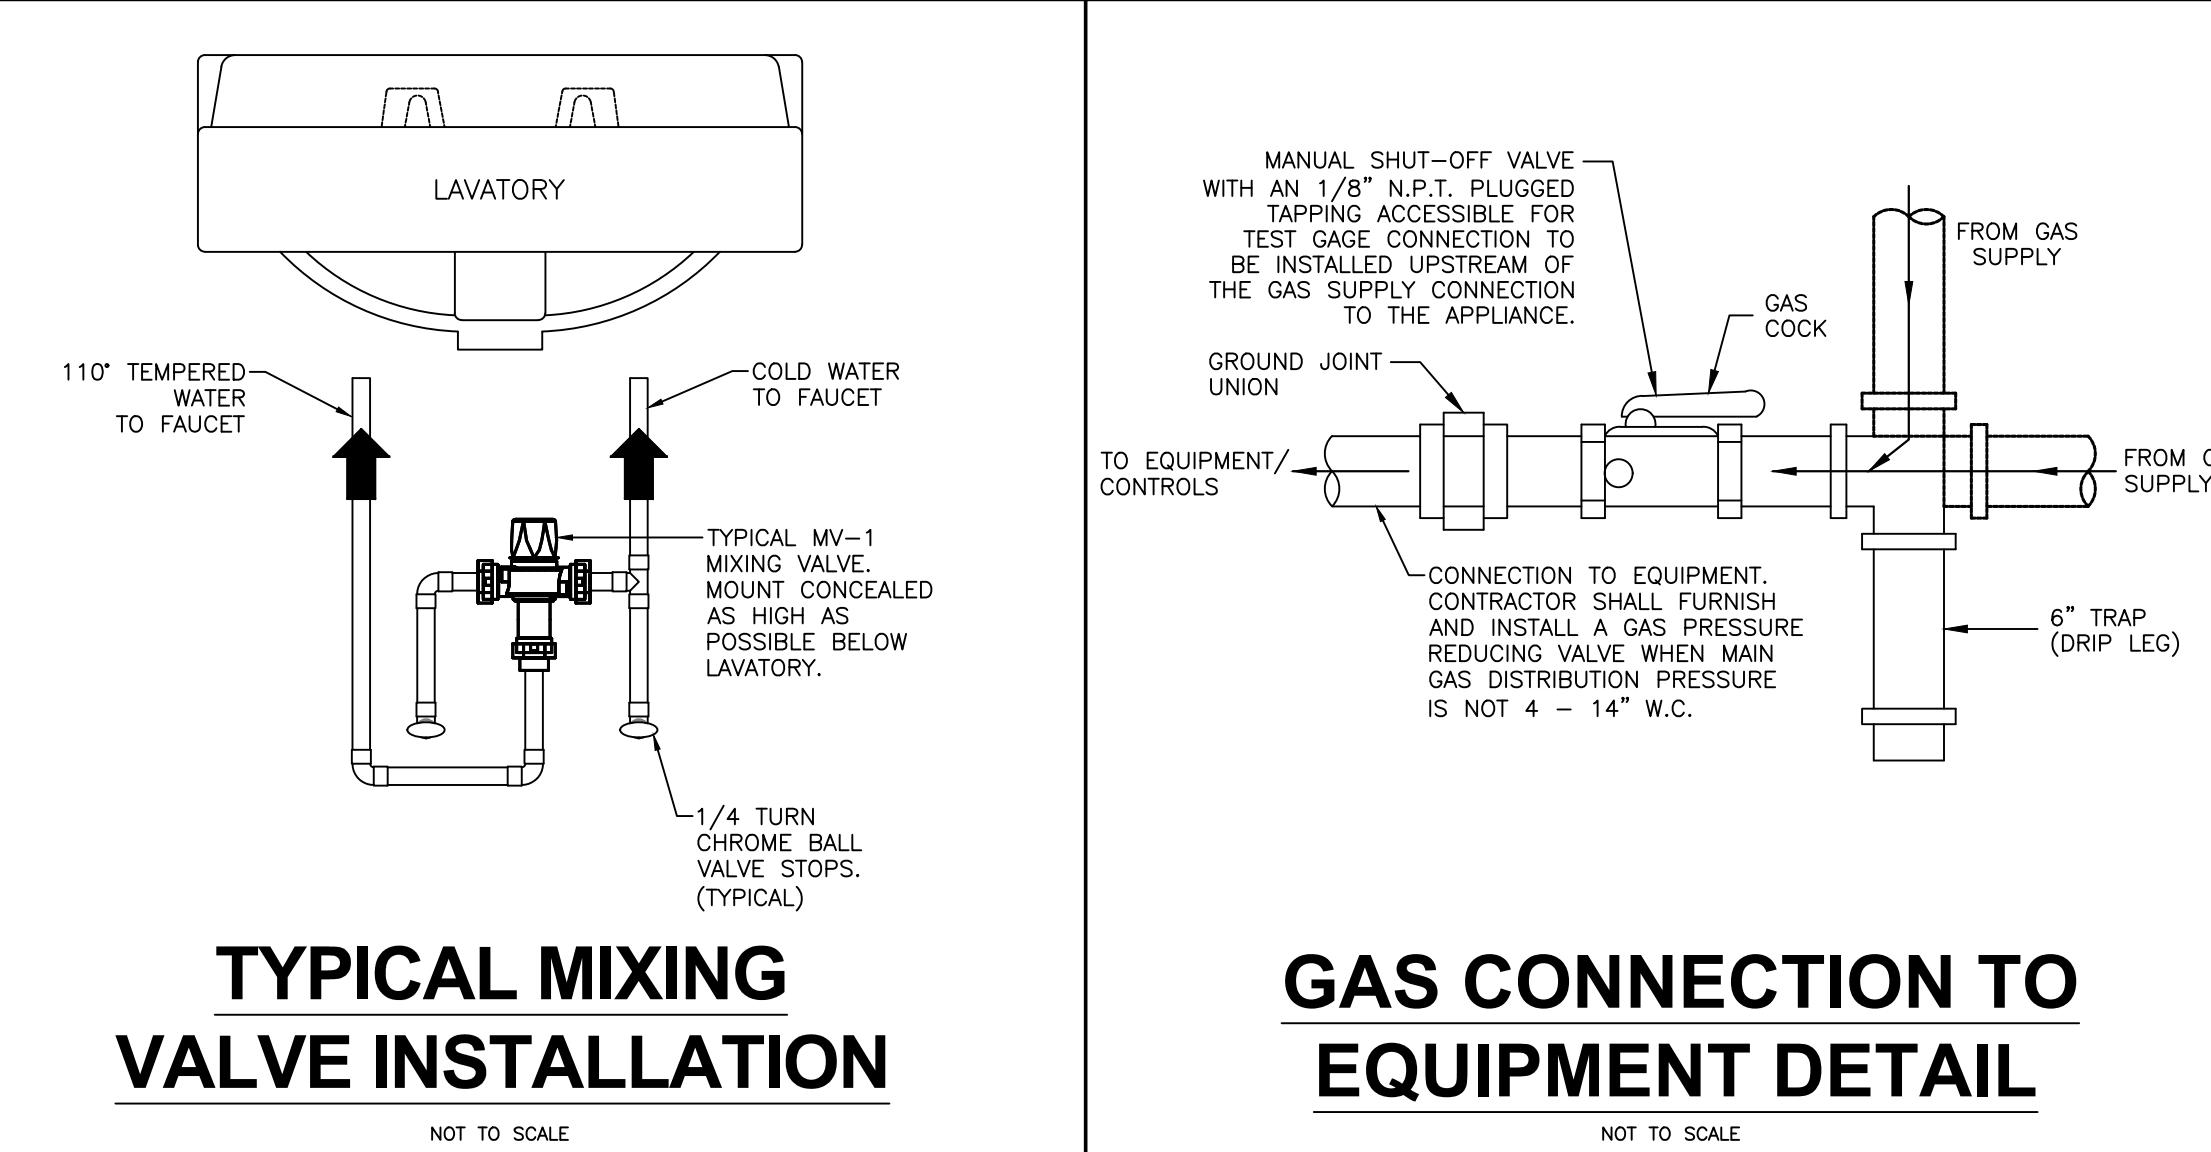

**GAS CONNECTION TO
EQUIPMENT DETAIL**
NOT TO SCALE

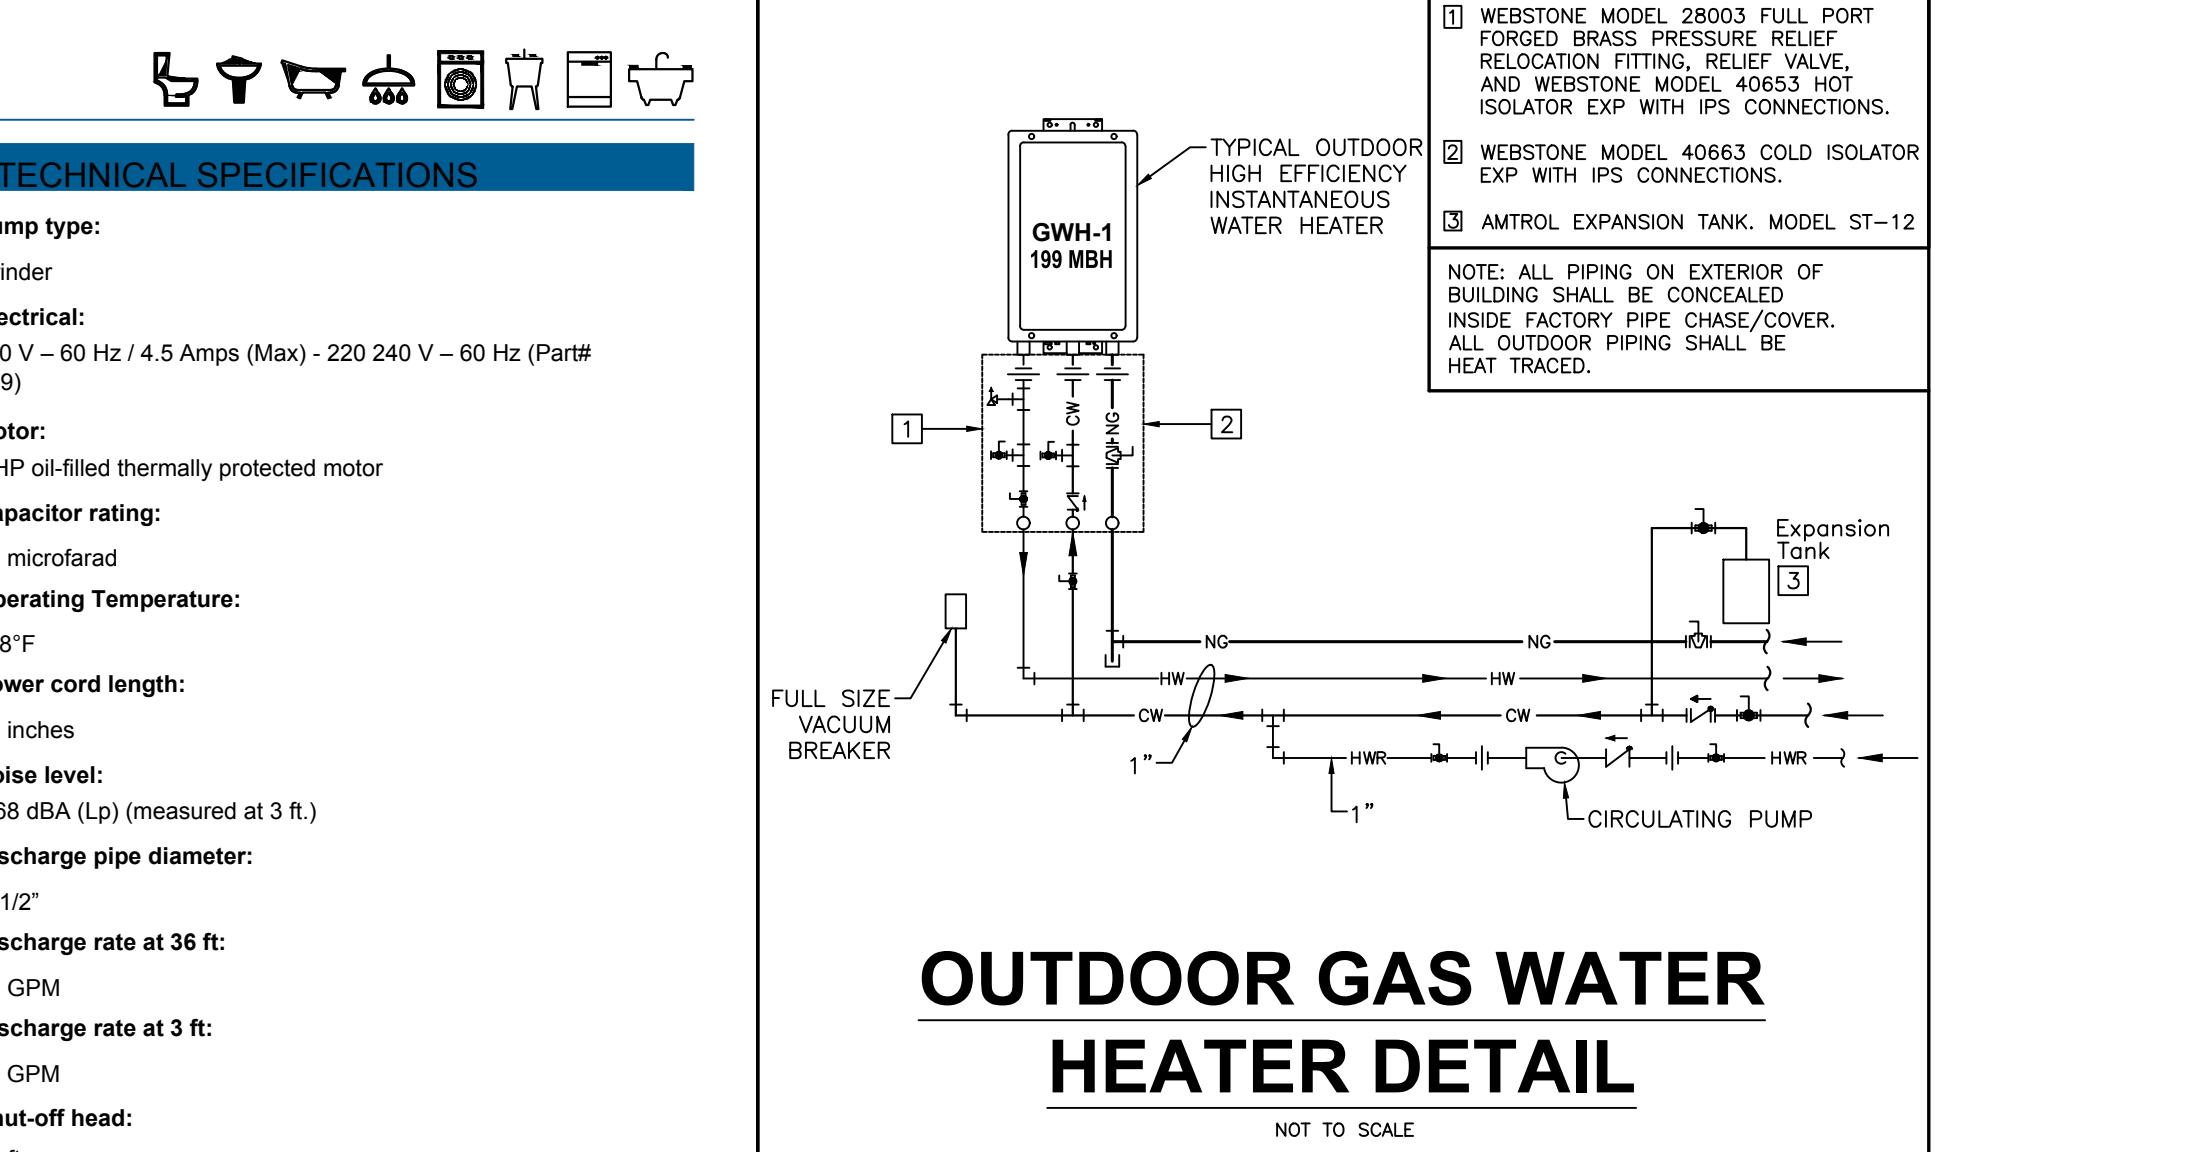

**OUTDOOR GAS WATER
HEATER DETAIL**
NOT TO SCALE

WEBSTON MODEL 28003 FULL PORT FORGED BRASS PRESSURE RELIEF RELOCATION FITTING, RELIEF VALVE, AND WEBSTON MODEL 40653 HOT ISOLATOR EXP WITH IPS CONNECTIONS.
WEBSTON MODEL 40663 COLD ISOLATOR EXP WITH IPS CONNECTIONS.
AMTROL EXPANSION TANK, MODEL ST-12

NOTE: ALL PIPING ON EXTERIOR OF BUILDING SHALL BE CONCEALED INSIDE FACTORY PIPE CHASE/COVER. ALL OUTDOOR PIPING SHALL BE HEAT TRACED.



GRINDER LIFT STATION DETAIL
NOT TO SCALE

Sanicubic® 1 GRINDER LIFT STATION – PART NO 089

CONNECTIONS

- Discharge: 1-1/2"
- Inlet: Four 1-1/2" or 4"
- Vent: 1-1/2"

Wastewater (Residential, Commercial Applications)

The Sanicubic 1 is a 1 HP heavy duty simplex grinder system used to pump away wastewater from several bathrooms and fixtures from an entire building structure. This system is able to discharge the waste up to 36 feet vertical and/or 328 feet horizontal.

It incorporates a grinder system which is ideal for uncontrolled environments in both residential and commercial applications (ie, rental unit, offices, warehouses, etc). The Sanicubic 1 is designed to handle sanitary products that may have been flushed down the toilet; such may consist of condoms, sanitary napkins, q-tips, dental floss, etc.

PRODUCT FEATURES

PERFORMANCE

- Maximum pumping height: 36 Ft (45 Ft Shut-off)
- Maximum flow rate: 50 GPM


ADVANTAGES

- Installed directly on the ground.
- Easy access for maintenance.
- Four inlets, two of which are low (1-1/2" and 4").
- System activates with a fail-safe air pressure switch system with triple redundancy.
- Stainless steel grinder.
- Integrated control panel with manual override.
- Rated IP68 with external control box and alarm standard.

STANDARD ACCESSORIES OPTIONAL

- Control box
- Wired alarm unit
- Descaler (Part NO 052) See page 28


NOTE: ALL PIPING TO AND FROM PUMP SHALL BE CONCEALED IN CHASES, WALLS, ETC. REFERENCE PLANS FOR ADDITIONAL INFORMATION.

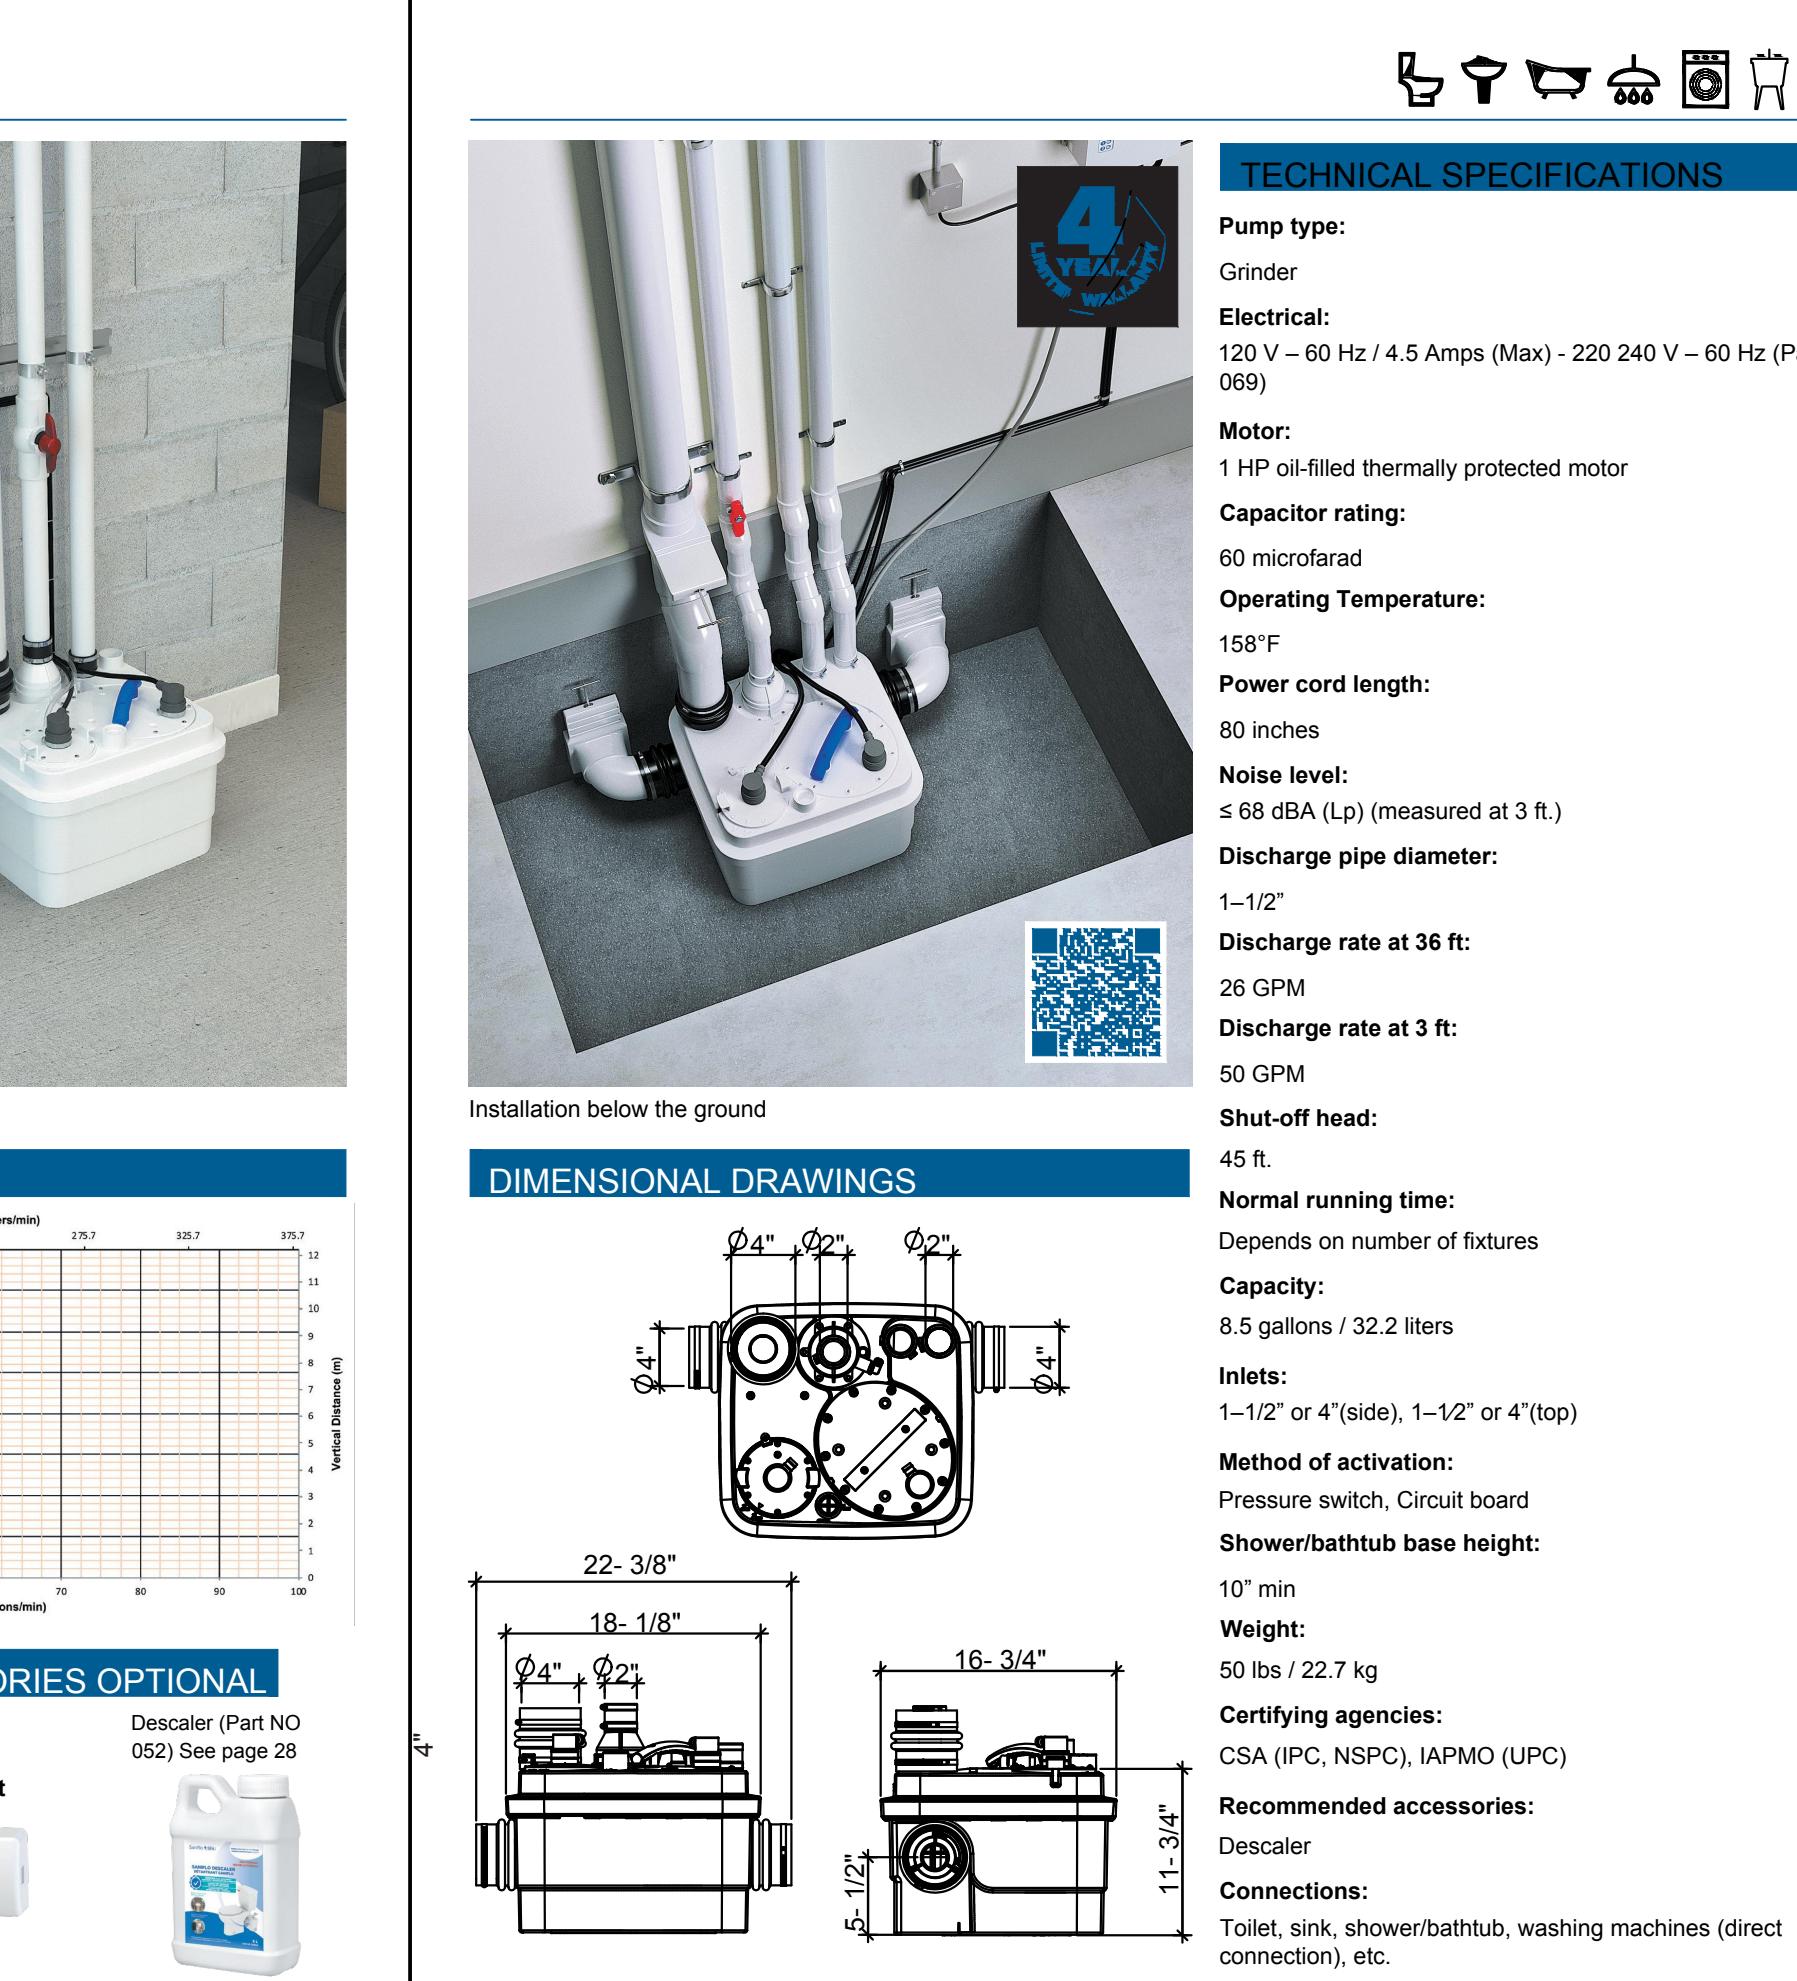


PLUMBING DETAILS
NOT TO SCALE

CLEANOUT UP TO GRADE
NOT TO SCALE


RHINO/SOUTHEAST DISTRIBUTORS, INC ITEM NO. 126 SQUARE SEWER COVER & ITEM NO. 127 SQUARE SEWER BOX
GRADE
CONCRETE
CLEANOUT PLUG
L.T. ELL OR TEE SEE PLAN

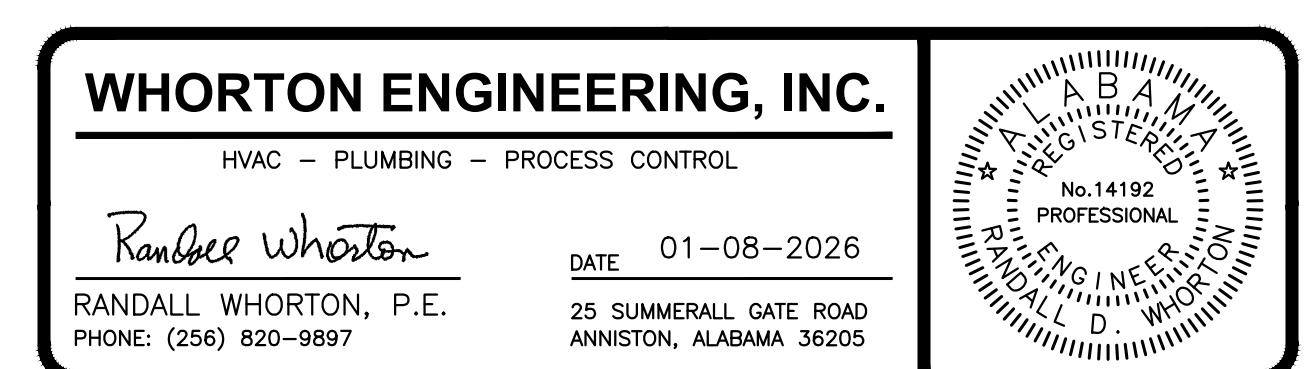

WHORTON ENGINEERING, INC.
HVAC – PLUMBING – PROCESS CONTROL
Ranbarb Whorton
RANDALL WHORTON, P.E.
PHONE: (256) 820-9897
DATE 01-08-2026
25 SUMMERALL GATE ROAD
ANNISTON, ALABAMA 36205
WHORTON ENGINEERING PROJECT NO. 25144

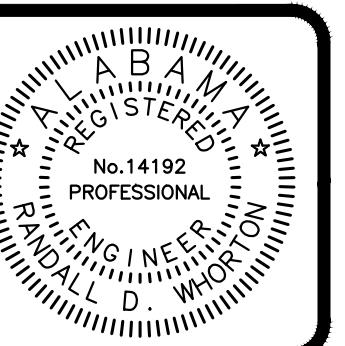

ALABAMA
REGISTERED
PROFESSIONAL
ENGINEER
No. 14192
RANDALL D. WHORTON

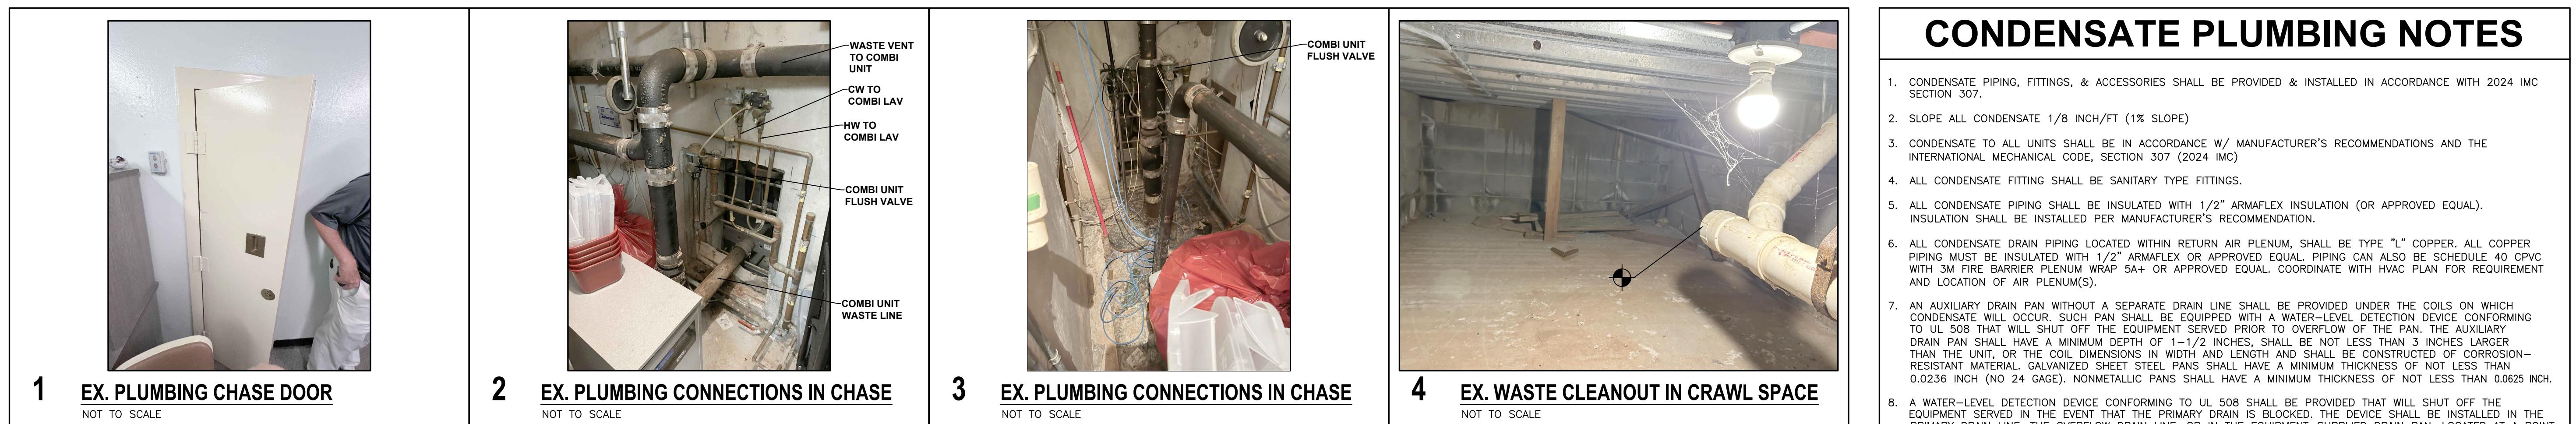

CONDENSATE PLUMBING NOTES

- CONDENSATE PIPING, FITTINGS, & ACCESSORIES SHALL BE PROVIDED & INSTALLED IN ACCORDANCE WITH 2024 IMC SECTION 307.
- SLOPE ALL CONDENSATE 1/8 INCH/FT (1% SLOPE)
- CONDENSATE TO ALL UNITS SHALL BE IN ACCORDANCE W/ MANUFACTURER'S RECOMMENDATIONS AND THE INTERNATIONAL MECHANICAL CODE, SECTION 307 (2024 IMC)
- ALL CONDENSATE FITTING SHALL BE SANITARY TYPE FITTINGS.
- ALL CONDENSATE PIPING BE INSULATED WITH 1/2" ARMAFLEX INSULATION (OR APPROVED EQUAL). INSULATION SHALL BE INSTALLED PER MANUFACTURER'S RECOMMENDATION.
- ALL CONDENSATE DRAIN PIPING LOCATED WITHIN RETURN AIR PLENUM, SHALL BE TYPE "L" COPPER. ALL COPPER PIPING MUST BE INSULATED WITH 1/2" ARMAFLEX OR APPROVED EQUAL. PIPELINE CAN ALSO BE SCHEDULE 40 CPVC WITH 3M FIRE BARRIER PLENUM WRAP 5A+ OR APPROVED EQUAL. COORDINATE WITH HVAC PLAN FOR REQUIREMENT AND LOCATION OF AIR PLENUM(S).
- AN AUXILIARY DRAIN PAN WITHOUT A SEPARATE DRAIN LINE SHALL BE PROVIDED UNDER THE COILS ON WHICH CONDENSATE WILL OCCUR. SUCH PAN SHALL BE EQUIPPED WITH A WATER-LEVEL DETECTION DEVICE CONFORMING TO UL 508 THAT WILL SHUT OFF THE EQUIPMENT SERVED PRIOR TO OVERFLOW OF THE PAN. THE AUXILIARY DRAIN PAN SHALL HAVE A MINIMUM DEPTH OF 1-1/2 INCHES, SHALL NOT BE LESS THAN 3 INCHES LARGER THAN THE UNIT, OR THE COIL DIMENSIONS IN WIDTH AND LENGTH AND SHALL BE CONSTRUCTED OF CORROSION-RESISTANT MATERIAL. GALVANIZED SHEET STEEL PANS SHALL HAVE A MINIMUM THICKNESS OF NOT LESS THAN 0.0236 INCH (NO 24 GAGE). NONMETALLIC PANS SHALL HAVE A MINIMUM THICKNESS OF NOT LESS THAN 0.0625 INCH.
- AN AUXILIARY DRAIN LINE SERVED IN THE EVENT THAT THE PRIMARY DRAIN IS BLOCKED, THE DEVICE SHALL BE INSTALLED IN THE PRIMARY DRAIN LINE, THE OVERFLOW DRAIN LINE, OR IN THE EQUIPMENT-SUPPLIED DRAIN PAN, LOCATED AT A POINT HIGHER THAN THE PRIMARY DRAIN LINE CONNECTION AND BELOW THE OVERFLOW RIM OF SUCH PAN.
- WATER-LEVEL MONITORING DEVICES : ON DOWN-FLOW UNITS AND ALL OTHER COILS THAT DO NOT HAVE A SECONDARY DRAIN OR PROVISIONS TO INSTALL A SECONDARY OR AUXILIARY DRAIN PAN. A WATER-LEVEL MONITORING DEVICE SHALL BE INSTALLED INSIDE THE PRIMARY DRAIN PAN. THIS DEVICE SHALL SHUT OFF THE EQUIPMENT SERVED IN THE EVENT THAT THE PRIMARY DRAIN BECOMES RESTRICTED. DEVICES INSTALLED IN THE DRAIN LINE SHALL NOT BE PERMITTED.
- APPLIANCE, EQUIPMENT AND INSULATION IN PANS : WHERE APPLIANCES, EQUIPMENT OR INSULATION ARE SUBJECT TO WATER DAMAGE WHEN AUXILIARY DRAIN PANS FILL, THAT PORTION OF THE APPLIANCE, EQUIPMENT AND INSULATION SHALL BE INSTALLED ABOVE THE RIM OF THE PAN. SUPPORTS LOCATED INSIDE OF THE PAN TO SUPPORT THE APPLIANCE OR EQUIPMENT SHALL BE WATER RESISTANT AND APPROVED.
- TRAPS : CONDENSATE DRAINS SHALL BE TRAPPED AS REQUIRED BY THE EQUIPMENT OR APPLIANCE MANUFACTURER.
- CONDENSATE PUMPS : CONDENSATE PUMPS LOCATED IN UNINHABITABLE SPACES, SUCH AS ATTICS AND CRAWL SPACES, SHALL BE CONNECTED TO THE APPLIANCE OR EQUIPMENT SERVED SUCH THAT WHEN THE PUMP FAILS, THE APPLIANCE OR EQUIPMENT WILL BE PREVENTED FROM OPERATING. PUMPS SHALL BE INSTALLED IN ACCORDANCE WITH THE MANUFACTURER'S INSTRUCTIONS.

TALLAPOOSA CO E911 ADDITION TO THE TALLAPOOSA COUNTY JAIL FACILITY

DADEVILLE, AL

CONSTRUCTION DOCUMENTS

Project Number: 25-1465

Date: 8 JANUARY 2026

Revisions:

Sheet Description

WASTE AND CONDENSATE PLUMBING PLANS

Sheet Number


P2.1

WASTE AND CONDENSATE PLUMBING PLANS

SCALE: 1/4" = 1'-0"

4' 0" 4' 8' 16'

SCALE

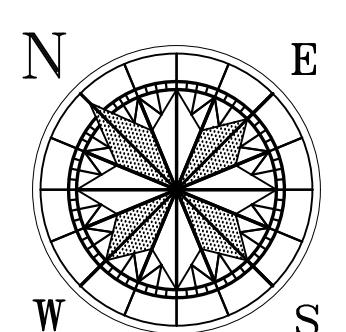

WHORTON ENGINEERING, INC.

HVAC - PLUMBING - PROCESS CONTROL

Randall Whorton


DATE 01-08-2026

RANDALL WHORTON, P.E.

PHONE: (256) 820-9897

25 SUMMERALL GATE ROAD

ANNISTON, ALABAMA 36205

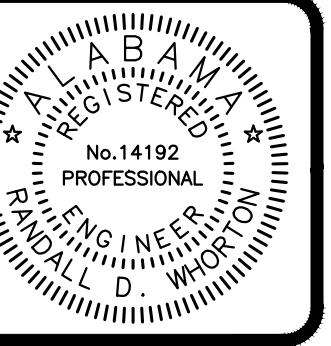

WHORTON ENGINEERING PROJECT NO. 25144

22 OF 40

**TALLAPOOSA
CO E911
ADDITION TO
THE
TALLAPOOSA
COUNTY JAIL
FACILITY**
DADEVILLE, AL

**CONSTRUCTION
DOCUMENTS**

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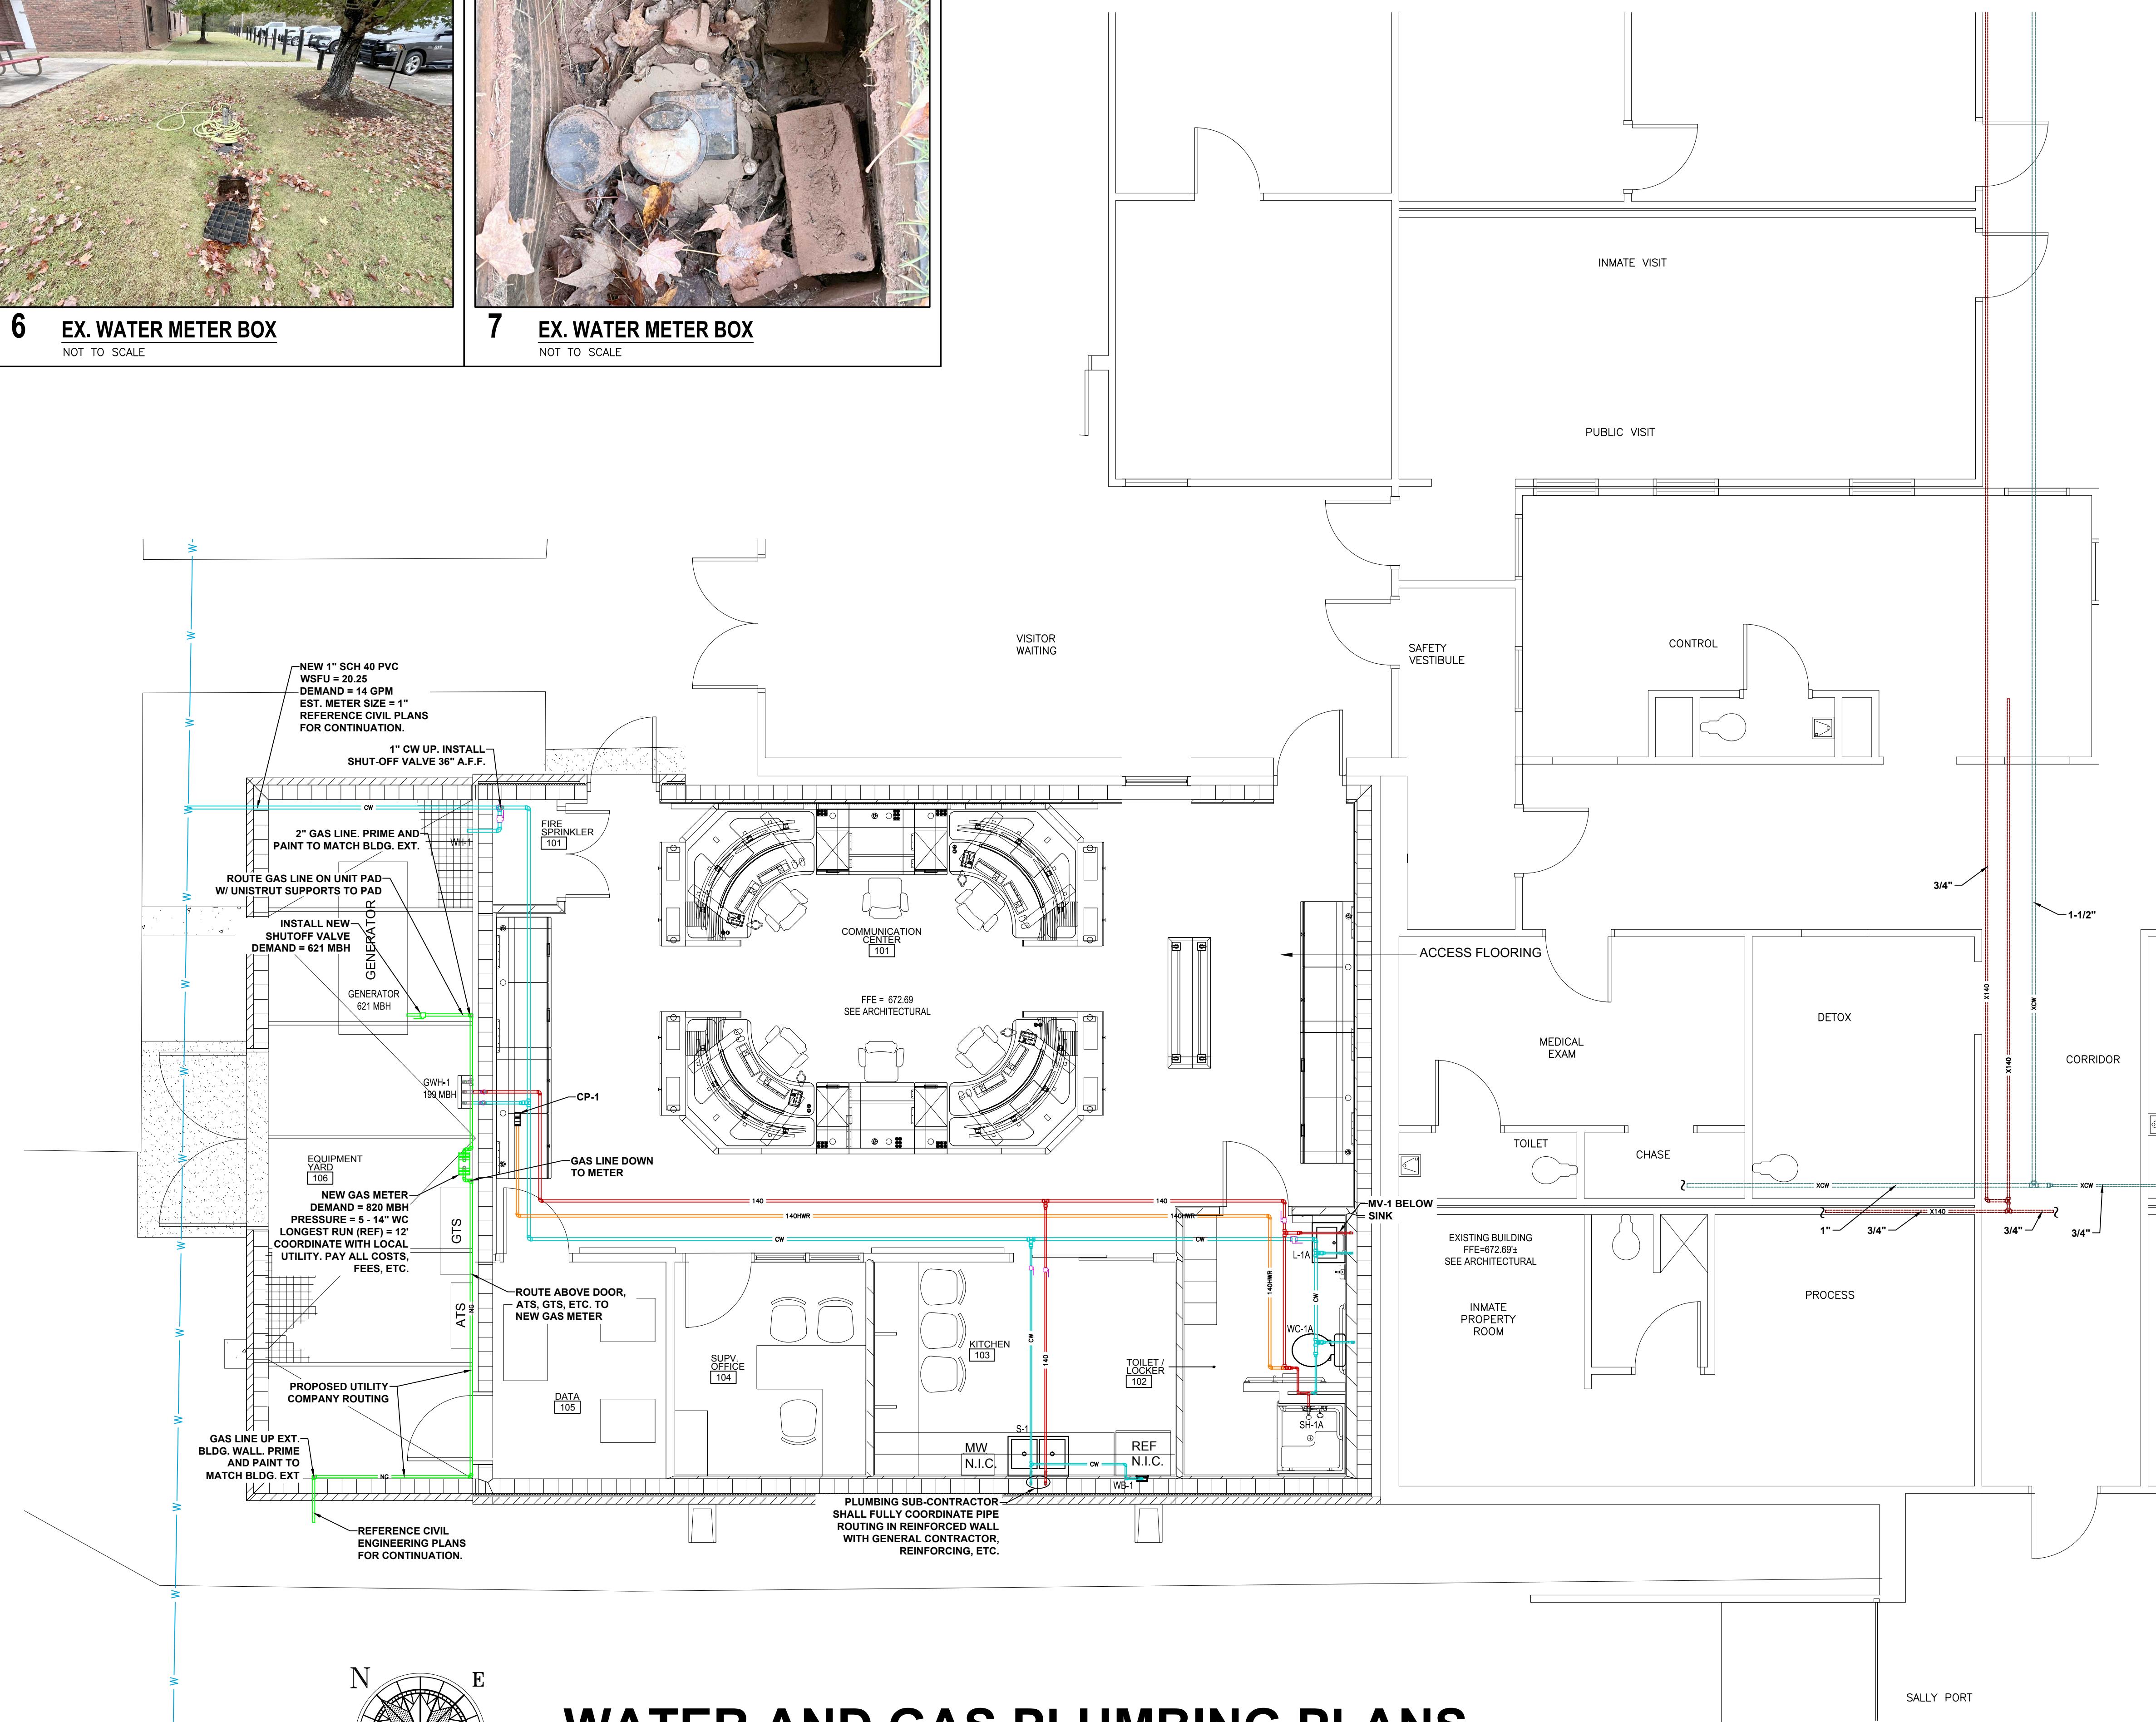
Revisions:

Sheet Description

**WATER AND GAS
PLUMBING
PLANS**

Sheet Number

P3.1



TALLAPOOSA CO E911 ADDITION TO THE TALLAPOOSA COUNTY JAIL FACILITY
DADEVILLE, AL




CONSTRUCTION DOCUMENTS

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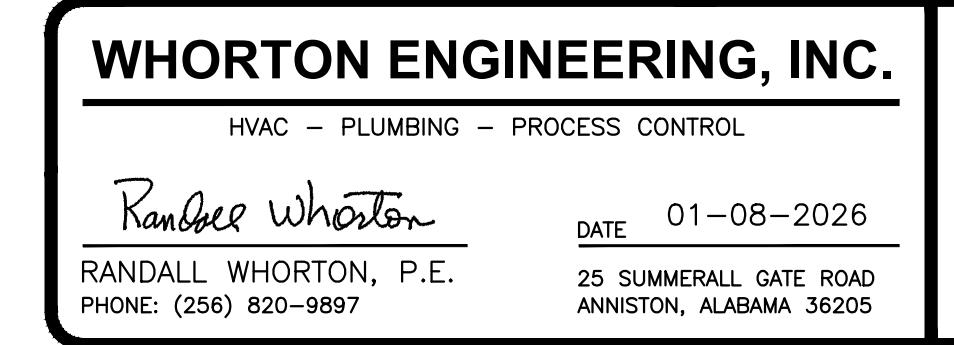
PLUMBING RISER DIAGRAMS

Sheet Number




PLUMBING RISER DIAGRAMS

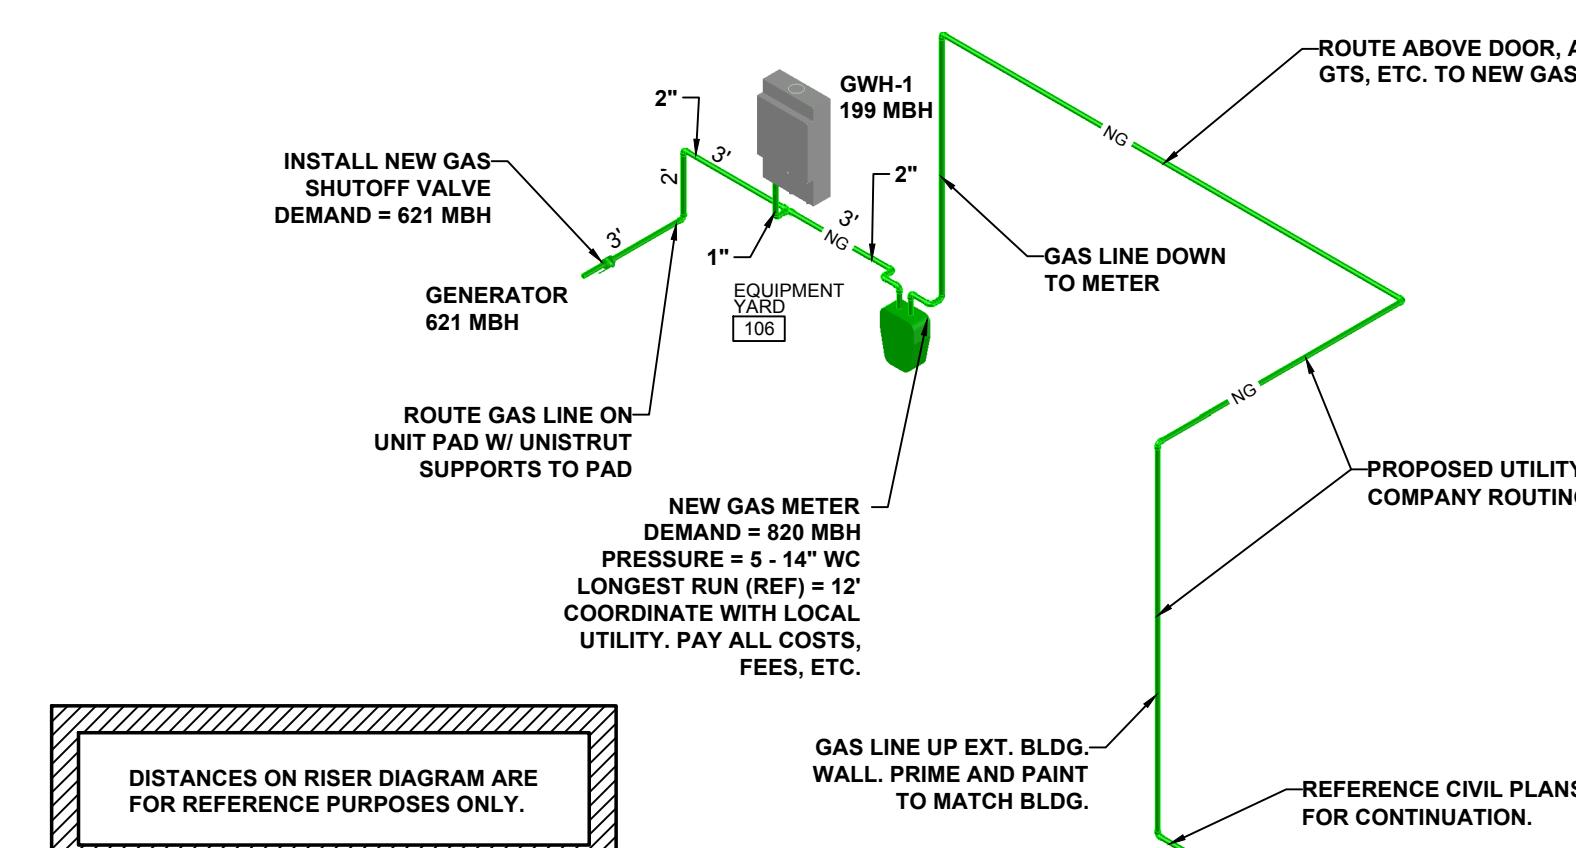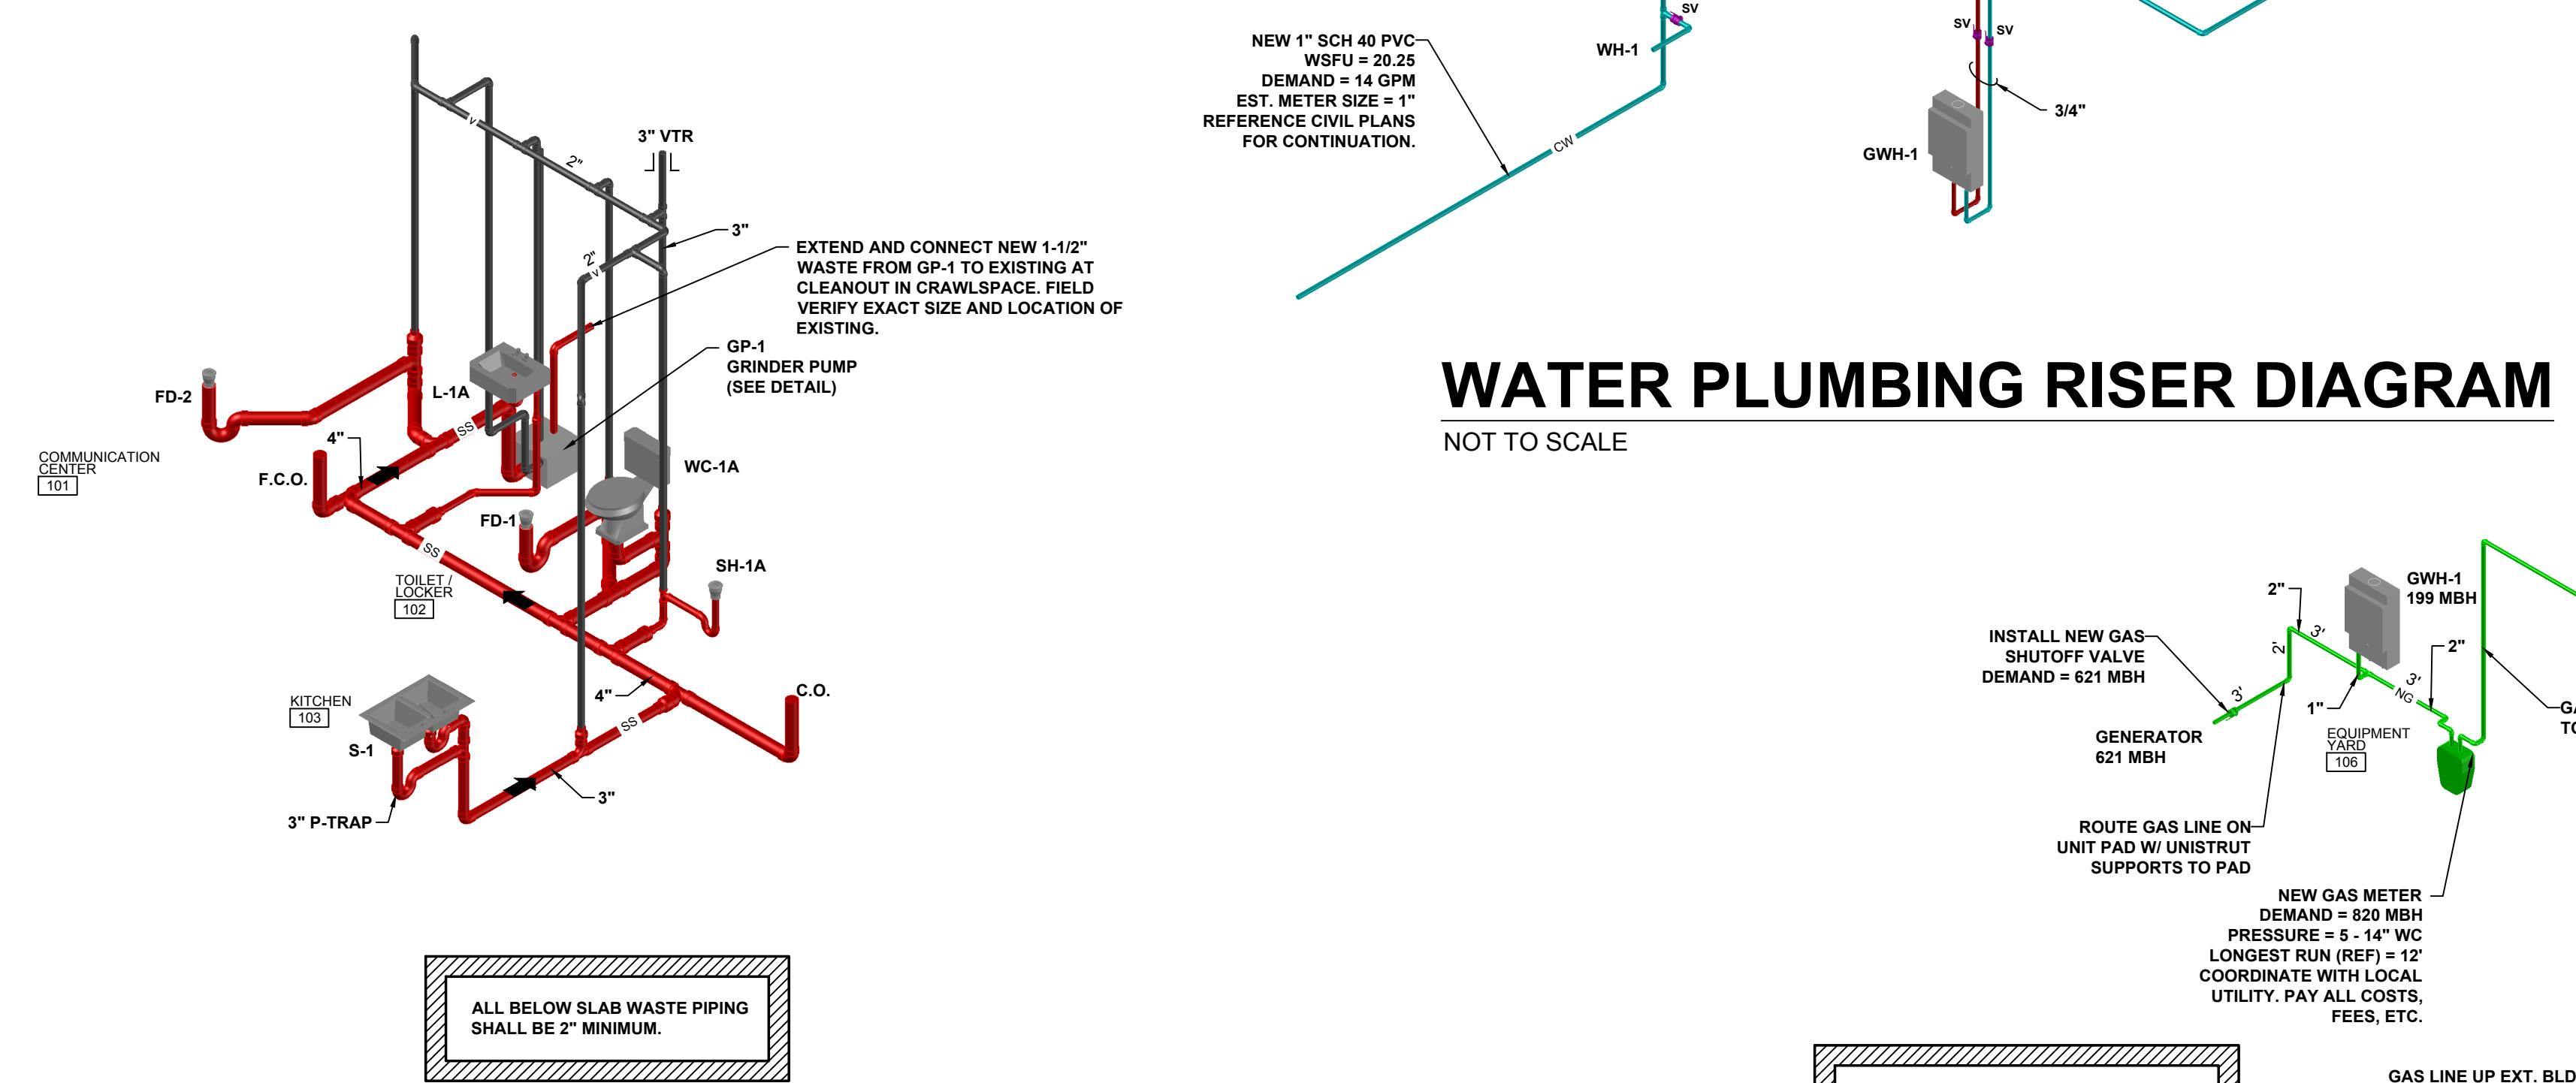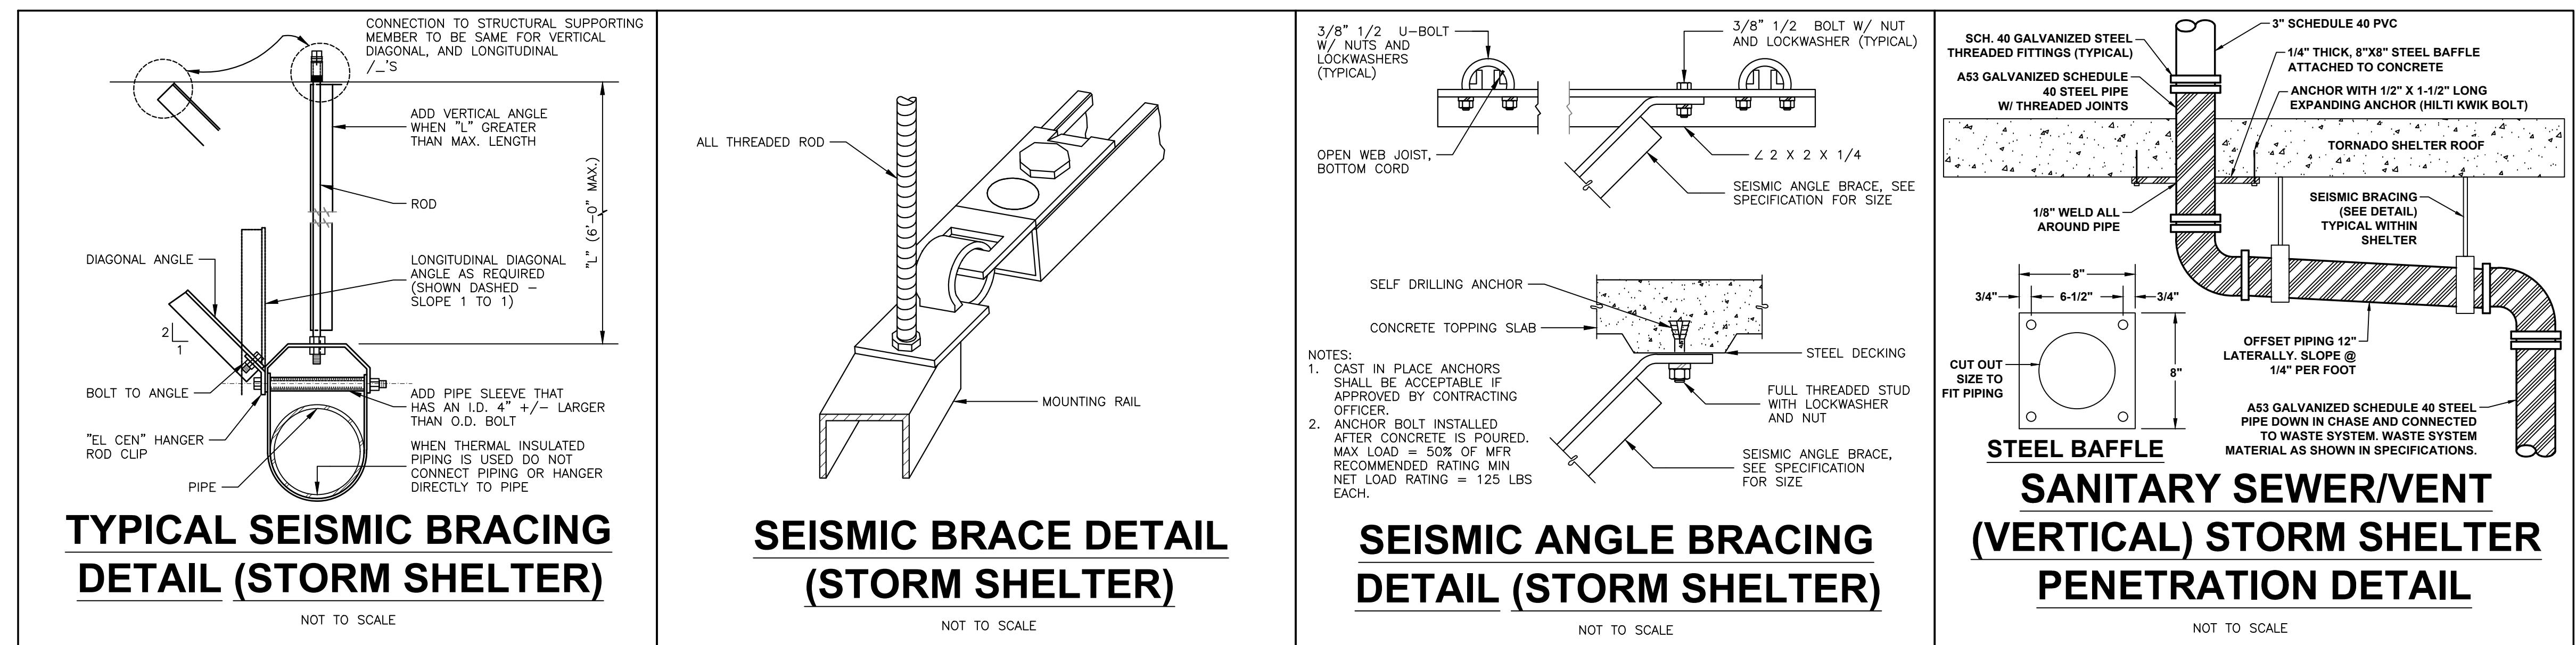NOT TO SCALE



P4.1

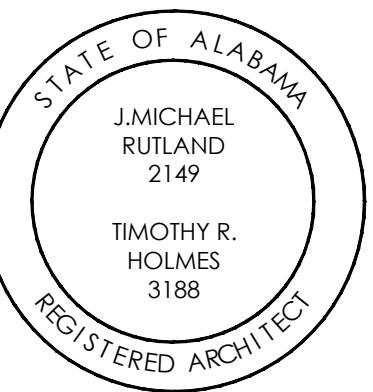

TALLAPOOSA
CO E911
ADDITION TO
THE
TALLAPOOSA
COUNTY JAIL
FACILITY

DADEVILLE, AL

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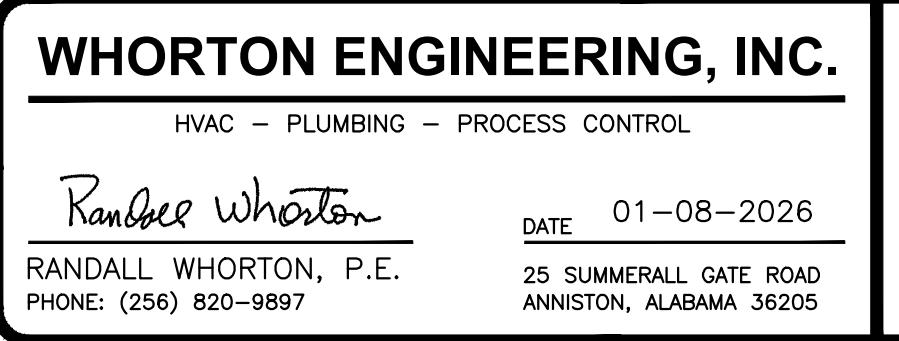
Revisions:

Sheet Description

HVAC LEGEND,
NOTES, AND
SCHEDULES

Sheet Number

M1.1



HVAC NOTES

- ① ALL DUCT DIMENSIONS SHOWN ARE NET INTERNAL.
- ② INSTALL OPPOSED BLADE BALANCING DAMPERS IN ALL NEW DIFFUSERS AND GRILLES.
- ③ THESE DRAWINGS ARE SCHEMATIC IN NATURE AND ARE NOT INTENDED TO SHOW ALL POSSIBLE CONDITIONS. IT IS INTENDED THAT A COMPLETE HVAC SYSTEM BE PROVIDED WITH ALL NECESSARY EQUIPMENT, APPURTENANCES, AND CONTROLS, COMPLETELY COORDINATED WITH ALL DISCIPLINES. ALL REQUIREMENTS OF THESE DOCUMENTS SHALL BE STRICTLY CONFORMED WITH ANY ITEMS AND LABOR REQUIREMENTS OF THE CONTRACT DOCUMENTS, WHETHER OR NOT THE SAME ARE APPROPRIATE CODES, STANDARDS, AND THESE CONTRACT DOCUMENTS SHALL BE FURNISHED WITHOUT INCURRING ANY ADDITIONAL COST TO THE CONTRACT. CAREFULLY REVIEW ALL CONTRACT DOCUMENTS AND THE DESIGN OF OTHER TRADES BEFORE PREPARING SHOP DRAWINGS.
- ④ COORDINATE DUCTWORK AND PIPING WITH STRUCTURAL, PLUMBING, FIRE PROTECTION AND ELECTRICAL, MAKE OFFSETS AND TRANSITIONS AS REQUIRED TO CLEAR STRUCTURAL MEMBERS, ETC. COORDINATE WITH OTHER TRADES WITHOUT ADDITIONAL EXPENSE TO THE OWNER.
- ⑤ REFER TO ARCHITECTURAL CEILING PLANS FOR EXACT LOCATION OF ALL CEILING MOUNTED AIR DISTRIBUTION DEVICES. COORDINATE WITH ARCHITECTURE, GRILLES, REGISTERS, AND DIFFUSERS. WITH ARCHITECTURE AND INTERIOR REFLECTED CEILING PLANS AND LIGHTING FIXTURES. FOR PARTICULAR ITEMS NOT SHOWN ON THE ARCHITECTURAL REFLECTED CEILING PLAN, PREPARE A DRAWING AND PRESENT IT TO THE ARCHITECT FOR REVIEW AND/OR APPROVAL.
- ⑥ COORDINATE ALL ROOF AND SLAB PENETRATIONS WITH THE STRUCTURAL ENGINEER. TRANSITIONS RECTANGULAR DUCTWORK ON THE BOTTOM AND THE SIDES. MAINTAIN DUCTWORK LEVEL AS HIGH AS POSSIBLE UNLESS NOTED OTHERWISE.
- ⑦ THE HVAC CONTRACTOR IS TO REVIEW THE ENTIRE SET OF PLANS FOR COORDINATION WITH OTHER TRADES. SHOP DRAWINGS WITH ALL TRADES COORDINATED WILL BE REQUIRED.
- ⑧ THE HVAC CONTRACTOR SHALL REVIEW THE ARCHITECTURAL PLANS FOR FINAL LOCATIONS OF ALL RATED WALLS, CEILINGS, FLOORS, ETC. THE HVAC CONTRACTOR SHALL FURNISH AND INSTALL FIRE OR FIRE/SMOKE DAMPERS IN ALL RATED LOCATIONS WHETHER SHOWN ON THE MECHANICAL PLANS OR NOT.
- ⑨ CONTRACTOR SHALL COORDINATE VOLTAGE AND PHASE OF EACH PIECE OF EQUIPMENT WITH THE ELECTRICAL CONTRACTOR PRIOR TO ORDERING.
- ⑩ ALL THREE PHASE EQUIPMENT SHALL BE EQUIPPED WITH PHASE LOSS PROTECTION.
- ⑪ ALL MOTOR STARTERS SHALL BE FURNISHED BY THE MECHANICAL CONTRACTOR.
- ⑫ CONTRACTOR TO COORDINATE ALL CEILING TYPES WITH DIFFUSERS. ALL DIFFUSERS IN GYPSUM CEILING SHALL INCLUDE PLASTER FRAME.
- ⑬ ALL DISTRIBUTION DEVICES SHALL HAVE FACE OPERABLE DAMPERS. ALL DIFFUSER RUNOUTS SHALL INCLUDE SPIN-IN DAMPER IN ROUND DUCTS.
- ⑭ INSULATE TOP SIDE/BACK OF ALL DIFFUSERS/GRILLES, ETC.
- ⑮ CONDENSATE DRAIN PIPING SHALL BE SLOPED A MINIMUM OF 1/8" PER FOOT AND SHALL BE SIZED PER TABLE 307.2.2 IN THE 2021 INTERNATIONAL MECHANICAL CODE UNLESS SHOWN LARGER ON PLANS.
- ⑯ ALL 3/4" AND 1" CONDENSATE DRAIN TRAPS SHALL BE EZ-TRAP OR APPROVED EQUAL WITH FLOAT SWITCH.
- ⑰ INSTALL AUXILIARY DRAIN PAN UNDER ALL UNITS MOUNTED IN ATTIC, ABOVE CEILINGS, ETC. INSTALL FLOAT SWITCH FOR UNIT SHUT DOWN IN AUXILIARY DRAIN PAN.
- ⑱ REFERENCE PLUMBING PLANS FOR CONDENSATE PIPING. IF CONDENSATE DRAINS ARE NOT SHOWN ON THE PLUMBING PLANS, ALL CONDENSATE DRAINS SHALL BE FURNISHED AND INSTALLED BY THE HVAC CONTRACTOR.
- ⑲ VERIFY WITH THE ARCHITECTURAL DRAWINGS, SIZE, LOCATION, AND MOUNTING HEIGHT OF ALL LOUVERS. VERIFY COLOR AND FINISH WITH ARCHITECT.
- ⑳ ALL UNUSED PORTION OF LOUVERS SHALL BE CAPPED OFF WITH 1" INSULATED ALUMINUM AND SEALED AIR/WATER TIGHT.
- ㉑ ALL THERMOSTATS TO BE AUTOMATIC CHANGE OVER TYPE AND SHALL INCLUDE LOCKING THERMOSTAT COVERS.
- ㉒ ALL THERMOSTATS TO BE MOUNTED 4'-0" A.F.F. TO HIGHEST OPERABLE CONTROL UNLESS OTHERWISE INDICATED.
- ㉓ ALL REFRIGERANT LINES SHALL BE SIZED/APPROVED BY THE EQUIPMENT VENDOR/COMPRESSOR MANUFACTURER.
- ㉔ ALL EXTERIOR EXPOSED ARMAFLEX INSULATION SHALL BE ARMAFLEX SHIELD WITH UV RESISTANT COATING.
- ㉕ PORTIONS OF DUCTWORK VISIBLE THROUGH GRILLES, REGISTERS, AND DIFFUSERS IN FINISHED AREAS SHALL BE PAINTED FLAT BLACK.
- ㉖ FLEXIBLE DUCT (SUPPLY RUNOUTS ONLY) SHALL NOT EXCEED 6'-0" IN LENGTH.
- ㉗ DUCTWORK SHALL BE INSULATED IN ACCORDANCE WITH THE FOLLOWING SCHEDULE: RECTANGULAR SUPPLY: 1" INTERNAL ROUND SUPPLY: 1-1/2" EXTERNAL FLEXIBLE SUPPLY: 1" PRE INSULATED RECTANGULAR RETURN: 1" INTERNAL OSA/EXHAUST: 1-1/2" EXTERNAL
- ㉘ DUCTWORK SHALL BE GALVANIZED AND INSTALLED IN ACCORDANCE WITH SMACNA STANDARDS.
- ㉙ LABEL ALL DUCTS WITH TYPE (SUPPLY, RETURN, ETC.) AND ARROWS INDICATING DIRECTION OF AIR FLOW. LABELS SHALL BE EVERY SIX FEET AND AT EACH CHANGE OF DIRECTION (T'S, ELBOWS, ETC.)
- ㉚ ROUND DUCT SHALL BE INSULATED WITH DUCT WRAP EQUAL TO CERTAINTED SOFT TOUCH DUCT WRAP WITH FSK VAPOR RETARDER FACING TYPE 75 WITH MINIMUM INSTALLED R-VALUE 4.2. ROUND DUCTS LOCATED WITHIN THE ATTIC SHALL BE INSULATED WITH DUCT WRAP EQUAL TO CERTAINTED SOFT TOUCH DUCT WRAP WITH FSK VAPOR RETARDER FACING TYPE 100 WITH MINIMUM INSTALLED R-VALUE 6.0.
- ㉛ ALL OPEN ENDED DUCT SHALL BE CAPPED WITH 1/2"X1/2" WIRE MESH.
- ㉜ ALL EXPOSED DUCT SHALL BE INSULATED INTERNALLY WITH 1" DUCT LINER EQUAL TO CERTAINTED TG2 DUCT LINER WITH MINIMUM INSTALLED R-VALUE 4.0.
- ㉝ ALL EXPOSED DUCT SHALL BE PAINTED. DUCT SHALL BE "PAINT GRIP". COORDINATE PAINT COLOR WITH ARCHITECT.
- ㉞ DUCT LINER FOR RECTANGULAR DUCTS SHALL BE EQUAL TO CERTAINTED TG2 DUCT LINER WITH A MINIMUM R-VALUE OF 4.0. RECTANGULAR DUCTS LOCATED WITHIN THE ATTIC SHALL BE LINED WITH DUCT LINER EQUAL TO CERTAINTED TG2 DUCT LINER WITH A MINIMUM R-VALUE OF 4.0 AND WRAPPED EXTERNALLY WITH DUCT WRAP EQUAL TO CERTAINTED SOFT TOUCH DUCT WRAP WITH FSK VAPOR RETARDER FACING TYPE 75 WITH A MINIMUM INSTALLED R-VALUE OF 4.2.
- ㉟ UNLESS OTHERWISE NOTED, WARRANTIES SHALL BEGIN AT DATE OF SUBSTANTIAL COMPLETION. ALL COMPRESSORS SHALL INCLUDE MIN. OF FIVE YEAR WARRANTY. ONE YEAR WARRANTY FOR LABOR, PARTS, UNITS, ETC. IS REQUIRED FOR ALL EQUIPMENT.
- ㉟ CONTRACTOR SHALL ANCHOR OUTDOOR UNITS TO CONCRETE PAD IN ACCORDANCE WITH MANUFACTURER'S RECOMMENDATION, WIND LOAD REQUIREMENTS, AND AS PER PLANS/SPECIFICATIONS. COORDINATE CONCRETE PAD SIZE, UNIT CLEARANCES, ETC. WITH STRUCTURAL AND ARCHITECTURAL PLANS, FRAMING, ETC.
- ㉟ THE CONTRACTOR SHALL INSTALL ANY CURB-MOUNTED EQUIPMENT IN SUCH A WAY THAT NO WATER LEAKAGE IS INTRODUCED INTO THE BUILDING.
- ㉟ ALL INDOOR AND OUTDOOR UNITS SHALL BE LOCATED SO THAT MAINTENANCE CLEARANCES IN ACCORDANCE WITH MANUFACTURER'S RECOMMENDATION AND AS PER PLANS/SPECIFICATIONS ARE MAINTAINED. COORDINATE MAINTENANCE CLEARANCES WITH STRUCTURAL AND ARCHITECTURAL PLANS, FRAMING, ETC.

HVAC LEGEND

SYMBOL	DESCRIPTION	SYMBOL	DESCRIPTION	SYMBOL	DESCRIPTION
	CEILING DIFFUSER - SUPPLY RECTANGULAR WITH ROUND NECK 4-WAY THROW UNLESS OTHERWISE INDICATED		MANUAL VOLUME DAMPER OPPOSED BLADE		VANNED TEE (PROVIDE ALL SQUARE OR RECTANGULAR TEE'S WITH VANES EVEN IF SYMBOL IS MISSING)
	CEILING DIFFUSER - RETURN RECTANGULAR WITH SQUARE NECK		LOW LEAKAGE MOTORIZED VOLUME DAMPER		STANDARD DUCT SIZE TRANSITION
	SIDEWALL DIFFUSER - SUPPLY WITH MULTI-VANE DEFLECTOR		THERMOSTAT LOCATION		STANDARD SQUARE TO ROUND TRANSITION
	SIDEWALL DIFFUSER - RETURN WITH 30° FIXED DEFLECTION		HUMIDISTAT LOCATION		HVAC CONDENSATE DRAIN PIPING
XX-X XXX CFM	DIFFUSER TAG REFERENCE SCHEDULE FOR SIZING		STANDARD 90° RADIUS ELBOW		HVAC REFRIGERANT LINE
	CEILING EXHAUST FAN		STANDARD 45° RADIUS ELBOW		ELECTRIC UNIT HEATER WALL MOUNTED (RECESSED)
	12"X12"		90° VANNED ELBOW (PROVIDE ALL SQUARE OR RECTANGULAR ELBOWS WITH VANES EVEN IF SYMBOL IS MISSING)		
	10"		45° VANNED ELBOW (PROVIDE ALL SQUARE OR RECTANGULAR ELBOWS WITH VANES EVEN IF SYMBOL IS MISSING)		

EXHAUST FAN SCHEDULE

MARK NO.	MOUNTING	CFM	STATIC IN W.G.	SONES	WATTS	VOLTAGE	MANUFACTURER (OR APPROVED EQUAL)	MODEL NO.	WEIGHT (LBS.)	NOTES
	CEILING	125	0.25	1.7	90	115-1-60	LOREN COOK	GC-340	25	SEE BELOW
<p>① FAN TO INCLUDE FACTORY MOUNTED/PRE-WIRED FAN SPEED CONTROL. ② FAN TO BE SWITCHED WITH LIGHTING.</p>										
<p>APPROVED EQUALS: BREIDERT, GREENHECK, AND PENN.</p>										

WALL MOUNTED ELECTRIC HEATER SCHEDULE

MARK NO.	NOMINAL CFM	VOLTAGE	WATTS	BTU/HR	AMPS	MANUFACTURER (OR APPROVED EQUAL)	UNIT MODEL NO.	UNIT WEIGHT (LBS)	NOTES
	100	208-1-60	1,500	5,120	7.2	BERKO	FRC4024F	25	SEE BELOW
<p>① UNIT TO INCLUDE BUILT-IN TAMPER-PROOF THERMOSTAT. ② UNIT TO INCLUDE FACTORY DISCONNECT SWITCH - MOUNTED BEHIND FRONT GRID PANEL. ③ UNIT TO INCLUDE THERMAL CUTOFF. ④ UNIT TO INCLUDE SEMI-RECESSED MOUNTING FRAME. ⑤ UNIT TO BE MOUNTED AT 16" AFF.</p>									
<p>APPROVED EQUALS: INDECO, MARKEL, QMARK, AND RAYWALL</p>									

CODES AND STANDARDS

- 2021 INTERNATIONAL PLUMBING CODE
- 2021 INTERNATIONAL MECHANICAL CODE
- 2021 INTERNATIONAL ENERGY CONSERVATION CODE
- 2010 ADA STANDARDS FOR ACCESSIBLE DESIGN
- ASHRAE 90.1-2013 ENERGY STANDARD


HVAC DRAWING INDEX


SHEET NO.	SHEET TITLE
M1.1	HVAC LEGEND, NOTES, AND SCHEDULES
M1.2	HVAC SCHEDULES
M1.3	HVAC SCHEDULES, DETAILS, AND VRF DIAGRAM
M2.1	HVAC DETAILS AND COMPLIANCE CALCULATIONS
M2.2	HVAC DETAILS
M3.1	HVAC PLANS

Sheet Description

HVAC LEGEND,
NOTES, AND
SCHEDULES

Sheet Number

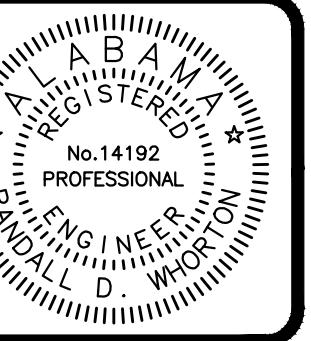

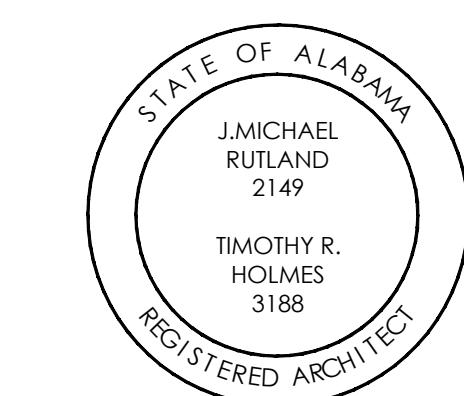

TALLAPOOSA
CO E911
ADDITION TO
THE
TALLAPOOSA
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CONSTRUCTION
DOCUMENTS

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HVAC
SCHEDULES

Sheet Number

M1.2

VRF INDOOR EQUIPMENT SCHEDULE (CEILING SUSPENDED)

MARK NO.	NOMINAL FAN CFM	COOLING CAPACITY		HEATING CAPACITY		MODEL NO. DATA		ELECTRICAL			NET WEIGHT (LBS.)	ASSOCIATED OUTDOOR UNIT	NOTES
		TOTAL CAPACITY (MBH)	CONDENSER E.A.T.	EVAPORATOR E.W.B. TEMP.	HIGH TEMP 47° E.A.T. (MBH)	MANUFACTURER (OR APPROVED EQUAL)	MODEL NO.	VOLTAGE	MCA (A)	MOCP (A)			
CS-1	635	24.0	95	80/67	27.0	MITSUBISHI	PCFY-P24	208/230-1-60	0.52	15	71	HRU-1	SEE BELOW
CS-2	985	30.0	95	80/67	34.0	MITSUBISHI	PCFY-P30	208/230-1-60	1.22	15	79	HRU-1	SEE BELOW
CS-1R	635	24.0	95	80/67	27.0	MITSUBISHI	PCFY-P24	208/230-1-60	0.52	15	71	HRU-1R	SEE BELOW
CS-2R	985	30.0	95	80/67	34.0	MITSUBISHI	PCFY-P30	208/230-1-60	1.22	15	79	HRU-1R	SEE BELOW
TOTAL		108.0			122.0								

- ① ALL UNITS TO INCLUDE INTERNAL FACTORY CONDENSATE PUMP.
- ② ALL UNITS TO INCLUDE WALL MOUNTED SMART ME CONTROLLER AND WALL MOUNTED REMOTE TEMPERATURE SENSOR.
- ③ REFRIGERANT R-410A.
- ④ ALL UNITS TO INCLUDE BICLIMATIC (OR APPROVED EQUAL) BI-POLAR IONIZATION UNIT MOUNTED INSIDE CEILING SUSPENDED UNIT PER MANUFACTURER'S RECOMMENDATION. IONIZATION UNIT SHALL BE POWERED FROM ASSOCIATED UNIT.
- ⑤ OUTSIDE AIR IS SUPPLIED THROUGH OUTSIDE AIR UNIT DIRECTLY INTO SPACE.
- ⑥ ALL UNITS TO INCLUDE FACTORY START-UP.

VRF OUTDOOR EQUIPMENT SCHEDULE

MARK NO.	MODEL NO. DATA		CAPACITY				ELECTRICAL				NET WEIGHT (LBS.)	NOTES	
	MANUFACTURER (OR APPROVED EQUAL)	MODEL NO.	AHRI EER	AHRI IEER	AHRI COP	COOLING MBH	HEATING MBH	VOLTAGE	MCA (A)	MOCP (A)	REC. FUSE (A)		
HRU-1	MITSUBISHI	PURY-P96	11.5	23.8	4.14	(NON-DUCTED INDOOR UNIT)	96	108	208/230-3-60	40/37	60/50	40/40	576
HRU-1R	MITSUBISHI	PURY-P72	11.9	23.0	4.09	(NON-DUCTED INDOOR UNIT)	72	80	208/230-3-60	30/27	50/45	30/30	483
TOTAL							168	188					

- ① R-410A REFRIGERANT, VARIABLE REFRIGERANT VOLUME, HEAT RECOVERY.
- ② SYSTEM SHALL INCLUDE ONE BUILDING MASTER CONTROLLER (AF-200A). REFERENCE PLANS FOR LOCATION. BUILDING MASTER CONTROLLER SHALL BE TOUCH SCREEN WITH INTEGRAL BACNET GATEWAY FOR INTEGRATION TO BUILDING AUTOMATION SYSTEM.
- ③ SYSTEM SHALL INCLUDE ONE HVAC MAINTENANCE TOOL AND SOFTWARE ON PORTABLE DRIVE WHICH SHALL BE STORED IN CONTROL PANEL ENCLOSURE. CONTRACTOR SHALL DEMONSTRATE/TEST UTILIZING MAINTENANCE TOOL WITH ENGINEER.
- ④ MITSUBISHI CONTROL DRAWINGS WITH M-NET ADDRESSES LABELED SHALL BE LAMINATED AND INSTALLED AT MITSUBISHI CONTROL PANEL. DRAWINGS SHALL INCLUDE M-NET ADDRESS, UNIT MARK NUMBER, REFRIGERANT LINE LENGTHS, AND REFRIGERANT CHARGE (R-410A).
- ⑤ WITHIN THE BUILDING MASTER CONTROLLER, UNITS SHALL BE LABELED WITH UNIT MARK NUMBER TO MATCH PLANS AND ROOM NAME/ROOM NUMBER.
- ⑥ CONTRACTOR SHALL COMPLETE THE STARTUP DOCUMENTATION AS PER THE MANUFACTURER'S INSTRUCTIONS TO CERTIFY THE SYSTEM FOR THE EXTENDED 10-YEAR PARTS AND 10-YEAR COMPRESSOR WARRANTIES.
- ⑦ ALL UNITS SHALL BE INSTALLED ON DIVERSITech QUICKSLING NEXT GENERATION SUPER STAND VRF EQUIPMENT STAND (OR APPROVED EQUAL). EACH EQUIPMENT STAND FRAME SHALL BE SECURELY ANCHORED TO CONCRETE PAD IN ACCORDANCE WITH MANUFACTURER'S RECOMMENDATION, WIND LOAD REQUIREMENTS, AND AS PER PLANS/SPECIFICATIONS.
- ⑧ APPROXIMATE VRF OUTDOOR EQUIPMENT REFRIGERANT PIPING SIZE:
 - UNIT HRU-1: LIQUID PIPE (HIGH PRESSURE) 3/4" BRAZED AND GAS PIPE (LOW PRESSURE) 7/8" BRAZED.
 - UNIT HRU-1R: LIQUID PIPE (HIGH PRESSURE) 5/8" BRAZED AND GAS PIPE (LOW PRESSURE) 3/4" BRAZED.
- ⑨ VERIFY FINAL REFRIGERANT PIPING SIZE AND LENGTH WITH MANUFACTURER.
- ⑩ ALL UNITS SHALL BE ASHRAE 90.1-2013 COMPLIANT.
- ⑪ ALL UNITS TO INCLUDE FACTORY START-UP.

VRF INDOOR EQUIPMENT SCHEDULE (CEILING CASSETTE)

MARK NO.	NOMINAL FAN CFM	COOLING CAPACITY		HEATING CAPACITY		MODEL NO. DATA		ELECTRICAL			NET WEIGHT (LBS.)	ASSOCIATED OUTDOOR UNIT	NOTES
		TOTAL CAPACITY (MBH)	CONDENSER E.A.T.	EVAPORATOR E.W.B. TEMP.	HIGH TEMP 47° E.A.T. (MBH)	MANUFACTURER (OR APPROVED EQUAL)	MODEL NO.	VOLTAGE	MCA (A)	REC. FUSE (A)			
CS-3	305	6.0	95	80/67	6.7	MITSUBISHI	PMFY-P06	208/230-1-60	0.25	15	38	HRU-1	SEE BELOW
CS-4	315	8.0	95	80/67	9.0	MITSUBISHI	PLFY-P08	208/230-1-60	0.30	15	35	HRU-1	SEE BELOW
CS-5	280	5.0	95	80/67	5.6	MITSUBISHI	PLFY-P05	208/230-1-60	0.24	15	35	HRU-1	SEE BELOW
TOTAL		19.0			21.3								

- ① ALL UNITS TO INCLUDE INTERNAL FACTORY CONDENSATE PUMP.
- ② ALL UNITS TO INCLUDE WALL MOUNTED SMART ME CONTROLLER AND WALL MOUNTED REMOTE TEMPERATURE SENSOR.
- ③ REFRIGERANT R-410A.
- ④ CASSETTE UNIT CS-3 SHALL BE ONE-WAY CEILING CASSETTE UNIT.
- ⑤ CASSETTE UNIT CS-4 AND CS-5 SHALL BE 24"X24" TO MATCH STANDARD LAY-IN CEILING TILE GRID.
- ⑥ CASSETTE UNIT FRAME SHALL NOT IMPEDE ACCESS TO ADJACENT ITEMS SUCH AS CEILING LIGHTS, ETC.
- ⑦ ALL UNITS TO INCLUDE BICLIMATIC (OR APPROVED EQUAL) BI-POLAR IONIZATION UNIT MOUNTED INSIDE CEILING CASSETTE PER MANUFACTURER'S RECOMMENDATION. IONIZATION UNIT SHALL BE POWERED FROM ASSOCIATED UNIT.
- ⑧ OUTSIDE AIR IS SUPPLIED THROUGH DEHUMIDIFIER DIRECTLY INTO SPACE.
- ⑨ ALL UNITS TO INCLUDE FACTORY START-UP.

VRF INDOOR EQUIPMENT SCHEDULE (WALL MOUNT)

MARK NO.	NOMINAL FAN CFM	COOLING CAPACITY		HEATING CAPACITY		MODEL NO. DATA		ELECTRICAL			NET WEIGHT (LBS.)	ASSOCIATED OUTDOOR UNIT	NOTES
		TOTAL CAPACITY (MBH)	CONDENSER E.A.T.	EVAPORATOR E.W.B. TEMP.	HIGH TEMP 47° E.A.T. (MBH)	MANUFACTURER (OR APPROVED EQUAL)	MODEL NO.	VOLTAGE	MCA (A)	MOCP (A)			
WM-1	295	12.0	95	80/67	13.5	MITSUBISHI	PKFY-P12	208/230-1-60	0.24	15	25	HRU-1	SEE BELOW
WM-1R	295	12.0	95	80/67	13.5	MITSUBISHI	PKFY-P12	208/230-1-60	0.24	15	25	HRU-1R	SEE BELOW
TOTAL		24.0			27.0								

- ① ALL UNITS TO INCLUDE FACTORY CONDENSATE PUMP WITH LINE SET/CONDENSATE PUMP ENCLOSURE KIT. (CONDENSATE PUMP APPROVED EQUALS: LITTLE GIANT EC-1K AND ASPEN/AIRTEC MINI AND MAXI LINE)
- ② ALL UNITS TO INCLUDE WALL MOUNTED SMART ME CONTROLLER AND WALL MOUNTED REMOTE TEMPERATURE SENSOR.
- ③ REFRIGERANT R-410A.
- ④ ALL UNITS TO INCLUDE FACTORY START-UP.

VRF BRANCH CONTROLLER SCHEDULE

MARK NO.	MANUFACTURER (OR APPROVED EQUAL)	MODEL NUMBER	BRANCHES	VOLTAGE	MCA (A)	MOCP (A)	UNIT WEIGHT (LBS.)	ASSOCIATED OUTDOOR UNIT	NOTES
BC-1	MITSUBISHI	CMB-P108NU-JA1-BV	8	208/230-1-60	0.8/1.0	20	106	HRU-1	SEE BELOW
BC-1R	MITSUBISHI	CMB-P104NU-J1-BV	4	208/230-1-60	0.4/0.4	20	58	HRU-1R	SEE BELOW

- ① BRANCH CONTROLLER TO INCLUDE FACTORY CONDENSATE PUMP.
- ② FURNISH AND INSTALL FACTORY BALL VALVES ON ALL PORTS OF BRANCH CONTROLLER.
- ③ LABEL PORTS OF BRANCH CONTROLLER WITH MARK NUMBER TO MATCH CONNECTED UNIT.
- ④ BRANCH CONTROLLER TO INCLUDE FACTORY START-UP.

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TALLAPOOSA
CO E911
ADDITION TO
THE
TALLAPOOSA
COUNTY JAIL
FACILITY

DADEVILLE, AL

CONSTRUCTION
DOCUMENTS



Project Number: 25-1465
Date: 8 JANUARY 2026
Revisions:

Sheet Description

HVAC
SCHEDULES,
DETAILS, AND
VRF DIAGRAM

Sheet Number

M1.3

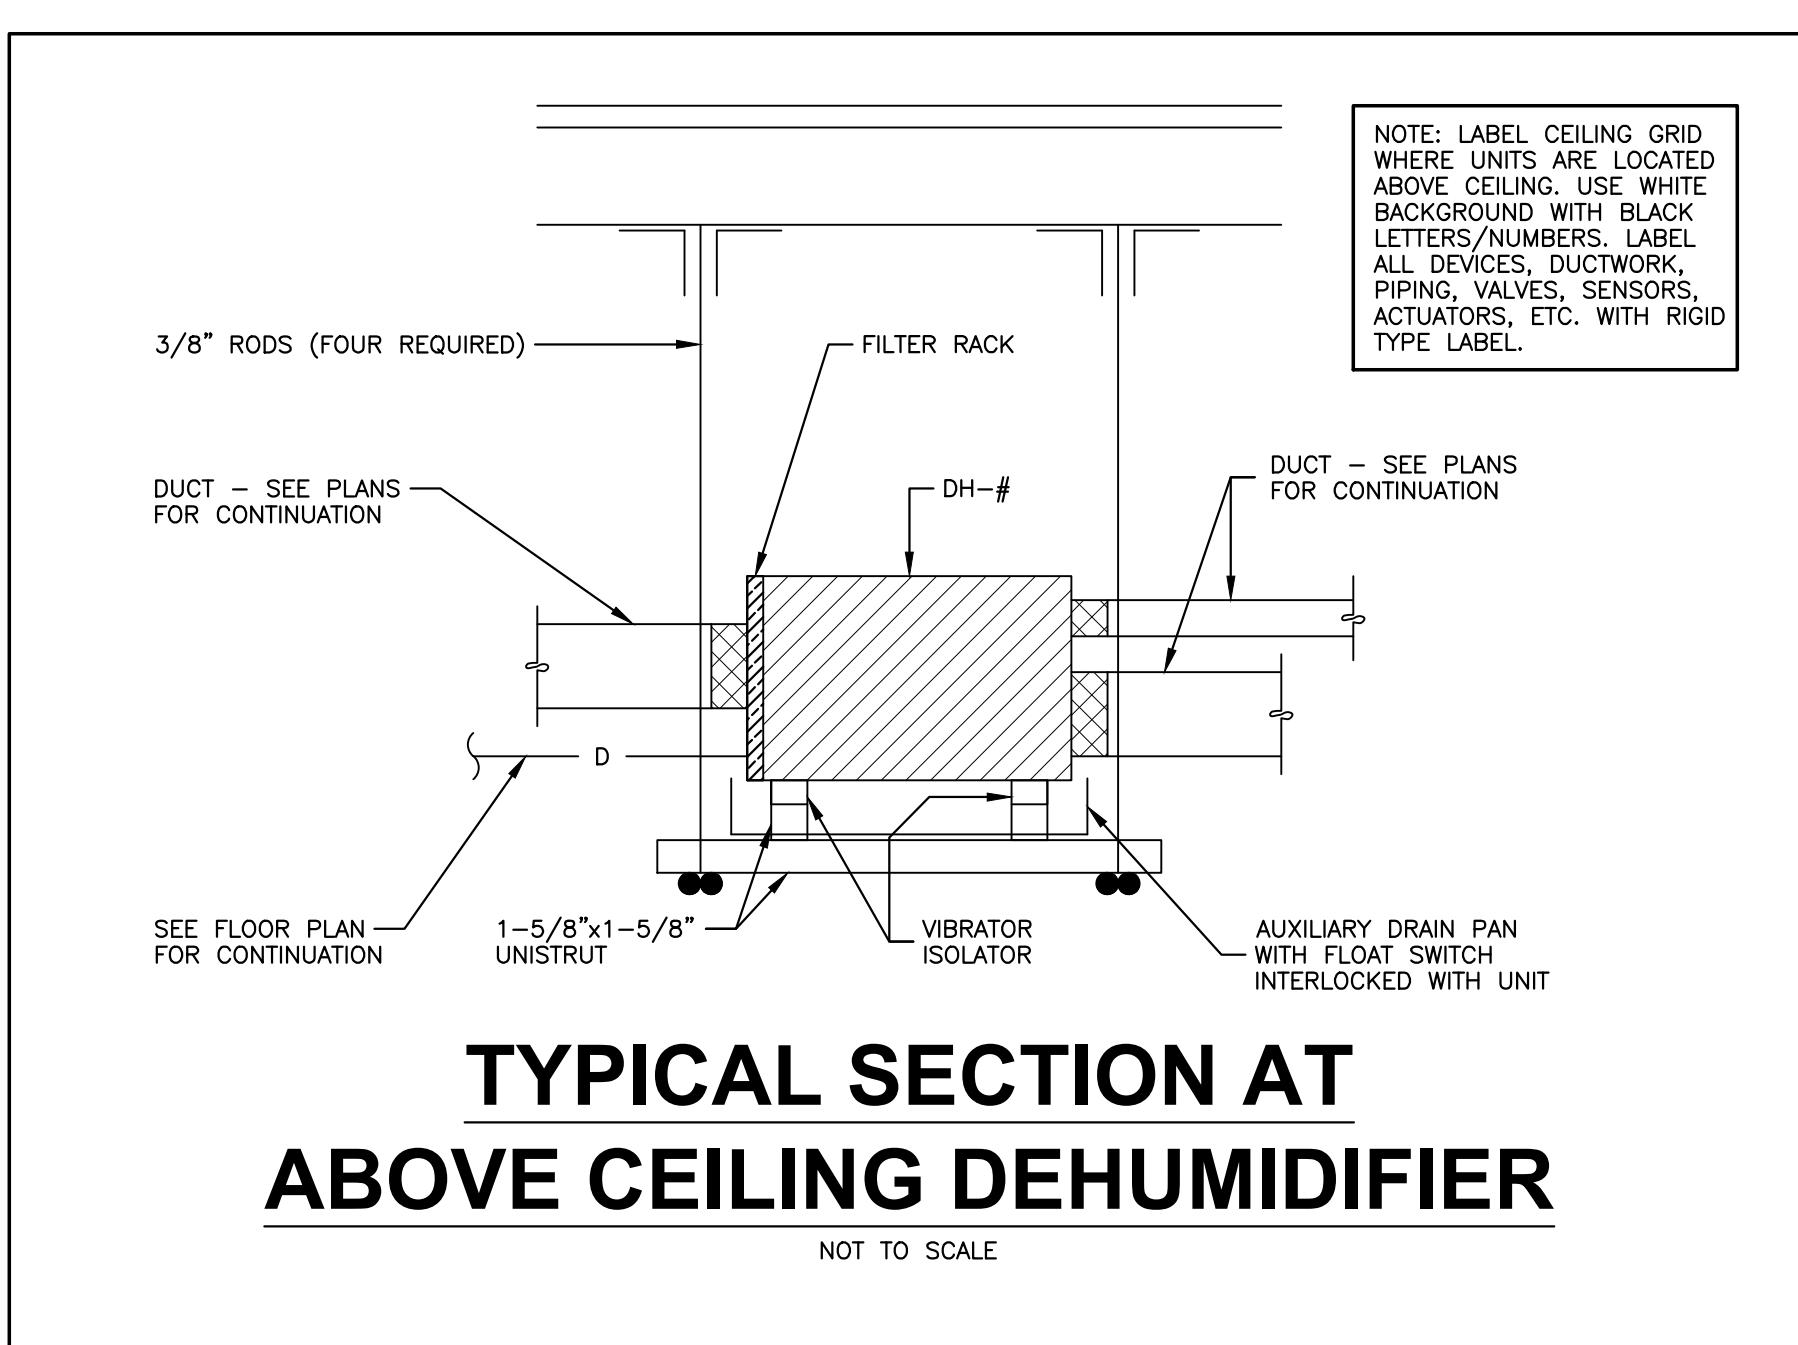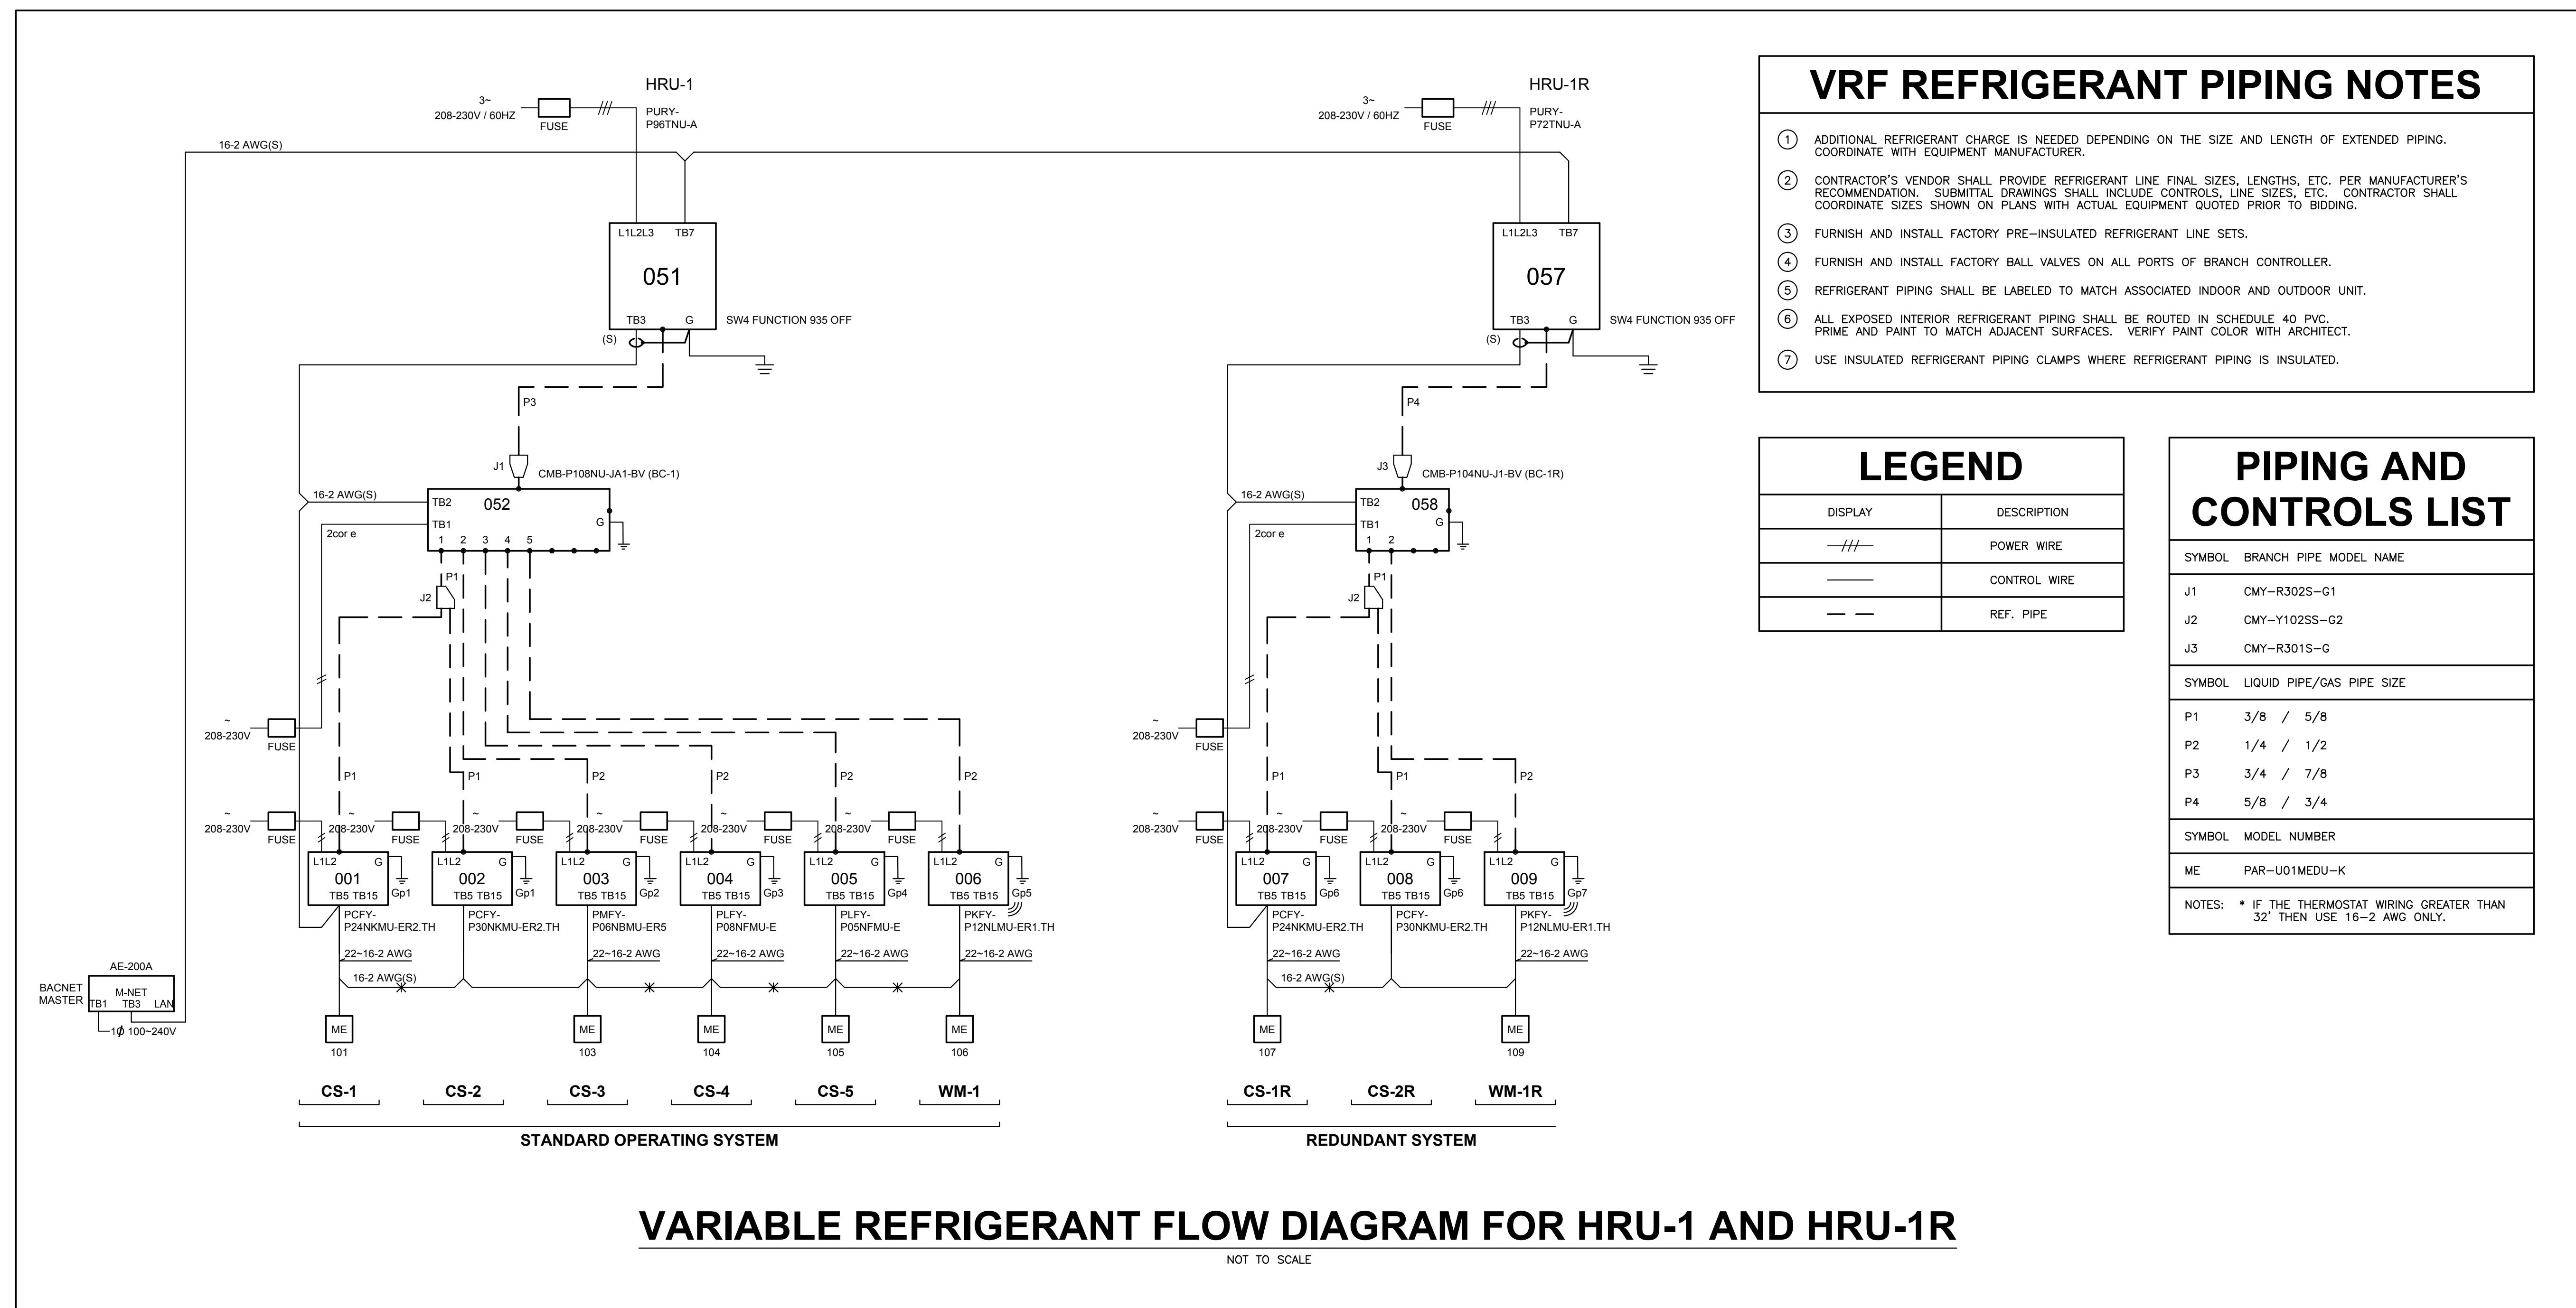


DEHUMIDIFIER EQUIPMENT SCHEDULE									
MARK NO.	NOMINAL FAN CFM	NOMINAL OSA CFM	REFRIGERANT	WATER REMOVAL 80°F 60% RH	OPERATING RANGE	ELECTRICAL		WEIGHT (LBS.)	NOTES
						POWER SUPPLY	AMPS		
DH-1	515	200	R-454B	205 PINTS/DAY	40°-104°F	115-1-60	12.5	THERMA-STOR	SANTA-FE ULTRA V205 148 SEE BELOW

① UNIT TO BE CONTROLLED WITH FACTORY MODEL DEH 3000 WALL MOUNTED HUMIDISTAT.
② UNIT TO INCLUDE FACTORY DUCT COLLARS (10").
③ UNIT TO INCLUDE FACTORY MERV-13 FILTER.
④ UNIT TO INCLUDE BIOPOLAR (OR APPROVED EQUAL) IONIZATION UNIT MOUNTED IN UNIT SUPPLY DUCT AND SHALL BE POWERED FROM ASSOCIATED DEHUMIDIFIER AND SHALL INCLUDE ALL NECESSARY TRANSFORMERS, INTERLOCK, ETC.
⑤ UNIT TO INCLUDE FACTORY CONDENSATE PUMP KIT.

**HVAC SCHEDULES,
DETAILS, AND VRF DIAGRAM**

WHORTON ENGINEERING, INC.
HVAC - PLUMBING - PROCESS CONTROL
Ranbar Whorton
DATE 01-08-2026
PHONE: (256) 820-9897
25 SUMMERMALL GATE ROAD
ANNISTON, ALABAMA 36205

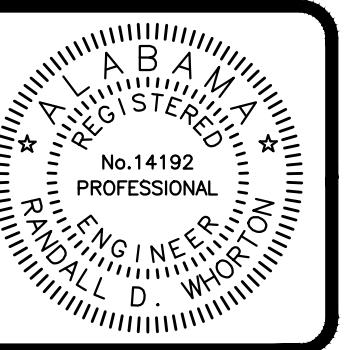

WHORTON ENGINEERING PROJECT NO. 25144

TALLAPOOSA CO E911 ADDITION TO THE TALLAPOOSA COUNTY JAIL FACILITY
DADEVILLE, AL


CONSTRUCTION DOCUMENTS

Project Number: 25-1465
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Revisions:

Sheet Description
HVAC DETAILS AND COMPLIANCE CALCULATIONS

Sheet Number

M2.1

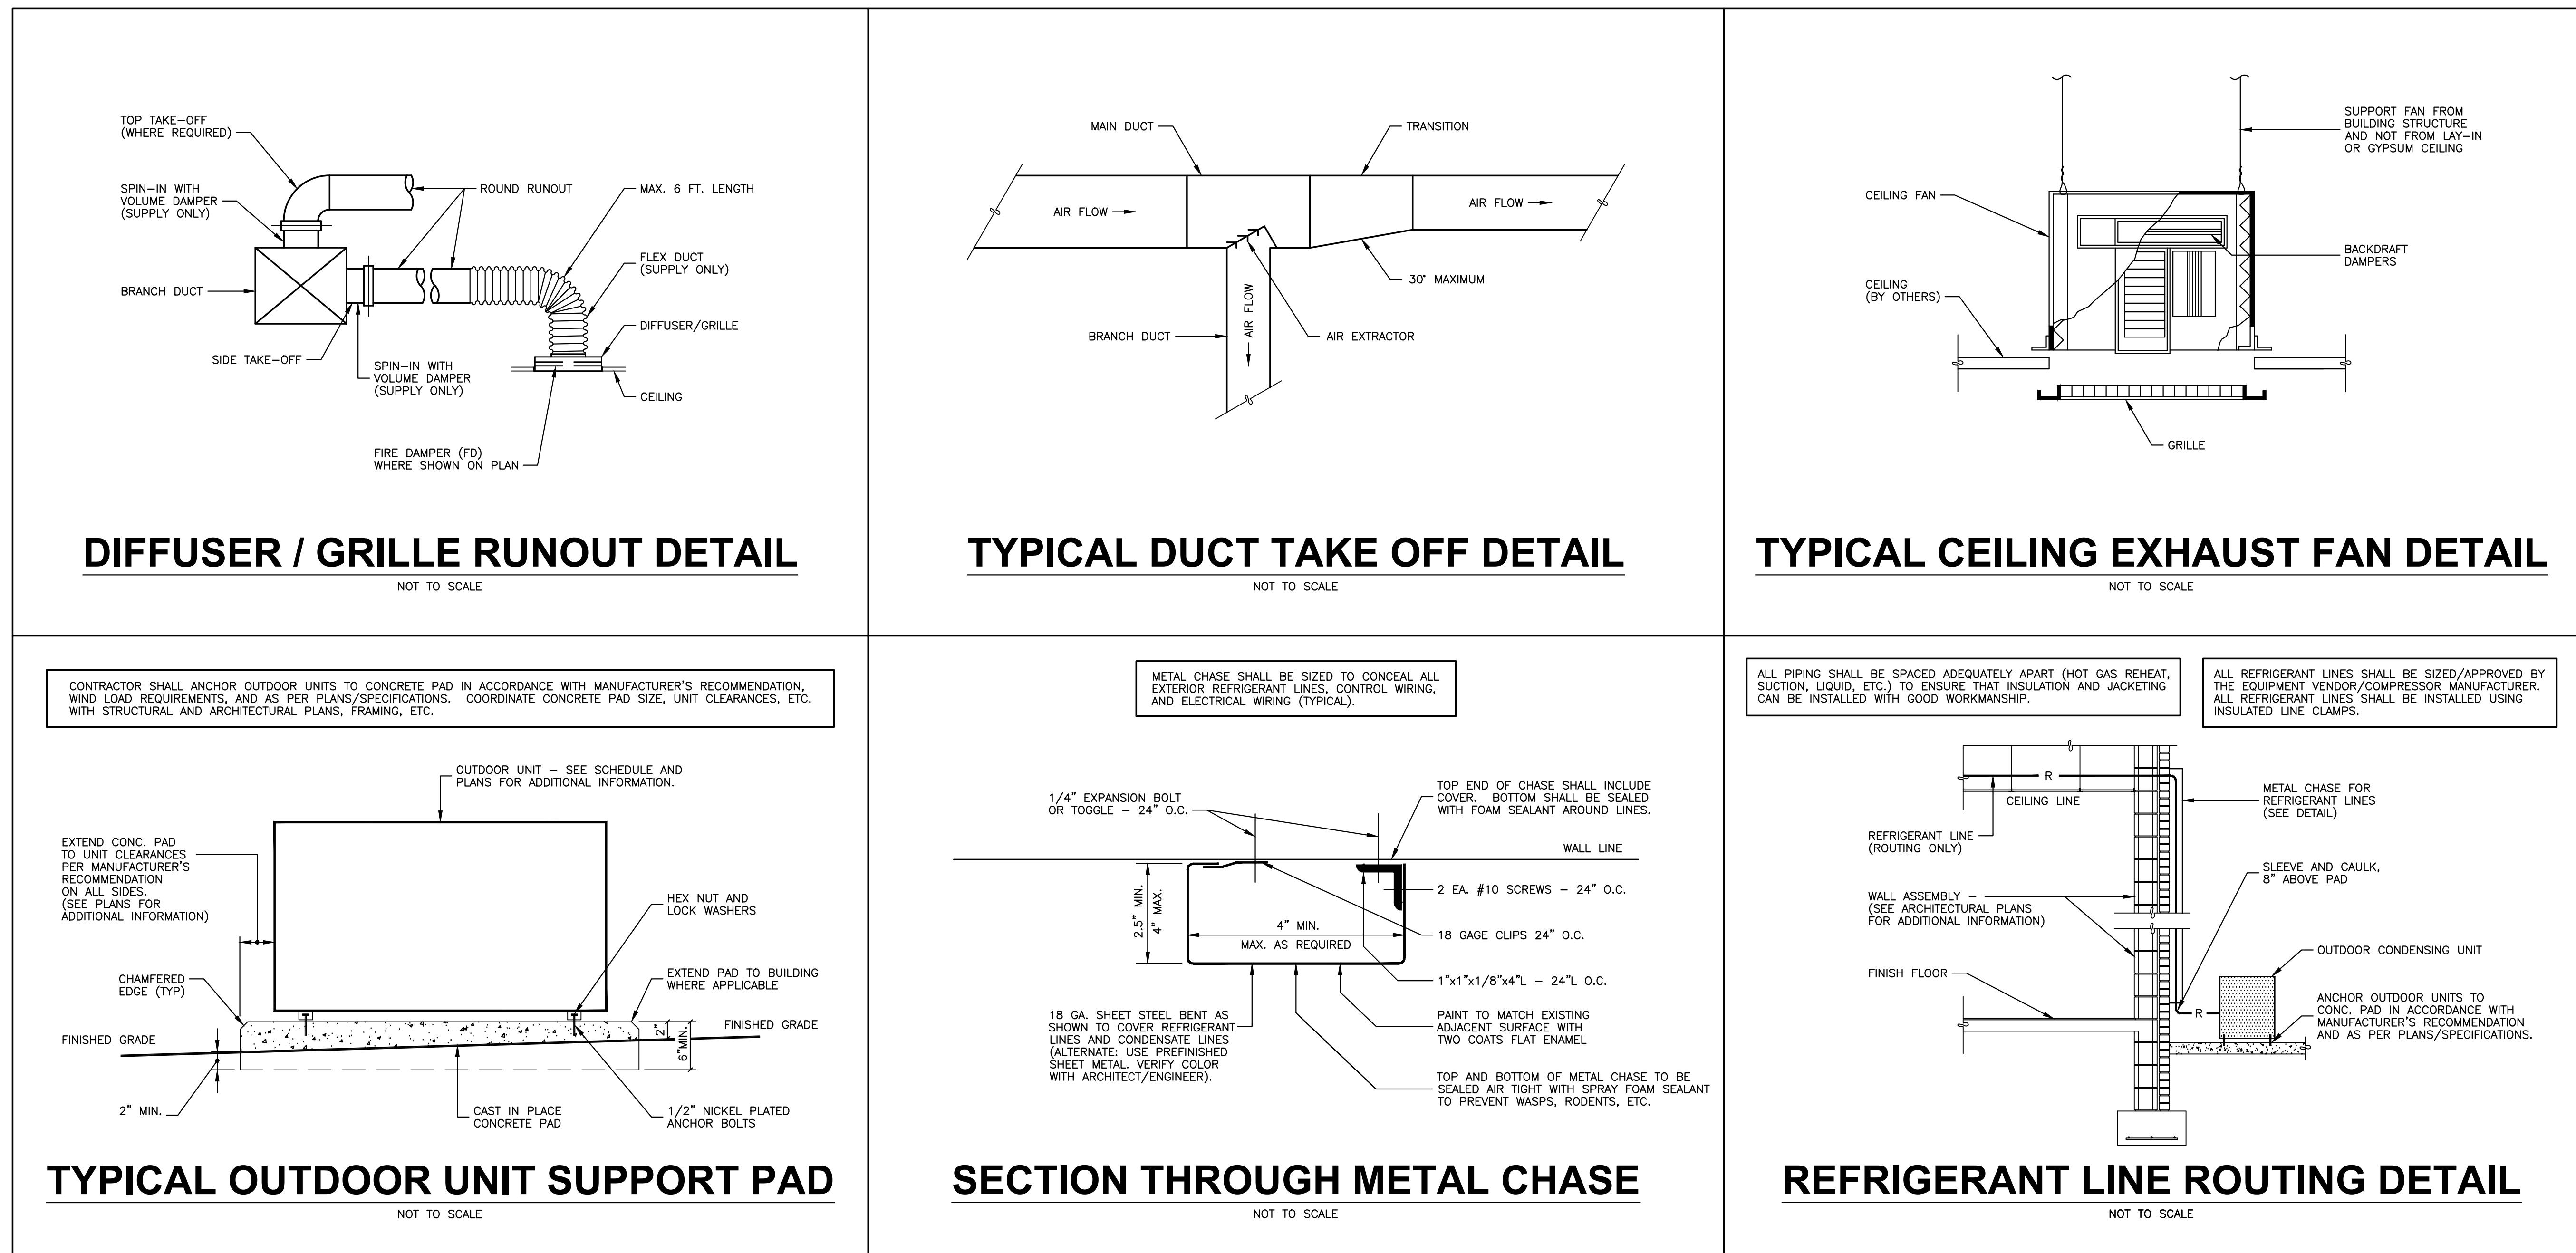

TALLAPOOSA CO E911 - DADEVILLE, AL IMC TABLE 403.3 COMPLIANCE CALCULATIONS																	
ROOM NAME	AREA (SF)	PEOPLE (QTY)	OUTDOOR AIR CALCULATIONS			EZ	VOZ CFM	VPZ CFM	ZP VOZ/VPZ	EV	VOT	DESIGN CFM	EXHAUST AIR				UNIT
			PEOPLE (CFM/PERSON)	AREA (CFM/SF)	TOTAL (VOU)								CFM/SF	FIXTURES	UNIT	REQUIRED CFM	DESIGN CFM
CALL CENTER	887	4	5.0	0.06	73	1	73	320	0.23								DH-1
KITCHEN	152	3	5.0	0.06	24	1	24	100	0.24								DH-1
SUPV OFFICE	100	1	5.0	0.06	11	1	11	75	0.15								DH-1
TOTAL (DH-1)	1,139				108					0.91	119	200					DH-1
TOILET/LOCKER	112												1/1	50/75	125	125	EF-1

HVAC DETAILS AND COMPLIANCE CALCULATIONS

WHORTON ENGINEERING, INC.

HVAC - PLUMBING - PROCESS CONTROL

Randall Whorton


DATE 01-08-2026

RANDALL WHORTON, P.E.
PHONE: (256) 820-9897

25 SUMMERALL GATE ROAD
ANNISTON, ALABAMA 36205

WHORTON ENGINEERING PROJECT NO. 25144



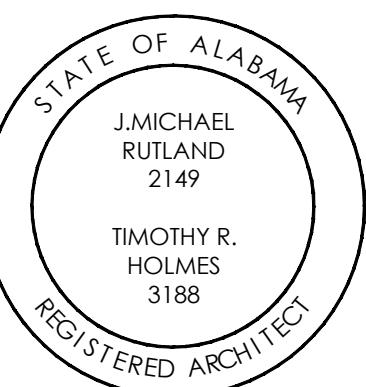

TALLAPOOSA CO E911 ADDITION TO THE TALLAPOOSA COUNTY JAIL FACILITY
DADEVILLE, AL

CONSTRUCTION DOCUMENTS

Project Number: 25-1465

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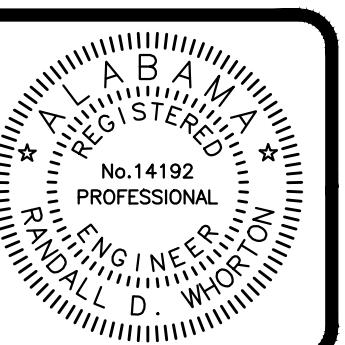
HVAC DETAILS

Sheet Number

M2.2


WHORTON ENGINEERING, INC.

HVAC - PLUMBING - PROCESS CONTROL

Randal Whorton
PHONE: (256) 820-9897DATE 01-08-2026
25 SUMMERMILL GATE ROAD
ANNISTON, ALABAMA 36205


WHORTON ENGINEERING PROJECT NO. 25144

29 OF 40

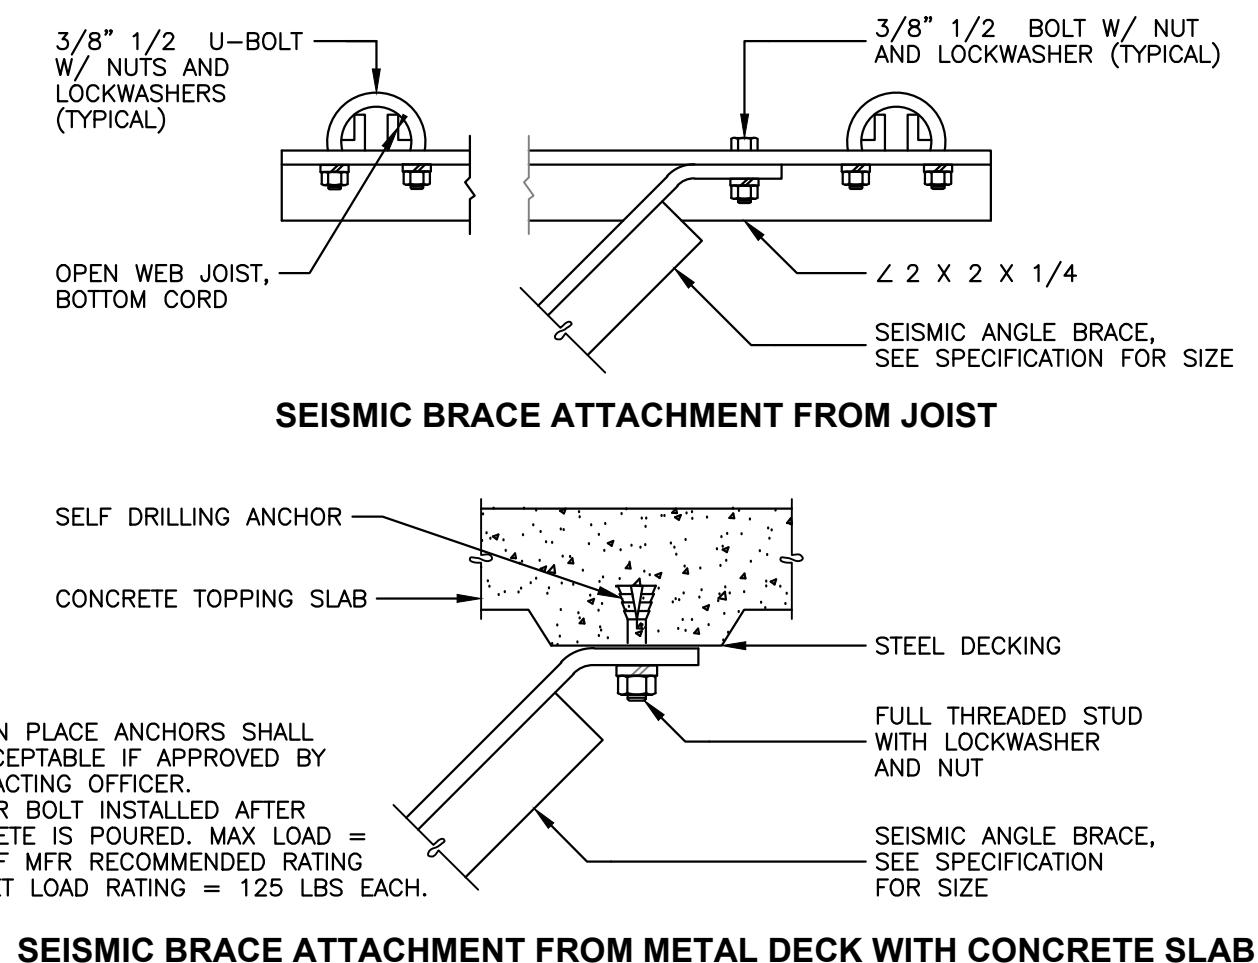


TYP. SEISMIC ANGLE BRACING DETAIL

NOT TO SCALE

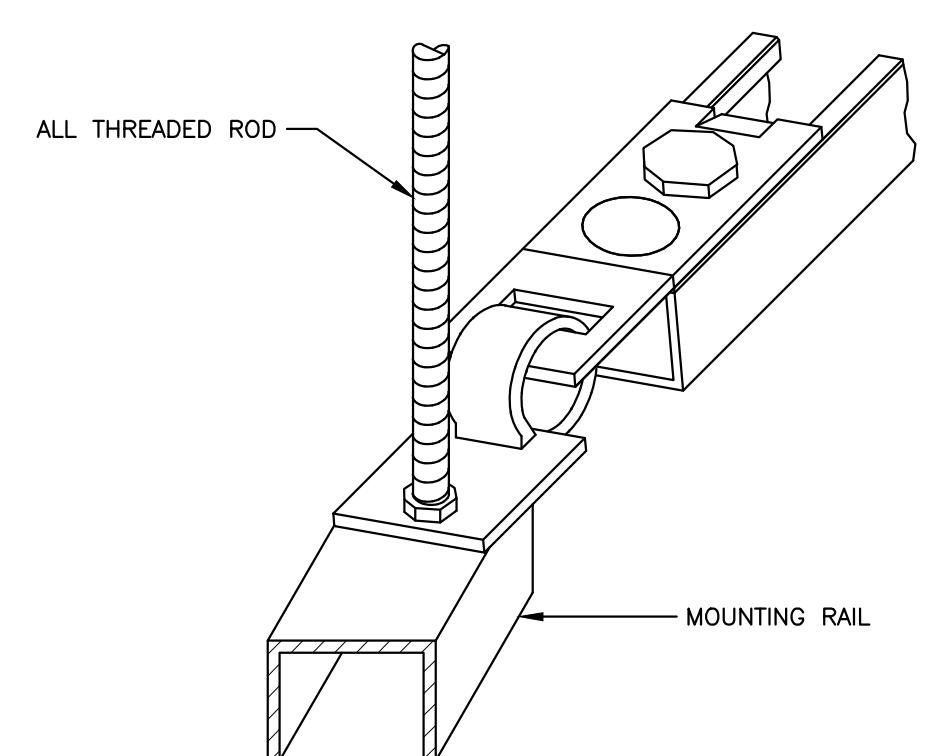


TYPICAL SEISMIC BRACE DETAIL

NOT TO SCALE

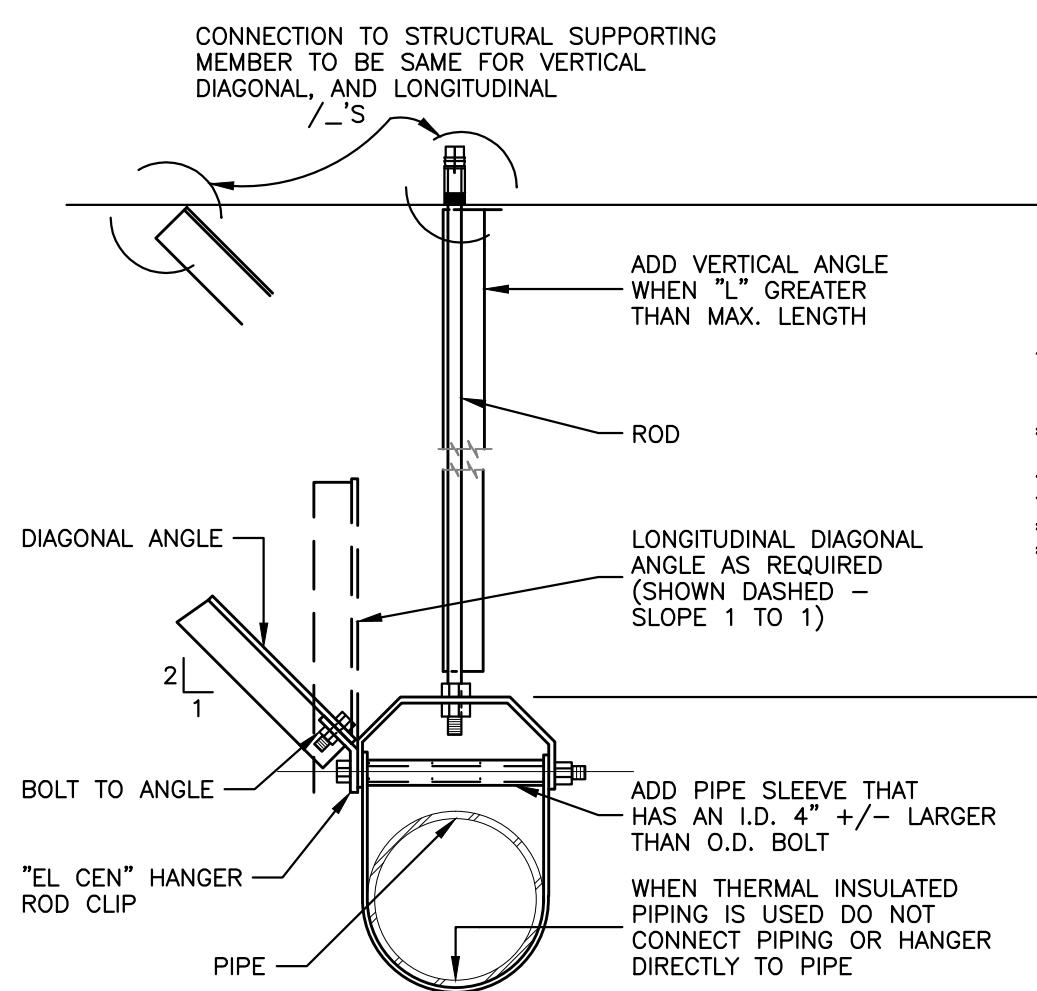

TYPICAL SEISMIC BRACING DETAIL


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TYPICAL LOUVER DETAIL

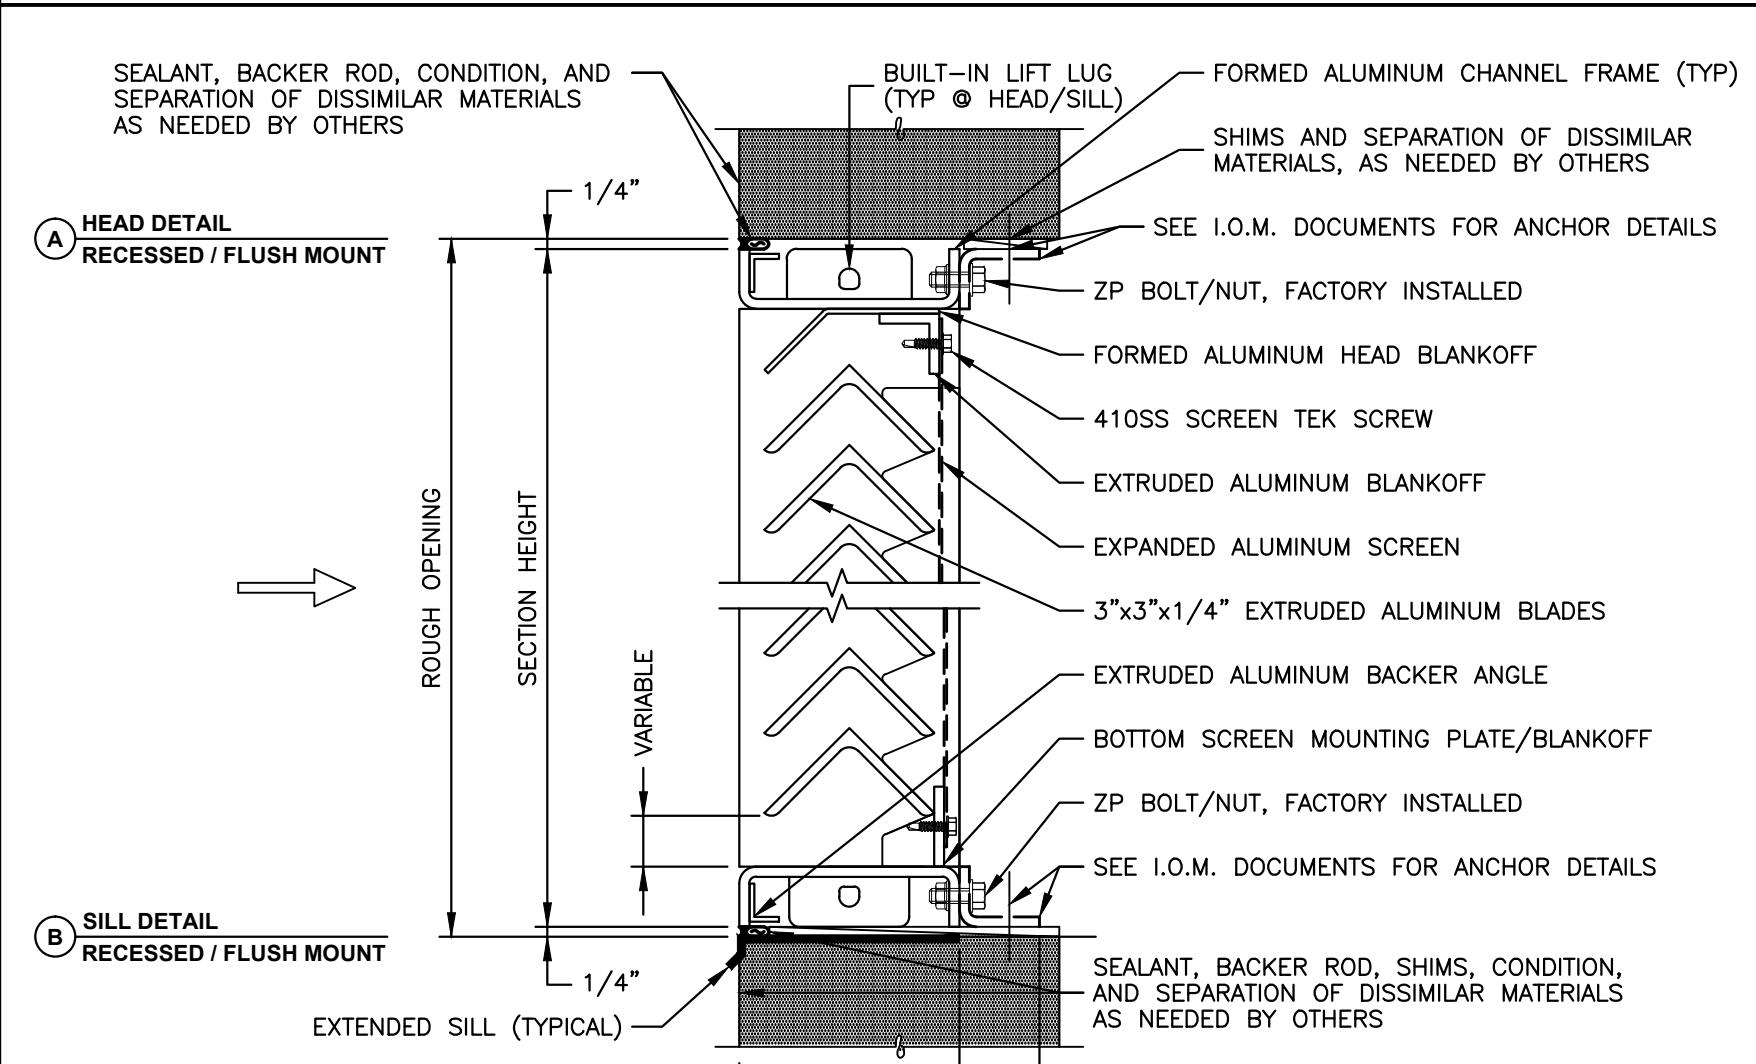
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SEE HVAC PLAN (SHEET M3.1) FOR SLEEVE LOCATIONS AND ADDITIONAL INFORMATION.




TYPICAL WALL SLEEVE DETAIL FOR REFRIGERANT LINES

NOT TO SCALE

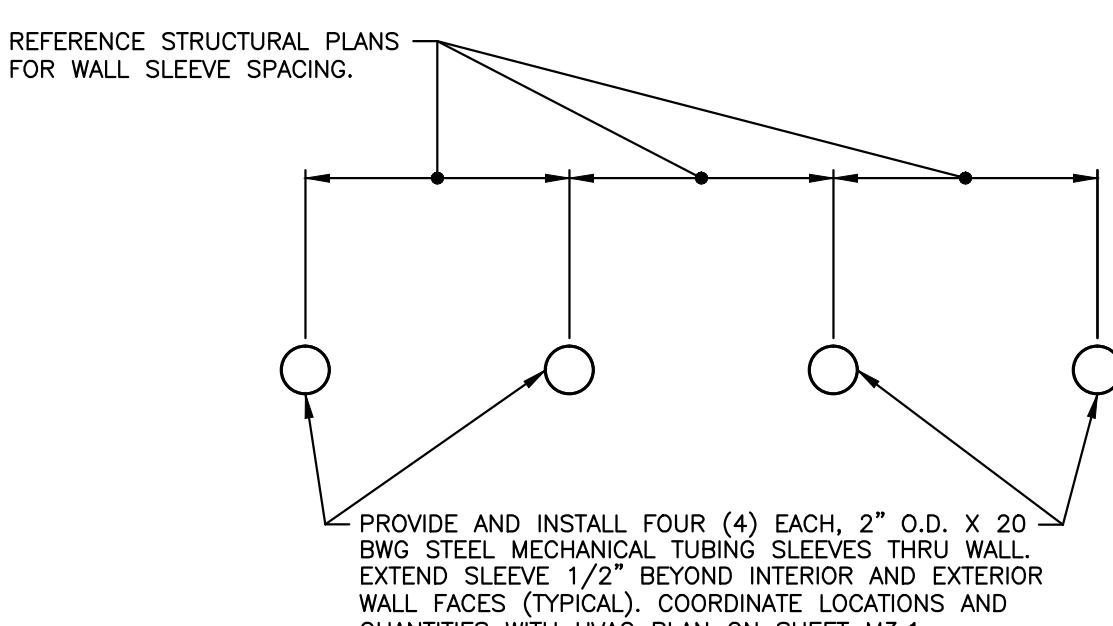

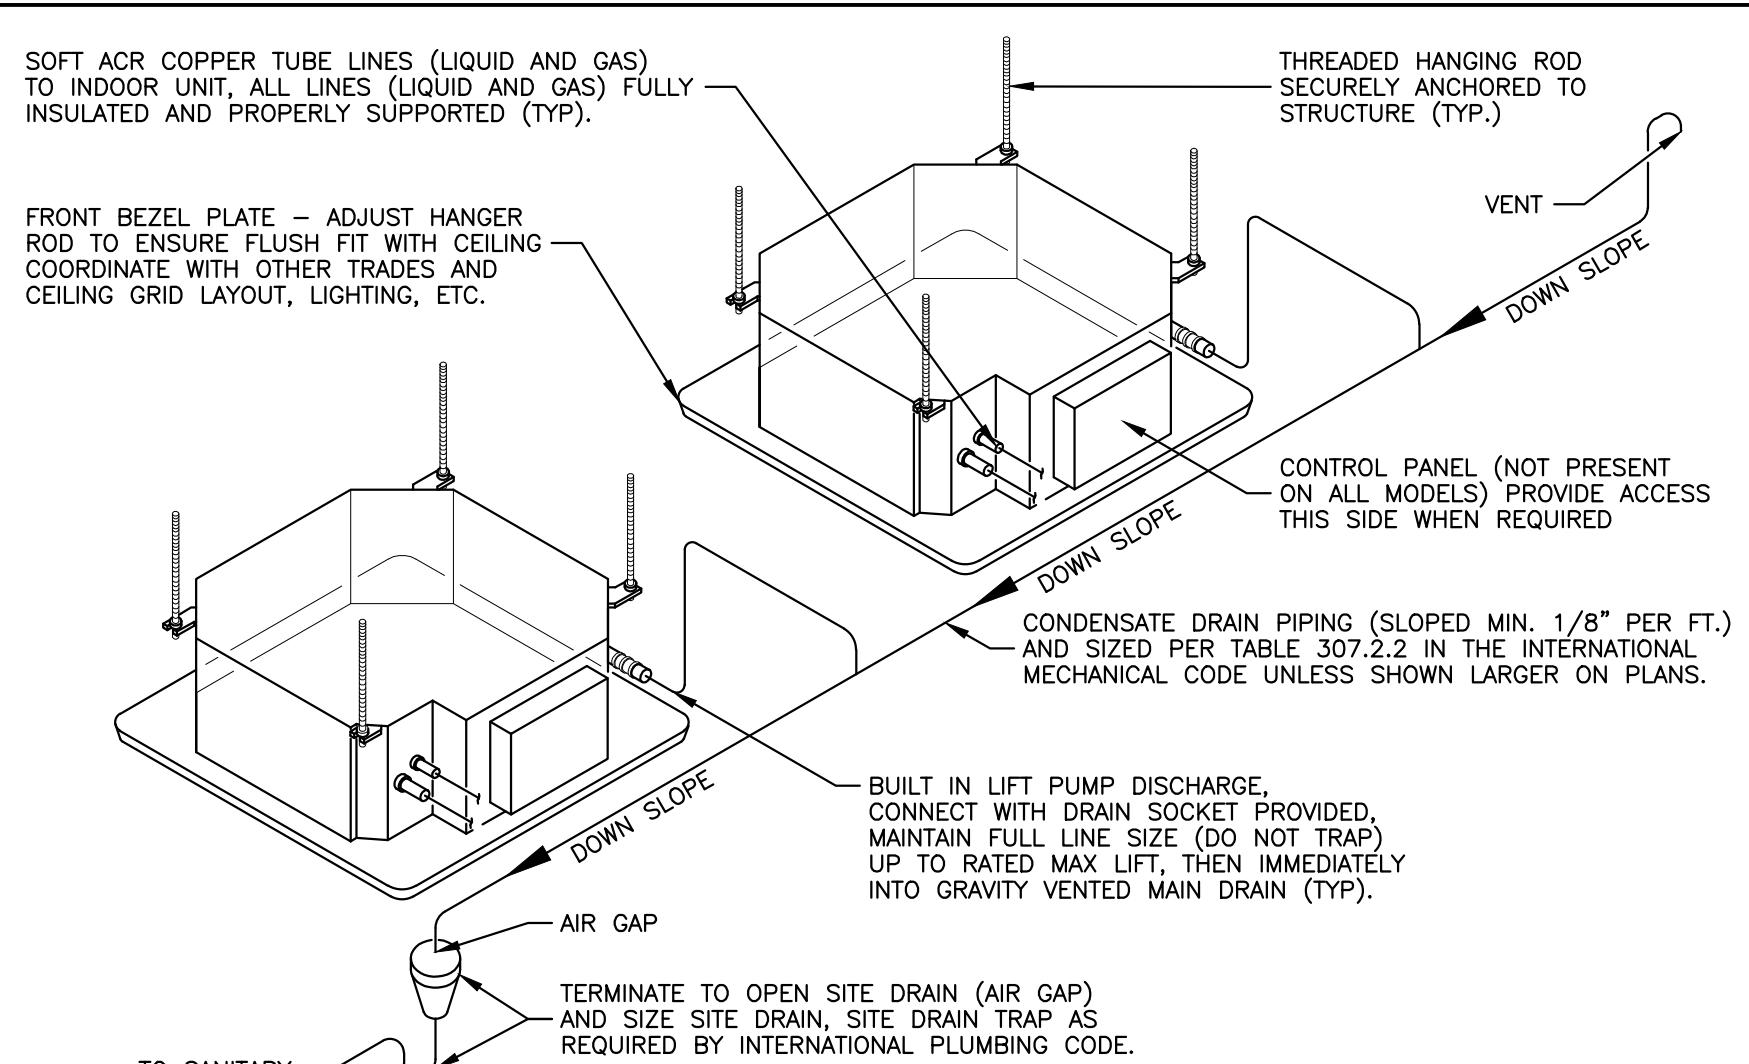
CEILING CASSETTE CONDENSATE DETAIL

NOT TO SCALE

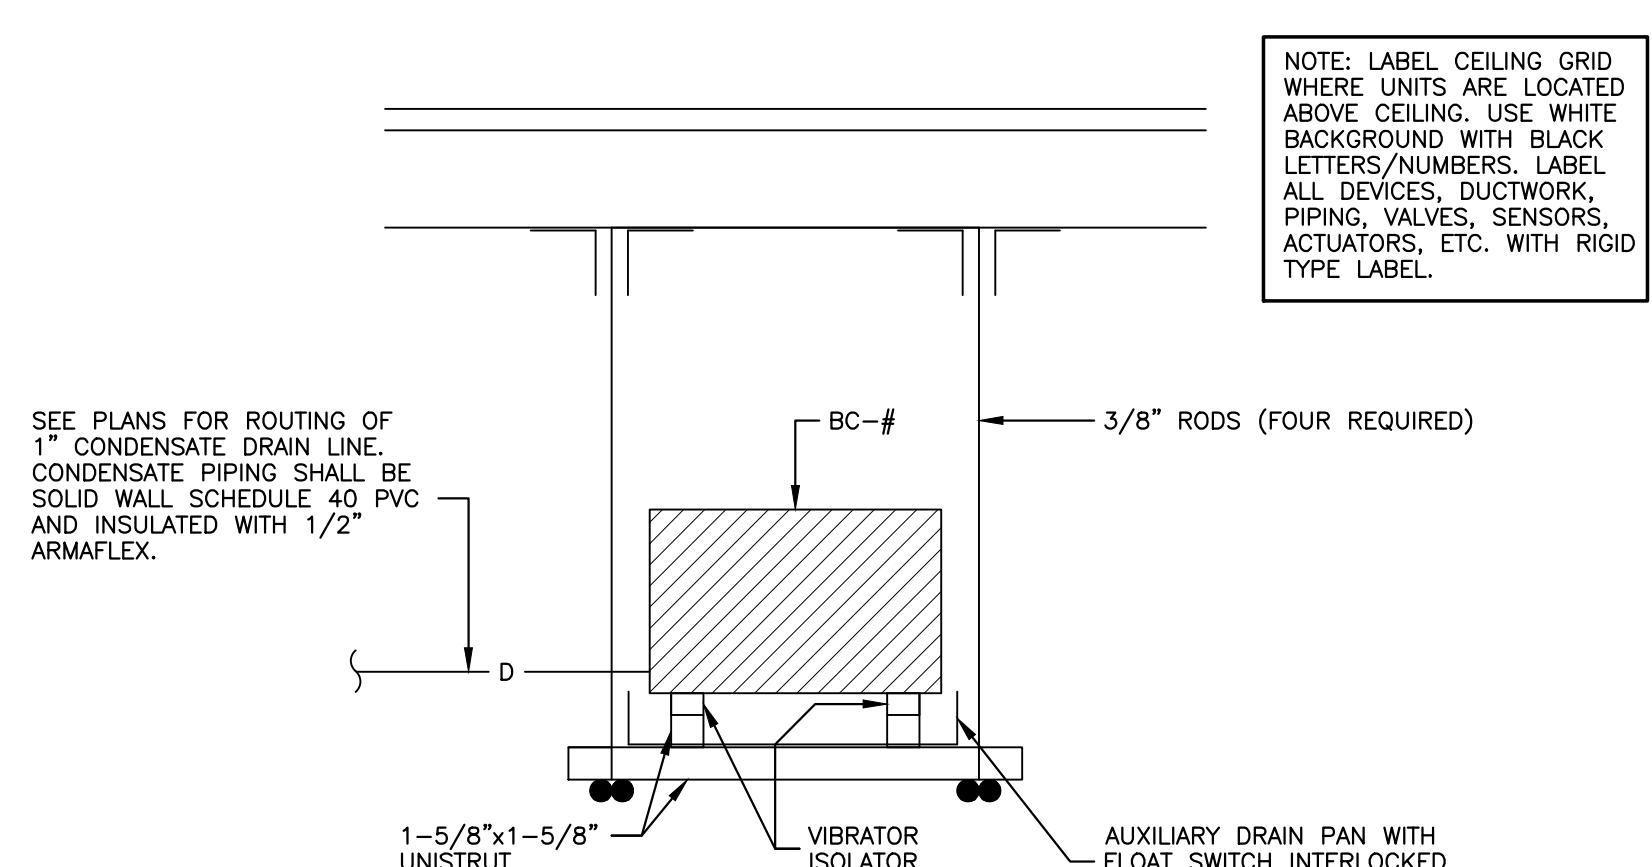

TYPICAL SECTION AT BRANCH CONTROLLER

NOT TO SCALE

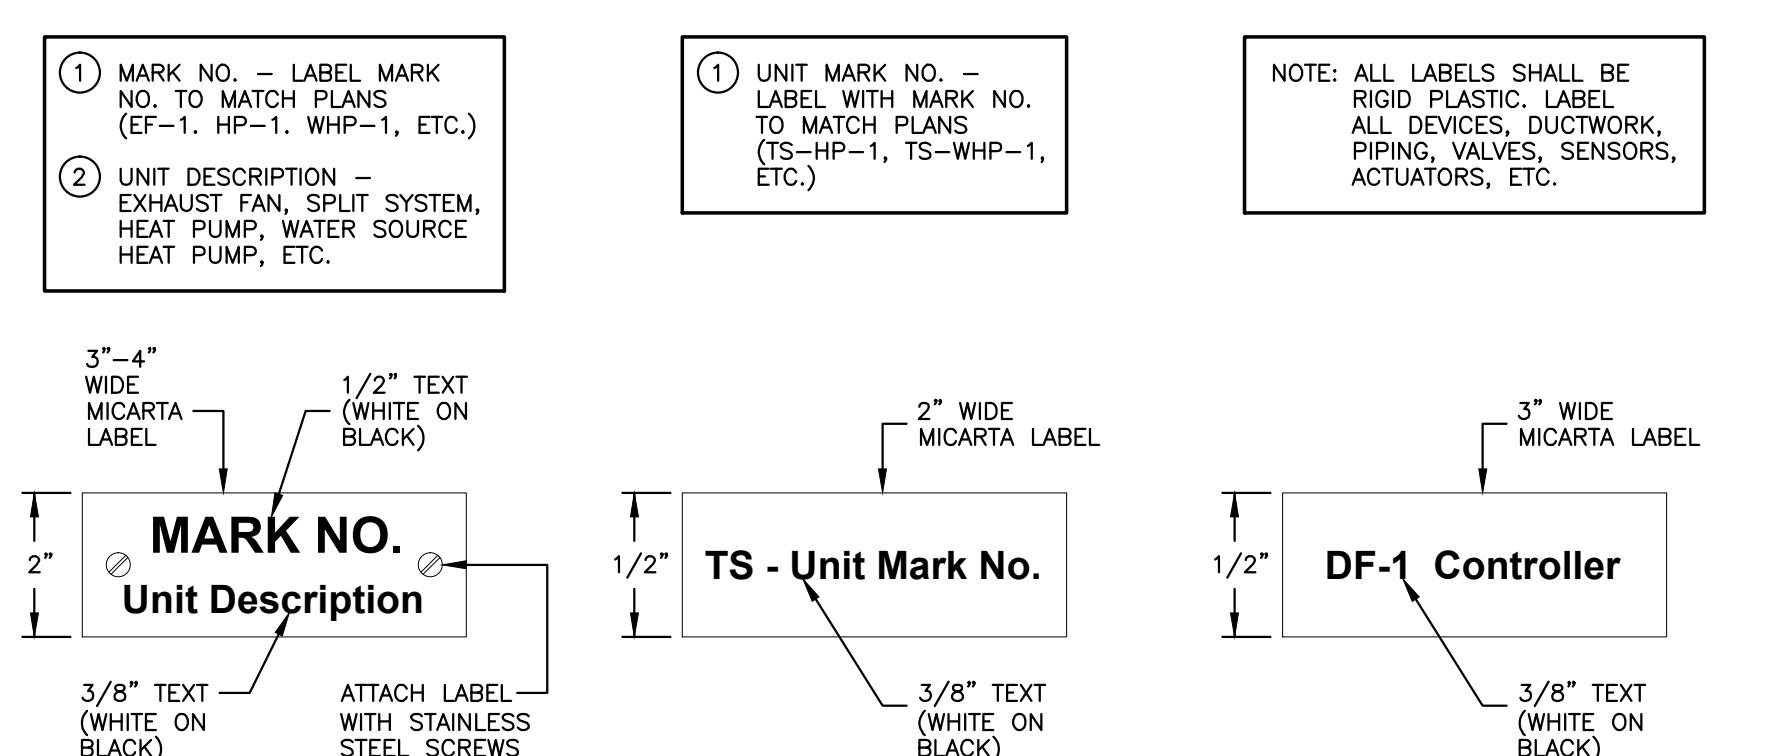

TYPICAL HVAC EQUIPMENT LABEL DETAIL


TYPICAL TEMP. SENSOR / THERMOSTAT LABEL DETAIL

TYPICAL FAN CONTROLLER LABEL DETAIL

HVAC EQUIPMENT LABELING DETAILS

NOT TO SCALE

HVAC DETAILS

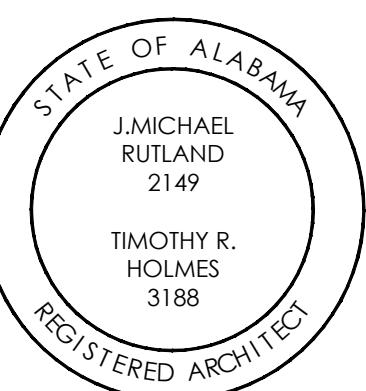

TALLAPOOSA
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DADEVILLE, AL

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DOCUMENTS



Project Number: 25-1465
Date: 8 JANUARY 2026
Revisions:

Sheet Description

HVAC PLANS

Sheet Number

M3.1

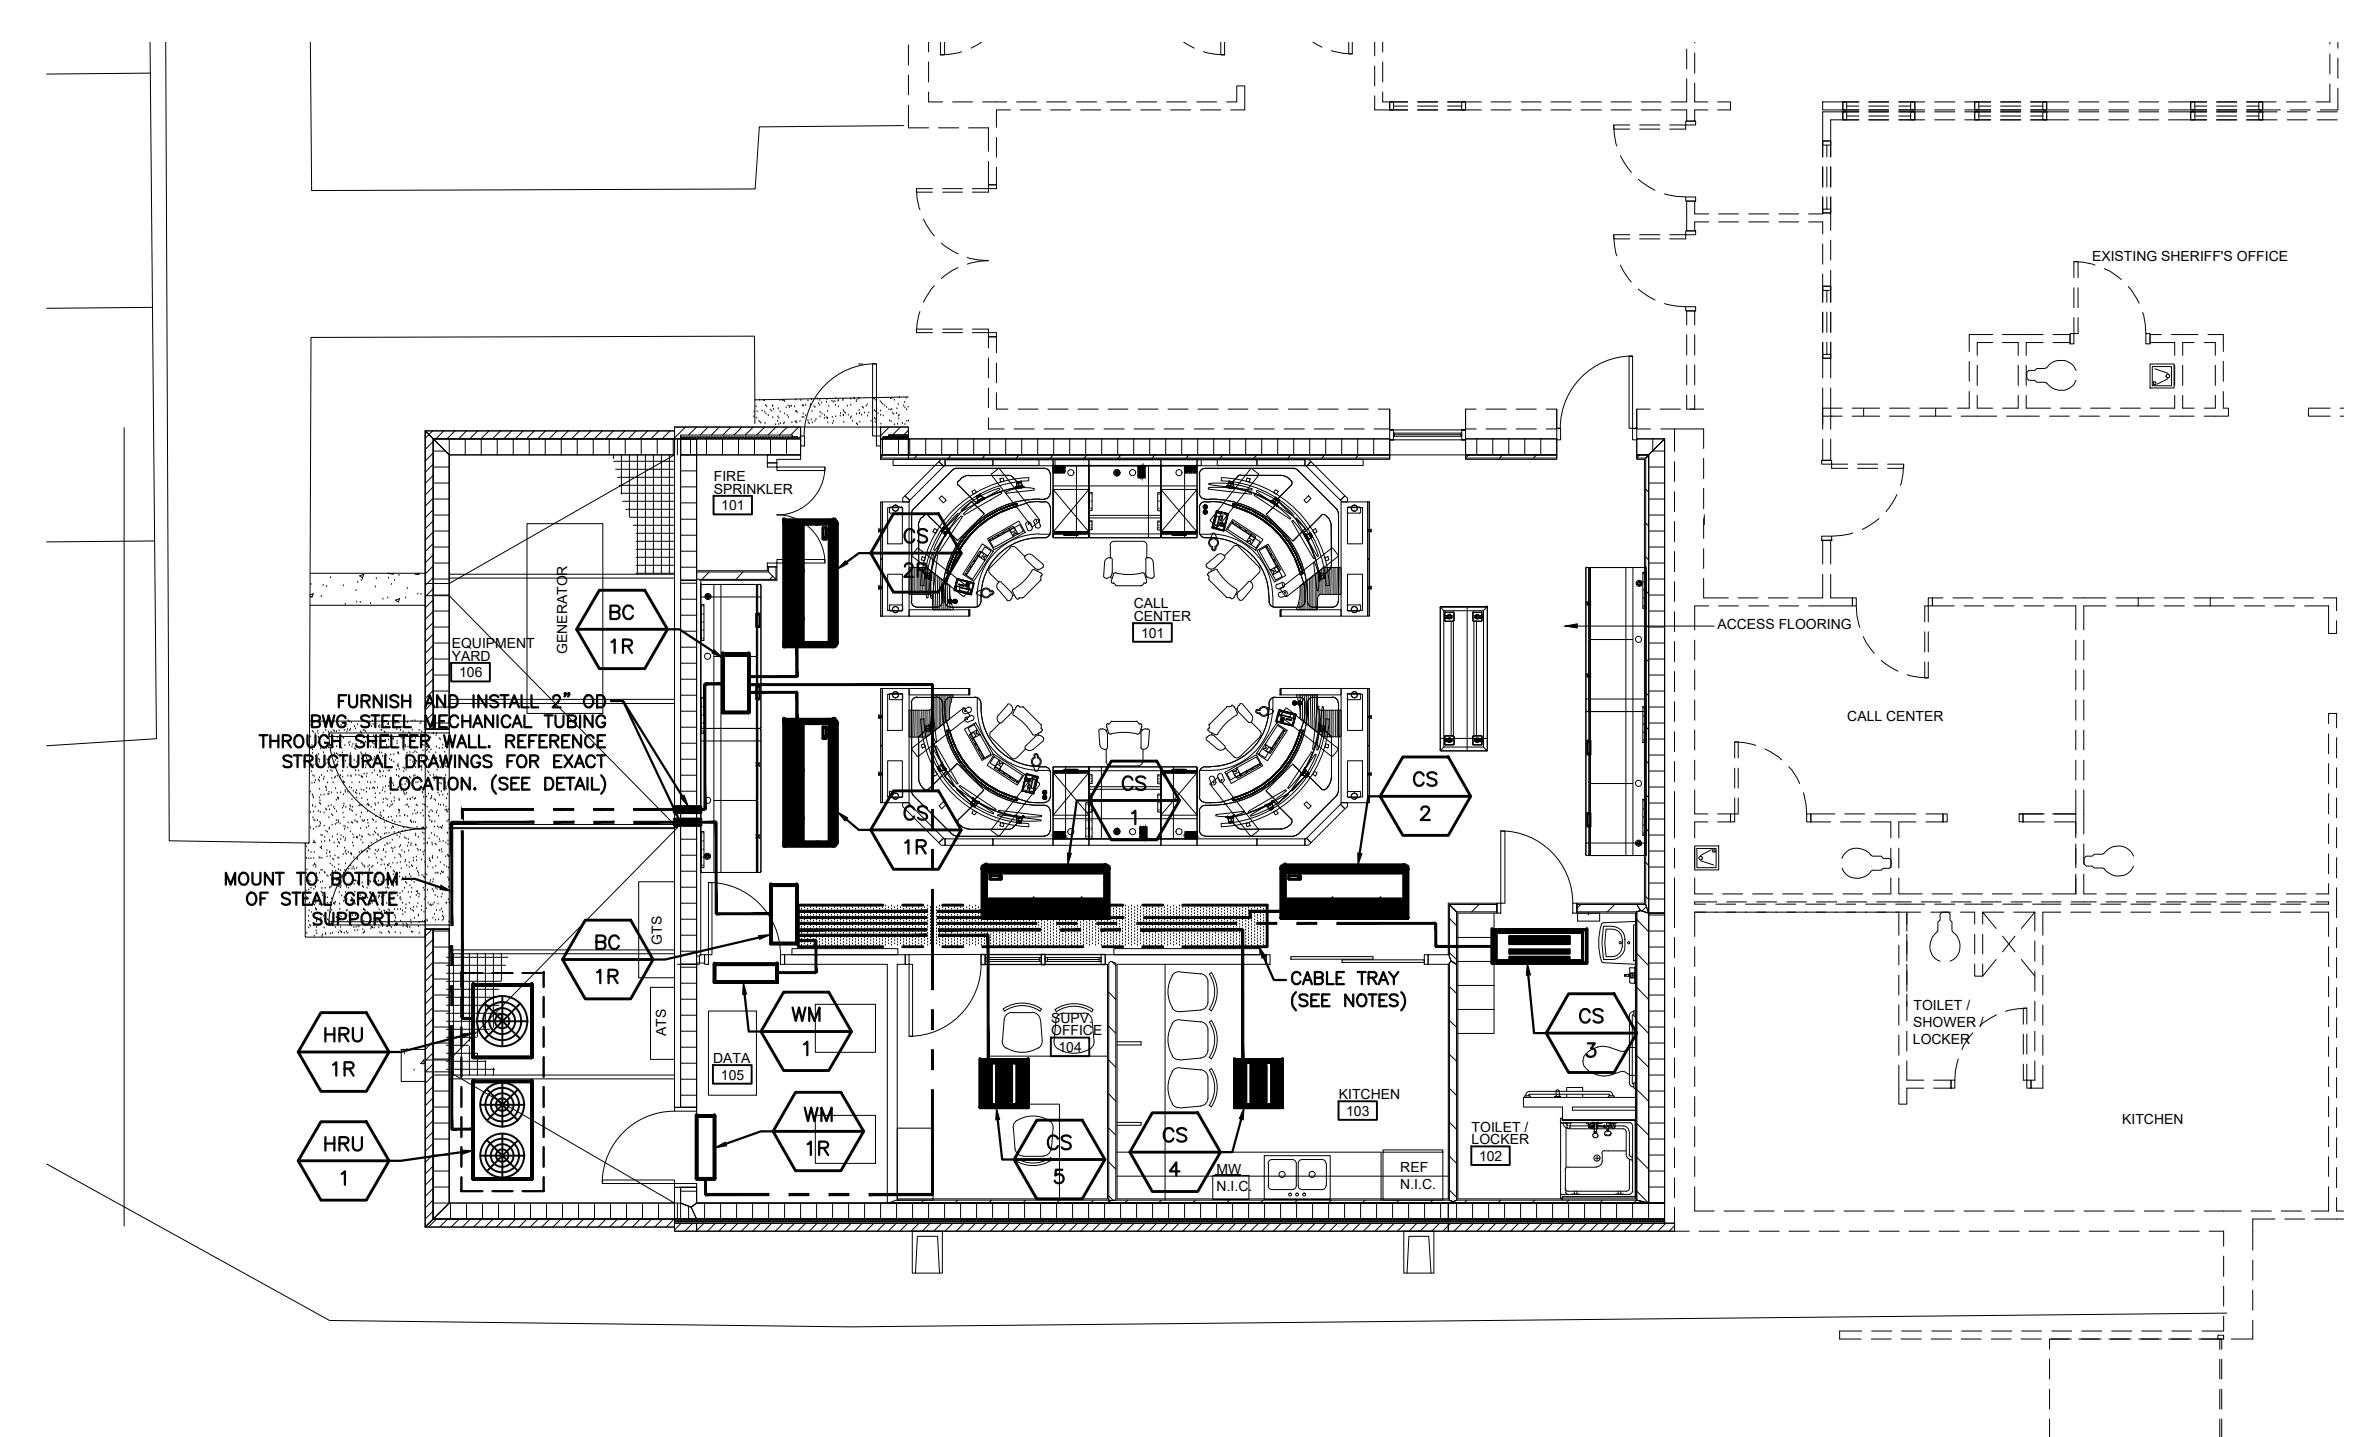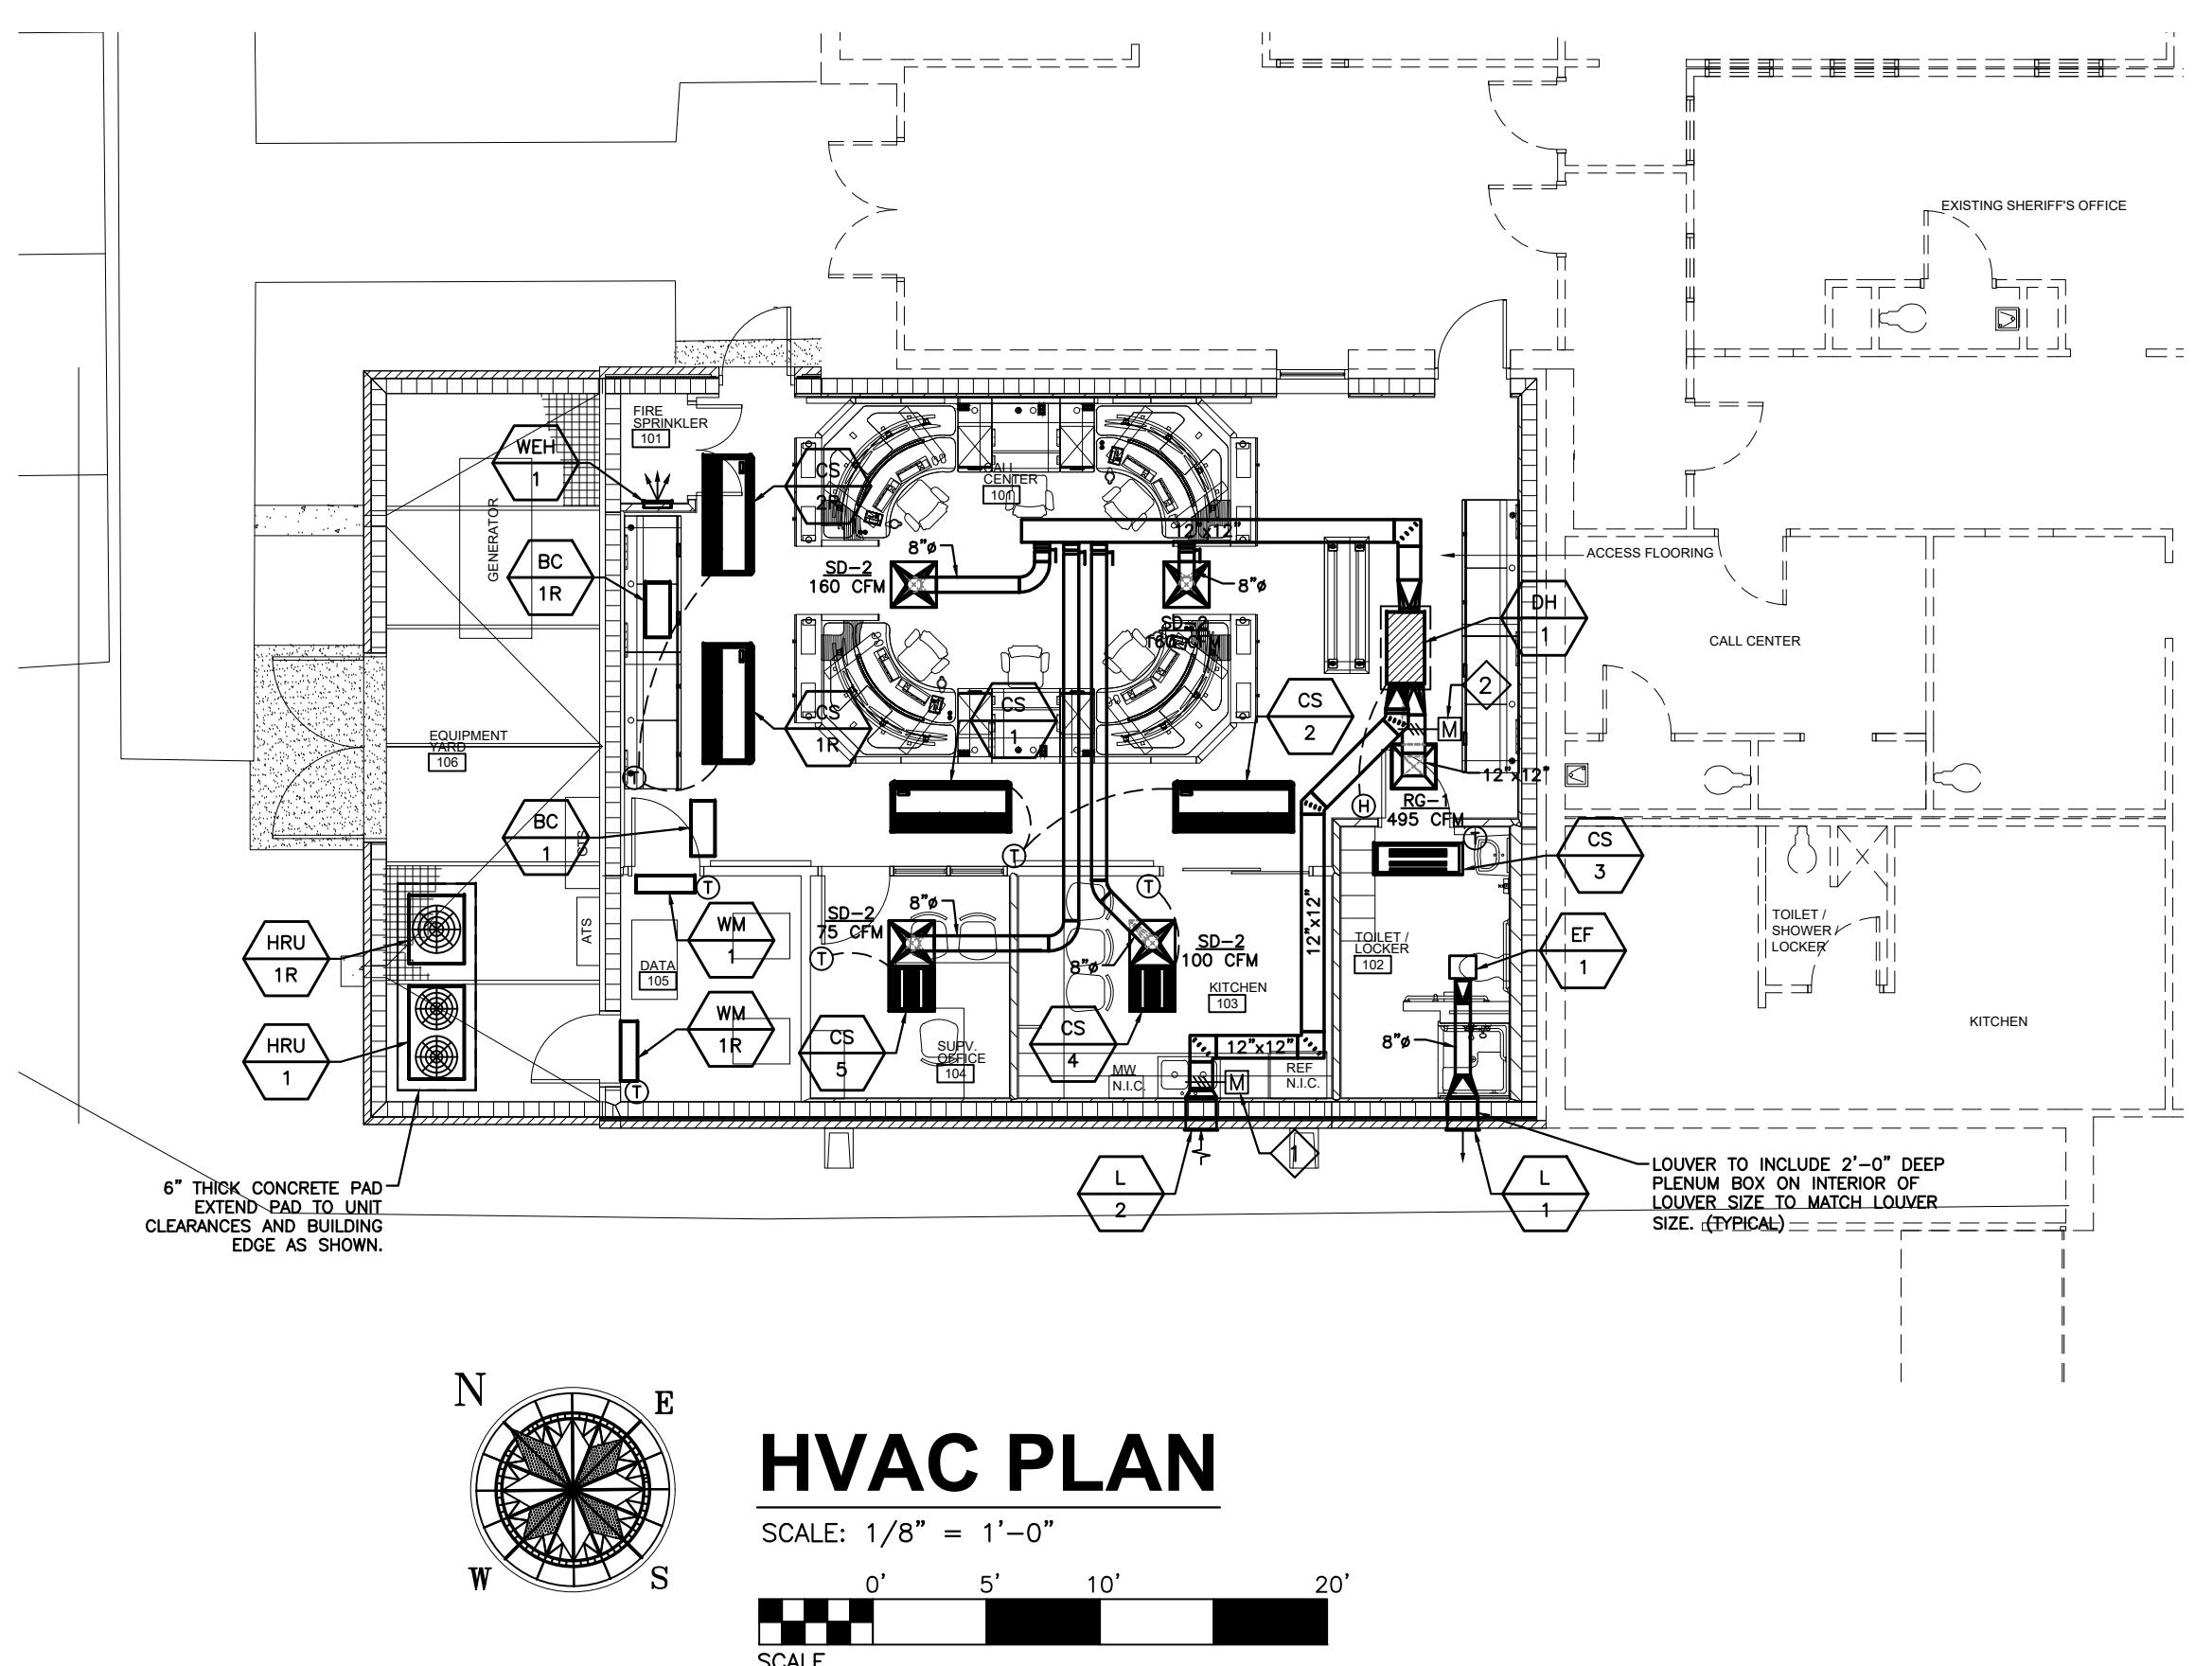


HVAC PLANS

DIFFUSER SCHEDULE							
Tag	Size	Neck Size	Quantity	Manufacturer	Model Number	Type	Notes
RG-1	24"X24"	23X23	1	TITUS	8RF	RETURN	20"X20"X1" FILTER
SD-2	24"X24"	8"Ø	4	TITUS	TDC	SUPPLY	
			5				

NOTE: FURNISH AND INSTALL AN INSULATION BLANKET ON THE BACK OF ALL CEILING MOUNTED DIFFUSERS AND GRILLES.

HVAC SHEET NOTES	
①	OUTSIDE AIR DAMPERS SHALL BE 120V. NORMALLY CLOSED AND INTERLOCKED TO OPEN WHEN THE ROOM LIGHTS ARE "ON".
②	UNIT RETURN AIR MOTORIZED DAMPER SHALL BE 120V. NORMALLY OPEN AND SHALL PARTIALLY CLOSE WHEN THE ROOM LIGHTS ARE "ON".

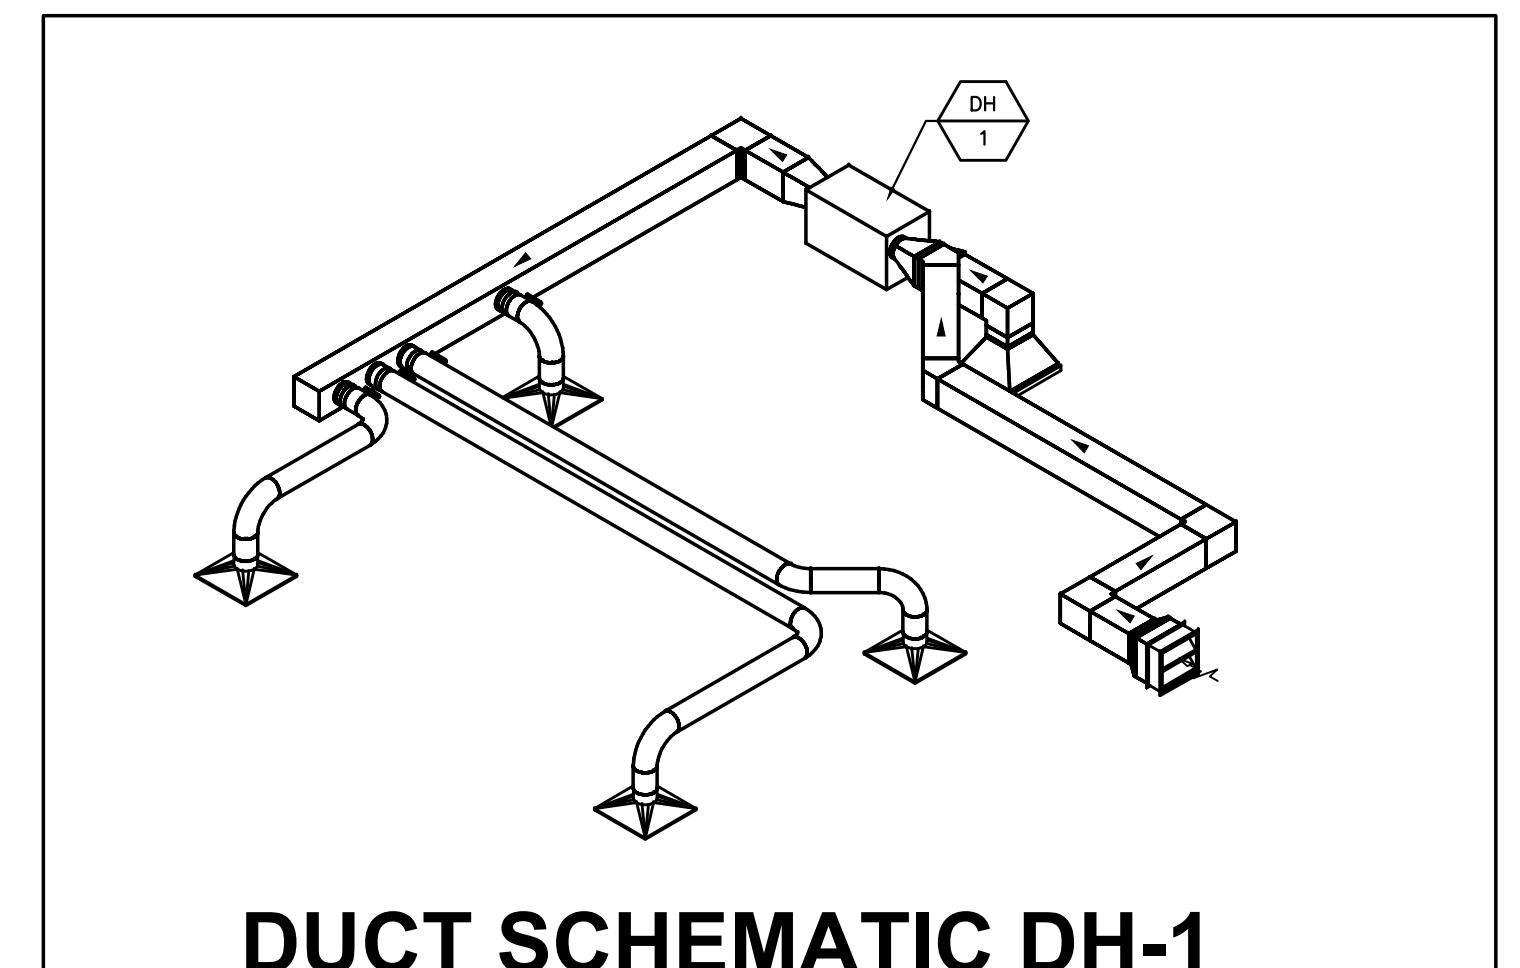

REFRIGERANT LINE NOTES

1. WIRE TRAY SHALL BE 18"X6". TRAY SHALL BE INSTALLED PER MANUFACTURER'S RECOMMENDATION.
2. ROUTING SHOWN ON PLAN HAS BEEN COORDINATED WITH CEILINGS. CONTRACTOR SHALL FULLY COORDINATE FINAL ROUTING WITH CEILINGS AND OTHER CONTRACTORS. VERIFY FINAL ROUTING WITH ARCHITECT/MECHANICAL ENGINEER PRIOR TO INSTALLATION.
3. INSULATION FOR LINE SETS SHALL BE PRE-INSULATED SOFT COPPER AND INCLUDE BOTH LIQUID AND GAS IN A SINGLE LINE SET WITH ISOLATION BETWEEN GAS AND LIQUID LINES.
4. REFRIGERANT LINES SHALL BE LABELED WITH BC NUMBER, BC PORT, AND INDOOR UNIT DESTINATION ON EACH LINE SET. LABELS SHALL BE INSTALLED EVERY 10 FT. FOR BOTH HORIZONTAL AND VERTICAL RUNS. LABELS MAY BE AS SHOWN ON TYPICAL LABEL DETAIL AND ATTACHED TO LINE SET WITH BLACK CABLE.

REFERENCE PLUMBING PLANS FOR CONDENSATE PIPING

WORTON ENGINEERING, INC.


HVAC - PLUMBING - PROCESS CONTROL


Randall Whorton

DATE 01-08-2026

RANDALL D. WORTON
PHONE: (256) 820-9897


25 SUMMERMILL GATE ROAD
ANNISTON, ALABAMA 36205

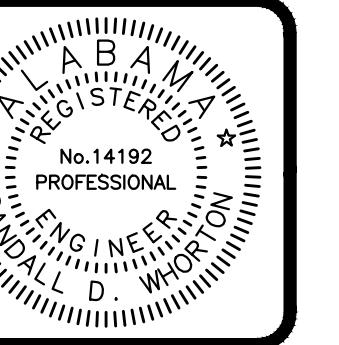

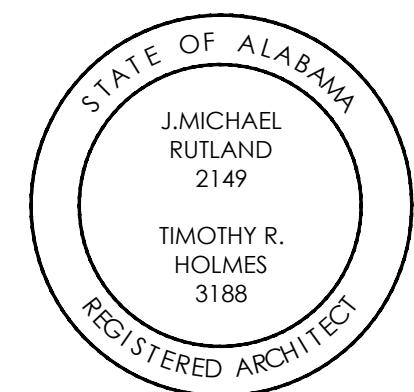


TALLAPOOSA CO E911 ADDITION TO THE TALLAPOOSA COUNTY JAIL FACILITY
DADEVILLE, AL

FIRE SERVICE RISER DIAGRAM

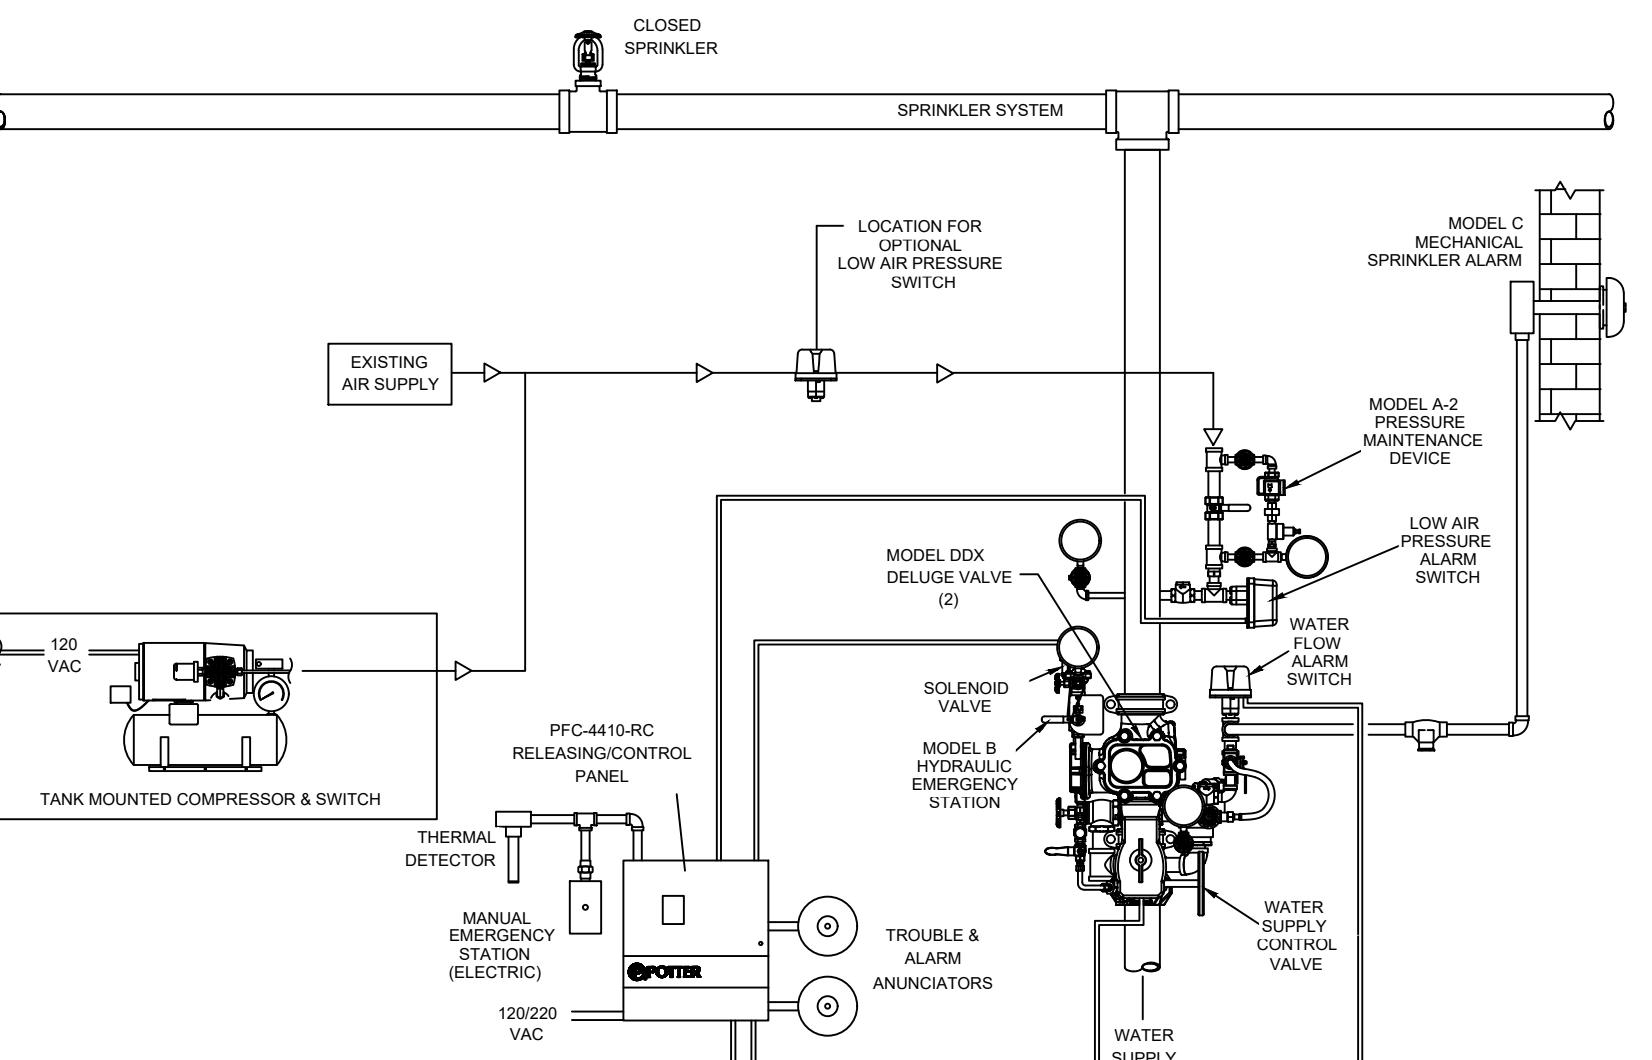

TYPICAL DOUBLE INTERLOCK PREACTION SYSTEM


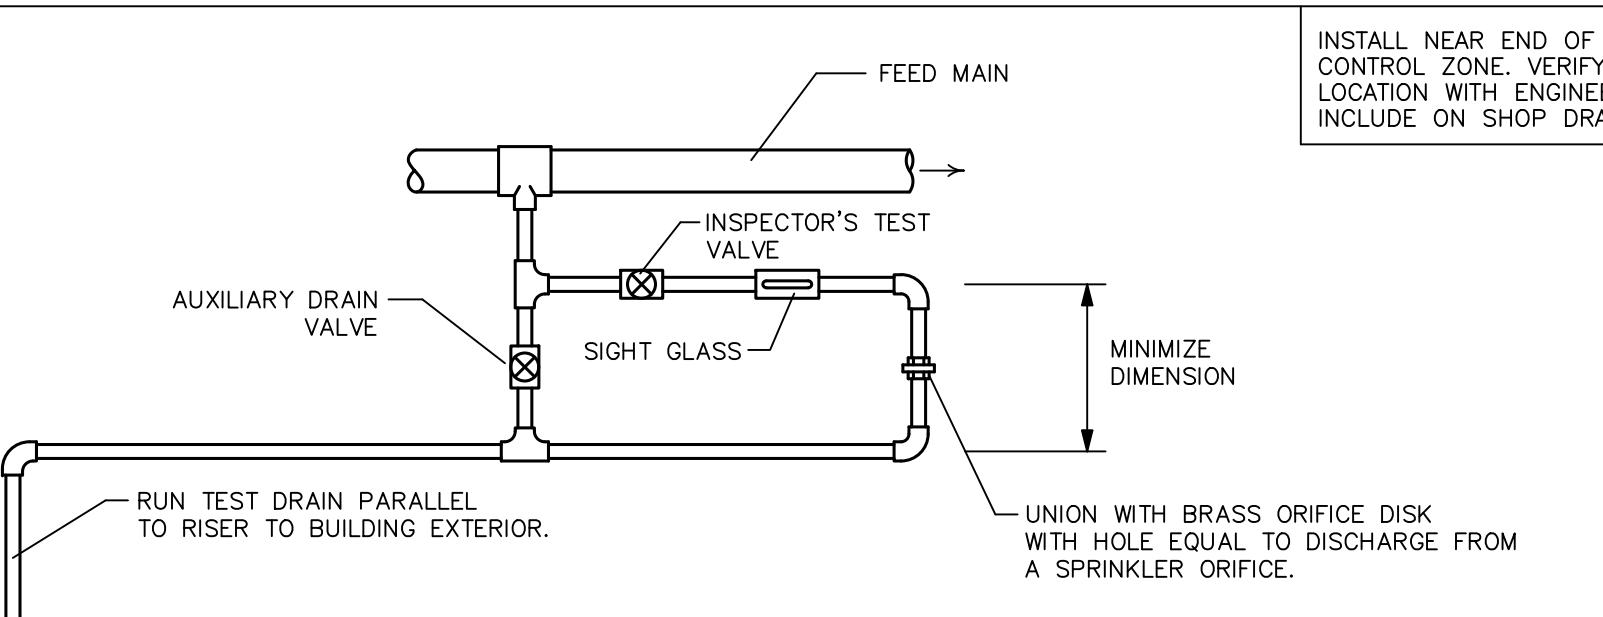


TYPICAL INSPECTOR'S TEST VALVE DETAIL

FIRE SPRINKLER PLUMBING LEGEND, NOTES, AND DETAILS

NOT TO SCALE


SEISMIC BRACE DETAIL

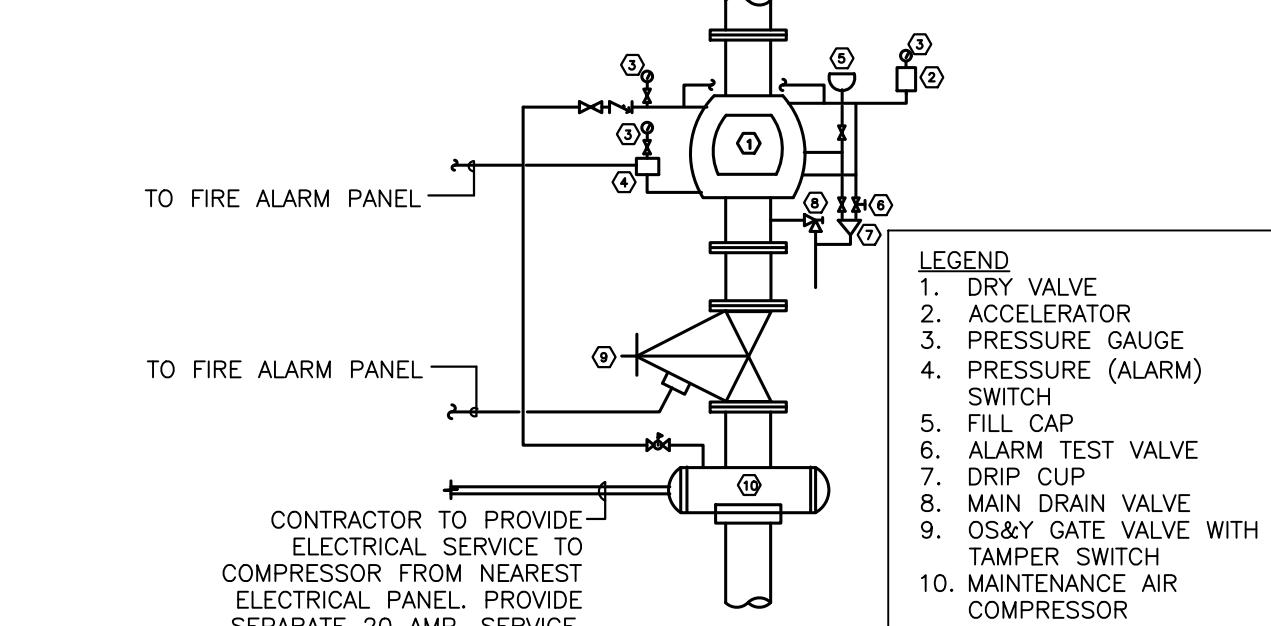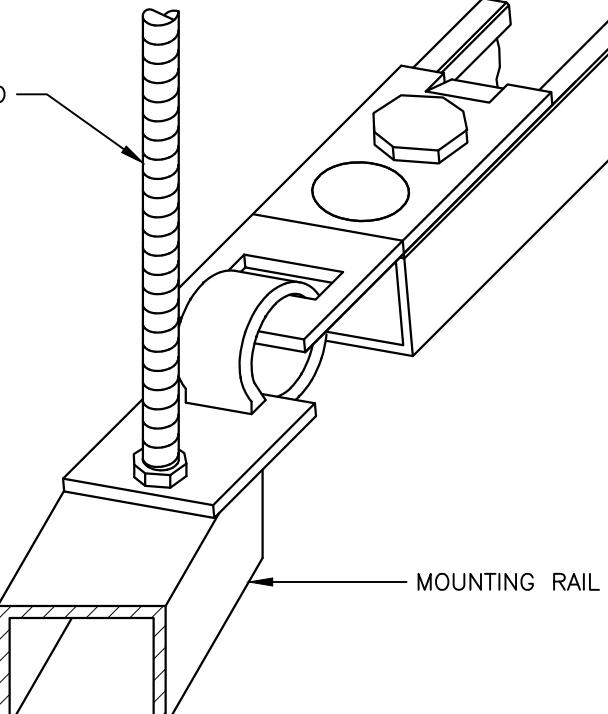



DRY VALVE DETAIL

FIRE SPRINKLER SYSTEM NOTES


1. THE FIRE PROTECTION SYSTEM IS SHOWN IN SCHEMATIC FORM ONLY. THE SUCCESSFUL FIRE PROTECTION VENDOR SHALL LOCATE AND SIZE ALL SPRINKLER HEADS, FIRE DEPARTMENT CONNECTIONS, STANDPIPE SYSTEMS, PIPING, ETC. IN COMPLETE ACCORDANCE WITH 2015 INTERNATIONAL FIRE CODE, 2015 INTERNATIONAL BUILDING CODE, AND LOCAL REQUIREMENTS.
2. SYSTEM DESIGN TO BE IN ACCORDANCE WITH WRITTEN SPECIFICATIONS. ALL HYDRAULIC CALCULATIONS SHALL BE SUBMITTED TO ENGINEER FOR REVIEW AND APPROVAL.
3. ALL PIPING SHALL BE INSTALLED IN SUCH A MANNER AS TO AVOID PLUMBING AND HVAC INSTALLATIONS. FAILURE TO COORDINATE WORK WILL RESULT IN REWORK AT CONTRACTOR'S EXPENSE. MAINTAIN MINIMUM STAIR WELL EGRESS CLEARANCE.
4. INSTALL ALL ABOVE CEILING PIPING BELOW DUCT.
5. INSTALL ALL EXPOSED PIPING AS HIGH AS POSSIBLE.
6. ROUTE ALL EXPOSED PIPING IN CHASES WHERE POSSIBLE.
7. COORDINATE ALL WORK WITH ARCHITECTURAL, STRUCTURAL, HVAC AND ELECTRICAL TRADES. PLUMBING PIPE ROUTING SHOWN IS DIAGRAMMATIC. PROVIDE ALL OFFSETS, ETC., TO AVOID INTERFERENCES WITH EQUIPMENT, PIPING, DUCTWORK, LIGHTS, CONDUIT, ETC.
8. COORDINATE ALL FLOOR PENETRATIONS WITH STRUCTURAL DRAWINGS. SET SLEEVES IN FLOORS AND WALLS AND ATTACHMENTS FOR HANGERS AS CONSTRUCTION PROGRESSES. ALL PENETRATIONS MUST BE SEALED AND HELD AS TIGHT TO COLUMNS OR WALLS AS POSSIBLE.
9. ALL PIPING SHALL BE CONCEALED INSIDE WALLS AND IN PIPE CHASES OR ABOVE CEILINGS. HOLD ALL PIPING ABOVE CEILING AS HIGH AS POSSIBLE.
10. ALL STRUCTURAL PENETRATIONS (SLEEVES, BLOCKOUTS, ETC.) ARE TO BE LOCATED AND COORDINATED IN THE FIELD BY THE CONTRACTOR IN RELATION TO THE REQUIREMENTS OF FINAL EQUIPMENT AND FIXTURES SELECTED.
11. FIELD VERIFY EXACT SIZE, MATERIAL, AND LOCATION OF ALL EXISTING UTILITIES BEFORE BEGINNING WORK.
12. ALL WET PIPING TO BE ROUTED BELOW CEILING INSULATION
13. ALL DRY PIPING TO BE ROUTED IN ATTIC SPACE

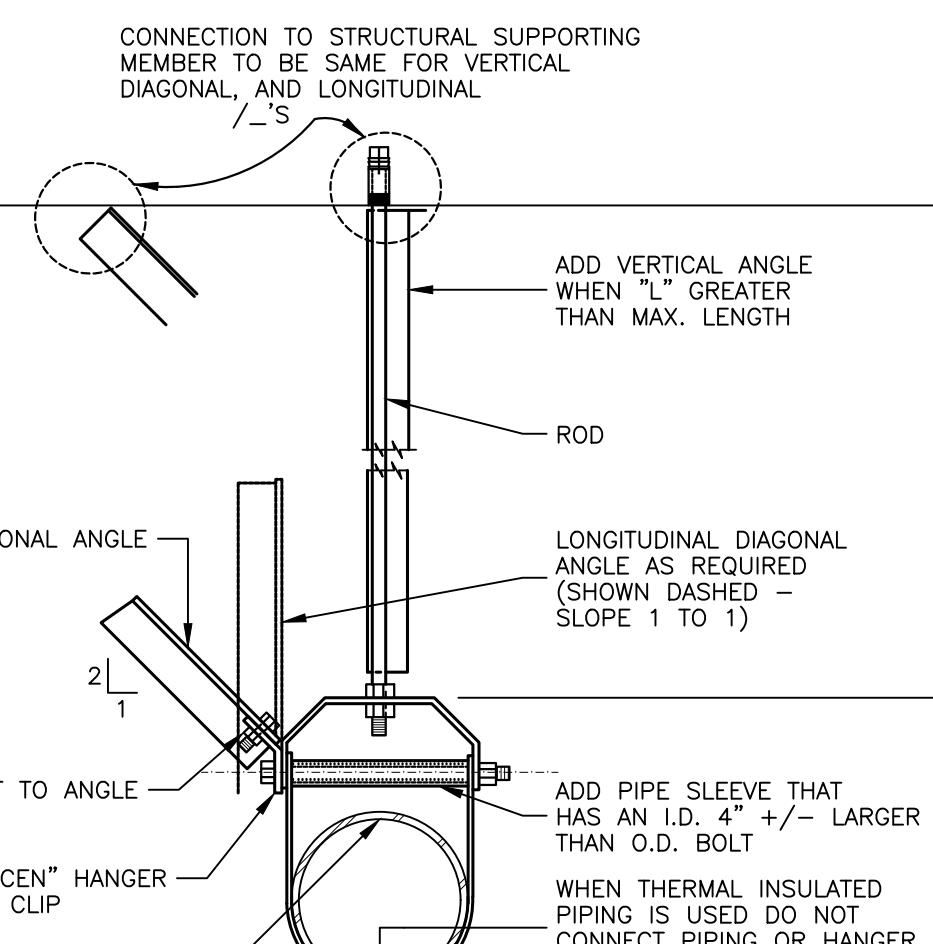

TYPICAL SEISMIC BRACING DETAIL

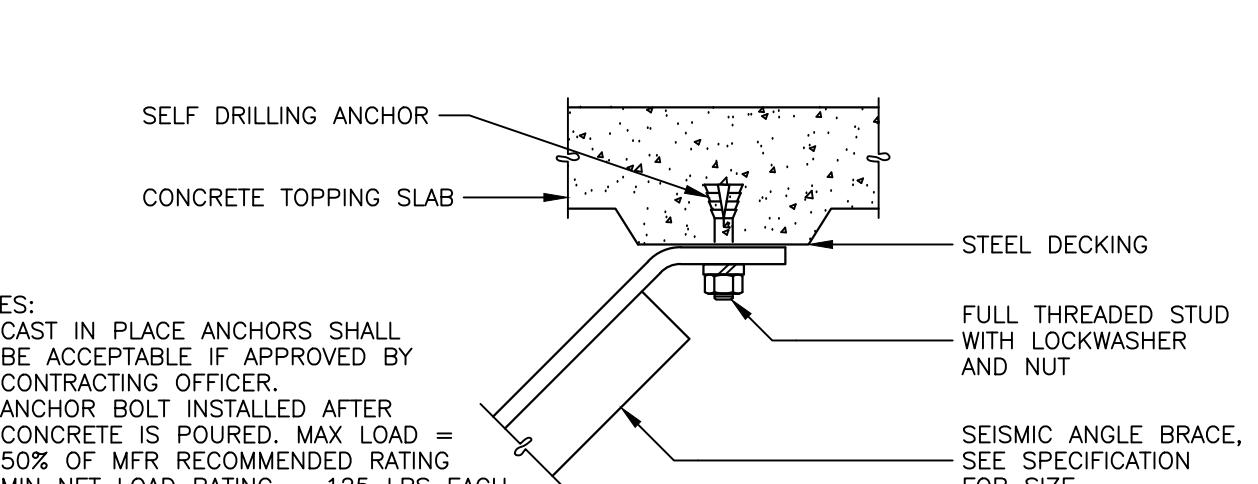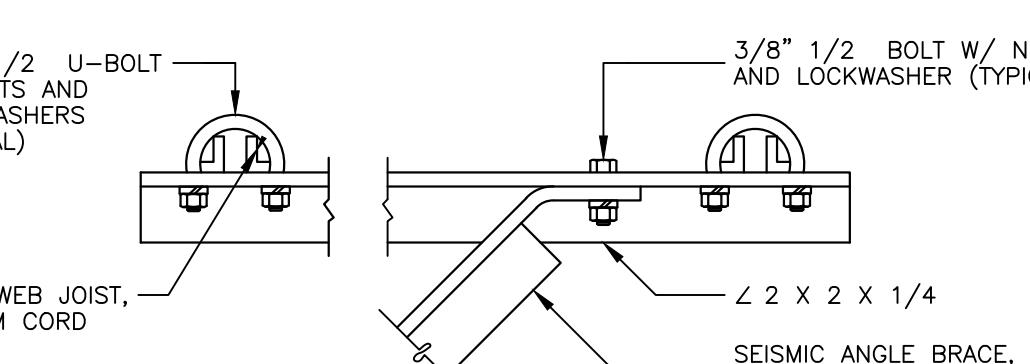

SEISMIC ANGLE BRACING DETAIL

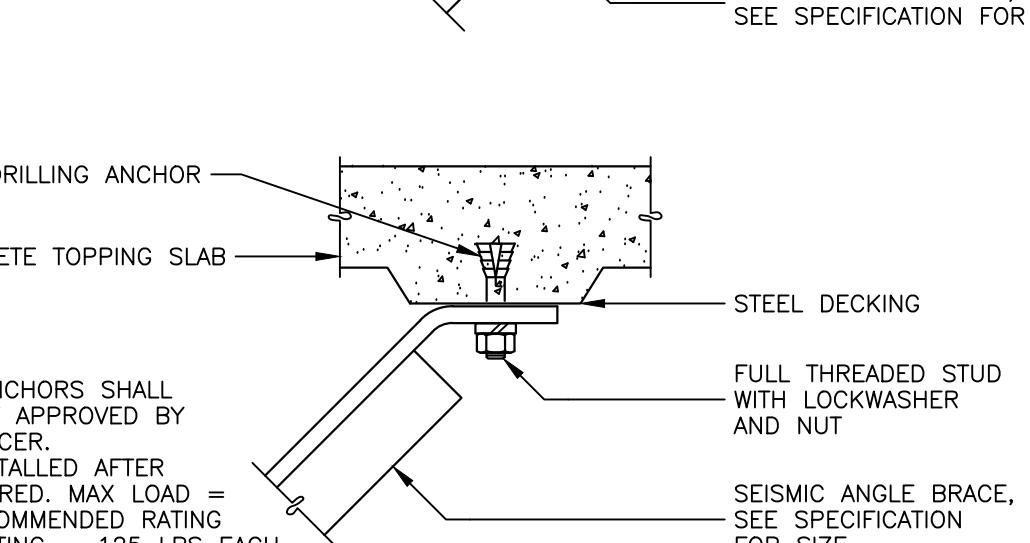

FIRE SPRINKLER ZONES

ZONE NO.	LOCATION	AREA	SYSTEM TYPE	TOTAL AREA
ZONE E1	DISPATCH		DOUBLE INTERLOCK PREACTION	800 SQFT
ZONE E2	REMAINING BUILDING		WET PIPE	315 SQFT
ZONE E3	IT/SERVER ROOM		CLEAN AGENT	80 SQFT

FIRE SPRINKLER DRAWING INDEX

SHEET NO.	SHEET TITLE
SP1.1	FIRE SPRINKLER LEGEND, NOTES AND DETAILS
SP2.1	FIRE SPRINKLER PLUMBING PLAN



TYPICAL CLEAN AGENT SYSTEM LAYOUT

WHORTON ENGINEERING, INC.

HVAC - PLUMBING - PROCESS CONTROL


Randall Whorton, P.E.

DATE 01-08-2026

PHONE: (256) 820-9897


25 SUMMERALL GATE ROAD

ANNISTON, ALABAMA 36205

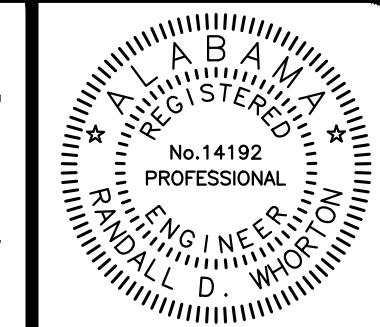

SP1.1

31 OF 40

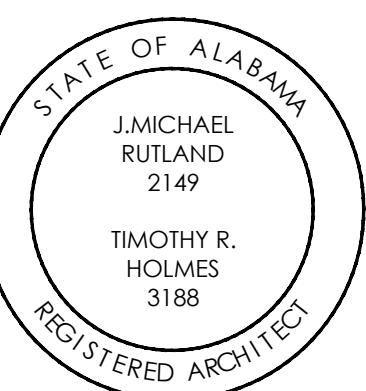

**TALLAPOOSA
CO E911
ADDITION TO
THE
TALLAPOOSA
COUNTY JAIL
FACILITY**

DADEVILLE, AL

**CONSTRUCTION
DOCUMENTS**

Project Number: 25-1465


Date: 8 JANUARY 2026

Revisions:

Sheet Description

**FIRE SPRINKLER
PLUMBING PLAN**

SCALE: 1/8" = 1'-0"

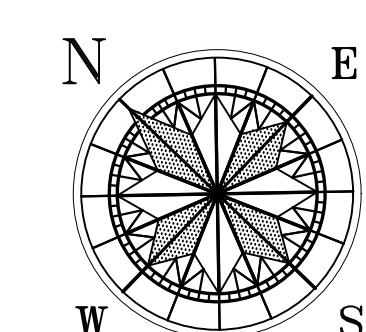

**FIRE SPRINKLER
PLUMBING PLAN**

Sheet Number

SP2.1



WHORTON ENGINEERING, INC.

HVAC - PLUMBING - PROCESS CONTROL


Ran...b... Whort...on

DATE 01-08-2026
RANDALL WHORTON, P.E.
PHONE: (256) 820-9897


WHORTON ENGINEERING PROJECT NO. 25144

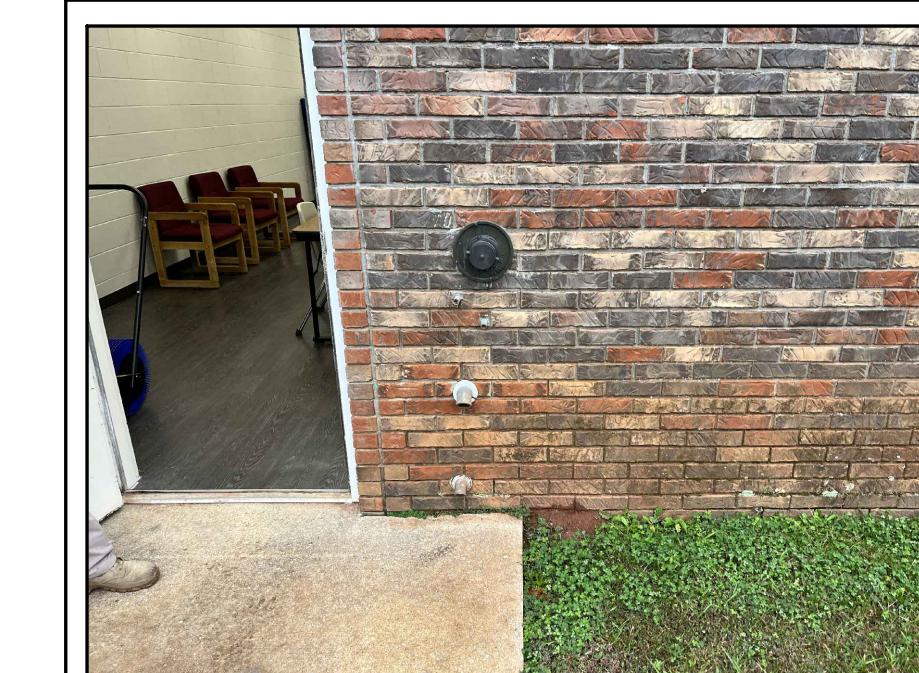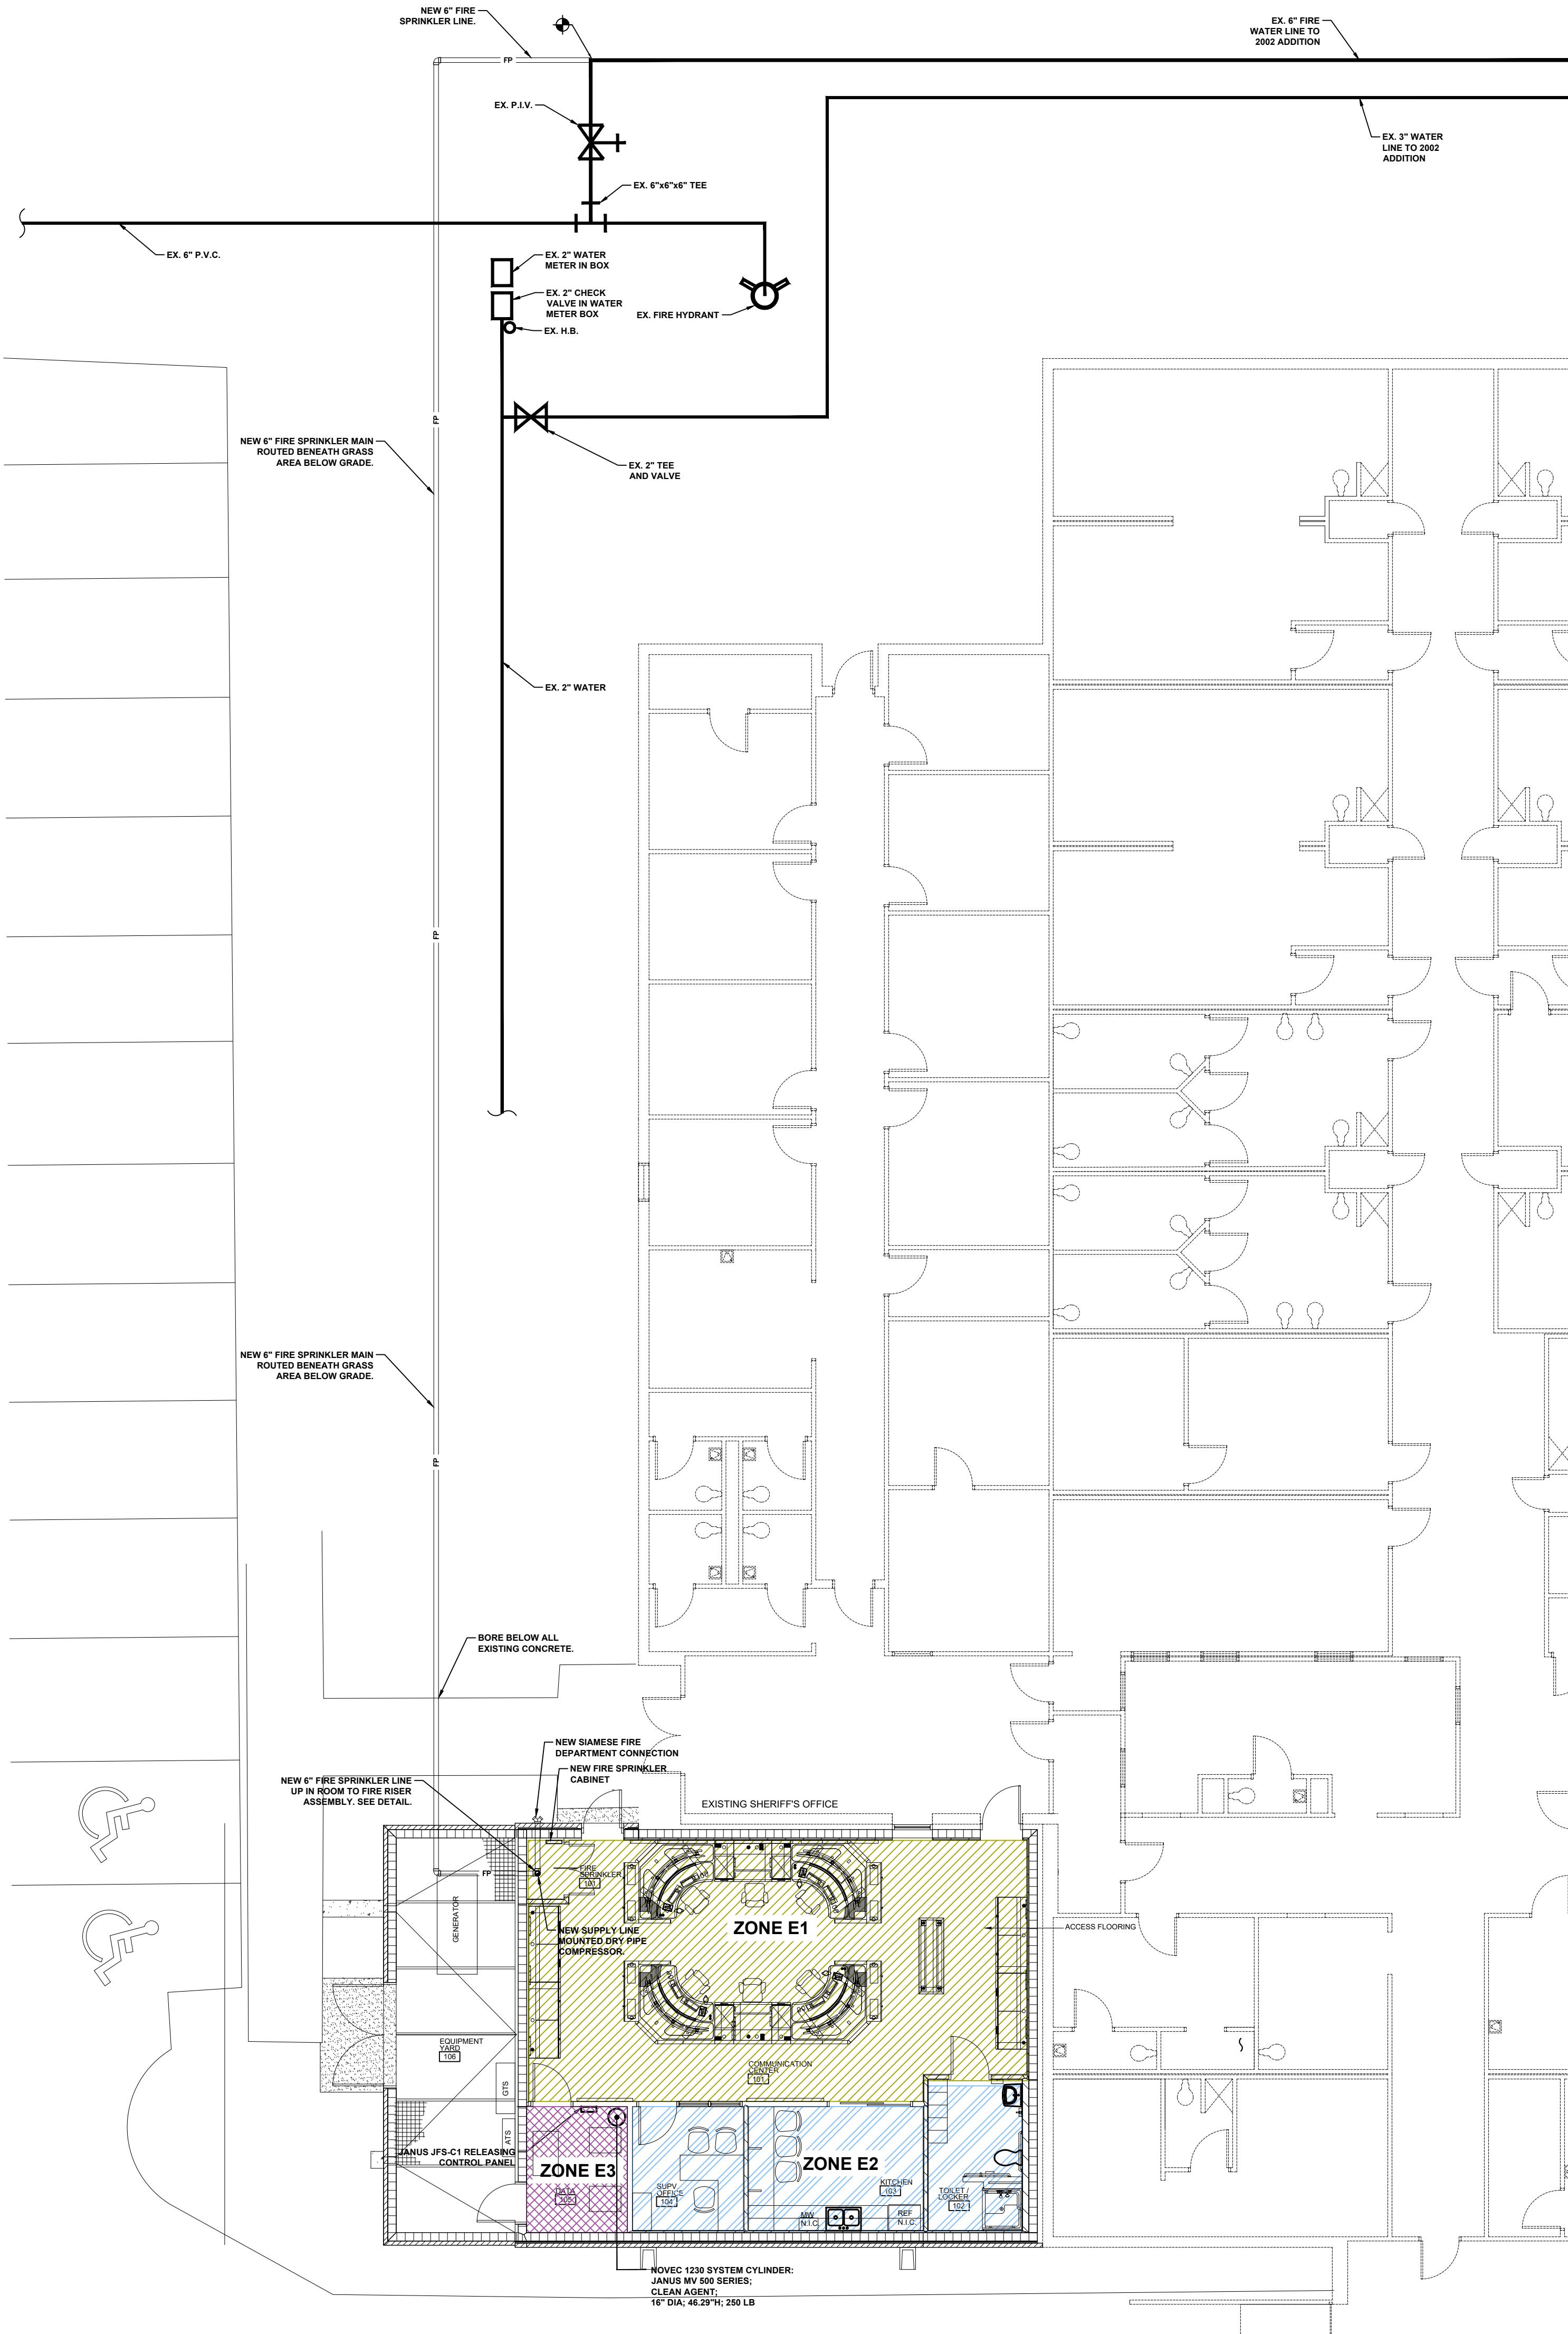

1 EX. FIRE DEPT. CONNECTION (2002 ADDITION)
NOT TO SCALE

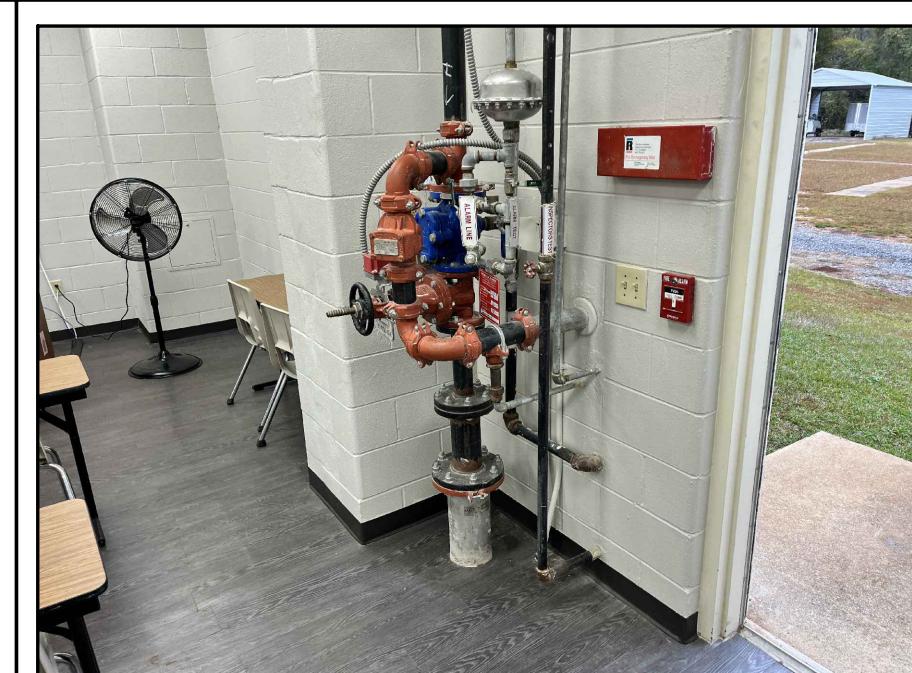

2 EX. FIRE RISER (2002 ADDITION)
NOT TO SCALE

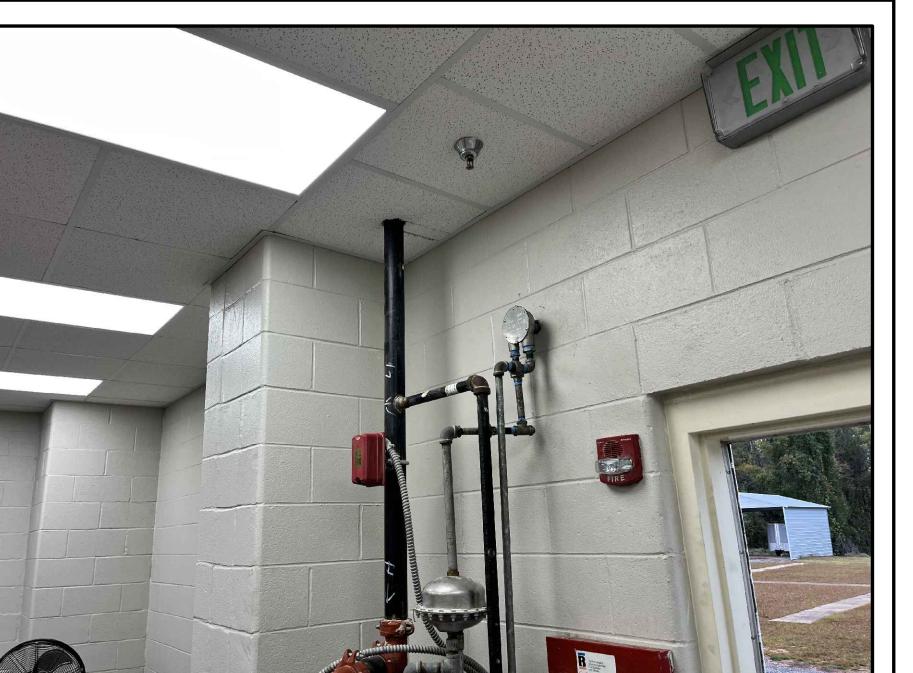

3 EX. FIRE RISER (2002 ADDITION)
NOT TO SCALE



4 EX. FIRE RISER SYSTEM TAG (2002 ADDITION)
NOT TO SCALE



5 EX. POST INDICATOR VALVE
NOT TO SCALE



6 PROPOSED NEW FIRE SPRINKLER MAIN ROUTING
NOT TO SCALE


ELECTRICAL LEGEND

- - PANELBOARD, SURFACE MOUNTED. SEE PANELBOARD SCHEDULE.
- - UTILITY METER/CT CABINET, WALL MOUNTED AS INDICATED. COORDINATE EXACT REQUIREMENTS WITH UTILITY COMPANY.
- - 240V, 3-POLE H.D. SAFETY SWITCH SIZED AND FUSED AS INDICATED.
- - MOTOR. SEE MECHANICAL FOR DETAILS.
- - 20A, 120V NEMA 5-20R DUPLEX RECEPTACLE MOUNTED 1'-6" AFF. AS INDICATED.
- - 20A, 125V NEMA 5-20R DUPLEX RECEPTACLE MOUNTED 4'-0" AFF. OR 9" ABOVE COUNTERTOP UNLESS OTHERWISE INDICATED.
- - 20A, 120V NEMA 5-20R DOUBLE DUPLEX RECEPTACLE MOUNTED 1'-6" AFF. UNLESS OTHERWISE INDICATED.
- - PP - ONE (1) 20A, 120V NEMA L5-20R TWIST-LOCK RECEPTACLE MOUNTED IN CEILING UNLESS OTHERWISE INDICATED.
- - TR - ONE (1) 30A, 120V NEMA L5-30R TWIST-LOCK RECEPTACLE MOUNTED IN CEILING ABOVE TELECOM RACK UNLESS OTHERWISE INDICATED.
- TVSS - TRANSIENT VOLTAGE SURGE SUPPRESSOR IN A NEMA 3R ENCLOSURE UNLESS MOUNTED INDOORS (NEMA 1). EACH UNIT SHALL HAVE SEPARATE BRANCH CIRCUIT PROTECTION. ATS UNIT SHALL PROTECT EMERGENCY SIDE.
- GAP - GENERATOR REMOTE ANNUNCIATOR PANEL FLUSH MOUNTED IN WALL.
- - JUNCTION BOX, SIZED AND LOCATED AS REQUIRED.
- - FIRE ALARM SYSTEM, ADDRESSABLE SMOKE DETECTOR, CEILING MOUNTED AS REQUIRED WITH DEVICE BACKBOX. SIMPLEX TO MATCH EXISTING TYPE IN BUILDING.
- - FIRE ALARM SYSTEM, VISUAL NOTIFICATION DEVICE MOUNTED 6'-8" AFF. WITH DEVICE BACKBOX. SIMPLEX TO MATCH EXISTING TYPE IN BUILDING.
- - FIRE ALARM SYSTEM, HEAT DETECTOR MOUNTED AS REQUIRED WITH DEVICE BACKBOX. SIMPLEX TO MATCH EXISTING TYPE IN BUILDING.
- - FIRE ALARM SYSTEM, AUDIO/VISUAL NOTIFICATION DEVICE MOUNTED 6'-8" AFF. WITH DEVICE BACKBOX. SIMPLEX TO MATCH EXISTING TYPE IN BUILDING.
- - FIRE ALARM SYSTEM, ADDRESSABLE PULL STATION MOUNTED 4'-0" AFF. WITH DEVICE BACKBOX. SIMPLEX TO MATCH EXISTING TYPE IN BUILDING.
- FAAP - FIRE ALARM SYSTEM, ANNUNCIATOR PANEL, FLUSH MOUNTED IN WALL. SIMPLEX TO MATCH EXISTING TYPE IN BUILDING. INTERFACE AS REQUIRED WITH EXISTING FIRE ALARM CONTROL PANEL LOCATED IN SECURITY CONTROL ROOM.
- FAEP - FIRE ALARM SYSTEM, EXTENDER PANEL, WALL MOUNTED, SIMPLEX TO MATCH EXISTING TYPE IN BUILDING. INTERFACE AS REQUIRED WITH EXISTING FIRE ALARM CONTROL PANEL LOCATED IN SECURITY CONTROL ROOM.
- - EXHAUST FAN. SEE MECHANICAL.
- 20A - 20A, 120V OR 208V MOTOR SNAP SWITCH MOUNTED AS REQUIRED.
- WALL SWITCH, SINGLE POLE MOUNTED 4'-0" AFF.
- WALL SWITCH, THREE-WAY MOUNTED 4'-0" AFF.
- WALL SWITCH/OCCUPANCY SENSOR, PIR, SINGLE POLE MOUNTED 4'-0" AFF.
- WALL SWITCH/OCCUPANCY SENSOR, PIR, THREE-WAY MOUNTED 4'-0" AFF.
- 0-10V WALL DIMMER MOUNTED 4'-0" AFF. DIMMER TO BE MATCHED WITH DRIVER AS REQUIRED.
- LV# - LIGHTING CONTROLS LOW VOLTAGE SWITCH MOUNTED 4'-0" AFF. SEE DETAIL. CONNECTION TO ROOM CONTROLLER VIA CAT 6 CABLE.
- - RECESSED LED LIGHT FIXTURE. SEE FIXTURE SCHEDULE.
- - RECESSED FIXTURE, LETTER IN OR ADJACENT TO SYMBOL DENOTES TYPE, SEE FIXTURE SCHEDULE.
- - AUTOMATIC CEILING MOUNTED OCCUPANCY/VACANCY SENSOR. 360° LOW VOLTAGE, DUAL TECH. COORDINATE WITH L.V. CONTROLS WHERE REQUIRED.
- PS - LIGHTING CONTROLS POWER SUPPLY MOUNTED ABOVE CEILING AS REQUIRED.
- RC - LIGHTING CONTROLS ROOM CONTROLLER/POWER SUPPLY MOUNTED ABOVE CEILING. # INDICATES NUMBER OF 0-10V DIMMING ZONES AND SWITCHED ZONES AS REQUIRED. "E" INDICATES UL924 EMERGENCY RELAY.
- TC - 24-HOUR/365 DAY, 2-CIRCUIT, ELECTRONIC CONTROL TIMECLOCK IN A NEMA 1 ENCLOSURE. INTERMATIC ET2125C OR APPROVED EQUAL.
- PC - PHOTOCELL FOR EXTERIOR LIGHTING CONTROLS. MOUNT AS HIGH AS POSSIBLE.
- - CCTV CAMERA LOCATION. ONE (1) CAT 6 CABLE IN 3/4" C. ABOVE CEILING FROM PATCH PANEL IN RACK TO CAMERA LOCATION. PROVIDE FLUSH DEVICE BACKBOX IN WALL WHERE REQUIRED. COORDINATE EXACT LOCATION AND HEIGHT WITH OWNER PRIOR TO INSTALLATION.
- PRH - ACCESS CONTROL PROXIMITY READER LOCATION, 4" SQUARE BOX WALL MOUNTED 4'-0" AFF. WITH SINGLE GANG PLASTER RING AND 3/4" C. STUBBED OUT ABOVE CEILING WITH INSULATED BUSHING.
- IC - INTERCOM STATION LOCATION, 4" SQUARE BOX WALL MOUNTED 4'-0" AFF. WITH SINGLE GANG PLASTER RING AND 3/4" C. STUBBED OUT ABOVE CEILING WITH INSULATED BUSHING.
- - LOW VOLTAGE WIRING IN CONDUIT FOR OCCUPANCY SENSORS.
- - 2 #12 & 1 #12 GND., 3/4" C. SURFACE MOUNTED.
- - 2 #12 & 1 #12 GND., 3/4" C. CONCEALED.
- - 2 #12, 2 #12 N. & 2 #12 GNDs., 3/4" C. CONCEALED ABOVE CEILING.
- - 3 #12, 3#12 N. & 3 #12 GNDs., 3/4" C. HOMERUN CONCEALED ABOVE CEILING.
- - 2 #12 & 1 #12 GND., 1" C. CONCEALED BELOW GRADE.
- - 3 #12 & 1 #12 GND., 1" C. CONCEALED BELOW GRADE.
- - 2 #12 & 1 #12 GND., 1" C. HOMERUN CONCEALED BELOW GRADE.
- - NUS - NEW UNDERGROUND SECONDARY. SIZE AS INDICATED.
- - FIRE ALARM SYSTEM CONDUCTORS AS REQUIRED IN CONCEALED CONDUIT.
- ▽# - TELECOMMUNICATIONS OUTLET LOCATION AT 1'-6" AFF. UNLESS OTHERWISE INDICATED. PROVIDE TWO-GANG DEVICE BACKBOX WITH SINGLE GANG PLASTER RING AND 1" C. WITH INSULATED BUSHING EACH END BACK TO NEAREST CABLE TRAY OR RACK LOCATION. # INDICATES NUMBER OF CAT 6 JACKS AND CABLES TO BE TERMINATED. PROVIDE 6-PORT FACEPLATE AS REQUIRED.
- - TV - TV MONITOR AV WALL BOX WITH DUPLEX RECEPTACLE AND TWO (2) CAT 6 JACKS TERMINATED WITH TWO (2) CAT 6 CABLES ROUTED IN 1" C. WITH INSULATED BUSHING EACH END BACK TO NEAREST CABLE TRAY LOCATION. COORDINATE EXACT MOUNTING HEIGHT WITH ARCHITECT AND OWNER. WIREMOLD EFSB4 OR APPROVED EQUAL TERMINATE CABLES IN PATCH PANEL IN RACK AS INDICATED.
- - D - TELECOMMUNICATIONS EQUIPMENT CONNECTION TO CONSOLE WORKSTATION.
- - P - POWER EQUIPMENT CONNECTION TO CONSOLE WORKSTATION. TWO (2) EA. 20A, 120V NEMA 5-20R DOUBLE DUPLEX RECEPTACLES EACH MOUNTED IN 4" SQUARE BOX BENEATH RAISED FLOOR. COORDINATE EXACT LOCATION WITH OWNER PRIOR TO INSTALLATION AS REQUIRED.
- TB - TELECOMMUNICATIONS BACKBOARD. 4" X 8' X 3/4" PLYWOOD BACKBOARD WITH TWO COATS OF GRAY FIRE-RETARDANT PAINT.
- - 10" WIDE X 4" DEEP STEEL BASKET TRAY MOUNTED 8'-0" AFF.
- - 12" WIDE X 3" DEEP STEEL BASKET TRAY MOUNTED BELOW RAISED FLOOR.
- - TR - 7'-0" FREESTANDING 2-POST TELECOMMUNICATIONS RACK. SEE DETAIL.
- - W - WIRELESS ACCESS POINT LOCATION. ROUTE TWO (2) CAT 6 CABLES IN 3/4" C. ABOVE CEILING WITH INSULATED BUSHING EACH END BACK TO RACK LOCATION. TERMINATE CAT 6 CABLES INTO A BISCUIT JACK ABOVE CEILING.
- MGB - MAIN EQUIPMENT GROUND BUS MOUNTED 1'-6" AFF. SIZE AS INDICATED. SEE DETAIL.
- SEB - SUPPLEMENTAL BONDING GROUND BUS MOUNTED 1'-6" AFF. SIZE AS INDICATED. SEE DETAIL.
- TGB - TELECOM GROUND BUS MOUNTED 1'-6" AFF. SIZE AS INDICATED. SEE DETAIL.
- X - 3/4" X 10'-0" COPPER GROUND ROD.
- - GROUNDING TEST WELL.

GENERAL NOTES:

1. CONTRACTOR SHALL VISIT SITE TO DETERMINE EXISTING AS-BUILT CONDITIONS PRIOR TO BIDDING PROJECT.
2. ALL ELECTRICAL WORK (NEW AND MODIFIED) SHALL MEET THE NATIONAL ELECTRICAL CODE AND LOCAL AUTHORITY HAVING JURISDICTION REQUIREMENTS.
3. IF ANY EXISTING UTILITY IS DAMAGED DURING CONSTRUCTION, THE CONTRACTOR SHALL REPAIR IMMEDIATELY AT NO EXPENSE TO THE OWNER.
4. PROVIDE GREEN INSULATED GROUND CONDUCTOR IN ALL RUNS IN ADDITION TO THOSE SHOWN. WHEN NO CONDUCTORS ARE SHOWN, THEN PROVIDE A PHASE, NEUTRAL AND GROUND CONDUCTOR.
5. ALL FEEDERS AND BRANCH CIRCUIT WIRING SHALL HAVE A SOLID COLOR-CODED JACKET CORRESPONDING TO THE VOLTAGE SYSTEM AND PHASE.
6. 0-10V LIGHTING CONTROL CABLEING CAN BE RUN IN SAME CONDUIT AS 120V POWER CABLEING IF INSULATION IS RATED EQUAL TO 120V CONDUCTOR INSULATION AND CLASS 1.
7. MINIMUM CONDUIT SIZE SHALL BE 3/4".
8. PROVIDE AND INSTALL ENGRAVED PLASTIC LAMINATE LABEL ON CEILING GRID AT LOCATIONS OF OCCUPANCY SENSOR POWER PACK LOCATED ABOVE CEILING.
9. COORDINATE CEILING MOUNTED OCCUPANCY SENSORS WITH SUPPLY DIFFUSERS SO THAT OCCUPANCY SENSOR IS A MINIMUM OF 3'-0" FROM NEAREST SUPPLY DIFFUSER.
10. ALL CONDUIT ROUTING SHALL BE COORDINATED WITH EQUIPMENT LOCATION, MECHANICAL PIPING AND ACCESS PANELS SO THAT ACCESS TO ALL EQUIPMENT THRU ACCESS DOORS IS NOT IMPEDED BY CONDUIT RUNS.
11. ALL CONDUIT SHALL BE CONCEALED AS INDICATED. IF CONDUIT CANNOT BE CONCEALED, SURFACE MOUNTED RACEWAY SHALL BE ACCEPTABLE ONLY WHERE APPROVED BY OWNER.
12. ALL LIGHTING SYSTEMS AND CONTROLS SHALL BE INSTALLED AND PROGRAMMED TO ADHERE TO ASHRAE 90.1-2013 CRITERIA.
13. EXISTING FACILITY SHALL REMAIN IN SERVICE DURING CONSTRUCTION. CONTRACTOR SHALL COORDINATE ALL POWER SHUTDOWNS WITH THE OWNER. ALL MAJOR SHUTDOWNS SHALL BE REQUESTED IN WRITING A MINIMUM OF 5 DAYS IN ADVANCE OF REQUESTED SHUTDOWN.
14. NEW FIRE ALARM COMPONENTS SHALL BE AN EXTENSION OF THE EXISTING SIMPLEX FIRE ALARM SYSTEM IN JAIL. SYSTEM TO ALARM LOCALLY AT DISPATCH.
15. FIRE ALARM SYSTEM CONTRACTOR SHALL BE CERTIFIED THROUGH THE STATE OF ALABAMA FIRE MARSHAL'S OFFICE AS REQUIRED.
16. NEW FIRE ALARM SYSTEM COMPONENTS SHALL BE PROVIDED BY SIMPLEX TO MATCH EXISTING COMPONENTS. CONTRACTOR SHALL HAVE ENTIRE FIRE ALARM SYSTEM RE-CERTIFIED AFTER MODIFICATIONS ARE ACCOMPLISHED. ALL MODIFICATIONS AND RE-CERTIFICATIONS SHALL BE PERFORMED BY A SIMPLEX NICET LEVEL TECHNICIAN. FIRE ALARM SYSTEM SHOP DRAWINGS SHALL BE SUBMITTED FOR APPROVAL.
17. INTERFACE NEW FIRE ALARM SYSTEM EXTENDER PANEL WITH EXISTING FIRE ALARM CONTROL PANEL AS REQUIRED. PROVIDE ALL REQUIRED CABLEING IN CONDUIT CONCEALED ABOVE CEILING. MAKE ALL CONNECTIONS AS REQUIRED FOR A COMPLETE AND OPERATIONAL SYSTEM.
18. CEILING MOUNTED FIRE ALARM DEVICES MAY BE UTILIZED IN LIEU OF WALL MOUNTED DEVICES WHERE NEW DEVICES ARE SHOWN TO BE INSTALLED.
19. BASE BID HAS CONDUIT ROUTED INSIDE AND DEVICE BACKBOXES CUT INTO CMU BLOCK. BID ALTERNATE HAS DEVICE BACKBOXES AND CONDUIT IN GYPOBOARD FUM OUT. FOR BASE BID, ROUTE CONDUIT IN CHASE SPACE.
20. OWNER SHALL BE RESPONSIBLE FOR PAYING ALL AID TO CONSTRUCTION ELECTRICAL UTILITY COSTS ASSOCIATED WITH THE ADDITION OF THE NEW ELECTRICAL SERVICE. ALABAMA POWER IS THE ELECTRICAL UTILITY PROVIDER.
21. COORDINATE WITH OTHER UTILITY DISCIPLINES AS REQUIRED FOR INSTALLATION OF NEW UNDERGROUND SECONDARY ROUTING.
22. CONTRACTOR SHALL BE REQUIRED TO BE LICENSED IN THE CITY OF DADEVILLE TO PERFORM WORK ON THE PROJECT.
23. ONE (1) 20A/1P SPARE BREAKER IS ALLOCATED FOR FUTURE OWNER'S THIRD PARTY ACCESS CONTROL/CCTV SYSTEM INSTALLATION.

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TALLAPOOSA CO E911 ADDITION TO THE TALLAPOOSA COUNTY JAIL FACILITY
DADEVILLE, AL

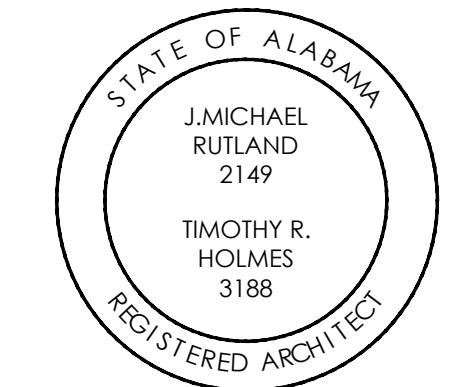CONSTRUCTION DOCUMENTS


Project Number: 25-1465
Date: 8 JANUARY 2026
Revisions:

Sheet Description
ELECTRICAL LEGEND, NOTES AND DETAILS

Sheet Number

LIGHTING FIXTURE SCHEDULE					
SYMBOL	DESCRIPTION	MANUFACTURER & CATALOG NUMBER	LAMPS	MOUNTING	REMARKS
A	6" WET LOCATION LED DOWNLIGHT WITH DIE-CAST ALUMINUM HEAT SINK, 120-277V 0-10V DIMMING DRIVER TO 1%, 50,000 HOUR LUMEN LIGHT ENGINE MIN., MEDIUM DISTRIBUTION, CLEAR SPECULAR REFLECTOR AND FINISH FLANGE.	COOPER LD6A20DE010 ERM6A15835 GLM1L1 GOTHAM EVO 35/20 6AR MD LSS 120 EZ1 PRESCOLITE LF6L DM1 6LFSL 20L 35K SP WT	LED 2000 LUMENS MIN 3500K	RECESSED IN CEILING	"EM" INDICATES FIXTURE WITH EMERGENCY BATTERY.
B	6" OPEN LED DOWNLIGHT WITH DIE-CAST ALUMINUM HEAT SINK, 120-277V, 0-10V DIMMING DRIVER TO 1%, 50,000 HOUR LUMEN LIGHT ENGINE MIN., MEDIUM DISTRIBUTION CLEAR SPECULAR REFLECTOR AND FINISH FLANGE.	COOPER LD6A20DE010 ERM6A15835 6LM1L1 GOTHAM EVO 35/20 6AR MD LSS 120 EZ1 PRESCOLITE LF6 DM1 6LFSL 20L 35K SP WT	LED 2000 LUMENS MIN 3500K	RECESSED IN CEILING	"EM" INDICATES FIXTURE WITH EMERGENCY BATTERY.
F4	2' X 4' HIGH EFFICIENCY LED FLAT PANEL TROFFER WITH SHALLOW DEPTH HOUSING, SMOOTH ACRYLIC DIFFUSER, WHITE FINISH, FLANGE TRIM & 0-10V DIMMING DRIVER.	COLUMBIA NBT 24 35 L054 F SF ED1 U LITHONIA EPANL 2X4 5400LM 80CRI 35K MN10 ZT MVOLT DAY-BRITE 2FPZ 54L 835 ADS UNV DIM	LED 5000 LUMENS MIN. 3500K	RECESSED IN CEILING	INDICATES INTEGRAL BATTERY BACKUP.
L4	2' X 4' HIGH EFFICIENCY LED FLAT PANEL TROFFER WITH SHALLOW DEPTH HOUSING, SMOOTH ACRYLIC DIFFUSER, WHITE FINISH, GRID TRIM & 0-10V DIMMING DRIVER.	COLUMBIA NBT 24 35 L054 F SF ED1 U LITHONIA EPANL 2X4 5400LM 80CRI 35K MN10 ZT MVOLT DAY-BRITE 2FPZ 54L 835 ADS UNV DIM	LED 5000 LUMENS MIN. 3500K	RECESSED IN CEILING	INDICATES INTEGRAL BATTERY BACKUP.
L6	2' X 4' LED INDIRECT FIXTURE WITH CURVED APERTURE, SHALLOW DEPTH, EDGE-LIT LED, LOW UGR, INTEGRAL 1% 0-10V DIMMING DRIVER AND WHITE FINISH.	WILLIAMS AP 24 L70 835 DIM UNV	LED 7000 LUMENS MIN. 3500K	RECESSED IN CEILING	INDICATES INTEGRAL BATTERY BACKUP.
S3	3' LED LENSED STRIP LIGHTING FIXTURE WITH DIFFUSE ACRYLIC LENS, STEEL HOUSING, WHITE FINISH, & 0-10V DIMMING DRIVER.	LITHONIA CLX L36 5250LM SEF FDL MVOLT GZ10 35K 80CRI WILLIAMS 755-3-L40/835-DIM-UNV	LED 4000 LUMENS MIN. 3500K	SURFACE	"EM" INDICATES INTEGRAL BATTERY BACKUP.
S4	4' LED LENSED STRIP LIGHTING FIXTURE WITH DIFFUSE ACRYLIC LENS, STEEL HOUSING, WHITE FINISH, & 0-10V DIMMING DRIVER.	COLUMBIA LCL4-35HL-ED LITHONIA CLX L48 6000LM SEF FDL MVOLT GZ10 35K 80CRI WILLIAMS 755-4-L60/835-DIM-UNV	LED 6000 LUMENS MIN. 3500K	SURFACE	"EM" INDICATES INTEGRAL BATTERY BACKUP.
U3	3' LENSED LED UNDERCABINET LIGHT WITH STEEL HOUSING, ACRYLIC LENS, WHITE FINISH AND 120V ELECTRONIC DRIVER.	COLUMBIA CUC3-CS-ED120 ELITE EU-LED 34-1300L DIMTR-120 35K WH WILLIAMS 1SF3-L18/835 DRV 120	LED 1200 LUMENS MIN. 3500K	UNDERCABINET	
U4	4' LENSED LED UNDERCABINET LIGHT WITH STEEL HOUSING, ACRYLIC LENS, WHITE FINISH AND 120V ELECTRONIC DRIVER.	COLUMBIA CUC4-CS-ED120 ELITE EU-LED 46-1300L DIMTR-120 35K WH WILLIAMS 1SF4-L18/835 DRV 120	LED 1800 LUMENS MIN. 3500K	UNDERCABINET	
WP1	LED EXTERIOR PERIMETER WALLPACK WITH DIE-CAST ALUMINUM HOUSING, IP66 RATED, FULL CUTOFF TYPE 3 DISTRIBUTION, 120V DRIVER, 3500K COLOR TEMPERATURE, BRONZE FINISH, AND PHOTOCELL.	LITHONIA DSXW1 LED 20C 530 35K T3M 120 PE PIR DDBXD	LED 3800 LUMENS MIN	WALL 9'-0" AFF.	MOUNTING HEIGHT AND COLOR AS DIRECTED BY ARCHITECT. "EM" INDICATES FIXTURE WITH EMERGENCY BATTERY.
WP2	LED EXTERIOR PERIMETER WALLPACK WITH DIE-CAST ALUMINUM HOUSING, IP66 RATED, FULL CUTOFF TYPE 3 DISTRIBUTION, 120V DRIVER, 3500K COLOR TEMPERATURE, BRONZE FINISH, AND PHOTOCELL.	LITHONIA DSXW1 LED 20C 530 35K T3M 120 PE PIR DDBXD	LED 4800 LUMENS MIN	WALL 8'-0" AFF.	MOUNTING HEIGHT AND COLOR AS DIRECTED BY ARCHITECT. "EM" INDICATES FIXTURE WITH EMERGENCY BATTERY.
○	SINGLE FACE LED EXIT LIGHT WITH GREEN LETTERS ON MIRROR, EDGE-LIT STYLE, BRUSHED ALUMINUM TRIM, 120/277 VOLT OPERATION AND ARROWS AS SHOWN AND NICAD BATTERY BACKUP.	LITHONIA LRP 1 GMR (ARROWS AS REQ'D.) 120/277	LED	CEILING	MOUNTED BEHIND GRATES AS HIGH AS POSSIBLE.

NOTE: PROVIDED UN-SWITCHED HOT CONDUCTOR TO EACH FIXTURE WITH EMERGENCY BATTERY BACKUP OR EXIT SIGN.

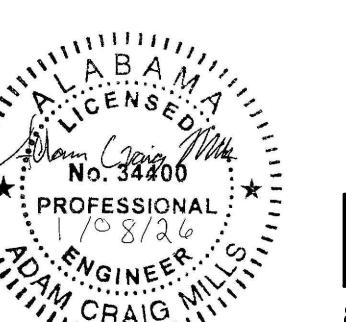

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E0.1

KEYED NOTES:

- ① - BORE UNDERNEATH EXISTING PARKING LOT AS REQUIRED TO INSTALL NEW UNDERGROUND CONDUITS AS INDICATED.
- ② - NEW UTILITY POLE MOUNTED TRANSFORMERS INSTALLED ON EXISTING UTILITY POLE. ROUTE NEW CONDUIT DOWN POLE AND SECURE AS REQUIRED. COORDINATE WITH UTILITY FOR EXACT REQUIREMENTS.
- ③ - INSTALL NEW UTILITY PROVIDED COMBINATION METER BASE/CT CABINET ON BUILDING EXTERIOR. COORDINATE EXACT REQUIREMENTS WITH UTILITY.

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ELECTRICAL SITE PLAN

SCALE: 1/8" = 1'-0"

EXISTING
FFE=6
**TALLAPOOSA
CO E911
ADDITION TO
THE
TALLAPOOSA
COUNTY JAIL
FACILITY**


DADEVILLE, AL

**CONSTRUCTION
DOCUMENTS**

Project Number: 25-1465
Date: 8 JANUARY 2026
Revisions:

Sheet Description
**ELECTRICAL
SITE PLAN**

Sheet Number

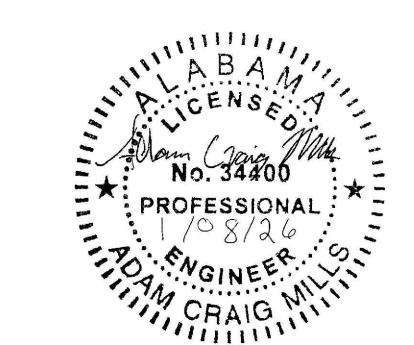
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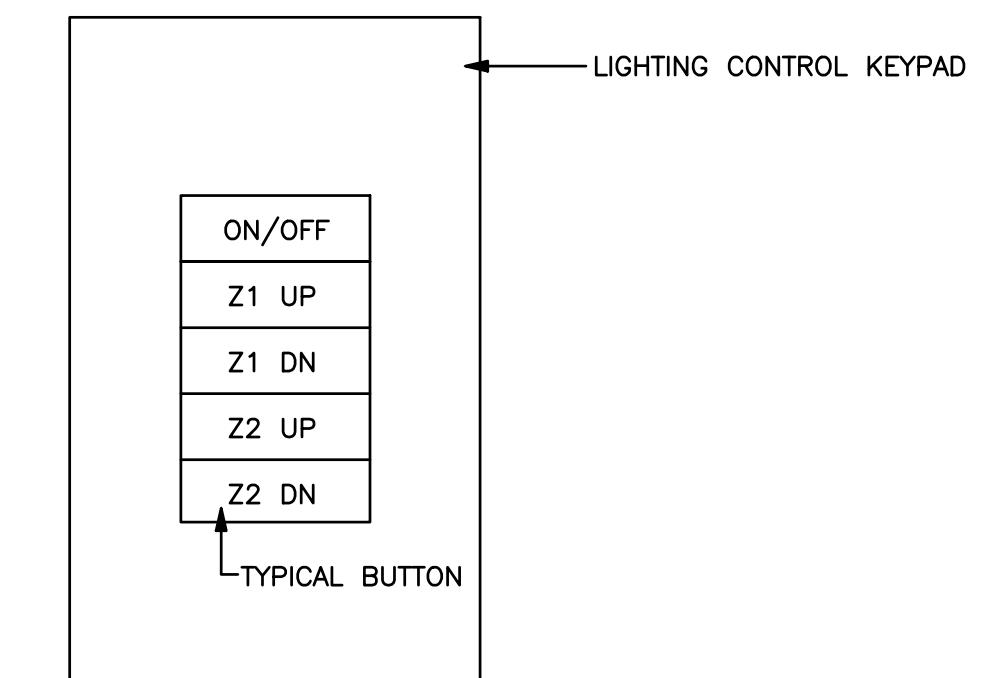
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LIGHTING CONTROLS, LV2 PROGRAMMING SCHEDULE			
BUTTON	ENGRAVING	ZONE CONTROLLED	PROGRAMMING DESCRIPTION
1	ON/OFF	ZONE 1 & 2	ALL ZONES ON/OFF
2	Z1 UP	ZONE 1	ZONE 1 RAISE
3	Z1 DN	ZONE 1	ZONE 1 LOWER
4	Z2 UP	ZONE 2	ZONE 2 RAISE
5	Z2 DN	ZONE 2	ZONE 2 LOWER




DEVICE: \$LV2
LOCATION: VARIES
COLOR: GRAY

LIGHTING CONTROLS "LV2" DETAIL

NOT TO SCALE

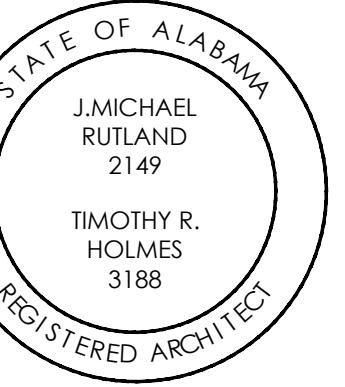NOTES:

1. ZONE 1: AS SHOWN
ZONE 2: AS SHOWN
2. WALL PLATE SHALL BE STAINLESS STEEL.
3. LIGHTING SHALL BE MANUAL "ON" AND AUTOMATIC "OFF".
4. TWO (2) INDIVIDUAL LOW-VOLTAGE DIMMERS MAY BE UTILIZED IN LIEU OF A SINGLE DEVICE.


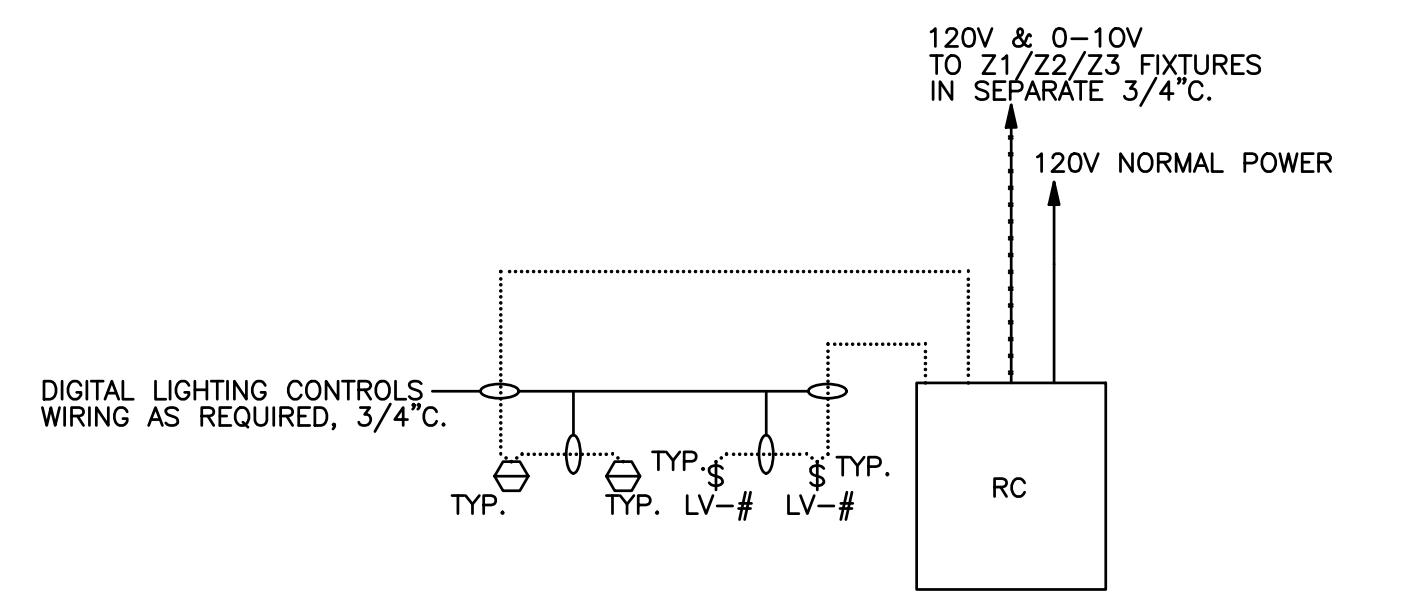


TYPICAL LIGHTING CONTROLS RISER DIAGRAM

NOT TO SCALE


NOTES:

1. PROVIDE UNSWITCHED HOT LEG TO EACH "EM" FIXTURE TO ILLUMINATE EMERGENCY BATTERY BACKUP UPON LOSS OF NORMAL POWER.

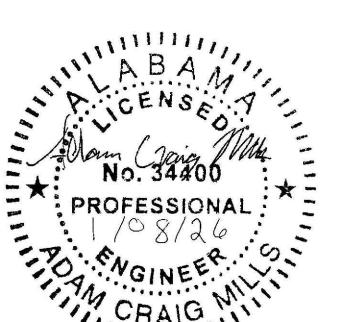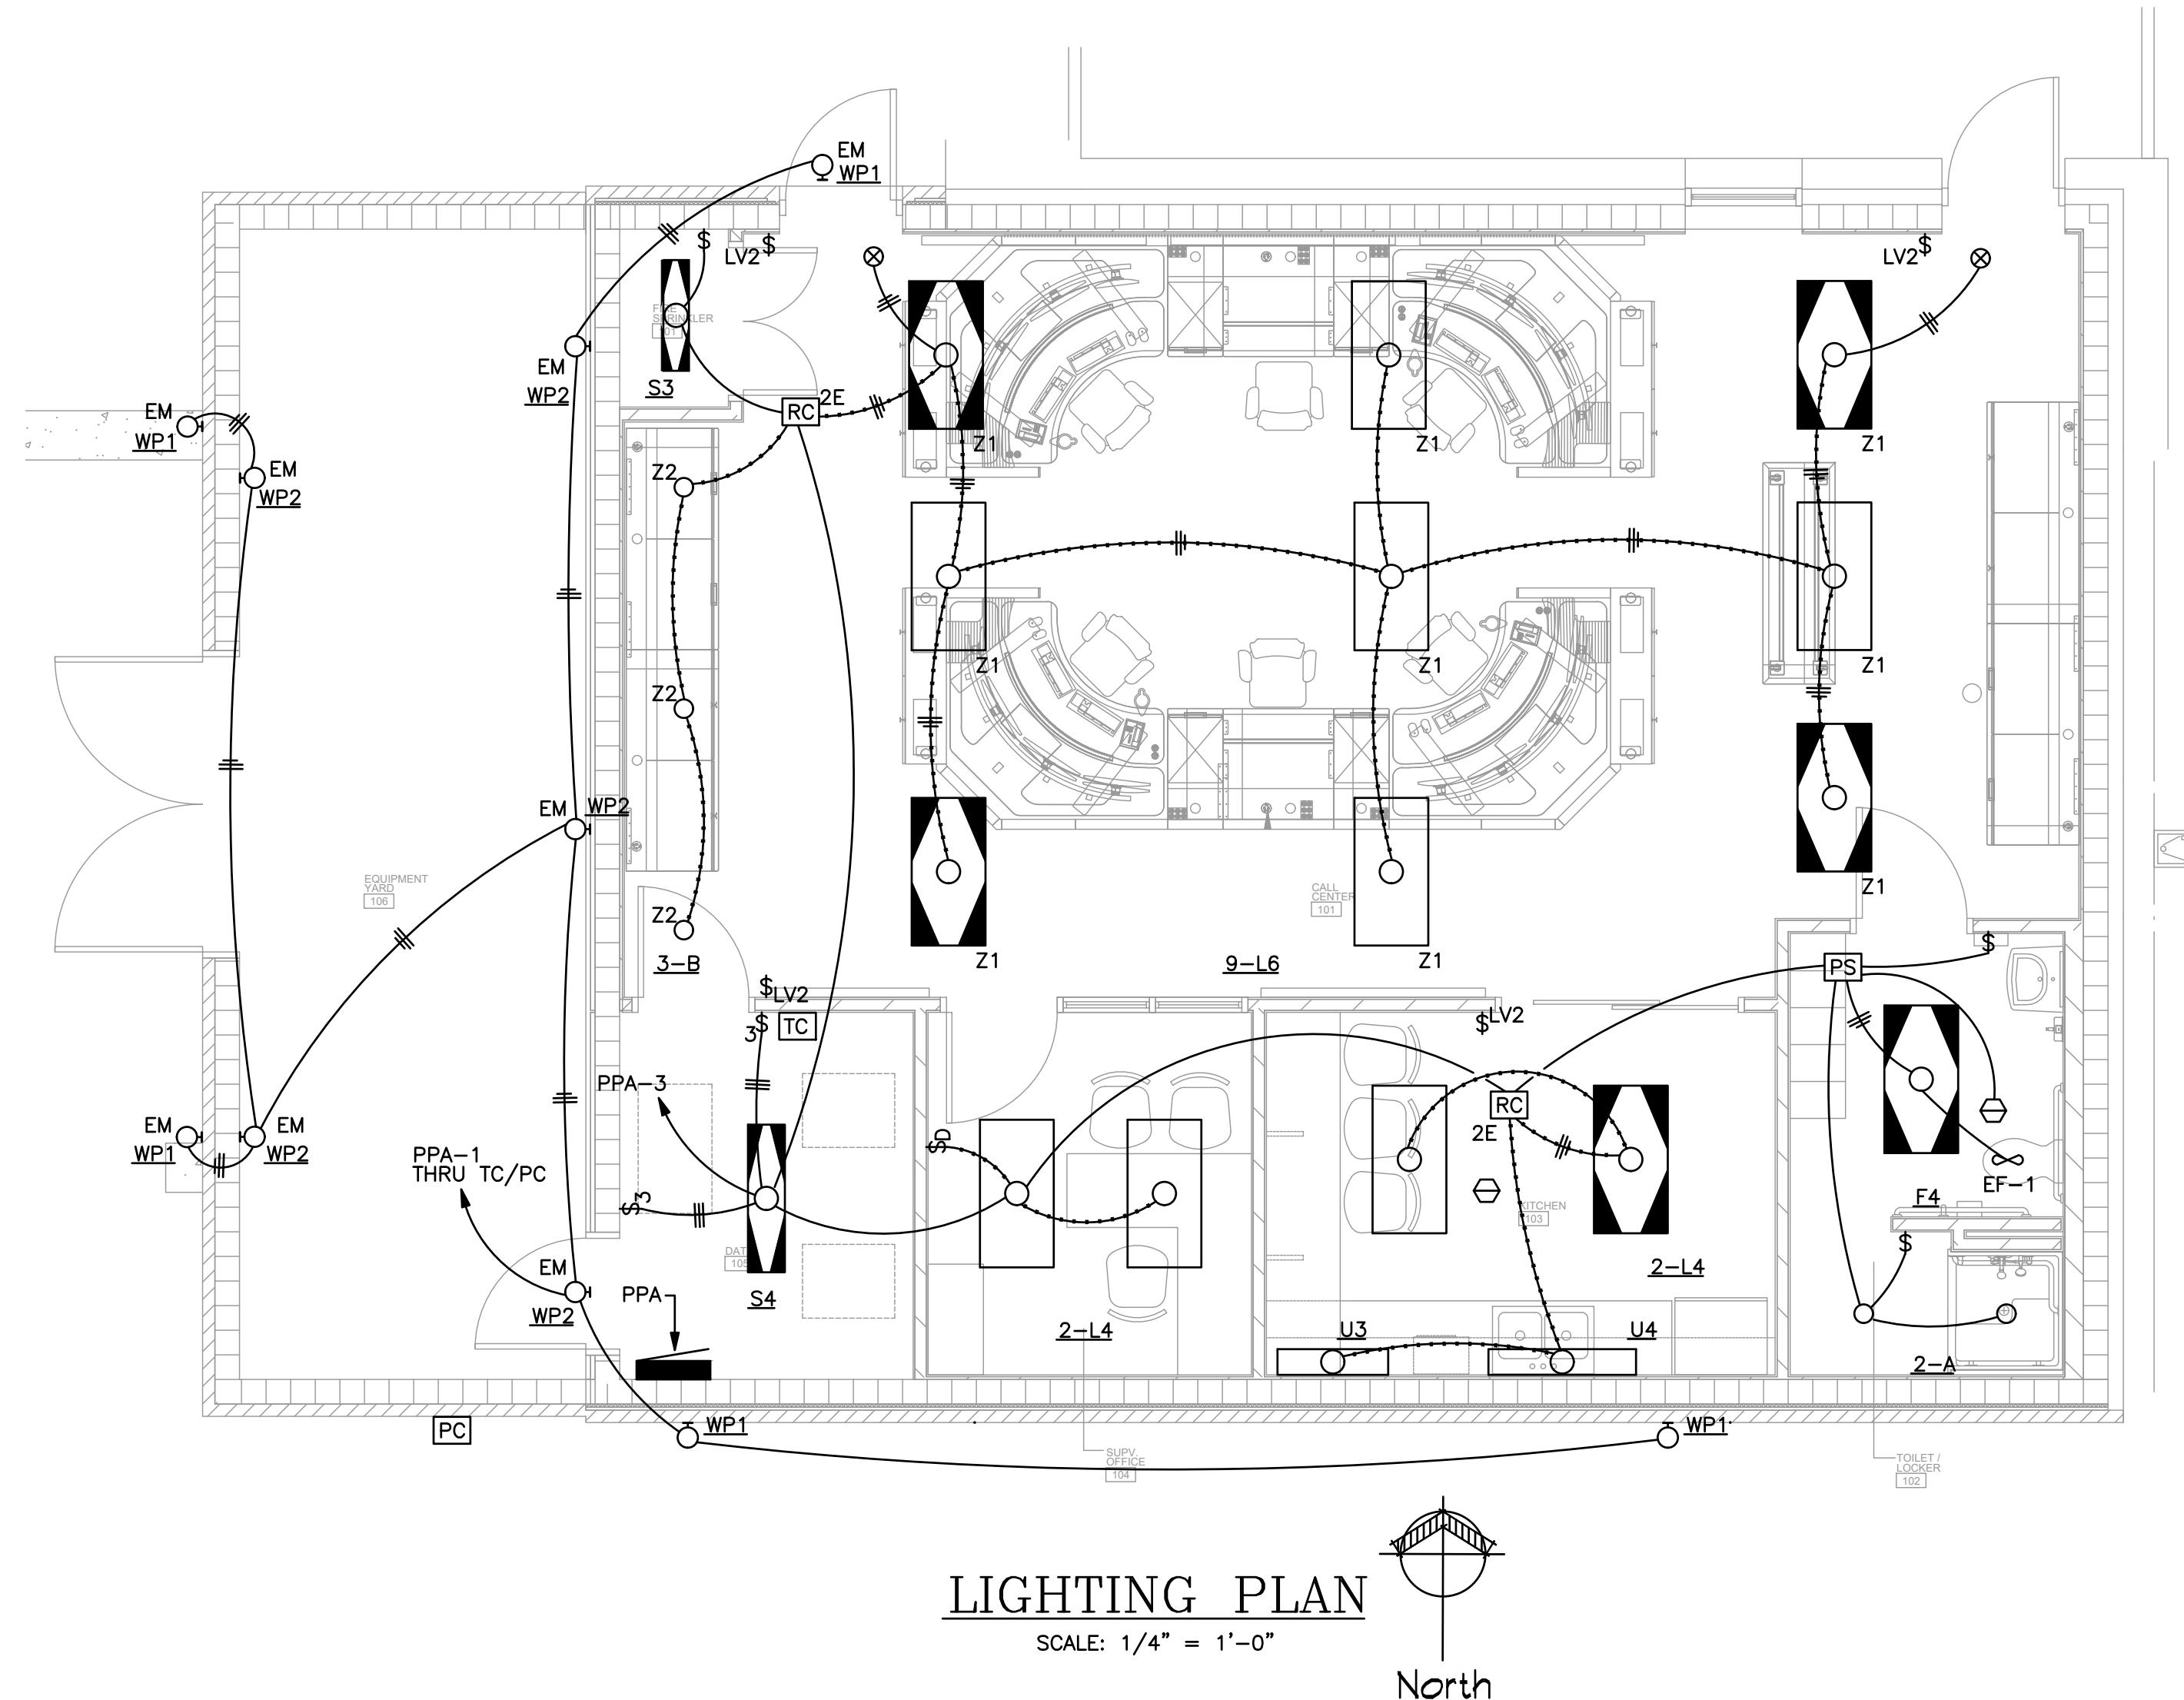

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TALLAPOOSA CO E911 ADDITION TO THE TALLAPOOSA COUNTY JAIL FACILITY
DADEVILLE, AL

CONSTRUCTION DOCUMENTS
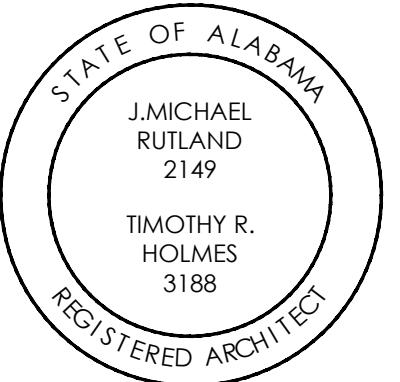
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Sheet Description
LIGHTING PLAN AND DETAILS

Sheet Number





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KEYED NOTES:

1. ALL CONDUITS PENETRATING DATA ROOM WALLS SHALL BE FIRESEALED.
2. INTERFACE WITH ROOM LIGHTING AS REQUIRED. SEE MECHANICAL FOR SEQUENCE OF OPERATION.
3. BORE UNDERNEATH EXISTING PARKING LOT AS REQUIRED TO INSTALL NEW UNDERGROUND CONDUITS AS INDICATED.
4. NEW UTILITY POLE MOUNTED TRANSFORMERS INSTALLED ON EXISTING UTILITY POLE. ROUTE NEW CONDUIT DOWN POLE AND SECURE AS REQUIRED.
5. INSTALL NEW UTILITY PROVIDED COMBINATION METER BASE/CT CABINET ON BUILDING EXTERIOR. COORDINATE EXACT REQUIREMENTS WITH UTILITY.
6. INSTALL NEW 60A/3P, 208V, H.D. SAFETY SWITCH IN A NEMA 3R ENCLOSURE WITH 40A D.E.T.D. FUSES (OR SIZED PER EQUIPMENT MANUFACTURER'S RECOMMENDATIONS), WALL MOUNTED. MAKE ALL CONNECTIONS AS REQUIRED.
7. INSTALL NEW 60A/3P, 208V, H.D. SAFETY SWITCH IN A NEMA 3R ENCLOSURE WITH 30A D.E.T.D. FUSES (OR SIZED PER EQUIPMENT MANUFACTURER'S RECOMMENDATIONS), WALL MOUNTED. MAKE ALL CONNECTIONS AS REQUIRED.
8. #1/0, 3/4" C. TO 3/4" X 10'-0" DRIVEN GROUND ROD.
9. SEE SERVICE ENTRANCE GROUND DETAIL.
10. 4 #4/0 & 1 #4 GND., 2-1/2" C.
11. 4 #4/0 3" C. PROVIDE ONE (1) SPARE 3" C. SPARE CONDUIT FROM RISER POLE TO METER LOCATION ONLY.
12. 3 #6 & 1 #10 GND., 1" C.
13. 3 #8 & 1 #10 GND., 3/4" C.
14. NEW 225A, 120/208V, 3-PHASE TRIPLE SWITCH DOCKING STATION "GDS" IN A NEMA 3R ENCLOSURE, WALL MOUNTED. UNIT TO HAVE EXTRA DEPTH FOR BOTTOM FEED.
15. ONE (1) 5-INCH PVC CONDUIT RACEWAY SLEEVE STUBBED THRU WALL 1'-0" AFF. FOR TEMPORARY CABLING WITH INTEGRAL SCREW CAPS EACH END. SECURE AS REQUIRED.
16. TVSS FOR ATS SHALL BE SURGE SUPPRESSION, INC., SMLB3Y1D3-21 WITH INTEGRAL DISCONNECTING MEANS AND NSI EASY TAPS ON LOAD CONDUCTORS.
17. TVSS FOR PP-A SHALL BE SURGE SUPPRESSION, INC., CKLA3Y1E31-21.
18. CONDUIT ROUTED BEHIND RAISED FLOOR THIS AREA UNLESS OTHERWISE INDICATED.
19. COORDINATE EXACT MOUNTING HEIGHT WITH OWNER'S FURNITURE VENDOR.

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TALLAPOOSA CO E911 ADDITION TO THE TALLAPOOSA COUNTY JAIL FACILITY

DADEVILLE, AL

CONSTRUCTION DOCUMENTS

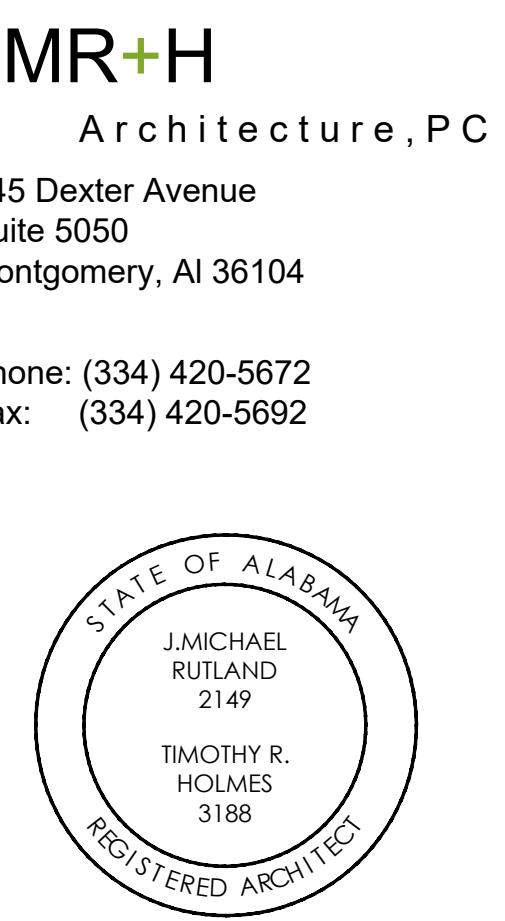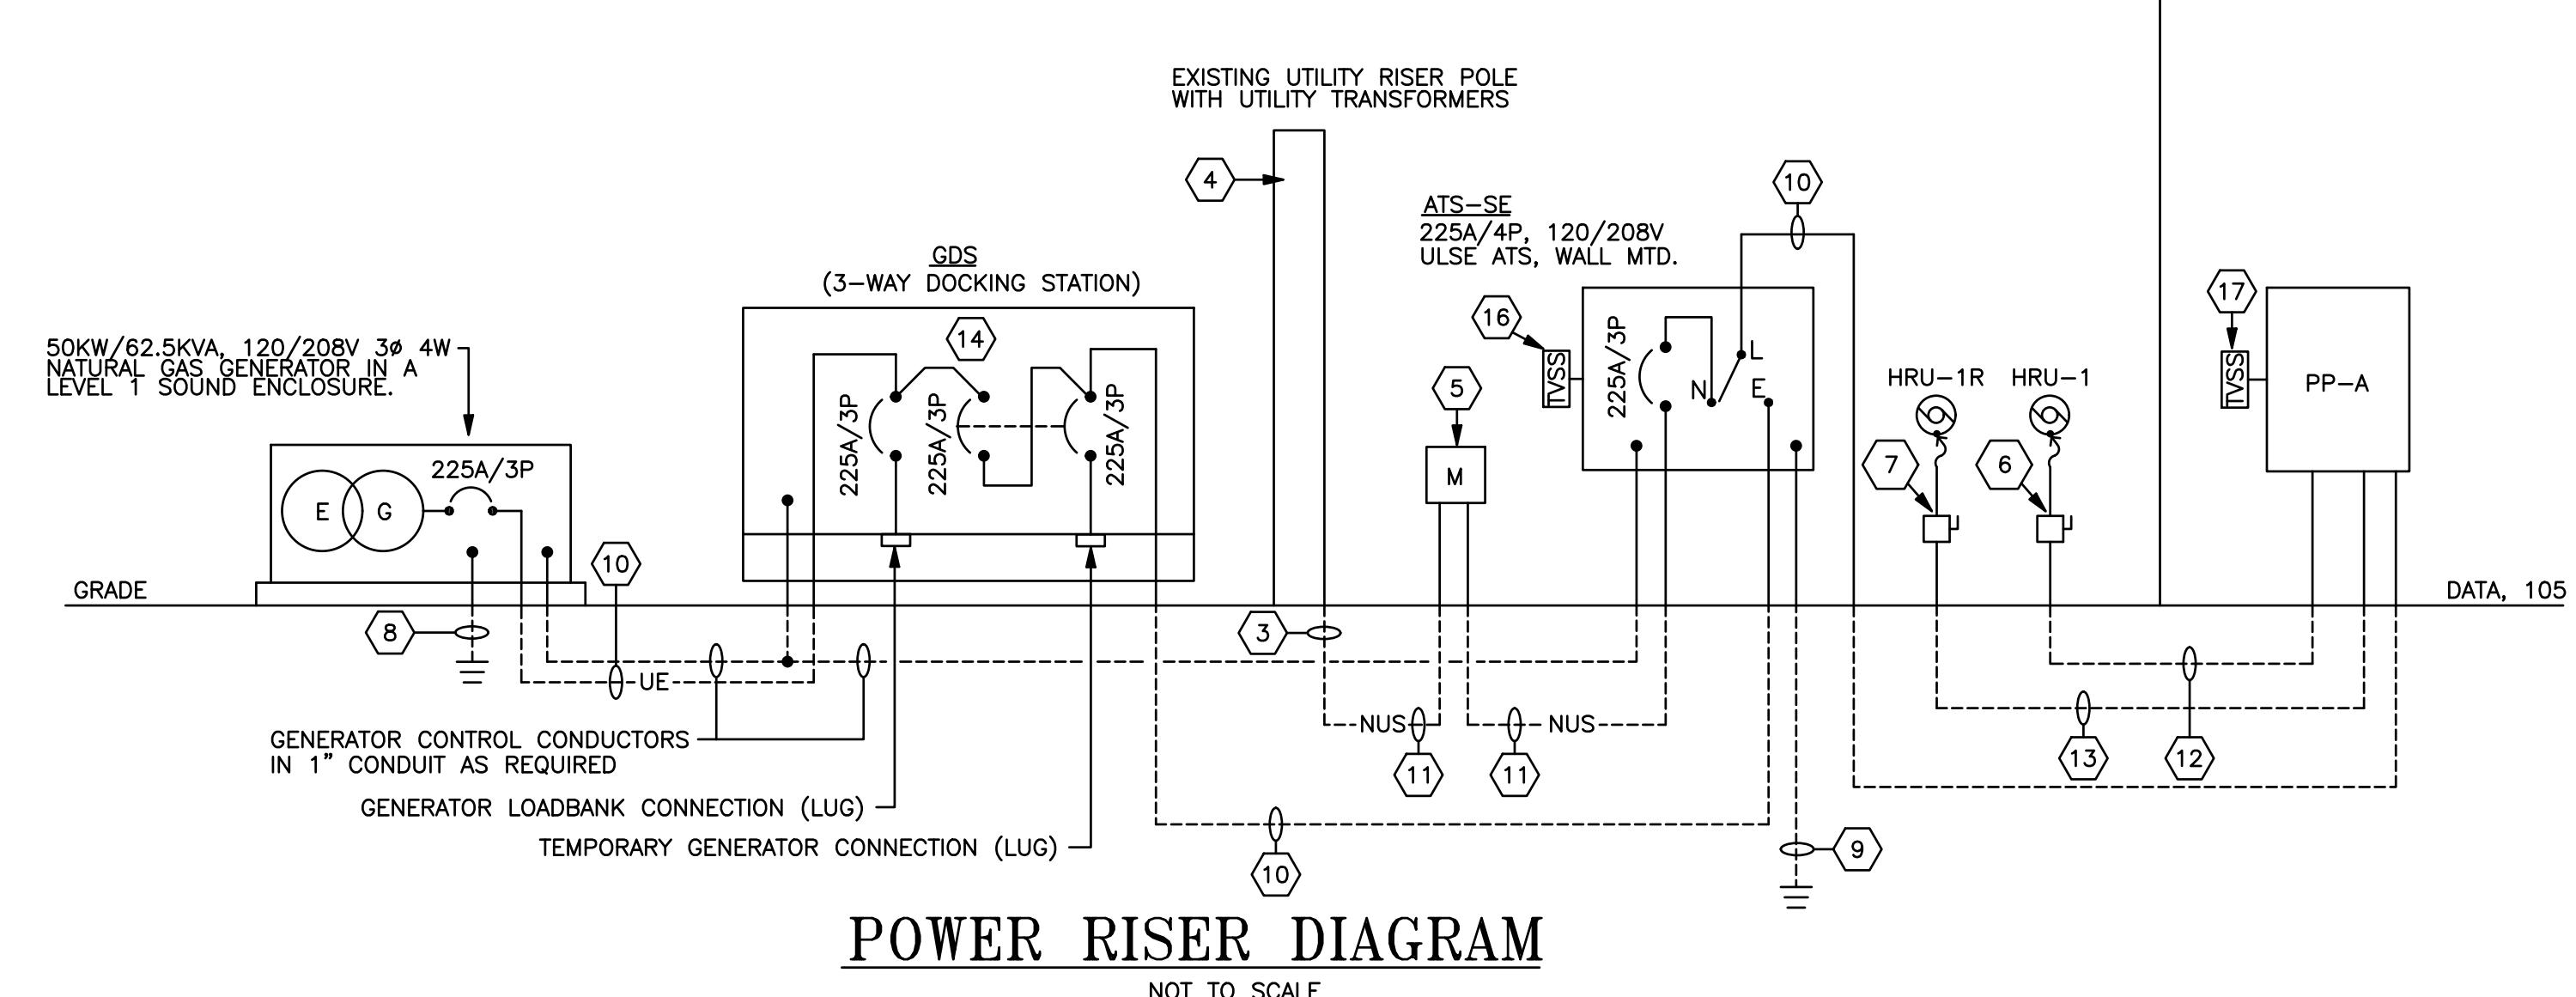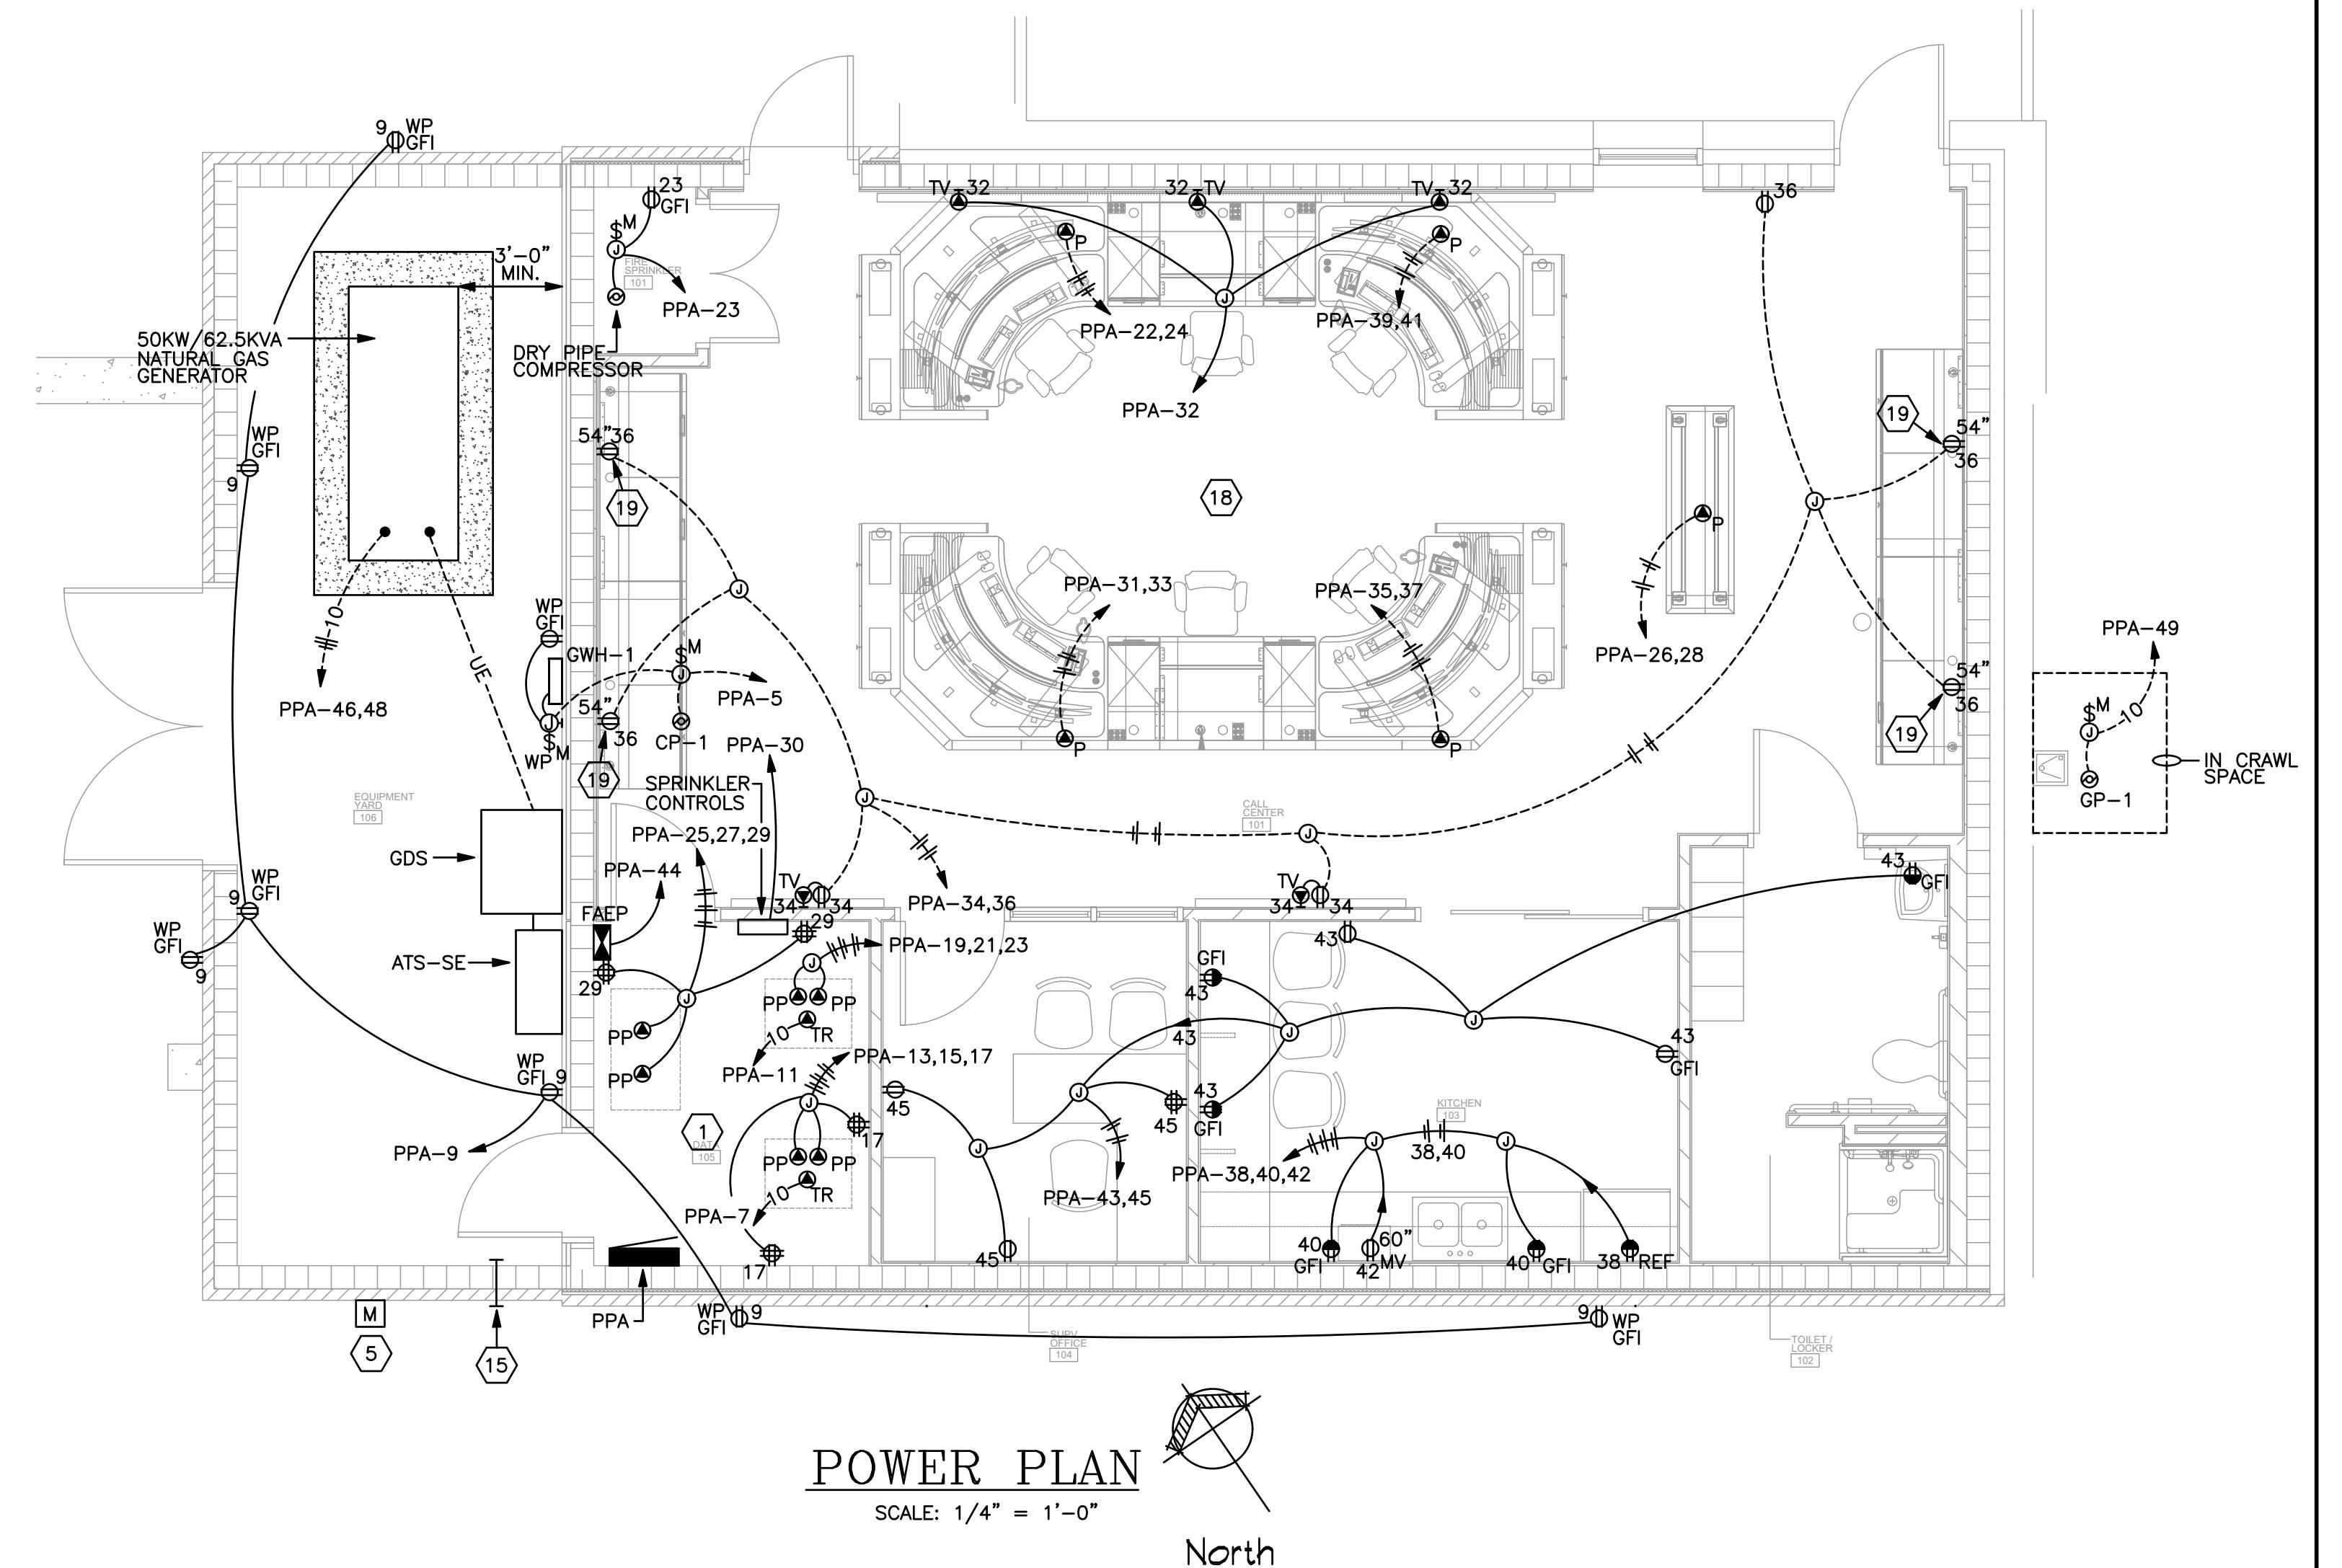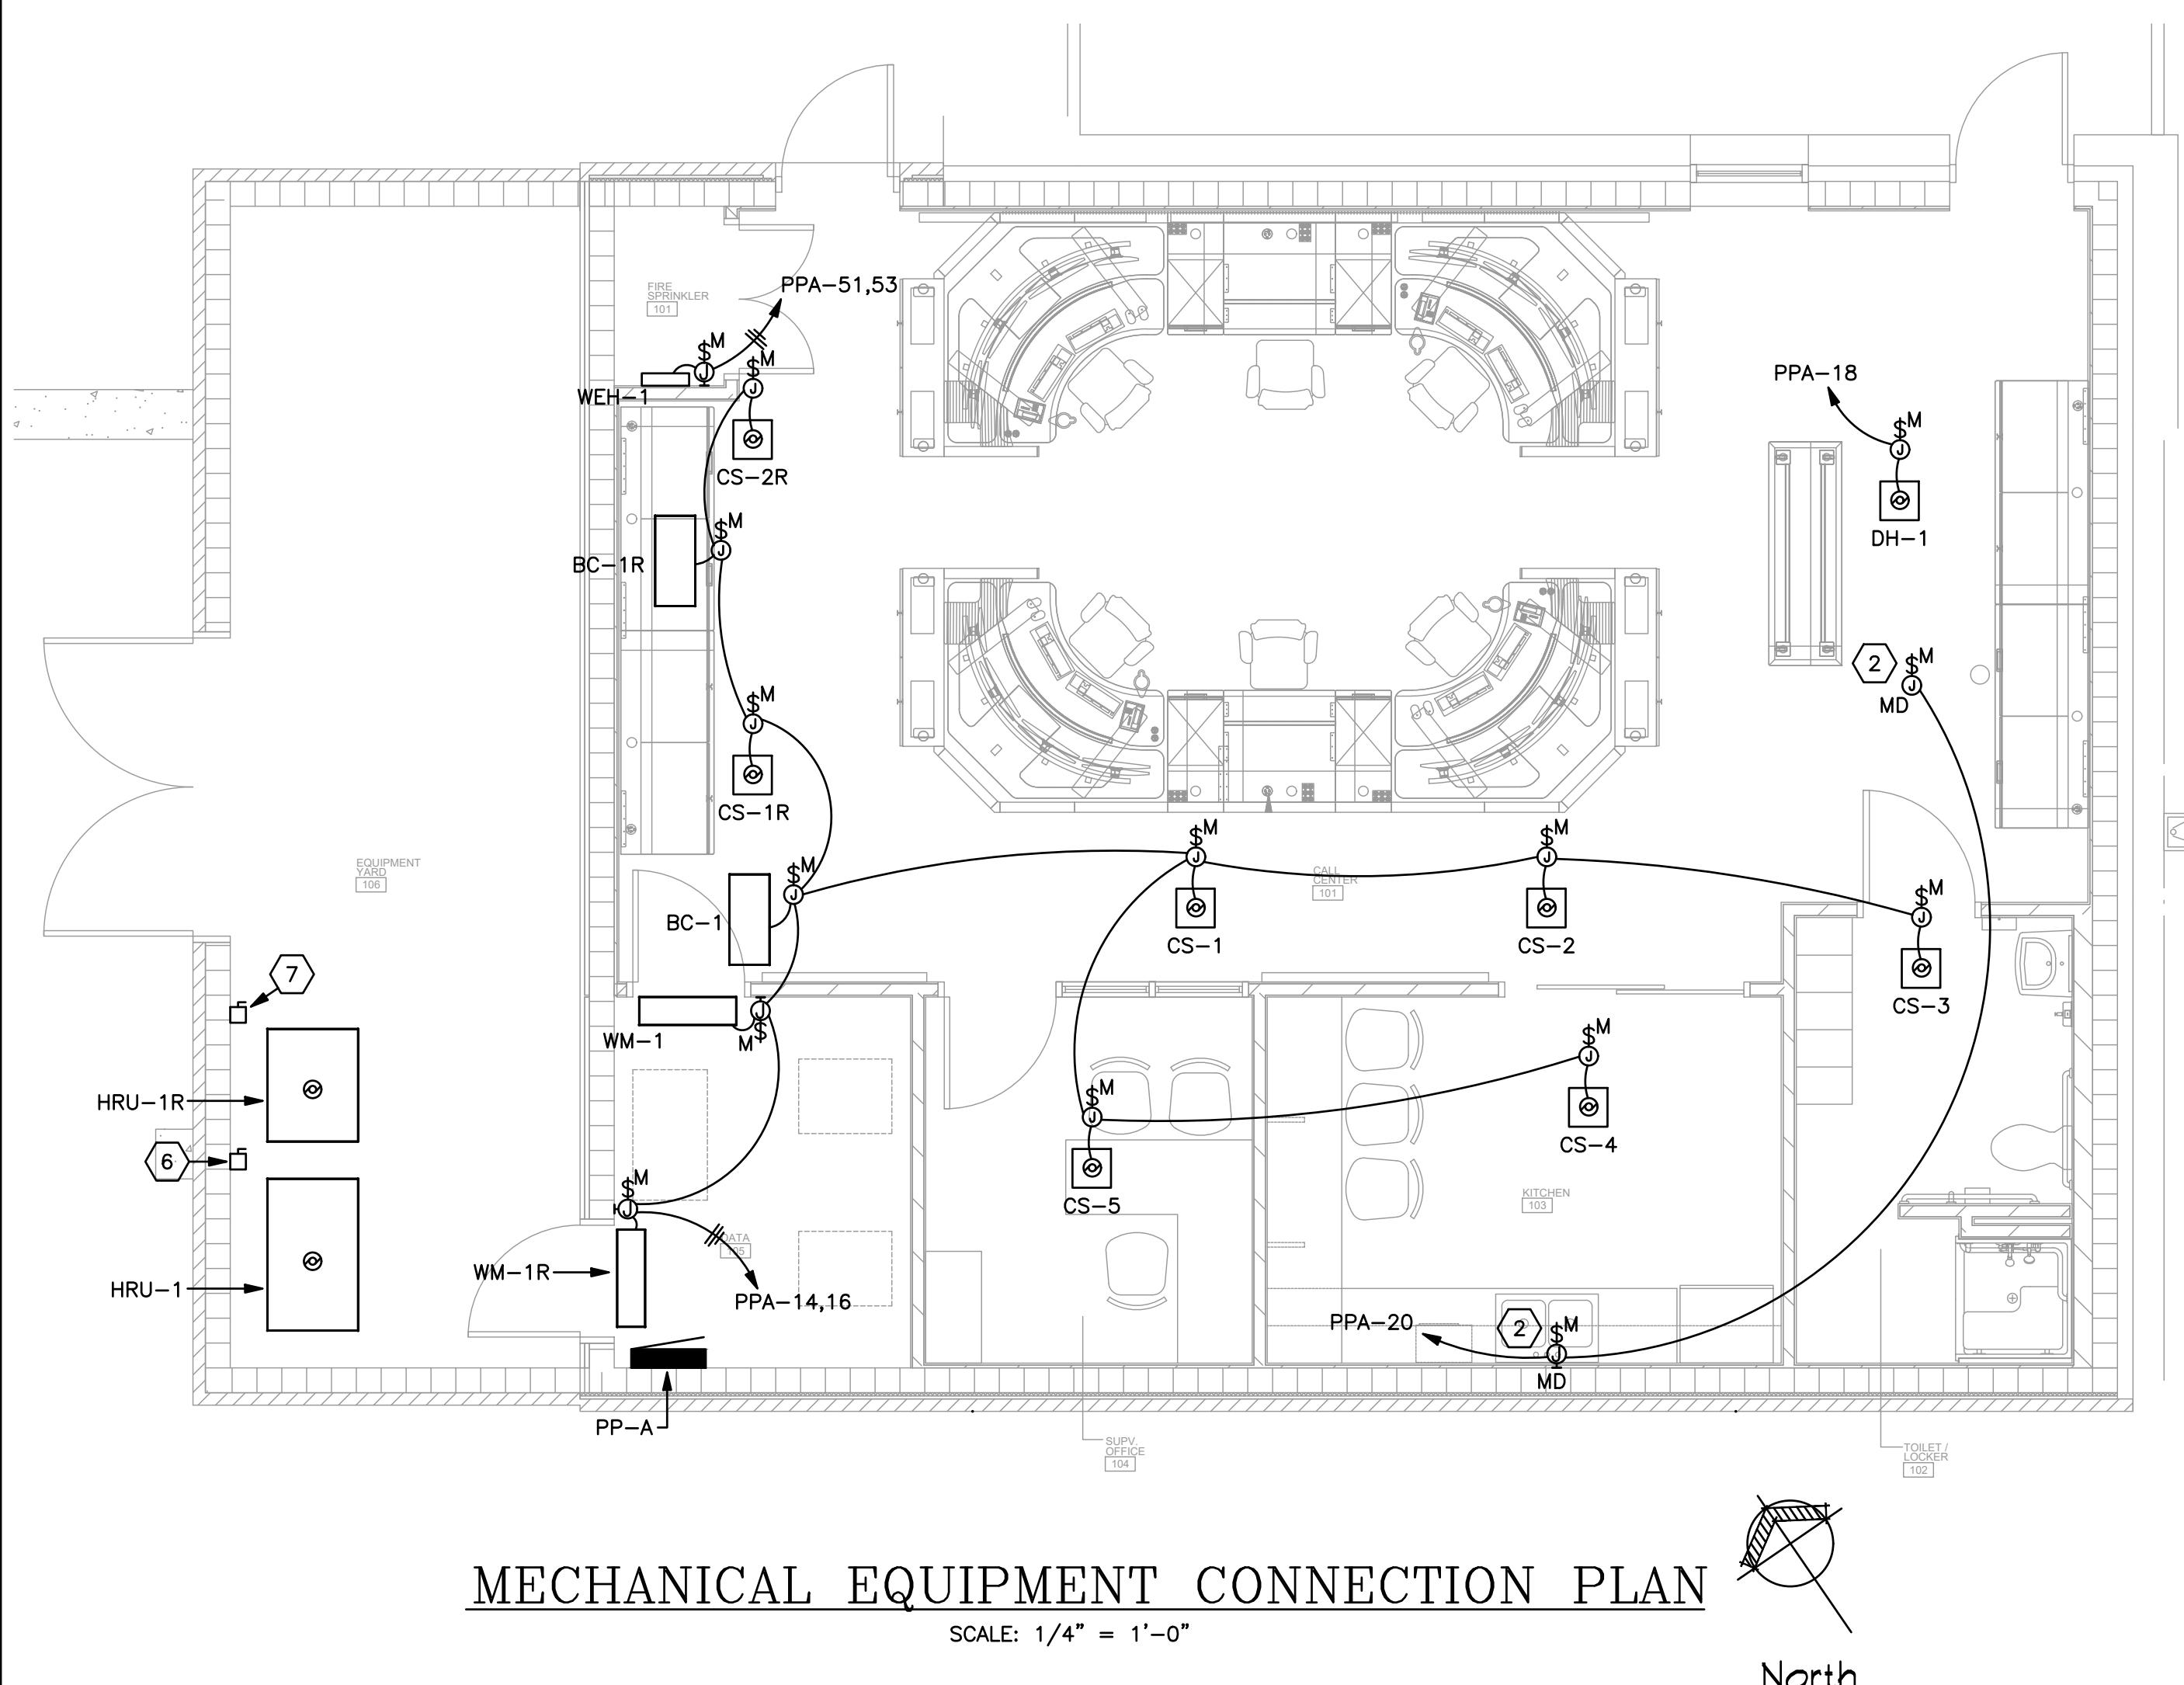Project Number: 25-1465
Date: 8 JANUARY 2026
Revisions:

Sheet Description
POWER PLANS AND POWER RISER DIAGRAM

Sheet Number


E3.1

KEYED NOTES:

- 1 - 2-4" CONDUITS STUBBED THROUGH WALL BELOW RAISED FLOOR AND UP TO A BASKET TRAY IN DATA ROOM. TERMINATE CONDUIT AT EACH CABLE TRAY WITH INSULATED GROUNDING BUSHING BOTH ENDS. CONDUITS SHALL BE FIRESEALED AS THEY PENETRATE WALL INTO DATA ROOM. SEAL AROUND ALL CABLES UPON COMPLETION.
- 2 - PROVIDE COMPLETE GROUNDING AND BONDING SYSTEM THIS AREA FOR RAISED ACCESS FLOORING SUPPORT STRUCTURE AS REQUIRED. BOND BACK TO TGB WITH #6 AWG.
- 3 - ROUTE TWELVE (12) CAT 6 CABLES IN CABLE TRAY FROM PATCH PANEL IN RACK TO CONSOLE LOCATION. TERMINATE CAT 6 CABLES INTO LEVITON 47689-QP PATCH BLOCK IN CONSOLE. COORDINATE EXACT LOCATION WITH OWNER PRIOR TO INSTALLATION.
- 4 - 12-STRAND SINGLE MODE FIBER OPTIC CABLE ROUTED IN 2" C. FROM EXISTING SERVER ROOM RACK IN JAIL TO NEW FIBER PATCH PANEL IN RACK IN DATA ROOM. COORDINATE EXACT LOCATION WITH OWNER PRIOR TO INSTALLATION. PROVIDE ALL NEW FIBER OPTIC PATCH PANELS AND FIBER TRAYS AND MAKE ALL TERMINATIONS AS REQUIRED FOR A COMPLETE AND OPERATIONAL INSTALLATION.
- 5 - 6-STRAND SINGLE MODE FIBER OPTIC CABLE ROUTED IN 2" C. FROM EXISTING DATA ROOM RACK IN JAIL TO NEW FIBER OPTIC PATCH PANEL IN RACK IN DATA ROOM. COORDINATE EXACT LOCATION WITH OWNER PRIOR TO INSTALLATION. PROVIDE ALL NEW FIBER OPTIC PATCH PANELS AND FIBER TRAYS AND MAKE ALL TERMINATIONS AS REQUIRED FOR A COMPLETE AND OPERATIONAL INSTALLATION.
- 6 - INTERFACE AS REQUIRED WITH SPRINKLER CONTROLS FOR A COMPLETE AND OPERATIONAL SYSTEM.
- 7 - ROUTE FOUR (4) SPARE CAT 6 CABLES IN CABLE TRAY FROM PATCH PANEL IN RACK TO FUTURE EQUIPMENT LOCATION. CABLES TO BE COILED UP IN CABLE TRAY WITH 25' SLACK FOR FUTURE TERMINATION.
- 8 - ROUTE TWO (2) CAT 6 CABLES IN 3/4" C. FROM PATCH PANEL IN RACK TO WIRELESS ACCESS POINT LOCATION. TERMINATE CAT 6 CABLES INTO BISCUIT JACK ABOVE CEILING AT WIRELESS ACCESS POINT LOCATION. COORDINATE EXACT LOCATION WITH OWNER PRIOR TO INSTALLATION.
- 9 - SEE ENLARGED PLAN THIS SHEET FOR ADDITIONAL WORK THIS AREA.
- 10 - 10"W X 4" D STEEL BASKET TRAY MOUNTED 8'-0" AFF. UNLESS OTHERWISE DIRECTED BY OWNER.
- 11 - CONDUIT UP TO CABLE TRAY. COORDINATE EXACT LOCATION WITH OWNER PRIOR TO INSTALLATION.
- 12 - TRANSITION CONDUIT FROM PIPE TUNNEL TO BELOW RAISED FLOOR IN NEW ADDITION AS REQUIRED.
- 13 - HORIZONTAL DATA CABLING ROUTED IN CABLE TRAY BEHIND RAISED FLOOR THIS AREA UNLESS OTHERWISE INDICATED.
- 14 - COORDINATE EXACT MOUNTING HEIGHT WITH OWNER'S FURNITURE VENDOR.

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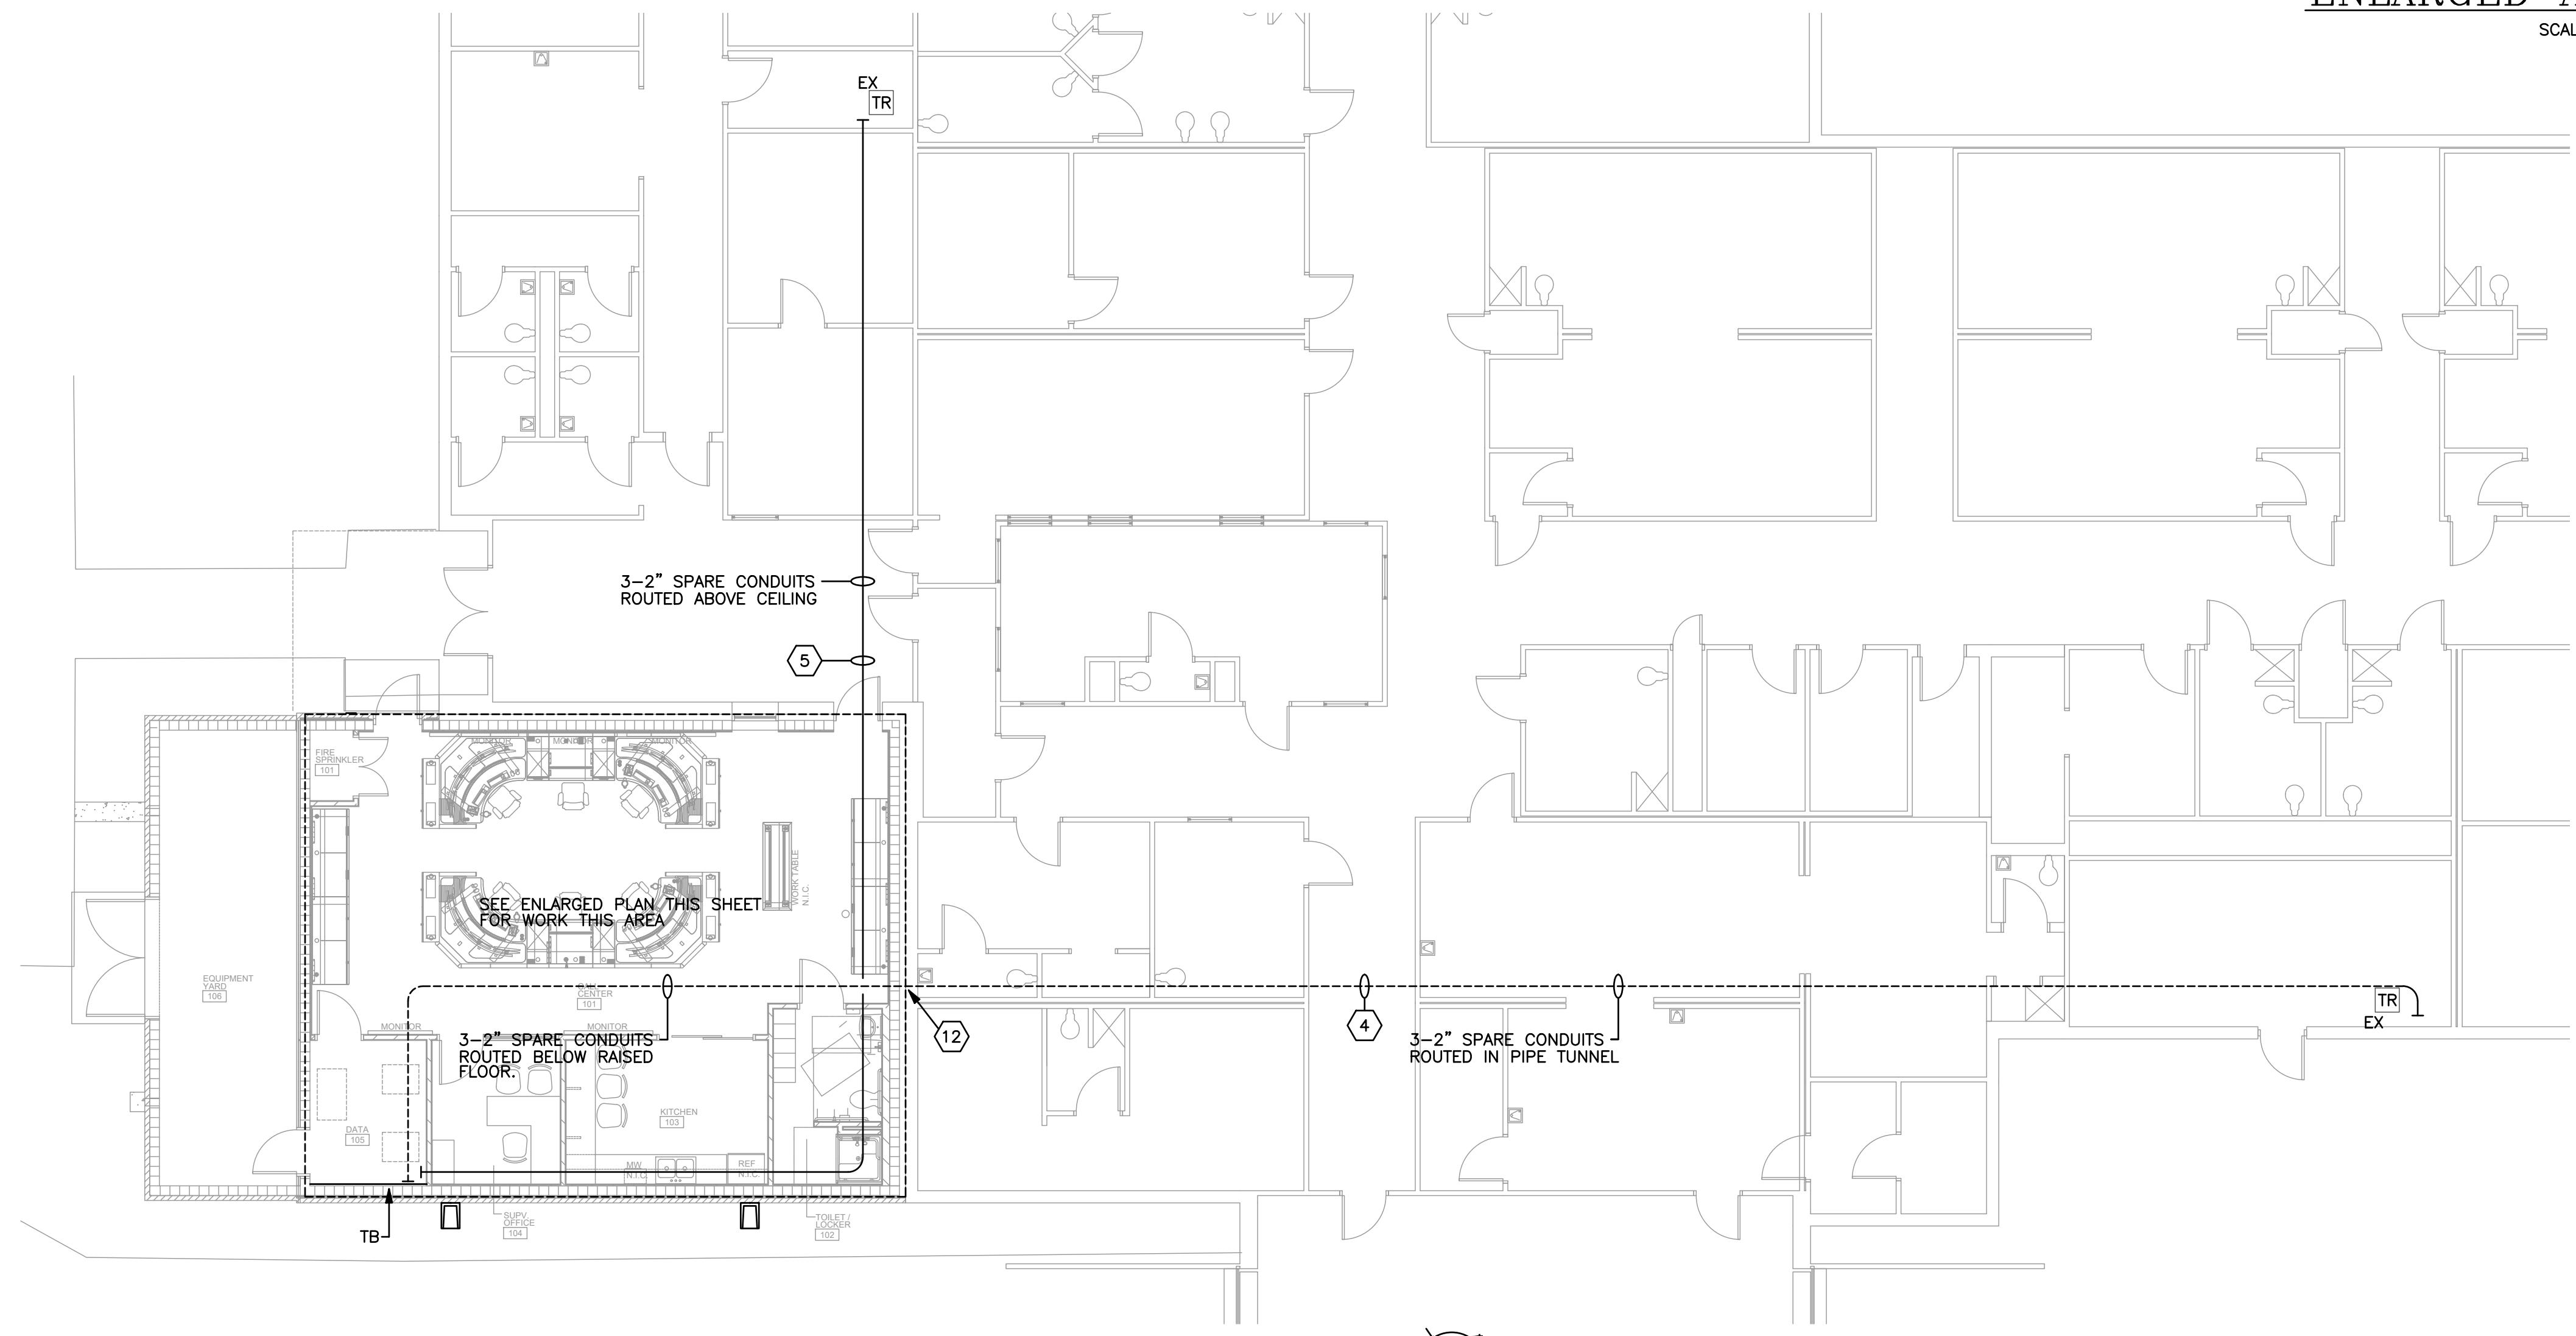
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ENLARGED AUXILIARY PLAN

SCALE: 1/4" = 1'-0"

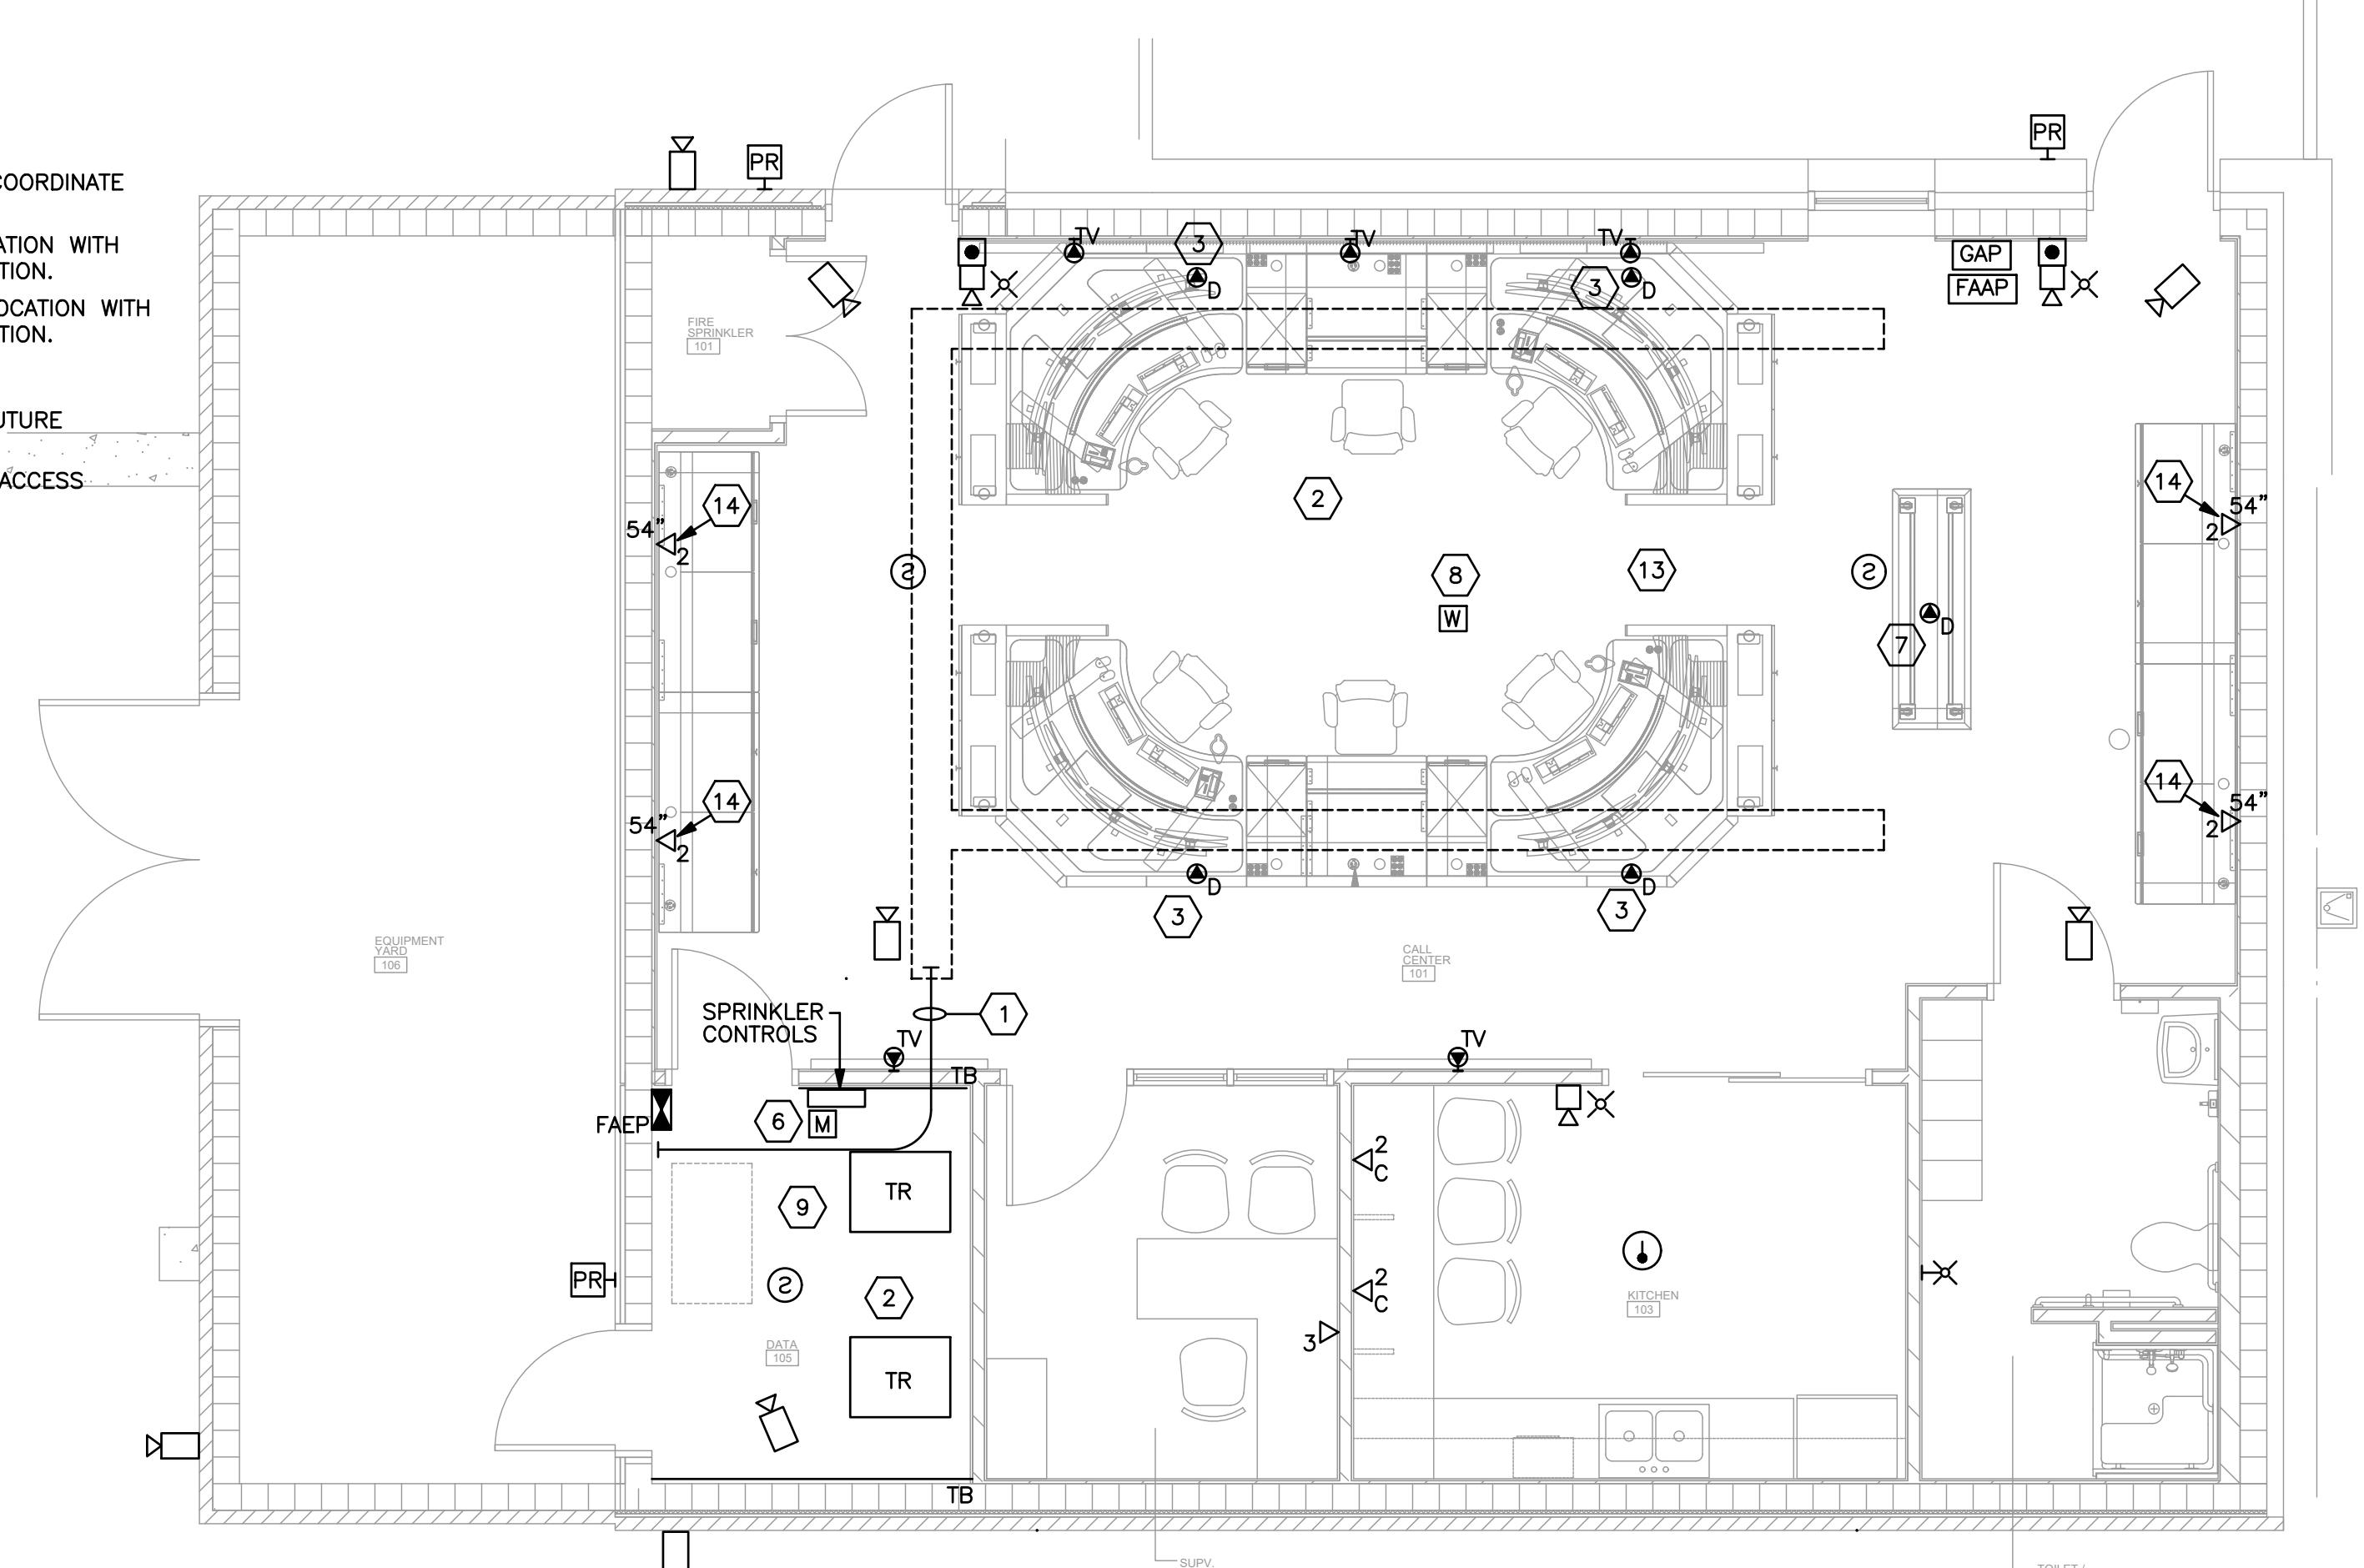
North



AUXILIARY PLAN

SCALE: 1/8" = 1'-0"

North

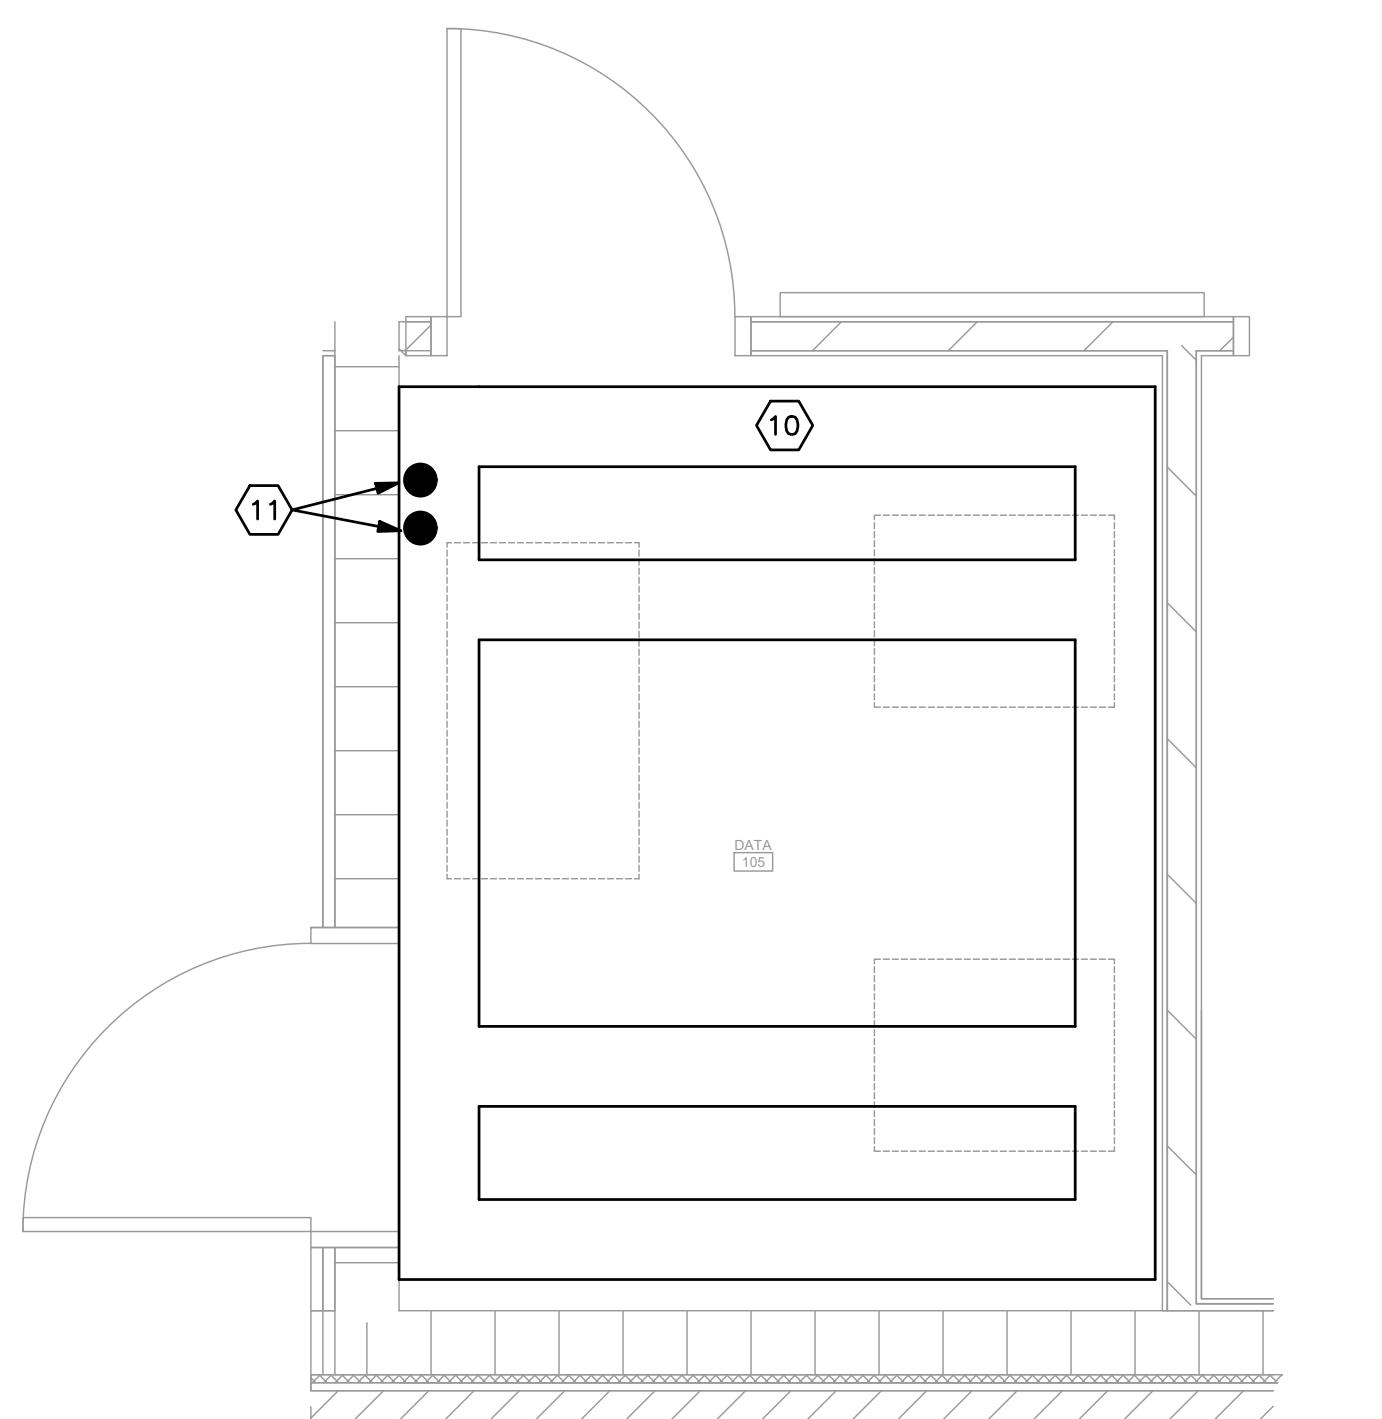

ENLARGED DATA, 108 PLAN

SCALE: 1/2" = 1'-0"

North

E4.1



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**TALLAPOOSA
CO E911
ADDITION TO
THE
TALLAPOOSA
COUNTY JAIL
FACILITY**
DADEVILLE, AL

**CONSTRUCTION
DOCUMENTS**


Project Number: 25-1465
Date: 8 JANUARY 2026
Revisions:

Sheet Description
**AUXILIARY
PLANS**

Sheet Number


KEYED NOTES:

- ① - #2/0 BARE STRANDED COPPER GROUND CONDUCTOR BURIED 2'-6" MINIMUM BELOW GRADE. GROUND CONDUCTOR TO BE 3'-0" FROM THE EXTERIOR WALL. EXOTHERMICALLY WELD TO GROUND ROD AS INDICATED.
- ② - TYPICAL 3/4" X 10'-0" COPPER GROUND ROD AND TEST WELL LOCATION. GROUND ROD/TEST WELL SHALL BE SPACED 15'-0" MAXIMUM BETWEEN EACH OTHER.
- ③ - MAKE CONNECTION TO EXISTING BUILDING GROUND RING WITH EXOTHERMICALLY WELDED CONNECTION. FIELD VERIFY EXACT LOCATION OF EXISTING GROUND RING.
- ④ - MAKE CONNECTION TO NEW MAIN EQUIPMENT GROUND BUS WITH DOUBLE LUG CRIMP CONNECTION.
- ⑤ - #2/0 JACKETED STRANDED COPPER GROUND CONDUCTOR IN NONMETALLIC CONDUIT. MAKE CONNECTION TO NEW MAIN EQUIPMENT GROUND BUS WITH DOUBLE LUG CRIMP CONNECTION.
- ⑥ - BOND ALL METALLIC EQUIPMENT IN YARD TO SBB WITH #6 JACKETED STRANDED COPPER GROUND CONDUCTOR WITH DOUBLE LUG CONNECTORS. CONDUCTORS TO BE ROUTED IN NONMETALLIC CONDUIT WHERE EXPOSED.
- ⑦ - BOND EACH SECTION OF THE ROOF PROTECTIVE GRID ON TOP OF MECHANICAL YARD TO THE ADJOINING PANEL WITH HOMERUN TO SBB WITH #6 JACKETED STRANDED COPPER GROUND CONDUCTOR WITH DOUBLE LUG CONNECTORS. CONDUCTORS TO BE ROUTED IN NONMETALLIC CONDUIT WHERE EXPOSED.
- ⑧ - #2/0 JACKETED STRANDED COPPER GROUND CONDUCTOR IN NONMETALLIC CONDUIT TO SBB UNDER RAISED FLOOR. MAKE CONNECTION TO NEW MAIN EQUIPMENT GROUND BUS WITH DOUBLE LUG CRIMP CONNECTION.
- ⑨ - #2 INSULATED CU PERIMETER BONDING BUS "PBB" CONDUCTOR INSTALLED AT CABLE TRAY HEIGHT AROUND PERIMETER OF ROOM WITH INSULATED STANDOFF CLAMPS 2'-0" O.C. AND BONDED BACK TO TGB WITH DOUBLE LUG CRIMPED CONNECTOR. BOND ALL METALLIC COMPONENTS INCLUDING DOOR JAMB TO "PBB" WITH DOUBLE LUG CRIMPED AND COPPER "C" CRIMPED CONNECTORS. "PBB" SHALL BE OPEN ON FAR CORNER AND NOT CONNECTED TO ITSELF. SEE "PBB" DETAIL THIS SHEET.
- ⑩ - #6 SOLID CU GROUND CONDUCTOR BONDED TO EVERY FOURTH RAISED FLOOR SUPPORT PEDESTAL WITH BIMETALLIC CLAMP. BOND BACK TO SBB BELOW RAISED FLOOR THIS AREA. SEE DETAIL THIS SHEET.
- ⑪ - ALL GROUNDING TO CONFORM TO MOTOROLA R56-2017 STANDARD.

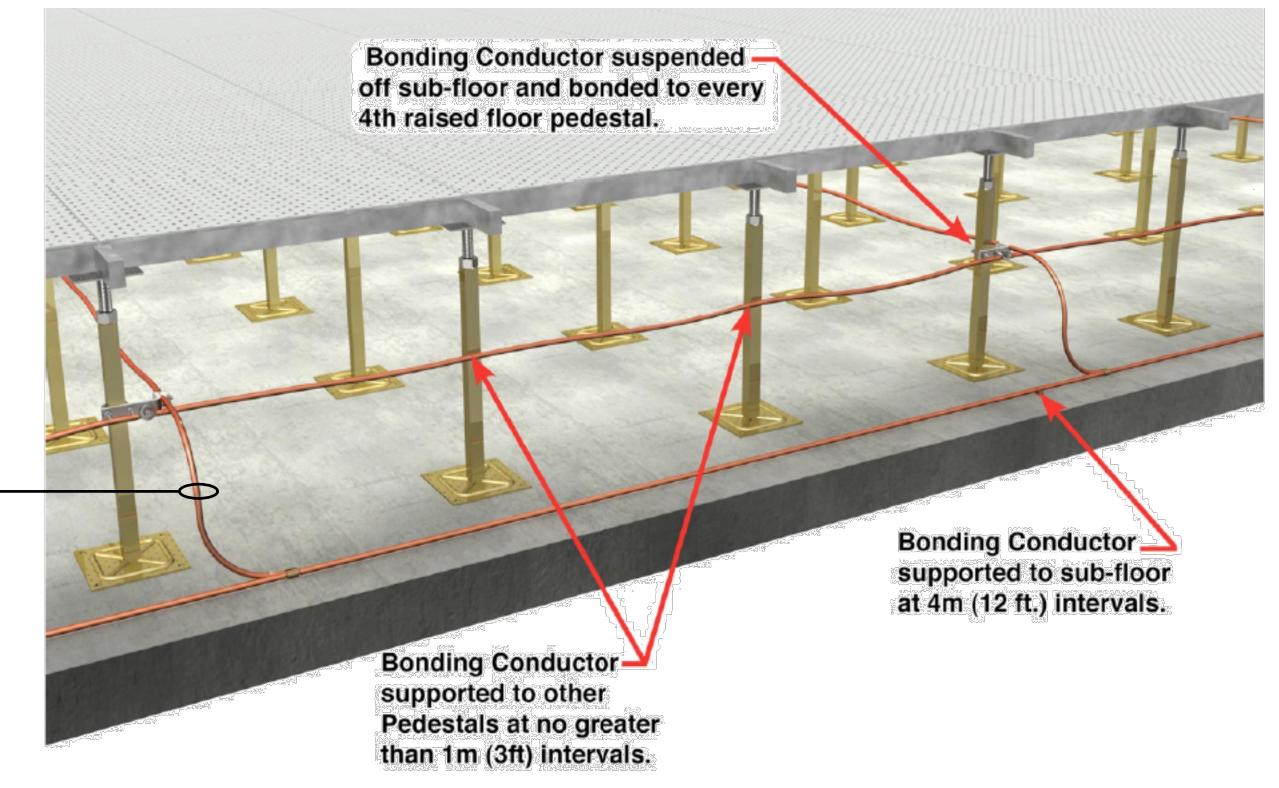

RAISED FLOOR BONDING DETAIL

NOT TO SCALE

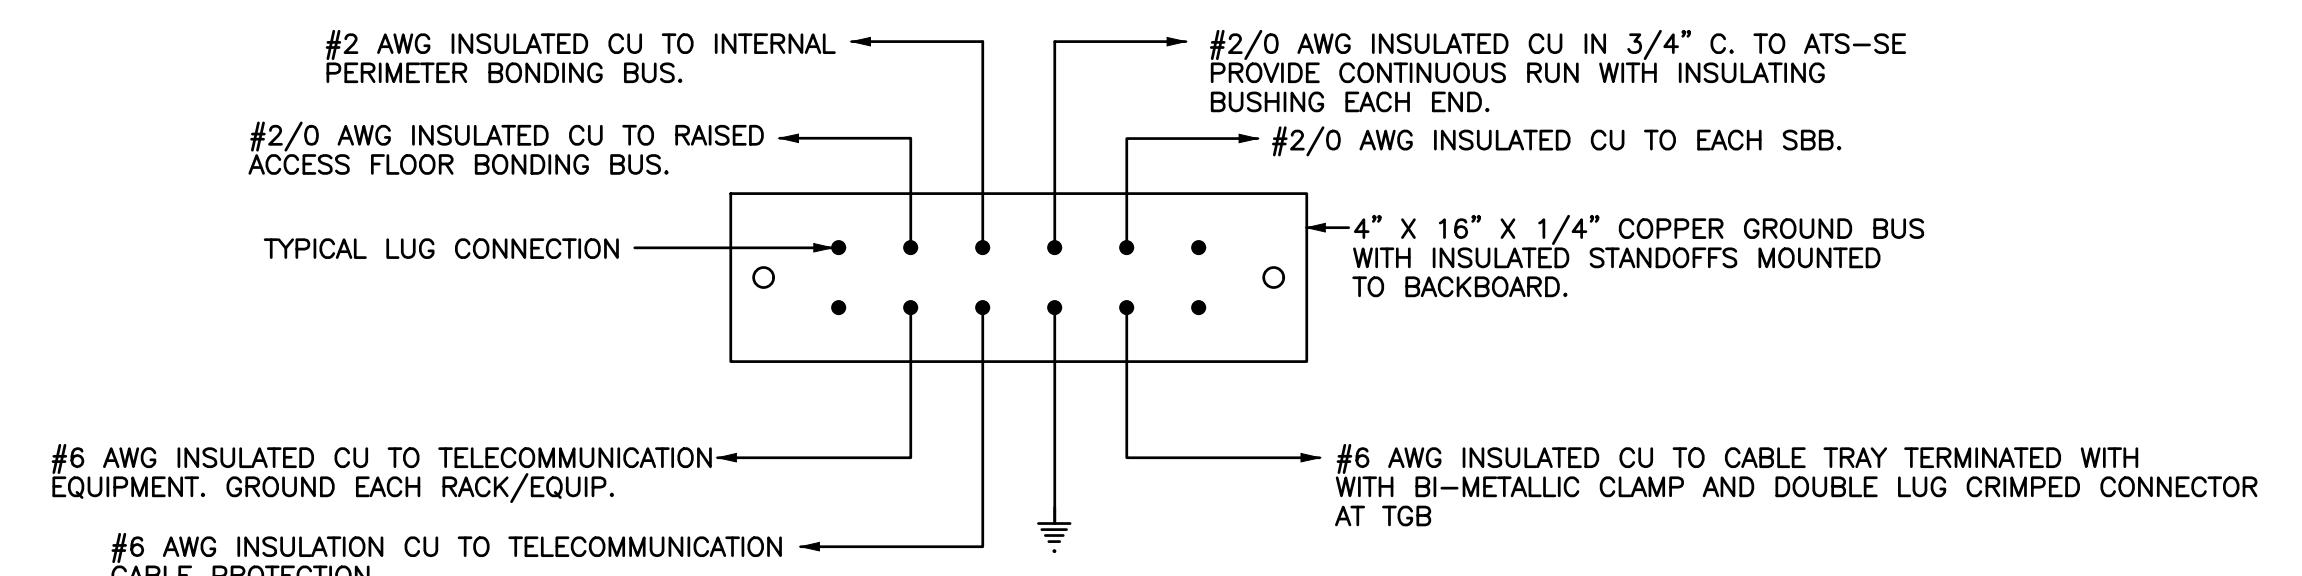


MAIN EQUIPMENT GROUND BUS (MGB)

NO SCALE



NOTES:

1. "MGB" SHALL BE HARGER GBIA14416M OR APPROVED EQUAL.
2. "TGB" AND UNDERFLOOR "SBB" SHALL BE HARGER GBIA14412M OR APPROVED EQUAL.
3. ALL "TGB" HARDWARE CONNECTIONS SHALL BE STAINLESS STEEL.
4. OUTDOOR EQUIPMENT YARD "SBB" SHALL BE HARGER TGBIA14412M OR APPROVED EQUAL.

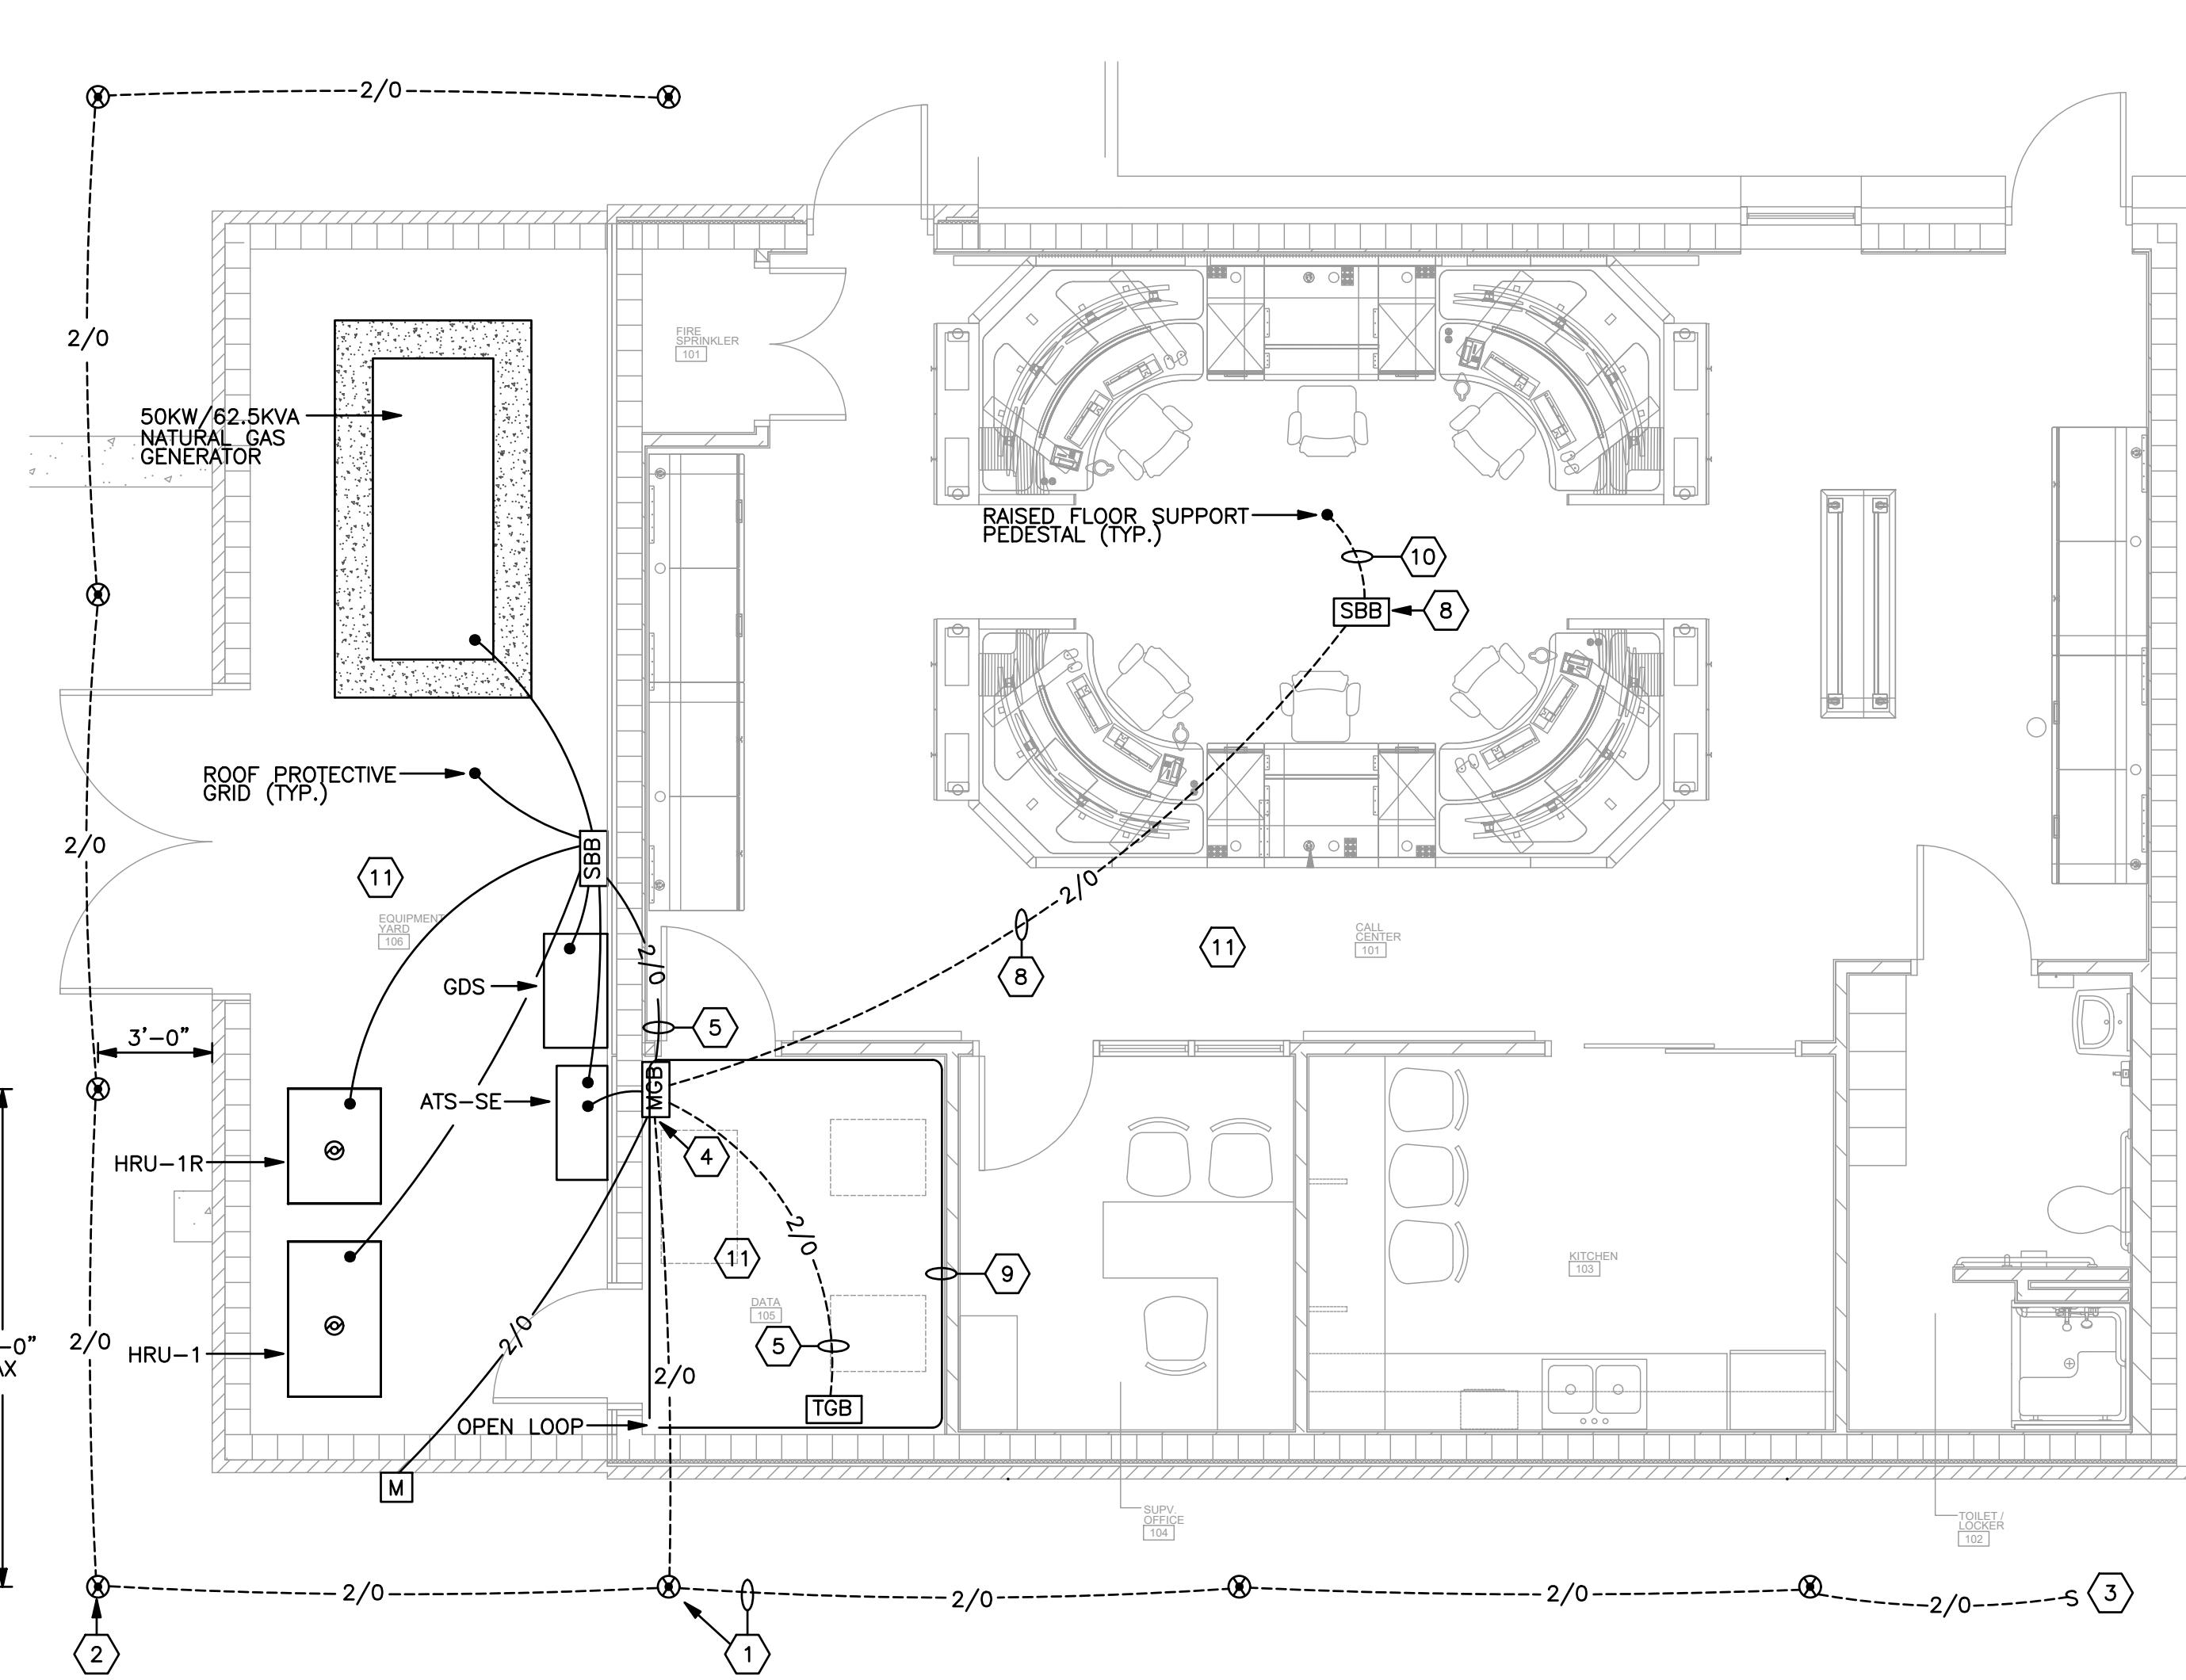



ENLARGED GROUNDING PLAN

SCALE: 1/4" = 1'-0"

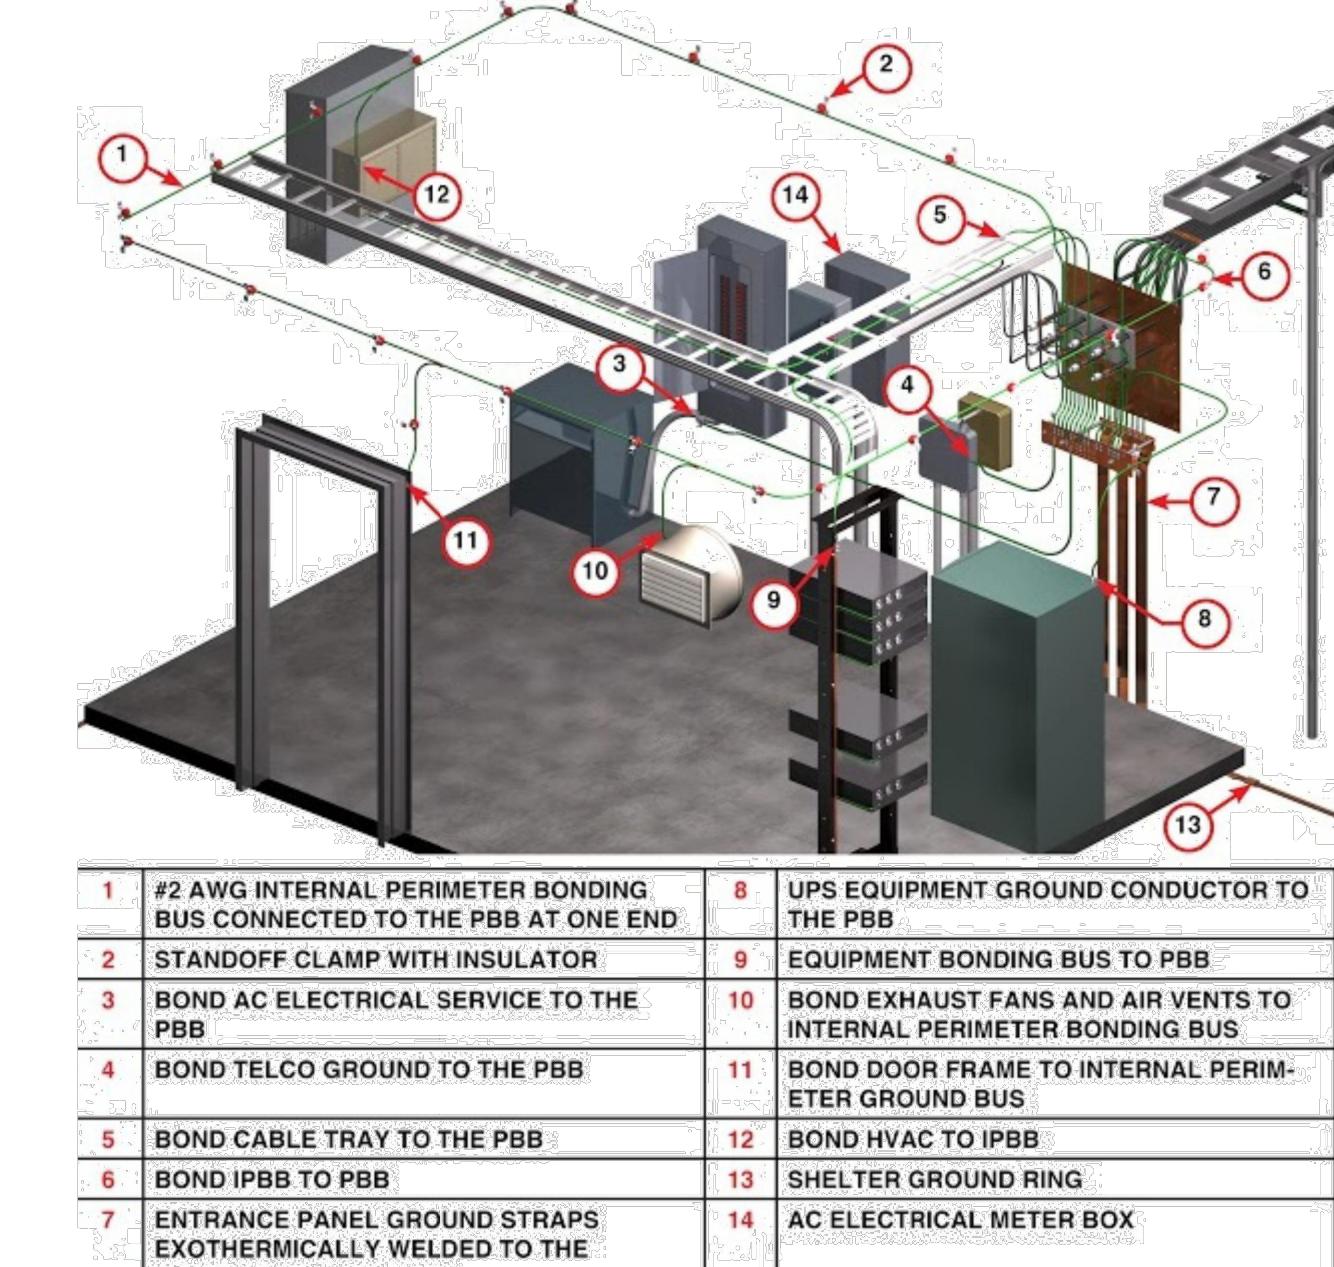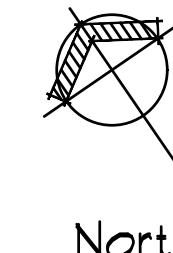

PERIMETER BONDING BUS DETAIL

NOT TO SCALE

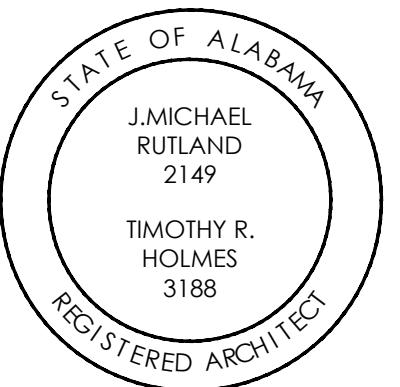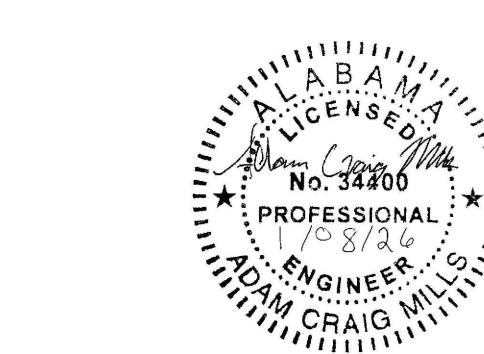

TALLAPOOSA CO E911 ADDITION TO THE TALLAPOOSA COUNTY JAIL FACILITY

DADEVILLE, AL

CONSTRUCTION DOCUMENTS


Project Number: 25-1465
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Revisions:

Sheet Description

GROUNDING PLAN AND DETAILS

Sheet Number

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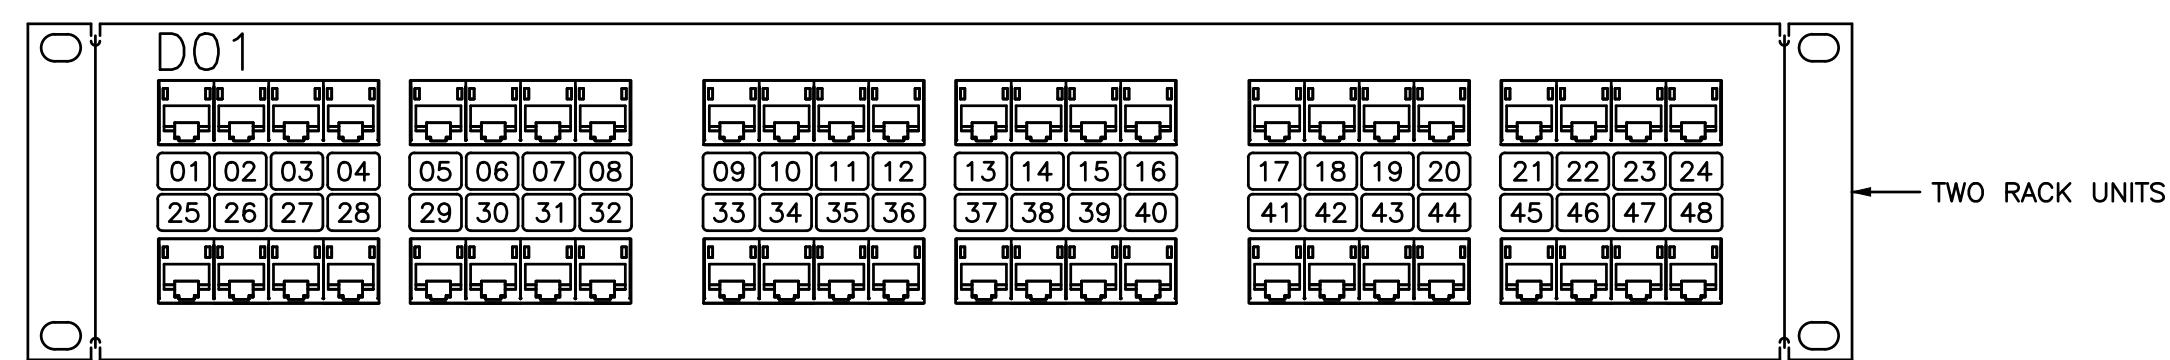


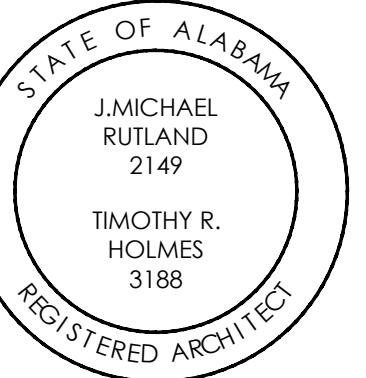**TALLAPOOSA
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DADEVILLE, AL


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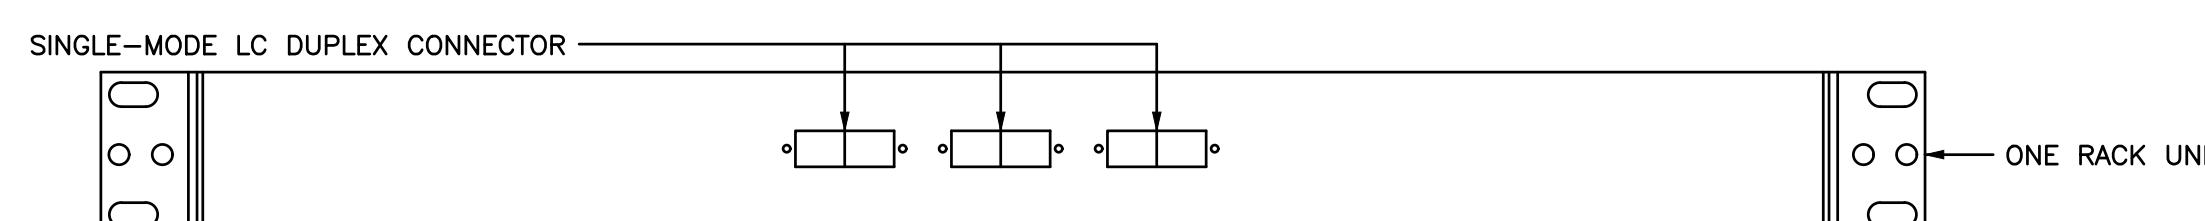
**TYPICAL 48 PORT CAT 6 PATCH PANEL DETAIL**

NO SCALE


NOTE: LEVITON 49256-H48 QUCKPORT CAT6 ANGLED PATCH PANEL.


**TYPICAL 12 PORT FIBER OPTIC PATCH PANEL DETAIL**

NO SCALE

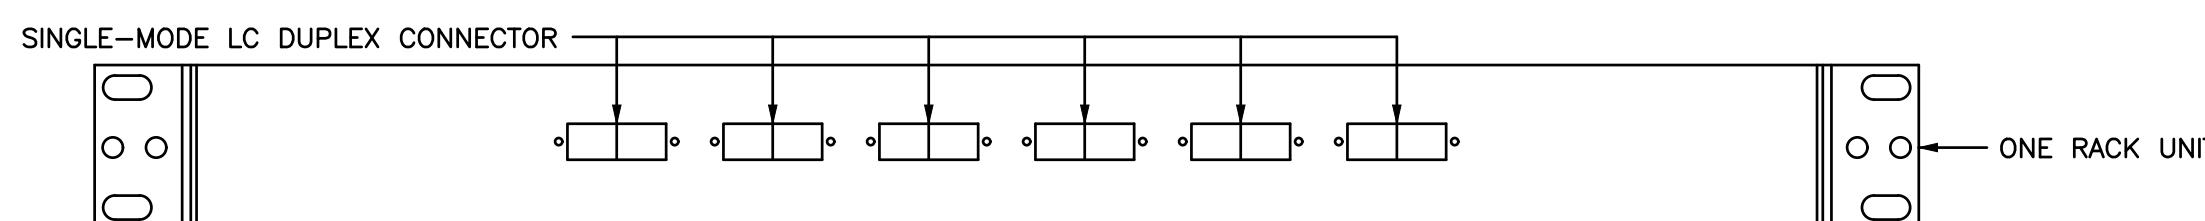**TYPICAL 6 PORT FIBER OPTIC PATCH PANEL DETAIL**

NO SCALE

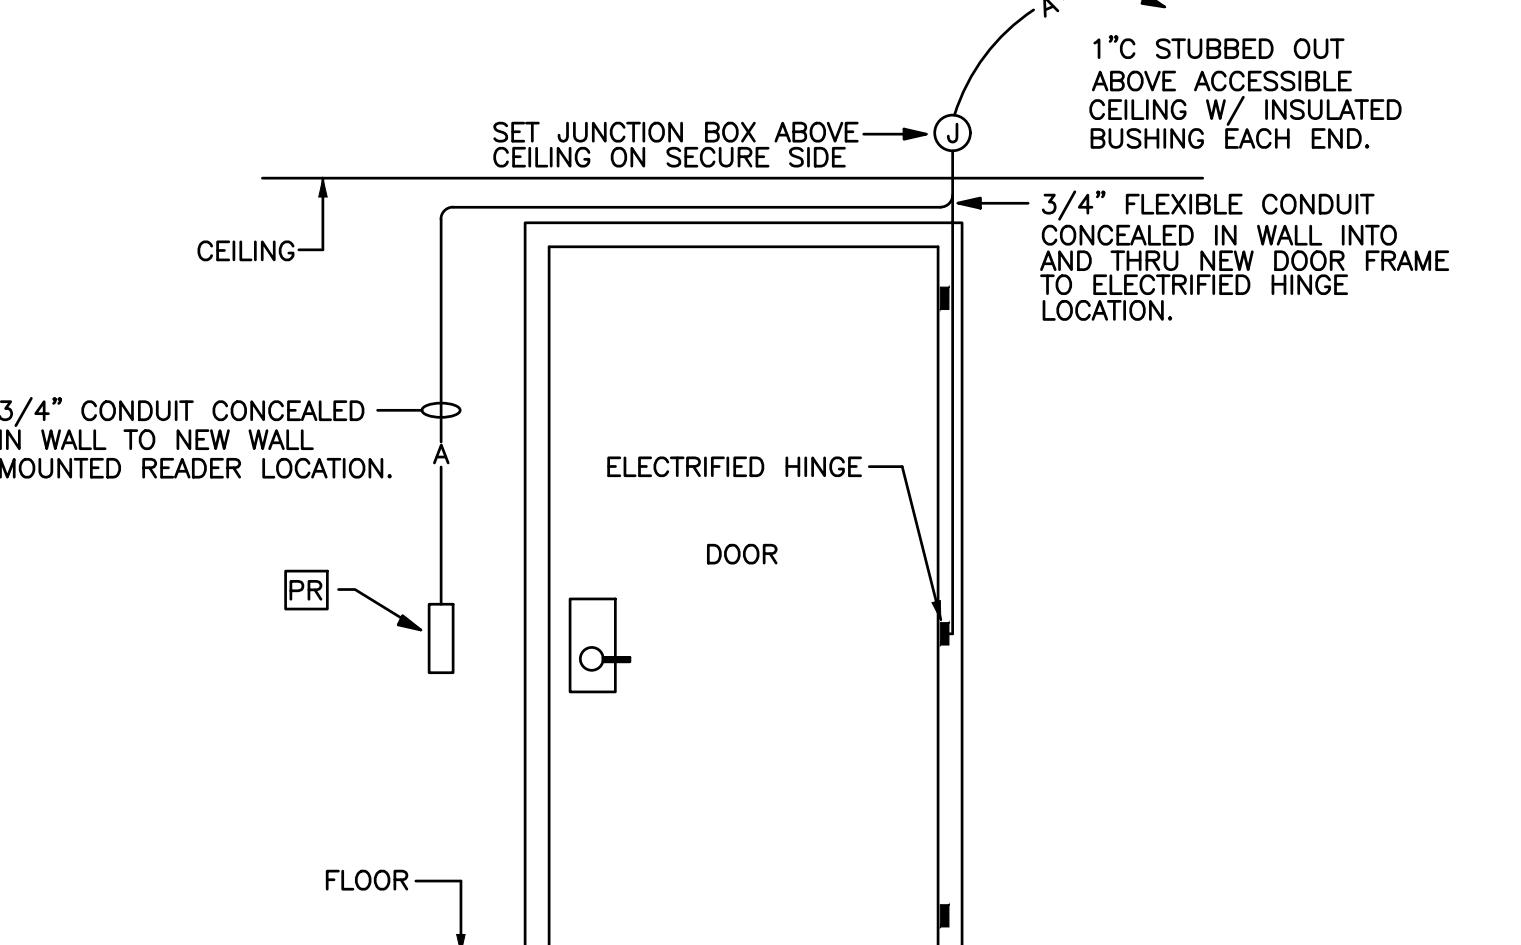

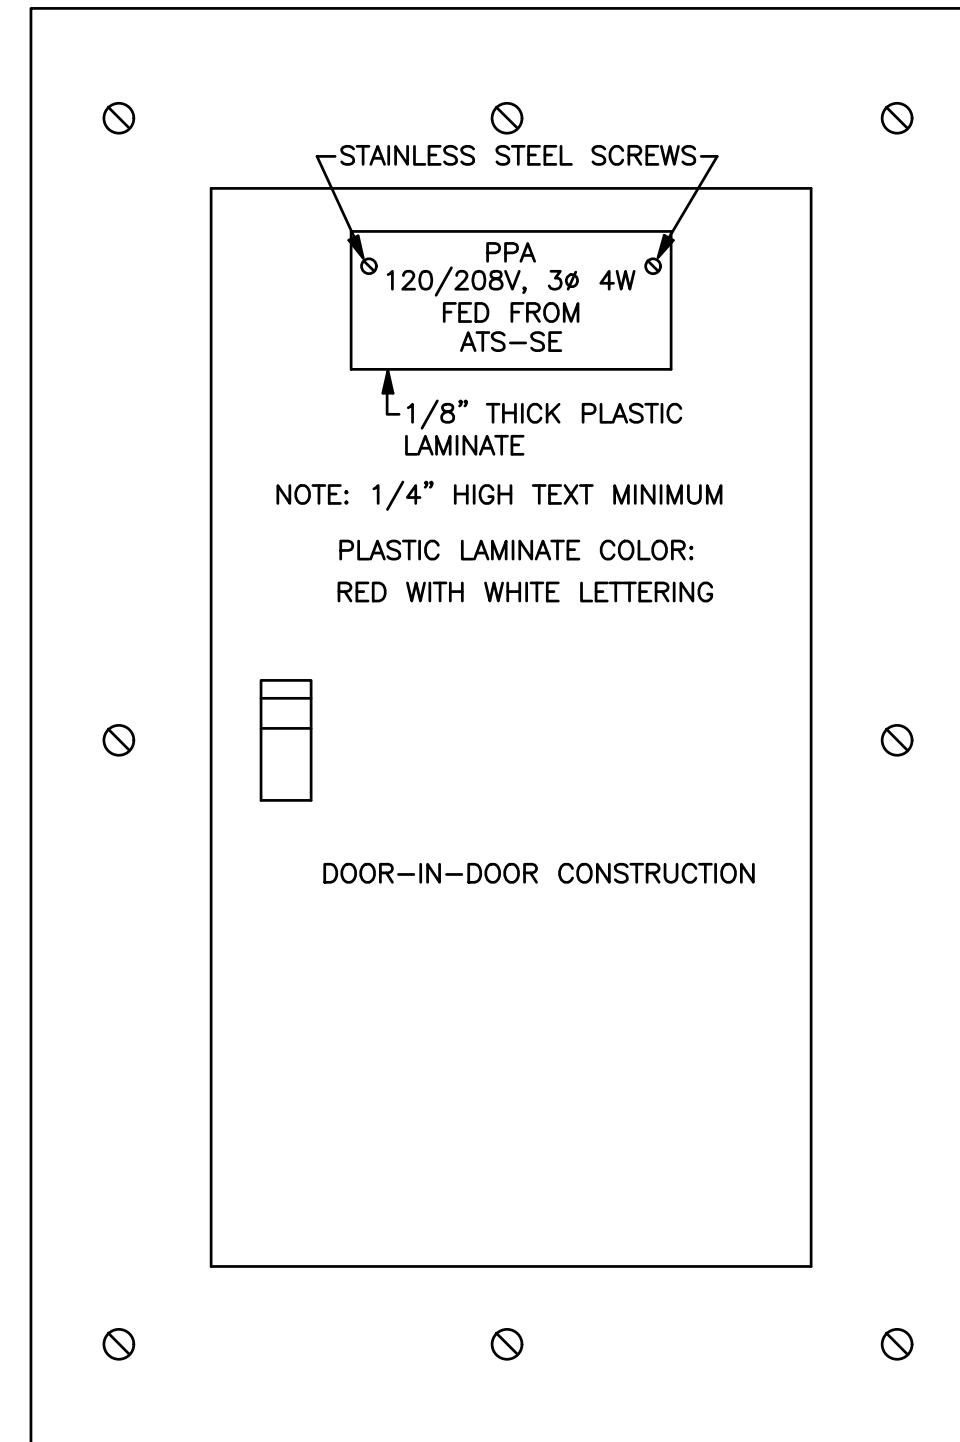


PANELBOARD I.D. DETAIL

NOT TO SCALE

PANELBOARD SCHEDULE											
DESCRIPTION	VOLT-AMP LOAD			CIRCUIT BREAKERS			VOLT-AMP LOAD			DESCRIPTION	
	PHASE A	PHASE B	PHASE C	TRIP POLE	TRIP CIR	TRIP CIR	PHASE A	PHASE B	PHASE C		
EXTERIOR LIGHTING	360			20	1	2	60	3	3850	HRU-1	
INTERIOR LIGHTING		950		20	1	3	4	—	—	—	
GWH-1 & CP-1			180	20	1	5	6	—	—	—	
RACK UPS	2880			30	1	7	8	50	3	2900	
EXTERIOR RECEPTACLES		900		20	1	9	10	—	—	2900	
RACK UPS		2880		30	1	11	12	—	—	—	
RECEPT-PP-DATA, 105	1200			20	1	13	14	20	2	620	
RECEPT-PP-DATA, 105		1200		20	1	15	16	—	—	620	
RECEPT-DATA, 105		720		20	1	17	18	20	1	1500 DH-1	
RECEPT-PP-DATA, 105	1200			20	1	19	20	20	1	600	
RECEPT-PP-DATA, 105		1200		20	1	21	22	20	1	360	
DRY PIPE COMPRESSOR/REC.		900		20	1	23	24	20	1	360	
RECEPT-PP-DATA, 105	1200			20	1	25	26	20	1	360	
RECEPT-PP-DATA, 105		1200		20	1	27	28	20	1	360	
RECEPT-DATA, 105		720		20	1	29	30	20	1	200 SPRINKLER CONTROLS	
RECEPT-CONSOLE; CALL-101	360			20	1	31	32	20	1	1200 RECEPT-MONITORS-CALL, 101	
RECEPT-CONSOLE; CALL-101		360		20	1	33	34	20	1	1160 RECEPT-MONITORS-CALL, 101	
RECEPT-CONSOLE; CALL-101		360		20	1	35	36	20	1	900 RECEPT-CALL, 101	
RECEPT-CONSOLE; CALL-101	360			20	1	37	38	20	1	1500 REFRIGERATOR-KITCHEN, 103	
RECEPT-CONSOLE; CALL-101		360		20	1	39	40	20	1	360 RECEPT-KITCHEN, 103	
RECEPT-CONSOLE; CALL-101		360		20	1	41	42	20	1	1200 MICROWAVE-KITCHEN, 103	
RECEPT-102/103	900			20	1	43	44	20	1	500 FAEP	
RECEPT-OFFICE, 104		720		20	1	45	46	30	2	1500 GENERATOR LOADCENTER	
SPARE (FUTURE CCTV/ACS)		0		20	1	47	48	—	—	1500	
GP-1	1920			50	1	49	50	20	1	0 SPARE	
WEH-1		750		20	2	51	52	20	1	0 SPARE	
—				—	—	53	54	20	1	0 SPARE	
	SUB TOTAL	10380	7640	7320				11530	11110	12410	SUB TOTAL

CONNECTED LOAD PHASE A: 21820
 CONNECTED LOAD PHASE B: 18750
 CONNECTED LOAD PHASE C: 19730
 TOTAL CONNECTED LOAD : 60390

PANELBOARD NOTES:
 * FACP CIRCUIT BREAKER SHALL BE RED IN COLOR WITH
 LOCK-ON ATTACHMENT.
 ** INDICATES BREAKER IS GFCI TYPE.

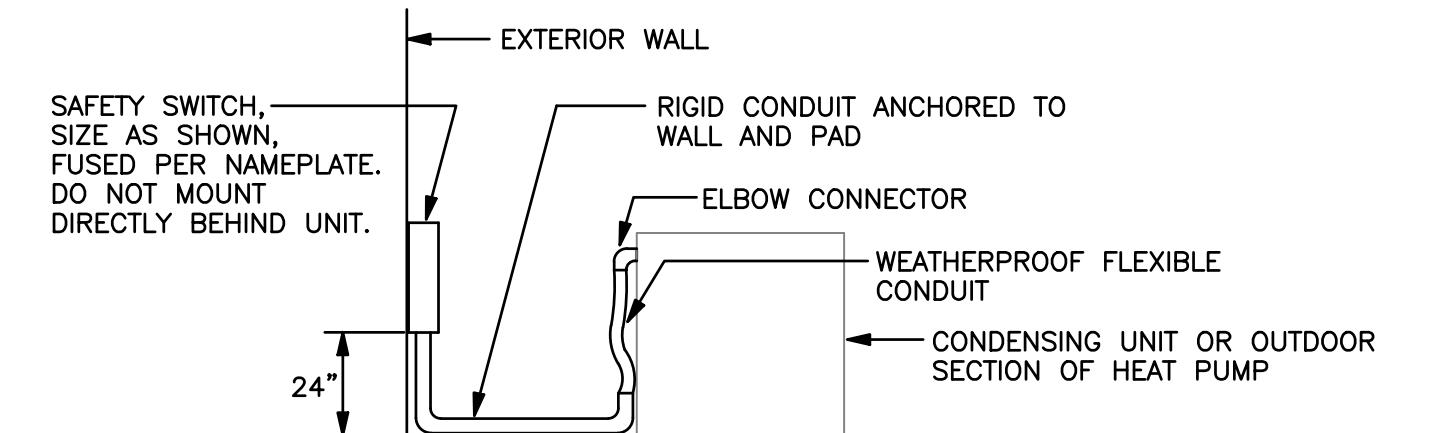


CONDENSING UNIT CONNECTION DETAIL

NO SCALE

NOTES:

1. SWITCH SHALL BE MOUNTED IN ACCESSIBLE LOCATION AND PER N.E.C.
2. CONTROL CONDUITS SHALL BE RUN IN SIMILAR MANNER EXCEPT PROVIDE CAST BOX WITH BLANK COVER IN LIEU OF SWITCH, IF CONTROL WIRING IS RATED FOR VOLTAGE OF BRANCH WIRING, THEN IT IS PERMISSIBLE TO BE RUN IN SAME CONDUIT.

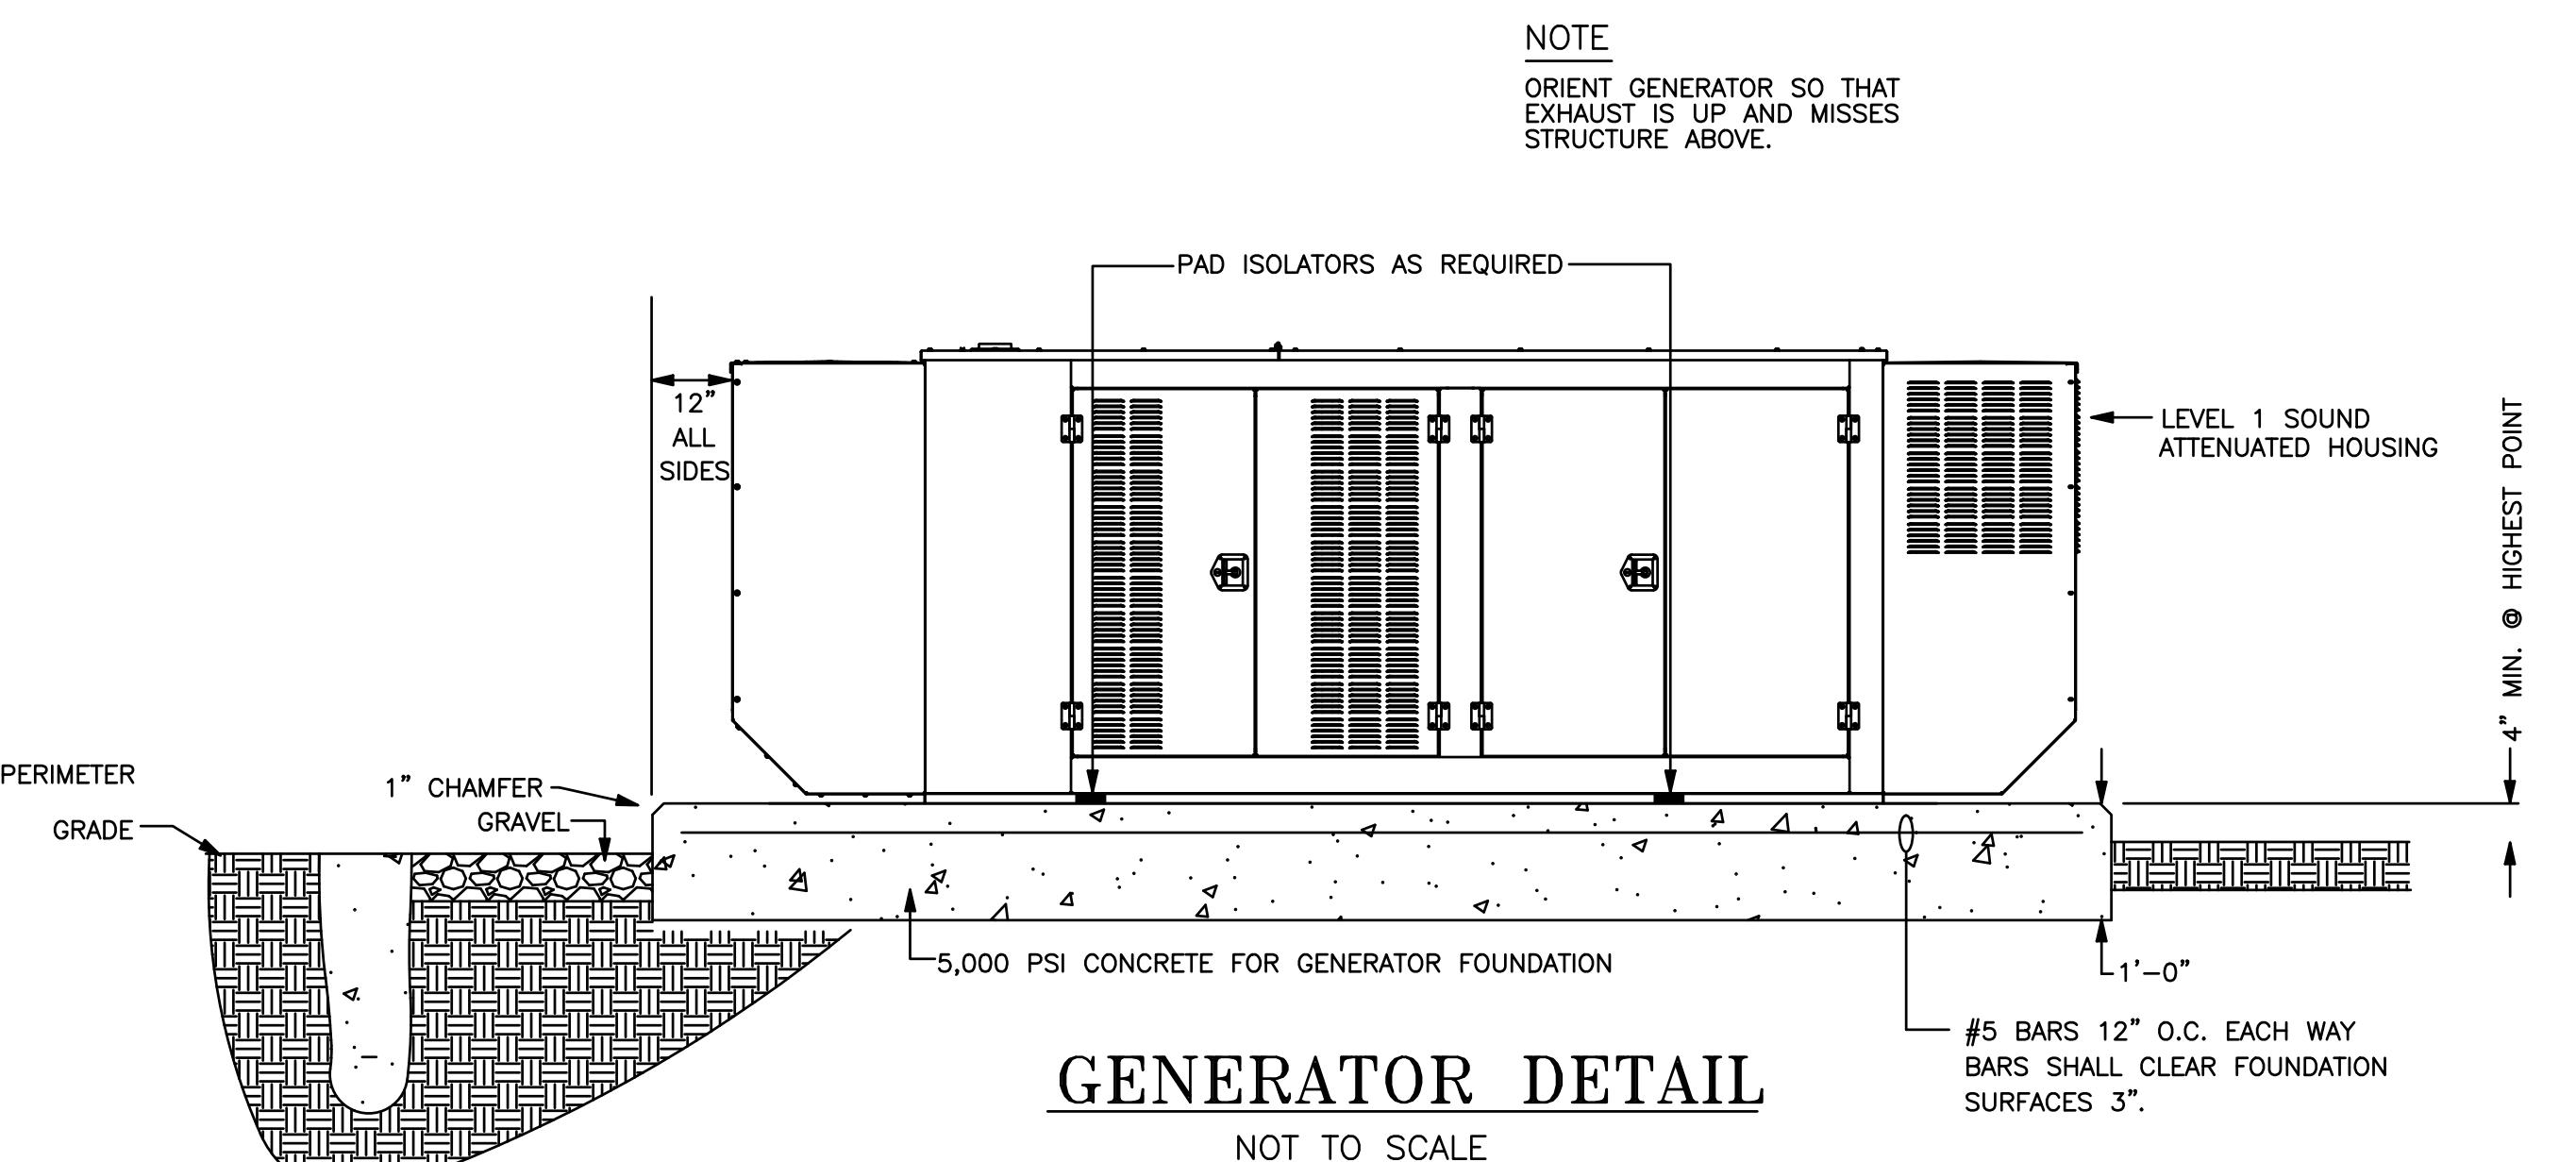


GENERATOR DETAIL

NOT TO SCALE

NOTES:

1. MAINTAIN A MINIMUM OF 3'-0" CLEARANCE OF THE SIDES OF THE GENERATOR. GENERATOR HOUSING DIMENSIONS MUST NOT EXCEED THE REQUIRED CLEARANCES WITH THE EXTERIOR WALLS.
2. PROVIDE ONE (1) CAT 6 CABLE FROM PATCH PANEL IN SERVER ROOM TERMINATED INTO A BISCUIT JACK INSIDE GENERATOR ENCLOSURE. CABLING SHALL BE RUN IN 3/4" C. UNDERGROUND INTO ENCLOSURE. COORDINATE EXACT LOCATION INSIDE ENCLOSURE WITH OWNER AND GENERATOR MANUFACTURER.
3. JACKET WATER HEATER, BATTERY CHARGER, RECEPTACLE AND ENCLOSURE LIGHTING SHALL ALL BE SERVED FROM LOADCENTER INSIDE GENERATOR ENCLOSURE. PROVIDE CIRCUIT BREAKERS SIZED AS REQUIRED BY GENERATOR MANUFACTURER.

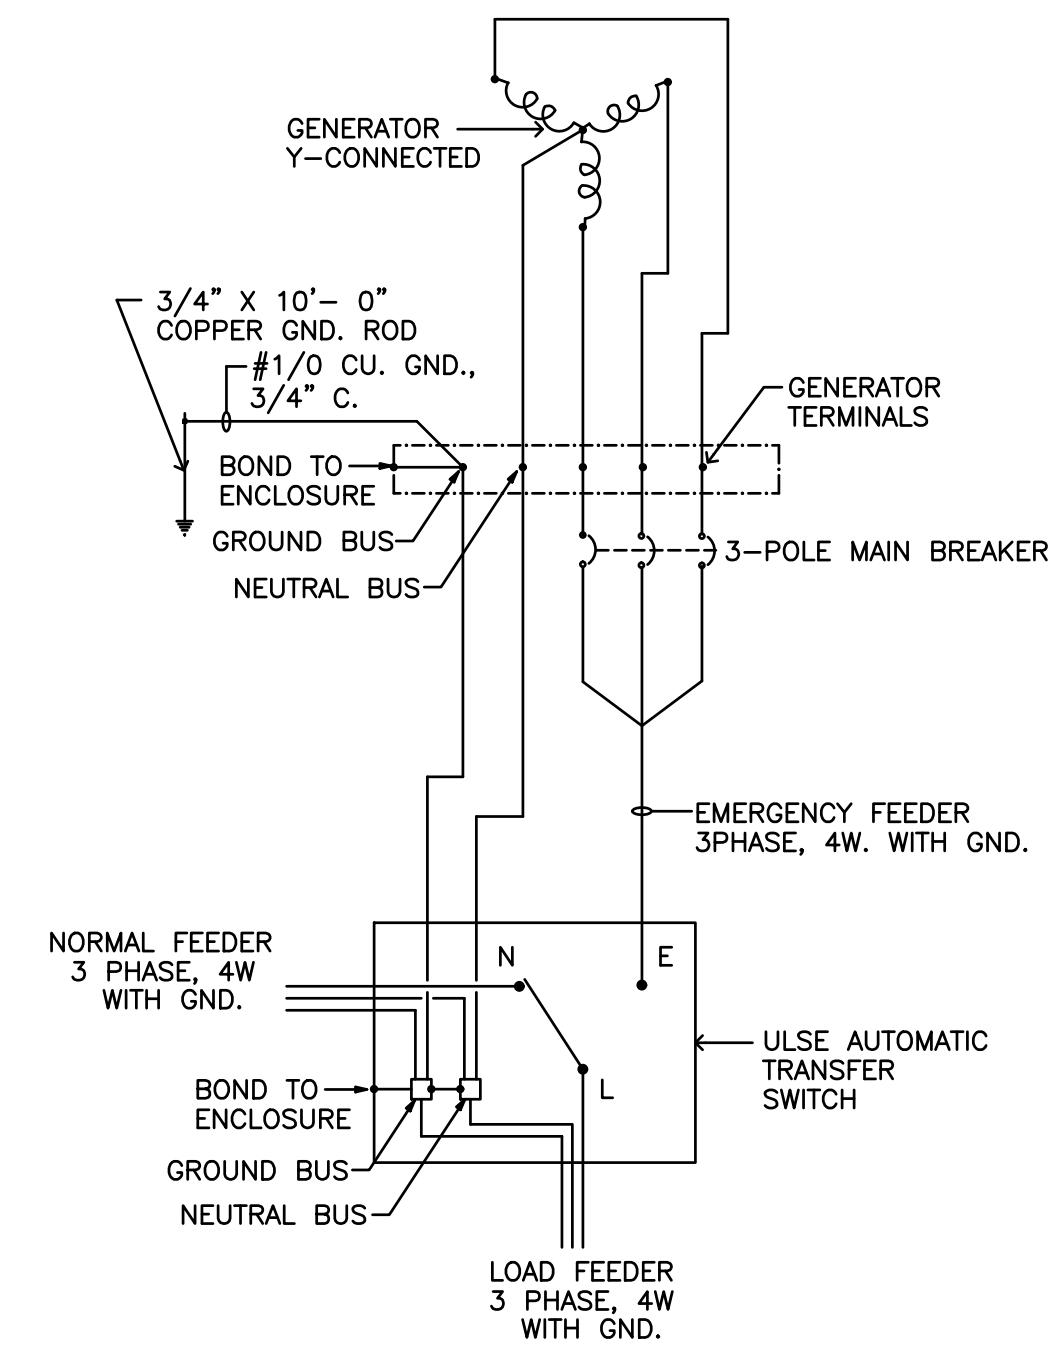


GENERATOR GROUNDING DETAIL

NOT TO SCALE

NOTE: SEE POWER RISER DIAGRAM FOR FEEDER SIZING.


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TALLAPOOSA CO E911 ADDITION TO THE TALLAPOOSA COUNTY JAIL FACILITY
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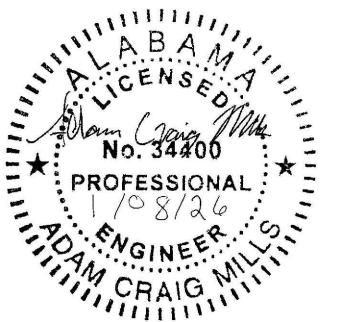


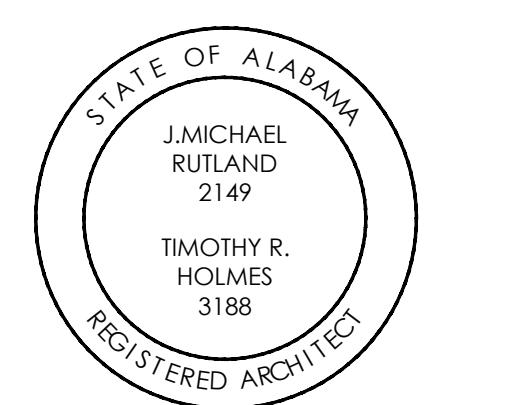SERVICE ENTRANCE GROUND DETAIL

NO SCALE

NOTES:

1. GROUNDING ELECTRODE CONDUCTORS SHALL BE ENCLOSED FULL LENGTH BY GALVANIZED RIGID CONDUIT AS INDICATED.
2. GROUNDING ELECTRODE CONDUCTORS SHALL BE BARE COPPER, SOFT-DRAWN.
3. ALL BUSHINGS, CLAMPS, JUMPERS, DEVICES, ETC. INSTALLED IN DIRECT CONTACT WITH EARTH SHALL BE APPROVED FOR THE PURPOSE.
4. GROUND CONNECTIONS BELOW GRADE SHALL BE OF THE EXOTHERMICALLY WELDED TYPE.
5. GROUND CONNECTIONS TO THE #2/0 BURIED GROUND LOOP SHALL BE OF THE EXOTHERMICALLY WELDED TYPE.

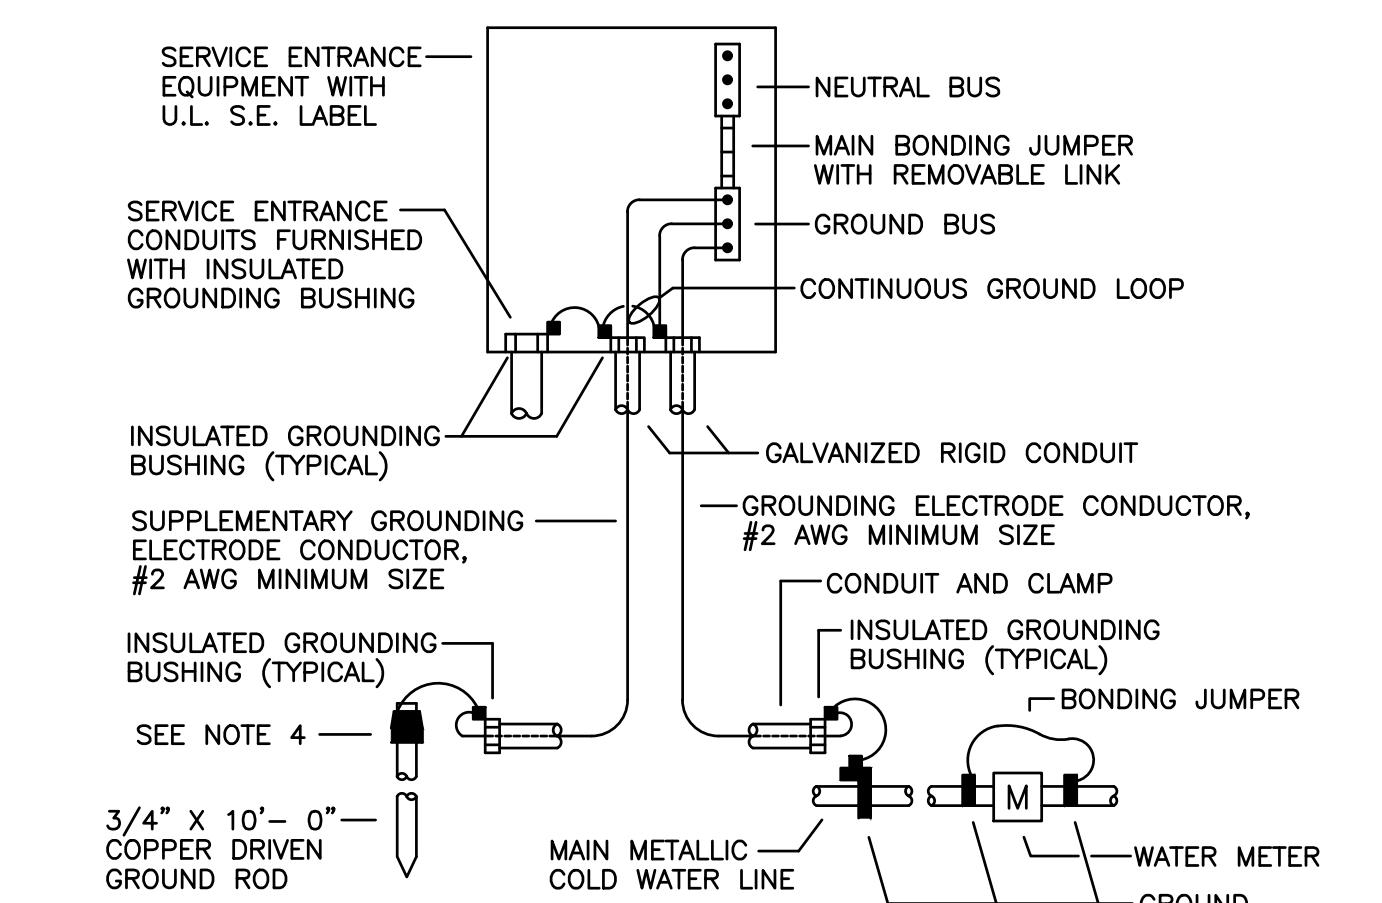

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